APPLICABLE CODES AND STANDARDS

- . 2023 FLORIDA BUILDING CODE (8TH EDITION)
- 2. 2021 INTERNATIONAL BUILDING CODE
- 3. ASCE 7-22: MINIMUM DESIGN LOADS ON BUILDINGS AND OTHER STRUCTURES
- 4. AISC STEEL CONSTRUCTION MANUAL (15TH EDITION)
- 5. ACI 318-14: BUILDING CODE REQUIREMENTS FOR STRUCTURAL CONCRETE
- 6. TMS 402-16; BUILDING CODE REQUIREMENTS FOR MASONRY STRUCTURES
- 7. AWS D1.1: STRUCTURAL WELDING


INSTALLATION NOTES AND SPECIFICATIONS

- 1. END WALL COLUMNS (POST) AND SIDE WALL COLUMNS ARE EQUIVALENT IN SIZE AND SPACING U.N.O.
- SPECIFICATIONS APPLICABLE TO 29 GA METAL PANELS FASTENED DIRECTLY TO 2.5'X2.5'X14 GA TUBE STEEL (TS) FRAMING MEMBERS FOR VERTICAL PANELS. 29 GA METAL PANELS SHALL BE FASTENED DIRECTLY TO 18 GA HAT CHANNELS U.N.O.
- 18 GA HAT CHANNELS SHALL BE SPACED 48" O.C. UNLESS DESIGN PRESSURES FROM TABLE 2 EXCEED THE MAX ALLOWABLE PRESSURES IN TABLE 1. THEN THE SPACING SHALL BE 24" O.C. IN THE ZONES THAT EXCEED THE MAX PRESSURES.
- 4. AVERAGE FASTENER SPACING ON-CENTERS ALONG RAFTERS OR PURLINS, AND POSTS, INTERIOR = 9" AND END=6" MAX.
- 5. FASTENERS CONSIST OF #12-14X3/4" SELF DRILLING SCREWS USE CONTROL SEAL WASHER WITH EXTERIOR FASTENERS. SPECIFICATIONS APPLICABLE ONLY FOR MEAN ROOF HEIGHT OF 20'-0" OR LESS, AND ROOF SLOPES OF 14" (3:12 PITCH) OR LESS, SPACING REQUIREMENTS FOR OTHER ROOF HEIGHTS AND/OR SLOPES MAY VARY.
- 6. ANCHORS SHALL BE INSTALLED THROUGH THE BASE RAIL WITHIN 6" OF EACH RAFTER COLUMN ALONG SIDES AND ENDS.
- 7. STANDARD GROUND ANCHORS (SOIL NAILS) CONSIST OF #4 REBARS WITH WELDED NUT X 30" LONG AND MAY BE USED IN SUITABLE SOILS. OPTIONAL ANCHORAGE MAY BE USED IN SUITABLE SOILS AND MUST BE USED IN UNSUITABLE SOILS AS NOTED. SOIL NAILS MAY BE USED FOR WIND SPEEDS LESS THAN OR FOLIAL TO 45 MPH.
- 8. RAFTER SPACING IS 5-0" FOR WIND SPEEDS BETWEEN 110 MPH AND 140 MPH AND 4-0" FOR WIND SPEEDS BETWEEN 140 MPH AND 180 MPH.
- 9. WINDOWS AND DOORS SHALL BE INSTALLED AND FLASHED IN ACCORDANCE WITH THE FENESTRATION MANUFACTURER'S WRITTEN INSTRUCTIONS. WINDOW AND DOOR OPENINGS SHALL BE FLASHED IN ACCORDANCE WITH SECTION 8703.4. WRITTEN INSTALLATION INSTRUCTIONS SHALL BE PROVIDED BY THE FENESTRATION MANUFACTURER FOR EACH WINDOW OR DOOR.
- 10. THE WIND SPEED LISTED ON THE PLANS HAS BEEN INTERPOLATED PER FBC TABLE R301.2.1.3 FOOTNOTE a.
- TORNADO VELOCITY COMPLIANCE NOT REQUIRED FOR RISK CATEGORY I AND II STRUCTURES PER 2023 FBC RESIDENTIAL R301 2 1.1 BIJII DING 1601 3 4 AND ASCE 7-22

ENCLOSED METAL BUILDING DESIGN
30'-0" WIDE x 90'-0" LONG x 14'-0" HIGH (EAVE)
W/ 12'-0" WIDE X 38'-0" LONG X 8'-0" HIGH (EAVE) LEAN-TO @ GABLE END

AND 8'-0" WIDE X 36'-0" LONG X 8'-0" HIGH (EAVE) LEAN-TO



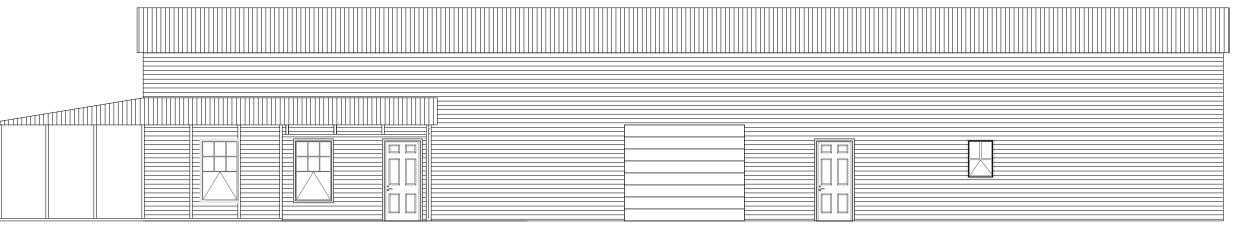

DESIGN LOADS

- 1. DEAD LOAD = 10 PSF
- 2. LIVE LOAD= 20 PSF
- 3. WIND LOAD (SEE TABLE 1)
- A. RISK CATEGORY = II
- B. WIND EXPOSURE CATEGORY = C
- C. ULTIMATE WIND SPEED = 130 MPH
- D. NOMINAL WIND SPEED = 101 MPH

R-3 OCCUPANCY

SHEET TITLE
NOTES AND SPECIFICATIONS
FRAMING LAYOUT ELEVATIONS
FRAMING LAYOUT ELEVATIONS
FRAME RAFTER LEAN-TO DETAILS
FOUNDATION PLAN AND DETAILS
CONNECTION DETAILS (1 OF 2)
CONNECTION DETAILS (2 OF 2)
WALL AND CEILING DETAILS
INCIDENTALS
ELEVATIONS
FLOOR PLAN
ELECTRICAL

DRAWING INDEX

S															
s	COMPONENTS AND CLADDING DESIGN PRESSURES MEAN ROOF HT 15 FT, EXPOSURE C (PSF)			
LS	7000	120		13	30 140		150		160		170		180		
	Zone	POS	NEG	POS	NEG	POS	NEG	POS	NEG	POS	NEG	POS	NEG	POS	NEG
LS	1	8.7	-18.5	10.3	-21.8	11.9	-25.3	13.7	-29.0	15.6	-33.0	17.5	-37.3	19.7	-41.7
2)	2	8.7	-25.0	10.3	-29.4	11.9	-34.1	13.7	-39.2	15.6	-44.5	17.5	-50.3	19.7	-56.4
2)	3	9.9	-40.2	11.6	-47.2	13.4	-54.7	15.4	-62.8	17.5	-71.5	19.8	-80.7	22.1	-90.4
	4	16.0	-17.5	18.8	-20.7	21.8	-24.0	25.0	-27.5	28.4	-31.2	32.1	-35.3	35.9	-39.6
	5	16.8	-21.3	19.7	-24.9	22.9	-28.9	26.3	-33.2	29.9	-37.8	33.8	-42.6	37.9	-47.8
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MEMBER	PRODUCT	MAX WIND DESIGN
	APPROVAL NUMBER	PRESSURES
ROOF PANELS	FL39466	+41.6 PSF / -31.2 PSF
WALL PANELS	FL39594	+55.4 PSF / -41.6 PSF
GARAGE DOOR	CTP	CTP
WALK-IN DOOR	CTP	СТР

CTP = CONTRACTOR TO PROVIDE 2023 FBC APPROVED PRODUCTS THAT MEET OR EXCEED DESIGN PRESSURES AS TABLULATED.

Digitally signed by Adam Collins DN: c=US, sn=Collins, givenName=Adam, email=adam@collinseng.com, cn=Adam Collins Date: 2025.01.16 10:31:05 -05'00' SEALED BY ADAM T. COLLINS, P.E. ON January 15, 2025
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			DRAWN	RBS			C ADAM COLLIN
			DESIGNED				(A) ADAM COLLIN
			CHECKED	ATC			ENGINEERING IN
			JOB No.	22047			CA# 31728 ~ P: 386.320.7400 ~ WWW.COLLINSENG.CO

SMITH JR
434 S.W. SPARROW
TERRACE LAKE CITY,
FL 32055


NOTES AND
SPECIFICATIONS


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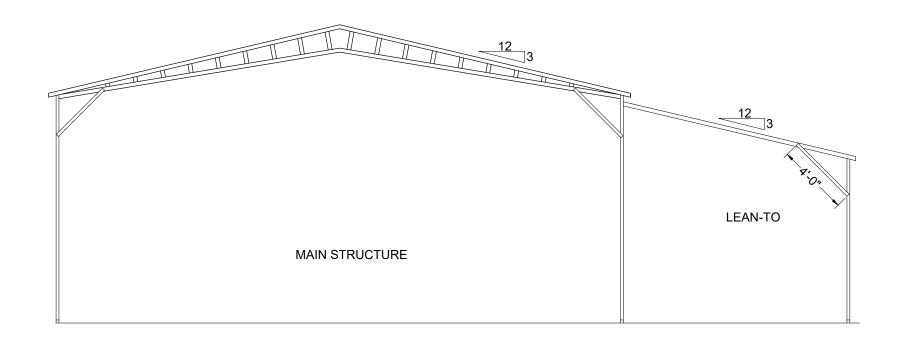
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SCALE

AS SHOWN






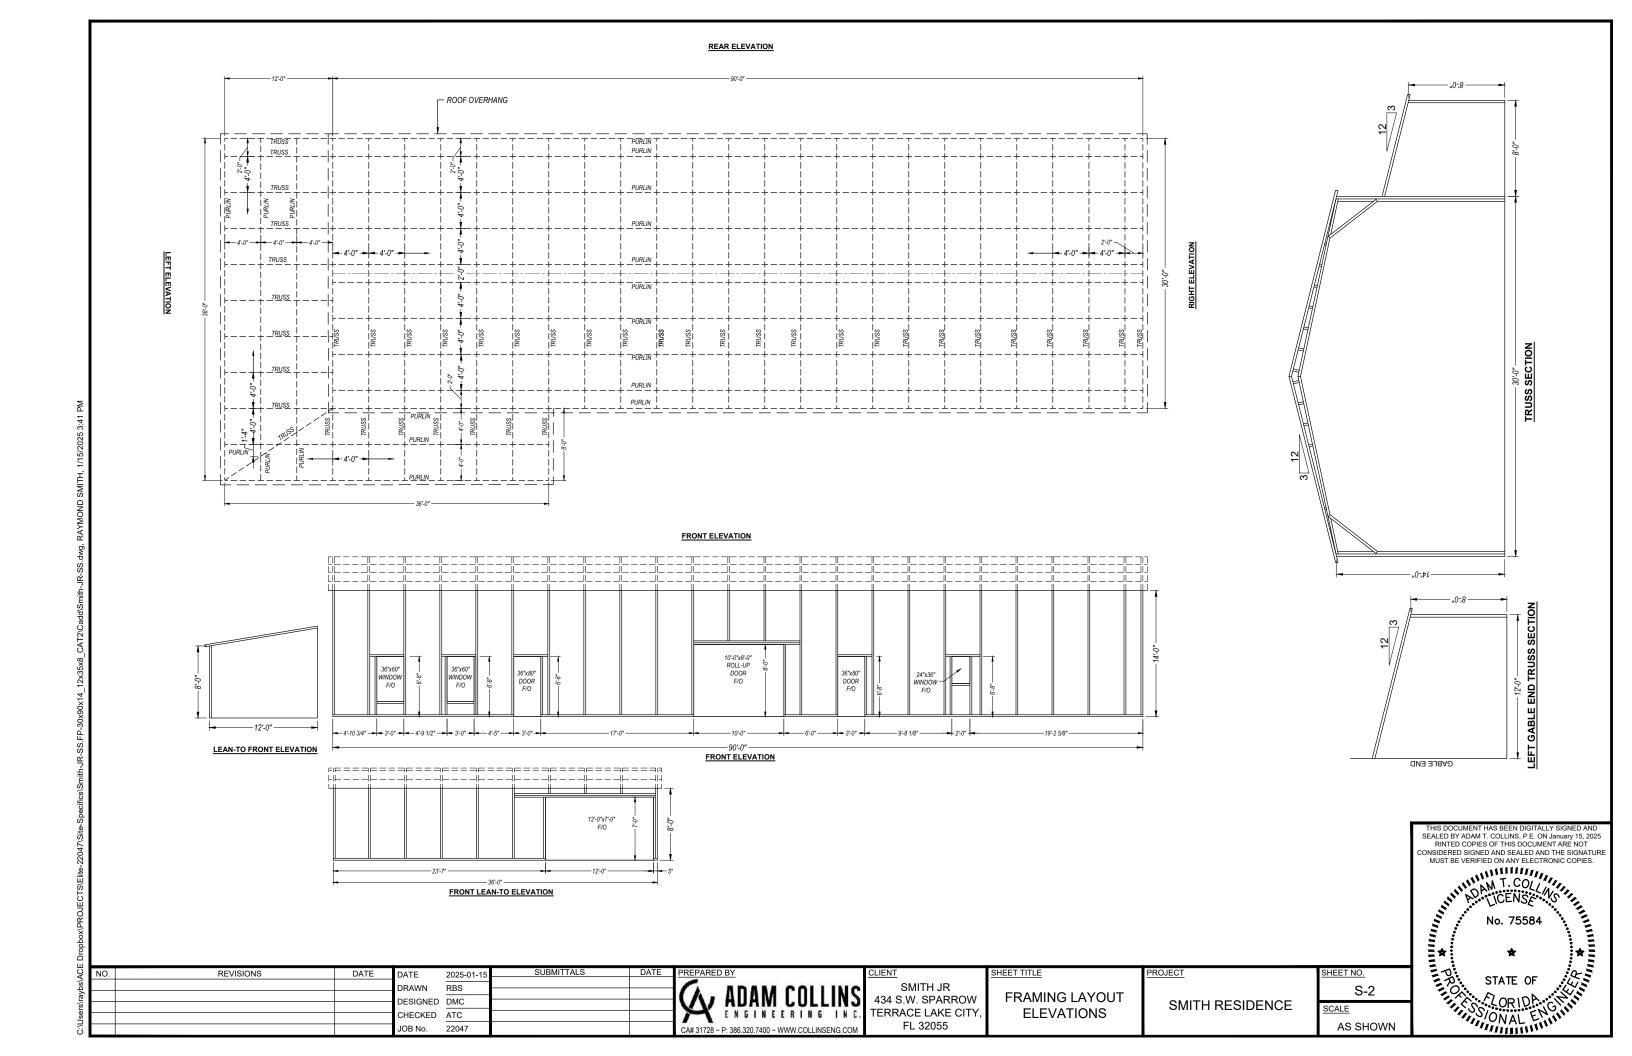

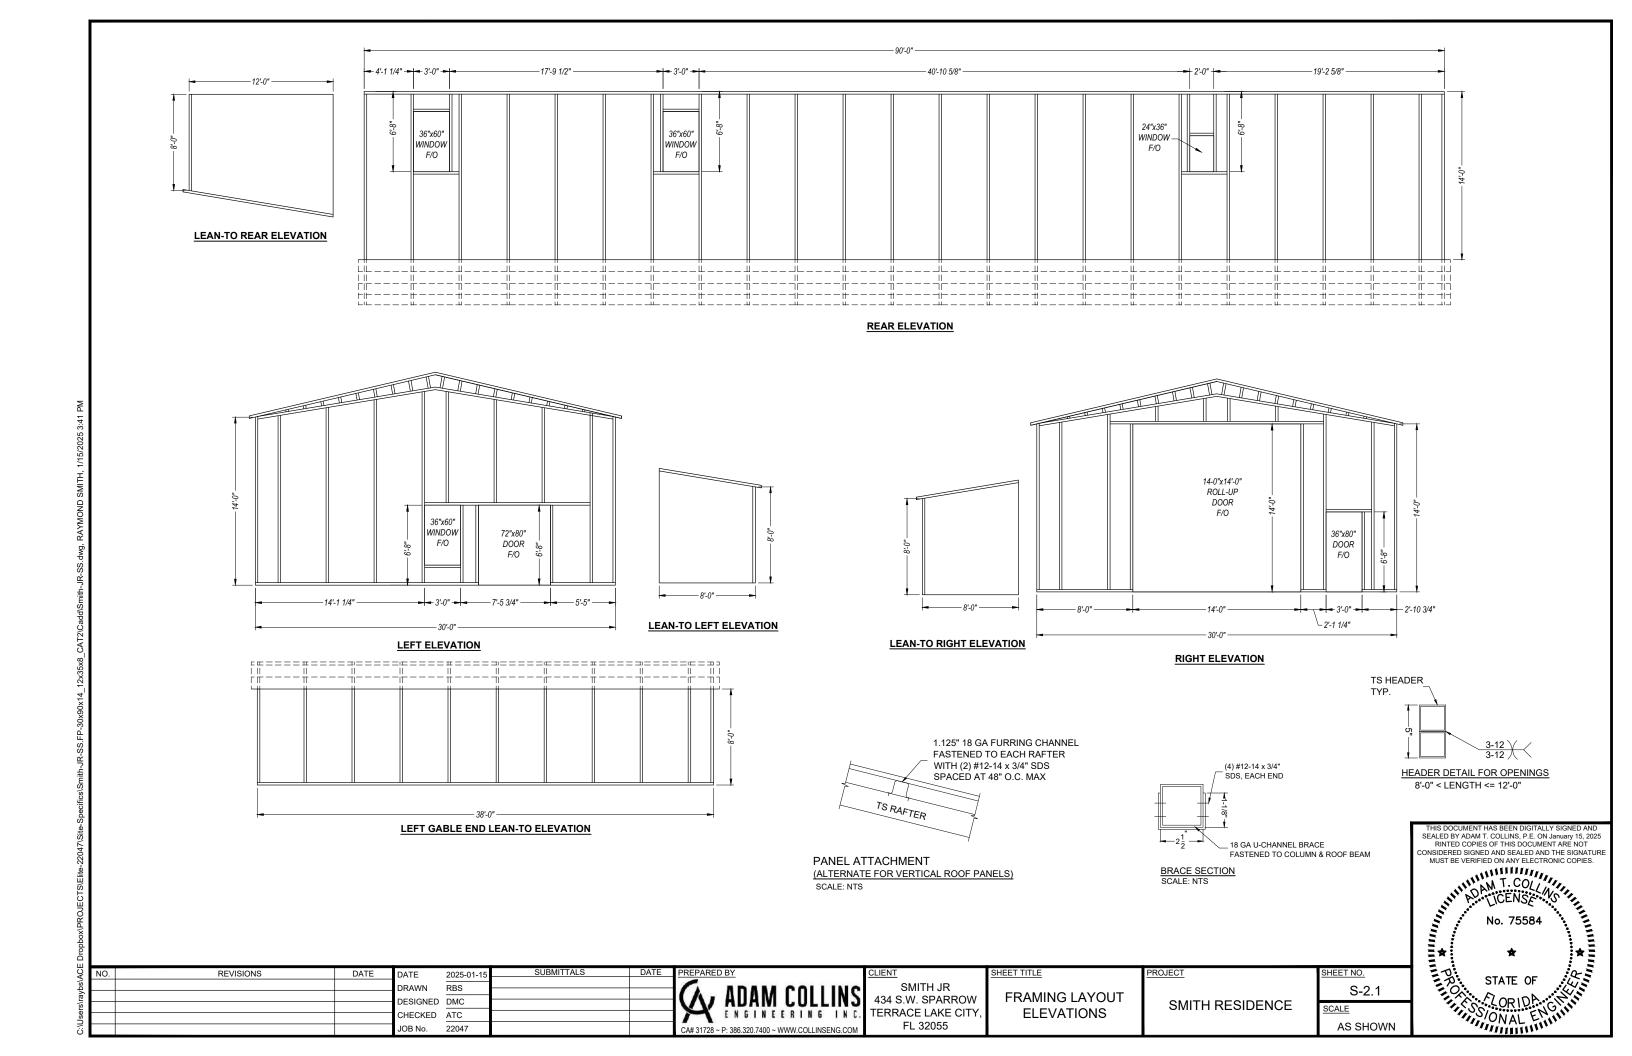TYPICAL BOX EAVE RAFTER LEAN-TO OPTIONS FRAMING SECTION

SCALE: NTS

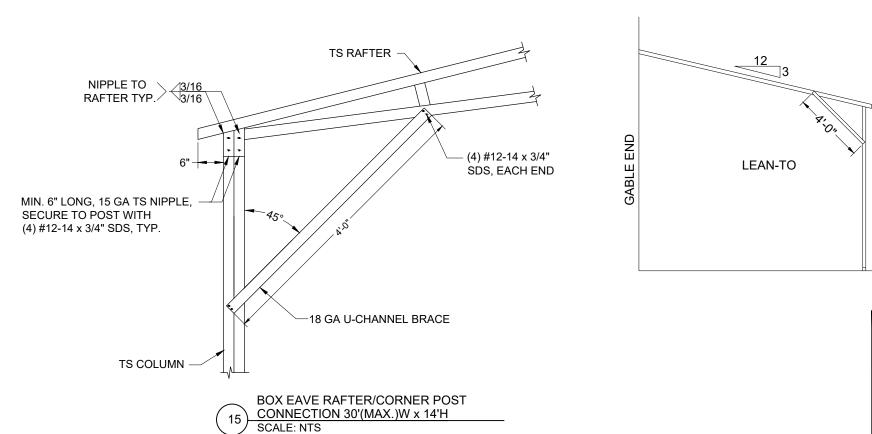

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SMITH JR 434 S.W. SPARROW TERRACE LAKE CITY, FL 32055

FRAME RAFTER LEAN-TO DETAILS

SHEET TITLE

SMITH RESIDENCE

PROJECT


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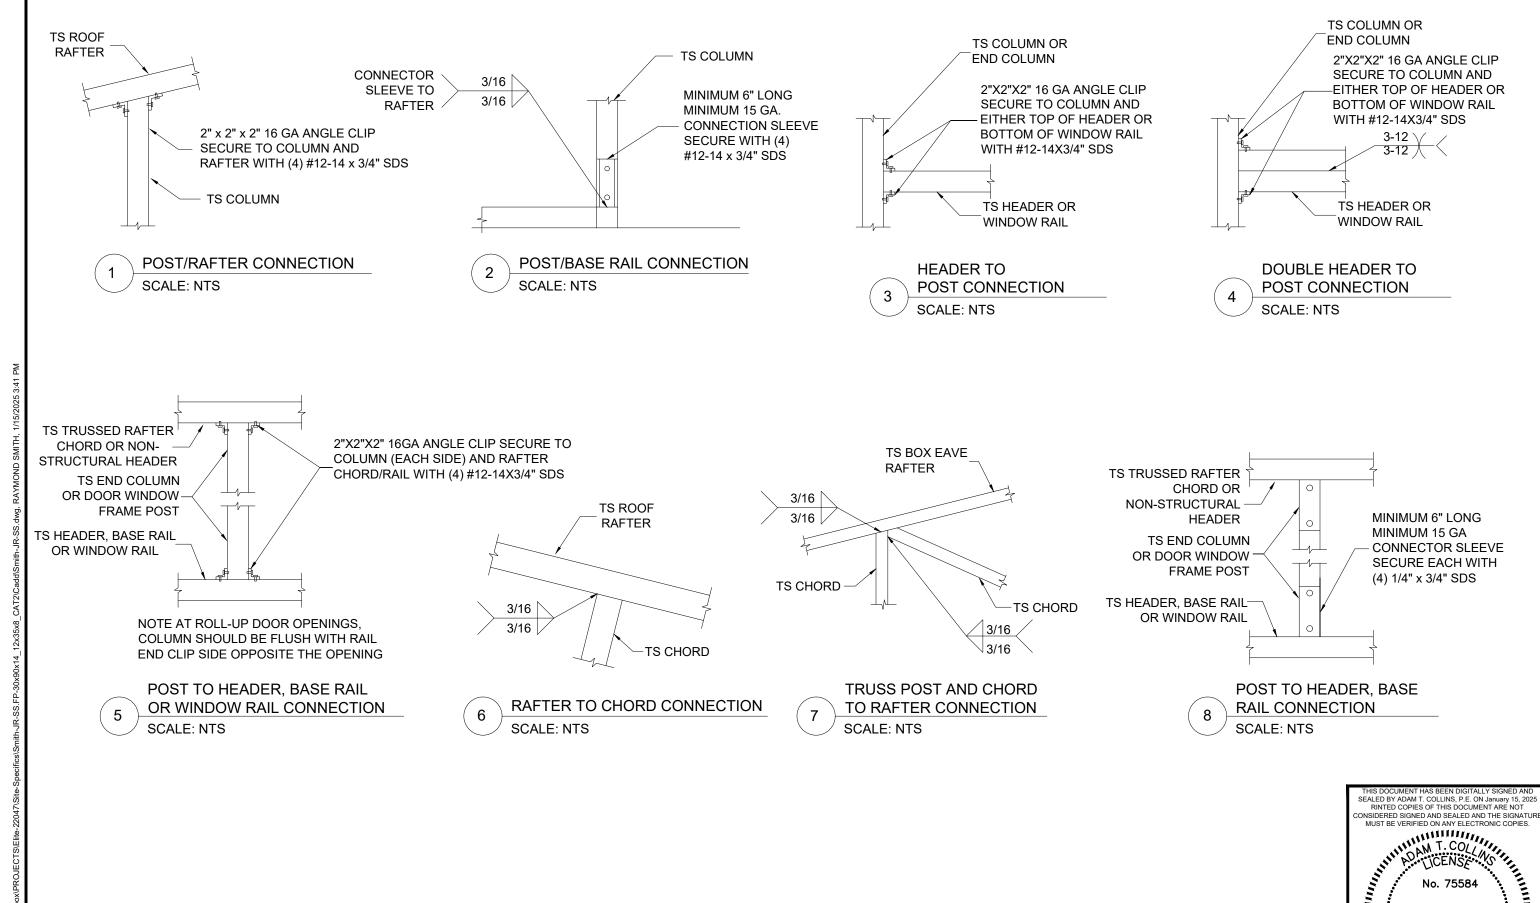
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SHEET TITLE

(1 OF 2)

SMITH JR

434 S.W. SPARROW

TERRACE LAKE CITY

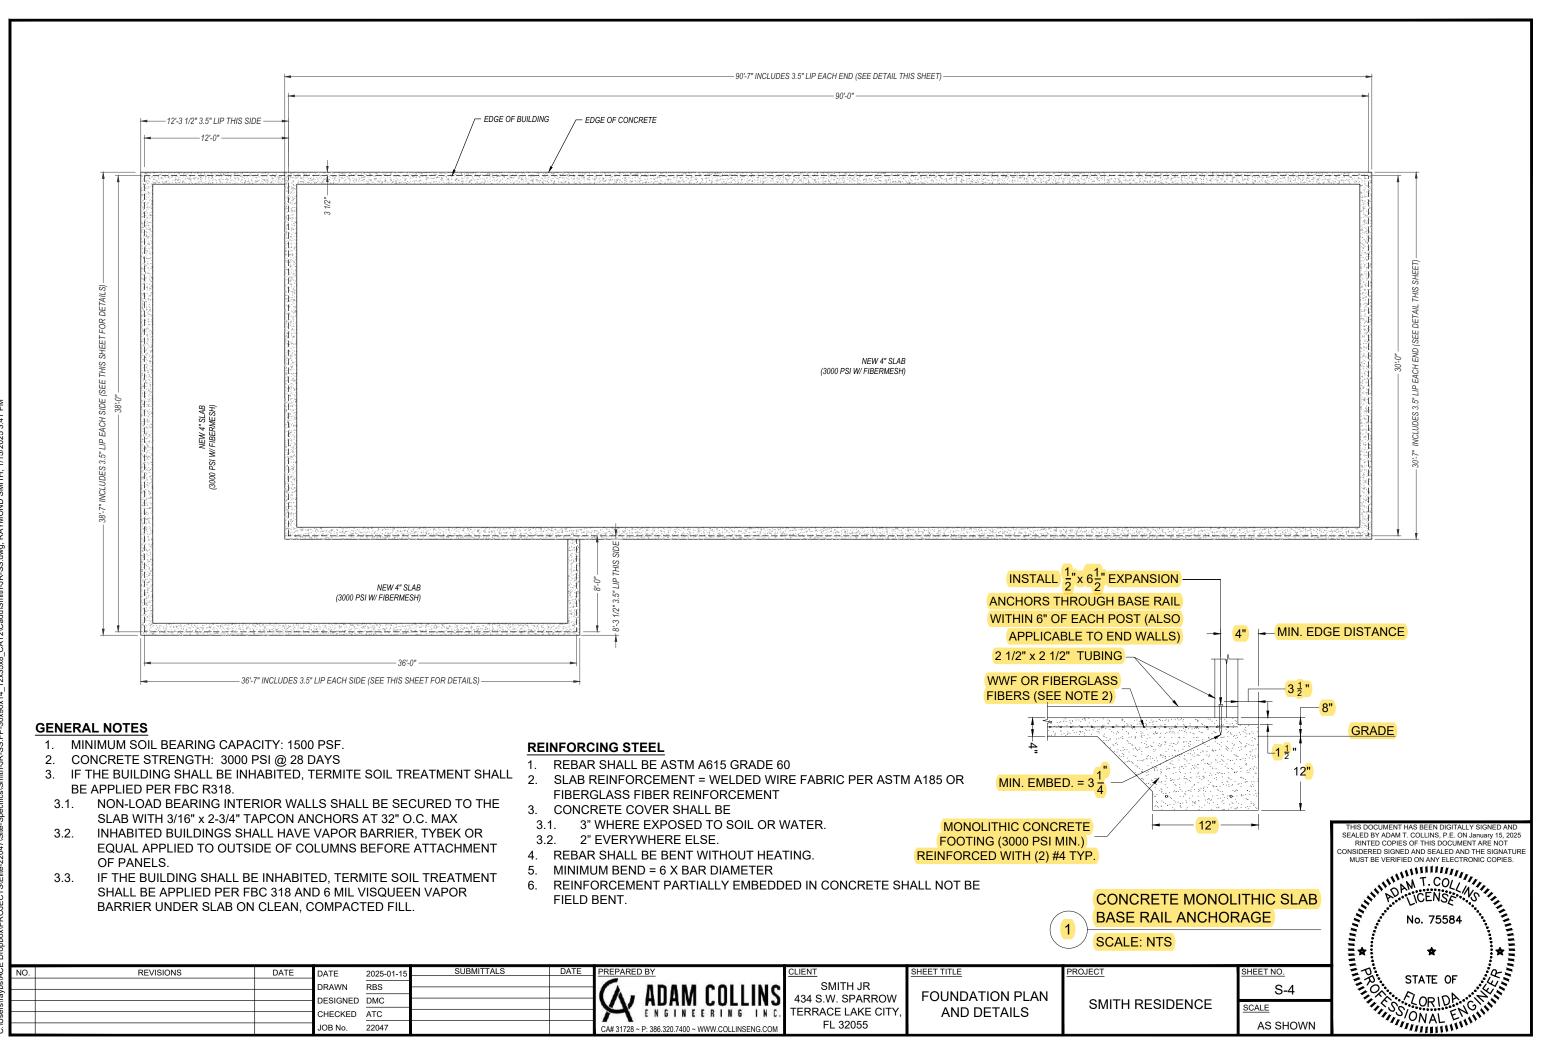FL 32055

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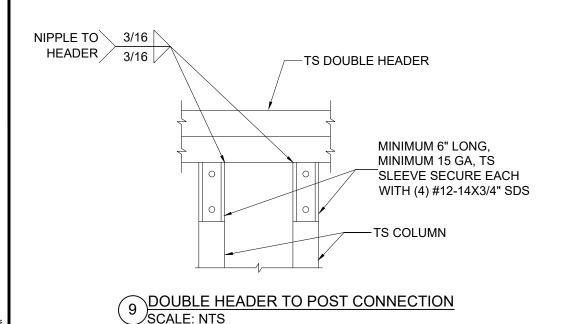
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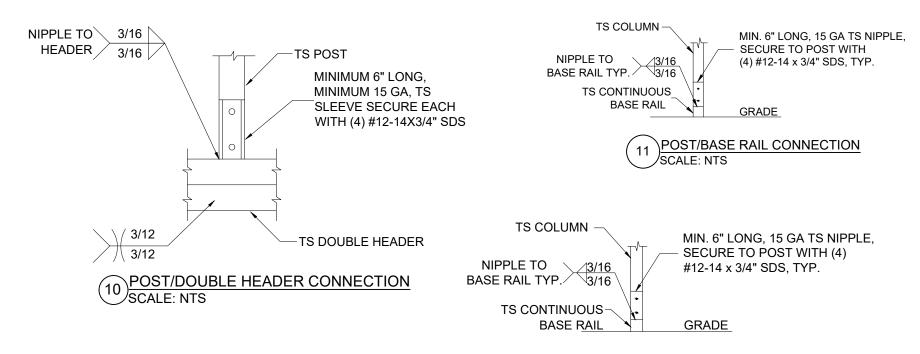
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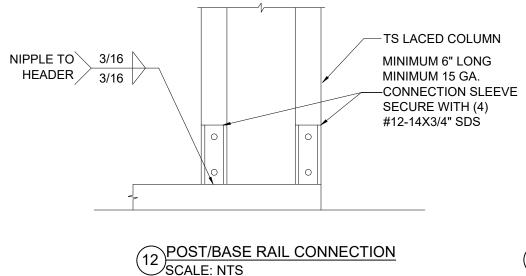
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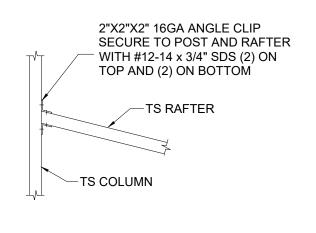
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C PROJECT HEET NO. S-5 CONNECTION DETAILS SMITH RESIDENCE SCALE AS SHOWN











LEAN TO RAFTER/COLUMN CONNECTION

RAFTER SPANLESS THAN 12'-0"

SCALE: NTS

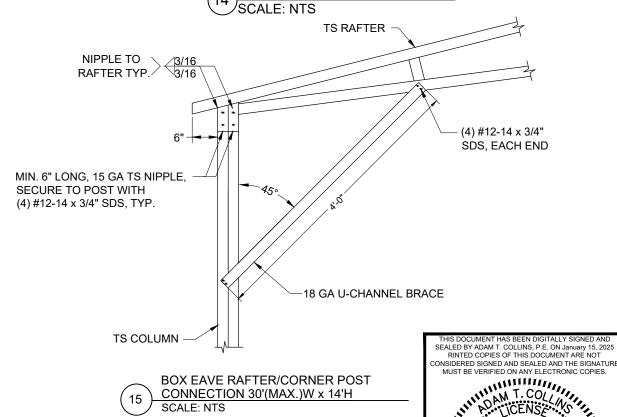

LEAN-TO POST CONNECTION

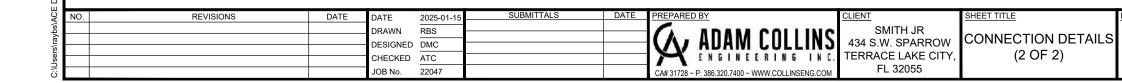



SMITH RESIDENCE SCALE

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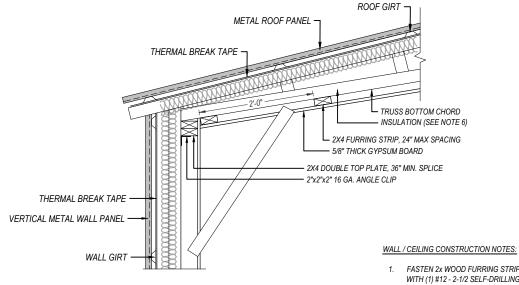
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AS SHOWN



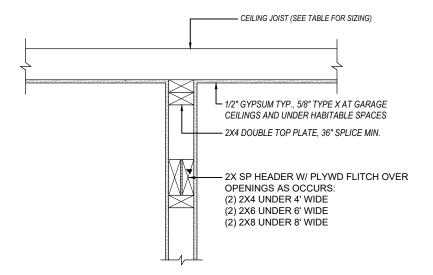

CEILING JOIST	SPAN TABLE (E	= 1,400,000 P.S.I.
JOIST SIZE	SPACING	SPAN
	12	11-10
0)//	16	10-9
2X4	19.2	10-2
	24	9-5
	12	18-8
0.40	16	16-11
2X6	19.2	15-11
	24	14-9
	12	24-7
0.40	16	22-4
2X8	19.2	21-0
	24	19-6
	12	26-0
0140	16	26-0
2X10	19.2	26-0
	24	24-10

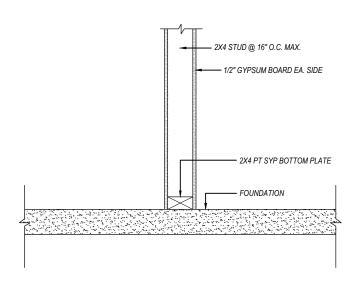INTERIOR WALL SECTION SCALE: NTS



- 2X4 STUD @ 16" O.C. MAX.

- INSULATION ((SEE NOTE 6)

DOUBLE 2.5" X 2.5" TS COLUMN

- 2X4 PT SYP BOTTOM PLATE

FOUNDATION

- 1/2" GYPSUM BOARD

- 1. FASTEN 2x WOOD FURRING STRIP TO METAL TRUSS BOTTOM CHORD
- WITH (1) #12 2-1/2 SELF-DRILLING SCREWS (SDS) PER TRUSS.
 FASTEN ANGLE CLIP TO TOP PLATE WITH (2) #12 1-1/2" WOOD SCREWS
 AND TO TS COLUMN WITH (2) #12 3/4" SDS AT EA. END AND 8' O.C. MAX
 FASTEN BOTTOM PLATE TO FOUNDATION WITH (1) 3/16" x 2-3/4" TAPCON
- ANCHORS AT 32" O.C. MAX.
- FASTEN CEILING JOISTS TO TOP PLATE WITH (2) 16D NAILS, TOENAIL EA. SIDE
- APPLY 1/8" x 3" THERMAL BREAK TAPE (ECOTAPE™OR EQUAL) ALONG OUTSIDE FACE OF ALL TS COLUMNS AND THE TOP CHORD OF ALL TRUSSES BEFORE ATTACHING PURLINS AND/OR PANELS. WHEN PURLINS ARE USED, THE CONTRACTOR MAY APPLY (1) 12" STRIP OF TAPE CENTERED AT EACH PURLIN TO COLUMN CONNECTION. THEN APPLY CLOSED CELL SPRAY FOAM INSULATION TO ACHIEVE THE REQUIRED R-VALUE. CONTRACTOR SHALL ENSURE THAT COMPLETE COVERAGE OF FOAM IS APPLIED TO THE SURFACE OF ALL STRUCTURAL MEMBERS THAT DIRECTLY CONNECT TO PURLINS AND/OR SIDING. THE ROOF DECK AND WALL SECTION CREATED BY THIS METHOD SATISFIES
- THE FLORIDA BUILDING CODE UNDERLAYMENT REQUIREMENT.
 ALL FLORIDA COUNTIES ARE EITHER CLIMATE ZONE 1 OR 2. THE
 MINIMUM R-VALUES FOR ZONE 1 ARE (WALL = 13; CEILING = 30) AND
 ZONE 2 VALUES ARE (WALL = 13; CEILING = 38). REFER TO ENERGY CALCULATIONS (BY OTHERS) FOR ANY ADDITIONAL INSULATION SPECIFICATIONS. THE R-VALUES LISTED ARE CURRENT PER FLORIDA BUILDING CODE. THESE R-VALUES ARE SUBJECT CHANGE, IF THE ENERGY CALCULATIONS SHOW LESSER VALUES ARE APPROPRIATE AND THE BUILDING OFFICIAL APPROVES THE REDUCTION.

EXTERIOR WALL SECTION SCALE: NTS

SMITH JR 434 S.W. SPARROW TERRACE LAKE CITY, FL 32055

SHEET TITLE

WALL AND CEILING **DETAILS**

PROJECT

HEET NO. S-7 SCALE

AS SHOWN

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