As required by Florida Statute 553.842 and Florida Administrative Code 9B-72, please provide the information and approval numbers on the building components listed below if they will be utilized on the construction project for which you are applying for a building permit. We recommend you contact your local product supplier should you not know the product approval number for any of the applicable listed products. Statewide approved products are listed online @ www.floridabuilding.org

Category/Subcategory	Manufacturer	Product Description	Approval Number(s)
1. EXTERIOR DOORS			
A. SWINGING			
B. SLIDING			
C. SECTIONAL/ROLL UP			
D. OTHER			
2. WINDOWS			
A. SINGLE/DOUBLE HUNG	Pella	Double Hung Window	16813.7
B. HORIZONTAL SLIDER	. 5110	Boasio Harig William	
C. CASEMENT			
D. FIXED			
E. MULLION			
F. SKYLIGHTS			
G. OTHER	1		
3. PANEL WALL			
A. SIDING			
B. SOFFITS			
C. STOREFRONTS			
D. GLASS BLOCK			
E. OTHER			
4. ROOFING PRODUCTS			
A. ASPHALT SHINGLES			
B. NON-STRUCTURAL METAL			
C. ROOFING TILES	1		
D. SINGLE PLY ROOF	1		
E. OTHER			
			i
5. STRUCTURAL COMPONENTS			
A. WOOD CONNECTORS	1		
B. WOOD ANCHORS	1		
C. TRUSS PLATES			
D. INSULATION FORMS	1		
E. LINTELS			
F. OTHERS	1		
100 (100 (100 (100 (100 (100 (100 (100			
6. NEW EXTERIOR		*	
ENVELOPE PRODUCTS			

The products listed below did not demonstrate product approval at plan review. I understand that at the time of inspection of these products, the following information must be available to the inspector on the jobsite; 1) copy of the product approval, 2) performance characteristics which the product was tested and certified to comply with, 3) copy of the applicable manufacturers installation requirements.

Further, I understand these products may have to be removed if approval cannot be demonstrated during inspection.

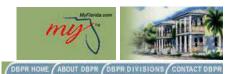
	3/20/2025	AA7 11' ' 1 4 41 ' 1
Contractor OB Agent Signature	Date	NOTES: We are adding one window to the permit
		Total of 12 windows.

Customer Nar	me: David Day	
Job Address:_	527 Nw Indian Springs Dr	
	Back of Home	
	X	

Front of Home



## Business & Professional Regulation



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<u>Product Approval Menu</u> > <u>Product or Application Search</u> > **Application List** 

Search Criteria			Refine Search
Code Version	2023	FL#	16813.7
Application Type	ALL	Product Manufacturer	ALL
Category	ALL	Subcategory	ALL
Application Status	ALL	Compliance Method	ALL
Quality Assurance Entity	ALL	Quality Assurance Entity Contract Expired	ALL
Product Model, Number or Name	ALL	Product Description	ALL
Approved for use in HVHZ	ALL	Approved for use outside HVHZ	ALL
Impact Resistant	ALL	Design Pressure	ALL
Other	ALL		

## **Search Results - Applications**

FL#	<u>Type</u>	<u>Manufacturer</u>	<u>Validated By</u>	<u>Status</u>
FL16813-R11 History	Revision	Pella Corporation FL#: FL16813.7 Model: 250 Series Double Hung Window Description: 72 1/2" x 63" vinyl non-impact double window Category: Windows Subcategory: Double Hung	T.E. Lunn, PE, LLC (561) 625-6455	Approved *

<sup>\*</sup>Approved by DBPR. Approvals by DBPR shall be reviewed and ratified by the POC and/or the Commission if necessary.

Contact Us :: 2601 Blair Stone Road, Tallahassee FL 32399 Phone: 850-487-1824

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**Product Approval Accepts:** 

Credit Card



SMALL BE REYOND WALL FINST HOR STUDGO.

2. OPENINGS, BUCKING & BUCKING FASTENERS MUST BE PROPERLY DESIGNED & INSTALLED TO TRANSFER WIND LOADS

2. OPENINGS, BUCKING & BUCKING FASTENERS MUST BE PROPERLY DESIGNED & INSTALLED TO TRANSFER WIND LOADS

3. THES FINOTH MENT RATED PRODUCT INSTALLATIONS ARE IN ACCORDANCE WITH AND MEET THE REQUIREMENTS OF

THE FLORIDA BUILDING CODE (FBC).

4. ALL ANCHORS SCIOLING PRODUCT FRAMES TO PRESSURE TREATED BUCKS OR WOOD FRAMING SHALL BE CAPABLE

OF RESISTING CORROSON CAUSED BY THE PRESSURE TREATING CHEMICALS IN THE WOOD.

5. MATERIALS MICLURING BUT NOT LIMITED TO STEEL SCREENS, THAT COME INTO CONTACT WITH OTHER DISSIMILAR

ANTERIALS SHALL MEET THE REQUIREMENTS OF FLORIDA BUILDING CODE CHAPTER 20.

6. TO THE BEST OF OUR KNOWLEDGE, THE PROQUET SHOWN HEREIN IS CERTIFIED & QUALITY ASSURED BY A FLORIDA

STATE APPROVED CERTIFICATION/QA ENTITY & SHALL BE LABELED IN ACCORDANCE WITH THE FBC. AND THE FLORIDA

BETWARMENT OF BUSINESS & PROFESSIONAL REGULATION SEPCIFICATIONS. PRODUCT ASSURBLY IS NOT PART OF THIS

CHAPTER OF THE RESULT OF THE RESULT OF THE FIRST OF THE FBC. AND THE FLORIDA

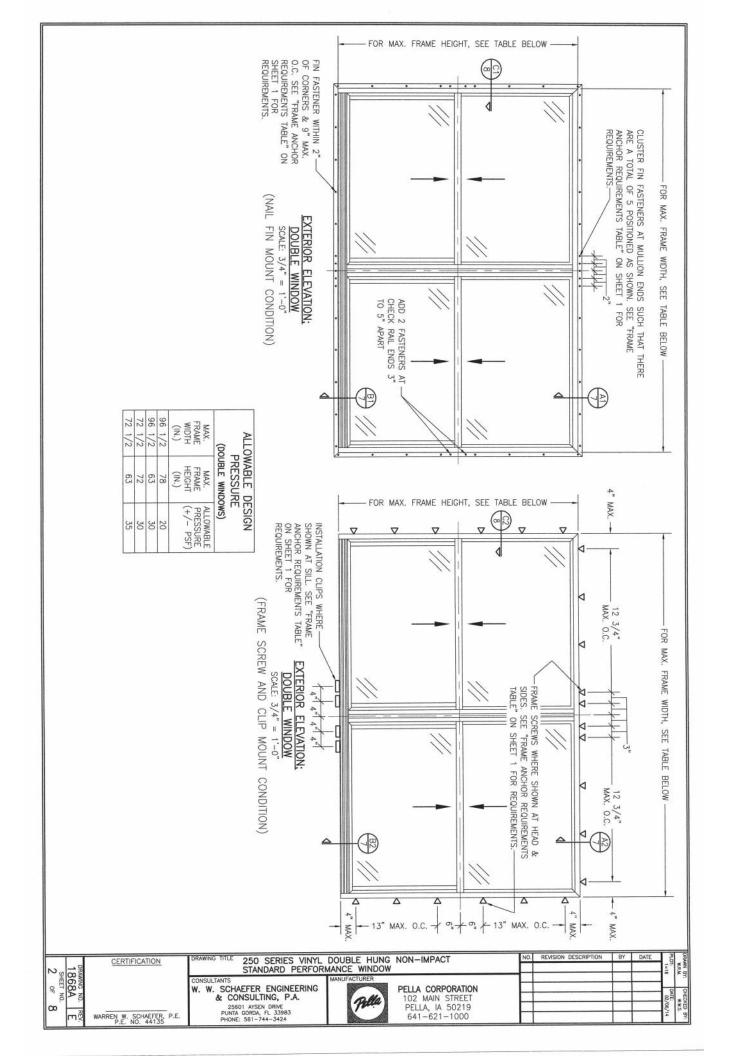
BETWARMENT OF BUSINESS & PROFESSIONAL REGULATION SEPCIFICATIONS. PRODUCT ASSURBLY IS NOT PART OF THIS (2) CONCRETE SCREWS SHALL BE ELCO ULTRACONS (C.S.), ELCO CRETE-FLEX (S.S.), RAMSET/RED HEAD TAPCONS (C.S. OR S.S.) OR HILTI KWIK-CON II (C.S OR S.S.) (3) WHEN SCREWS ARE USED WITH THE NAIL FIN, THEY MUST BE A PAN HEAD OR W SCREW OR HAVE A FLAT WASHER AT THE SCREW HEAD. (1) FRAME AND INSTALLATION CLIP SCREWS SHALL BE A PAN OR HEX HEAD SCREW 7. CERTIFICATION OF THESE PRODUCT INSTALLATIONS SHALL BE CONSIDERED VOID IF ANY OF THE FOLLOWING APPLY:
1) PRODUCT IS INSTALLED WITHOUT A BUILDING PERMIT FROM THE APPLICABLE LOCAL BUILDING DEPARTMENT. 2)
1) PRODUCT IS INSTALLED BY ANYONE OTHER THAN A LICKENED CONTRACTOR EXPERIENCED WITH INSTALLATIONS OF THIS PROPOLICIT. 3) IF CHANGES HAVE OCCURRED TO THE PRODUCT'S CERTIFICATION ENTITY'S CERTIFICATE THAT CAUSE THESE INSTALLATIONS TO BE INCORRECT OR INCONSISTENT WITH WHAT HAS BEEN TESTED.

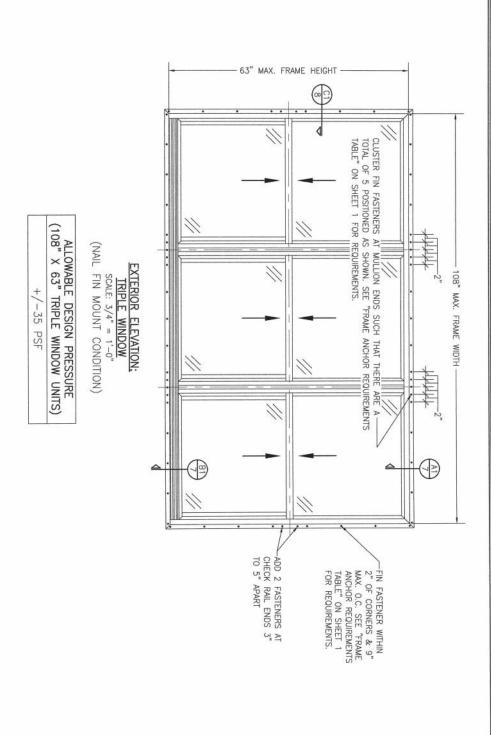
8. THE LEAST DESIGNA PRESSURE SPECIFIED BUILER IN THIS DRAWING OR IN THE PRODUCT SERTIFICATION SHALL CONTROL FOR THE INSTALLED PRODUCT INSTALLATION ONLY. WATER PROPERS OF THE INSTALLED PRODUCT IS NOT PART OF THE INSTALLATION CERTIFICATION. THAT RESPONSIBILITY SHALL BE THAT OF THE MANUFACTURER &/OR MESTALLIDON NOTE:
WHEN RECESSARY, NEXTALATION WETHODS MAY BE MIXED WITH ANY ONE WINDOW SUCH THAT INDIVIDUAL SIDES OF THE WINDOW MAY USE ONE OR THE CHIEFR ANCHOR METHOD (SCAMPLE: HEAD MAY USE FRAME SCRENS METHOD WHILE OTHER SIDES USE FIN) ALL PASTENERS SHALL BE IN ACCORDANCE WITH THESE DRAWINGS. SPECIFIED ANCHOR EMBED TO BASE MATERIAL ALL BE BEYOND WALL TRINGS OR STUDGO.

OPPINIOS. BUCKING A BUCKING FASTENERS MUST BE PROPERLY DESIGNED & INSTALLED TO TRANSFER WIND LOADS THE STRUCTURE.

THE STRUCTURE.

THESE NON-MIPICT RATED PRODUCT INSTALLATIONS ARE IN ACCORDANCE WITH AND MEET THE REQUIREMENTS OF GENERAL NOTES: Z N. MIN. 18 GA. 33 KSI METAL STUD N. MIN. 1/8" THK 6063-T5 ALUM. MIN. 18 GA. 33 KSI METAL STUD C-90 MIN. 1/8" THK 6063-T5 ALUM. LAPICUAEL TIST REPORTS. THE FLOREM BURDEN CORE FRANCHES AND/OR INFORMATION & RESULTS A APPLIABEL TIST REPORTS. THE FLOREM BUILDING CODE REFINING CONSIDERED WITH THE AURION WAS THAT IN FORCE AT THE TIME OF THE FRANCHORM. IS THE REPORT OF CODE RESION RESULPINATES OR IN THE EIGHT THAT MAY OR ADDRIGHT OR COMPETED ON THE REPORTS PRODUCT, PRICE TO STATING CODE COMPANIES WITH THE STATE. THE MANIFACTIBER SHALL FIRM WITH THE RESILLATION ENAULATION BIOGRETS RECORD THAT THE INSTITUTIONS SPECIFIED "IN ARE CURRENT WITH THE THAT CURRENT ISSUES, CODE AND PAPILICABLE STANDARDS." MIN. MIN. 1/8" THK A36 STEEL Z 2X4 WOOD FRAME OR BUCK (MIN. GR. 3 & G=0.55) 2X4 WOOD FRAME OR BUCK (MIN. GR. 3 & G=0.55) (MIN. GR. 3 & G=0.55) 2X4 WOOD FRAME OR BUCK NIN. 2500 PSI CONCRETE CMU OR 2500 PSI CONCRETE 1/8" THK A36 STEEL 1/8" THK A36 STEEL OPENING TYPE GR. 3 & G=0.55) (SUBSTRATE) THK 6063-T5 ALUM. FRAME ANCHOR (3) NAIL INSTALLATION CLIP SCREWS FRAME SCREWS ING NO. NO. 8 GR. 5 SELF NO. NO. 10 GR. 5 SELF TAP/DRILL SCREW NO. NO. NO. (2) (2) 3/16" CONCRETE SCREW NO. 10 SMS OR WOOD SCREW FIN FASTENERS 10 GR. 5 SELF TAP/DRILL SCREW 10 GR. 5 SELF TAP/DRILL 10 10 GR. 5 SELF TAP/DRILL REQUIREMENTS TABLE 10 GR. 5 GR. 5 SELF TAP/DRILL PRAME/CLIP/NAIL FIN TO OPENING FASTENER TYPE GR. 5 SELF TAP/DRILL 1/4" CONCRETE SCREW NO. 0 GA. ROOFING 10 SMS SCREW 10 SMS SCREW SELF TAP/DRILL TAP/DRILL NAIL SCREW SCREW SCREW SCREW SCREW SCREW MINIMUM FULL FULL WAFFLE FULL FULL FULL FULL 1/4" 3/8 3/8 1/4" W HEAD EDGE DIST 1/2 1/2" 12 1/2 1/2 1/2" 2" PRESSIPES & CONTITIONS SHOWN IN THIS PREVAING ARE COVERNED BY INSTALLATION REQUIREMENTS ONLY. THE COVERNING CONTITIONS ON ANY SPECIFIC PRODUCT SHALL BE THE LESSER OF THOSE SPECIFIED IN THE PRODUCTS STATE APPROVIAL OR THAT SHOWN IN THESE DRAWINGS. ALL ANCHOES UP THER SPECIFIC SUBSTRATES
ALL ANCHOES IN THER SPECIFIC SUBSTRATES
HAVE BEEN ANALYZED IN ACCORDANCE WITH
THEIR APPLICABLE OF SUPPORTING ALL LOADS
MAPOSED ON THE SUPPORTING ALL LOADS
MAPOSED ON THE SUPPORTING ALL LOADS
CONDITIONS OUTSIDE OF WHAT IS SHOWN
CONDITIONS OUTSIDE OF WHAT IS SHOWN
HERE. M SHALL BE SUBJECT TO JOB SPECIFIC FOR MAX. FRAME HEIGHT, SEE TABLE BELOW SHEET FOR REQUIREMENTS. REQUIREMENTS TABLE" ON THIS & 9" MAX. O.C. FIN FASTENER WITHIN 2" OF CORNERS 1 (NAIL TO 5" CHECK RAIL ENDS ADD 2 FASTENERS FOR EXTERIOR ELEVATION: FIN MOUNT CONDITION) SCALE: 3/4" = 1'-0"SINGLE WINDOW MAX. FRAME WIDTH, APART TABLE BELOW "FRAME ANCHOR SI A FRAME (IN.) 36 38 ALLOWABLE DESIGN SEE SINGLE WINDOWS) PRESSURE FRAME HEIGHT MAX. (N) 72 63 86 (+/- PSF) ALLOWABLE FOR MAX. FRAME HEIGHT, SEE TABLE BELOW 30 30  $\nabla$ V FRAME SIDES. SEE "FRAME ANCHOR REQUIREMENTS TABLE" ON THIS SHEET FOR REQUIREMENTS. FOR MAX. FRAME WIDTH,
TABLE BELOW EXTERIOR ELEVATION; SCREW MOUNT CONDITION) SCREWS WHERE SINGLE WINDOW 3/4" = THESE DRAWNOS ARE APPLICABLE ONLY TO THE PRODUCT SPECIFED, THEY MAY NOT BE USED FOR THE ASSEMBLY WAY OR NESTLATION OF ANY OTHER PRODUCT NOR MAY THEY BE USED FOR RATIONAL AND/OR LOCAL APPROVAL OF ANY PRODUCT NOT PRODUCED BY THE MANUFACTURER STATED ON THESE DRAWNOS. NMOHS Digitally signed minimin, SEE SCA by Warren W Schaefer + STATE OF Date: Δ 2024.09.24 SSIONAL IN MAX. O.C. 0 10 MAX MAX 12:55:06 -04'00' 250 SERIES VINYL DOUBLE HUNG NON-IMPACT STANDARD PERFORMANCE WINDOW CERTIFICATION WWS 07/14/ 1868A SHEET NO. PELLA CORPORATION 102 MAIN STREET PELLA, IA 50219 641-621-1000 유 W. SCHAEFER ENGINEERING & CONSULTING, P.A. 03/08/16 W.W.S. 03/08/16 Pella 25601 AYSEN DRIVE PUNTA GORDA, FL 33983 PHONE: 561-744-3424 W.W.S. 12/02/23  $\infty$ WARREN W. SCHAEFER, P.E. P.E. NO. 44135





CERTIFICATION

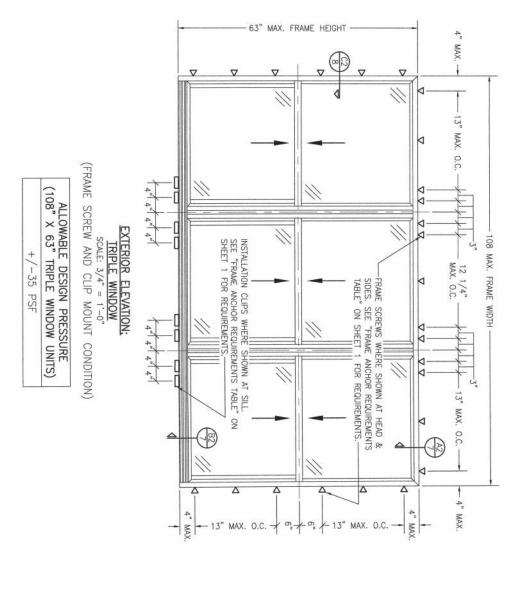
CASE OF STANDARD PERFORMANCE WINDOW

CONSULTANTS

W. SCHAEFER ENGINEERING & CONSULTING, P.A.

25601 AYSEN DRIVE
P.E. NO. 44135 P.E.

PELLA, IA 50219
641-621-1000



250 SERIES VINYL DOUBLE HUNG NON-IMPACT STANDARD PERFORMANCE WINDOW

Pella

W. W. SCHAEFER ENGINEERING & CONSULTING, P.A.


25601 AYSEN DRIVE PUNTA GORDA, FL 33983 PHONE: 561-744-3424 PELLA CORPORATION 102 MAIN STREET PELLA, IA 50219 641-621-1000 DATE: 02/06/14


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1868A SHEET NO.

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250 SERIES VINYL DOUBLE HUNG NON-IMPACT STANDARD PERFORMANCE WINDOW

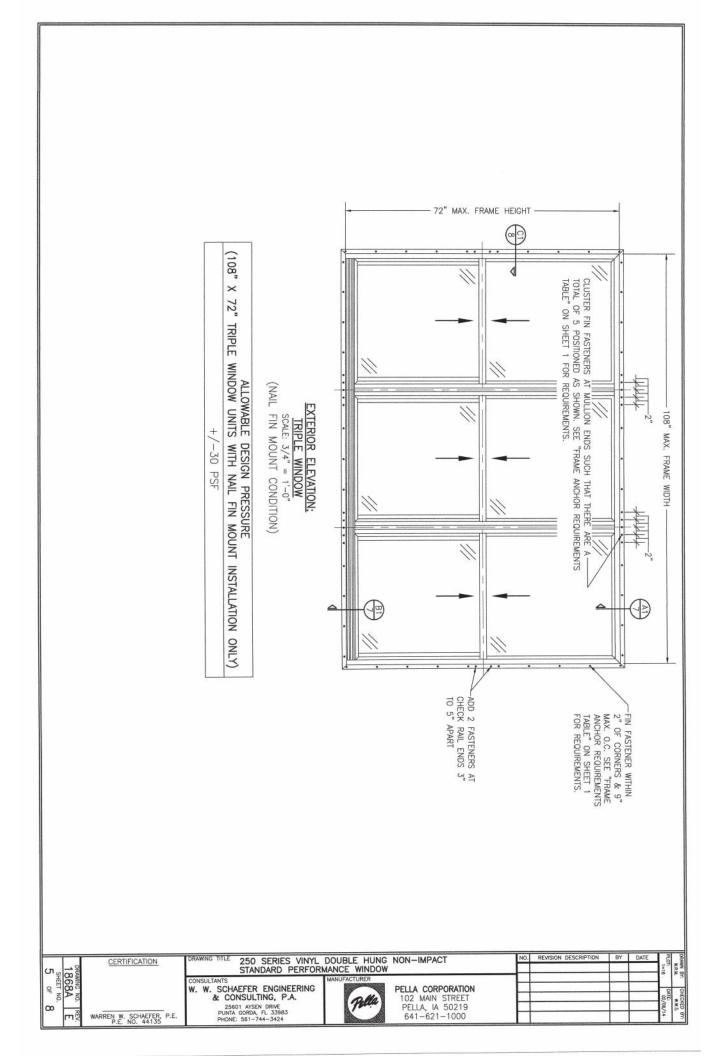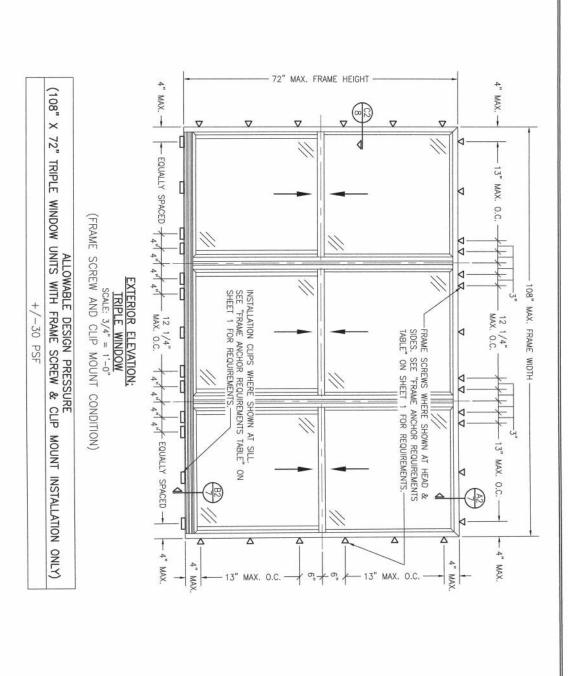W. W. SCHAEFER ENGINEERING & CONSULTING, P.A. 25801 AYSEN DRIVE PUNTA GORDA, FL 33983 PHONE: 581-744-3424 PELLA CORPORATION 102 MAIN STREET PELLA, IA 50219 641-621-1000

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