GENERAL: T1.B TITLE SHEET OPTION "B" OWNER: F1.B FIXTURE PLAN OPTION "B" ARCHITECTURAL: A1.B FLOOR PLAN OPTION "B" A2.B EXTERIOR ELEVATIONS OPTION "B" A3.B SECTIONS AND DETAILS OPTION "B" A4.B SCHEDULES OPTION "B" A5.B DOOR DETAILS OPTION "B" A6.B TOILET PLAN & DETAILS OPTION "B"

STRUCTURAL:

A8.B LIFE SAFETY PLAN

S1.B	STRUCTURAL NOTES OPTION "B"	
S2.B	CONCRETE SUMMARY OPTION "B"	
S3.B	FOUNDATION PLAN OPTION "B"	

ELECTRICAL:

E1.B	POWER PLAN OPTION "B"	
E2.B	LIGHTING PLAN OPTION "B"	
E3.B	POWER POLE DETAILS OPTION "B"	
E4.B	POWER POLE DETAILS OPTION "B"	
E5.B	ELECTRICAL PANELS OPTION "B"	
EMS1.B	SENSOR LOCATION PLAN OPTION "B"	
EMS2.B	CPU TERMINAL DIAGRAM OPTION "B"	
EMS3.B	EMS PANEL AND CONTROLS OPTION "B"	
EMS4.B	EMS PANEL AND CONTROLS OPTION "B"	
ES1.B	ELECTRICAL SITE LIGHTING PLAN OPTION "B"	

MECHANICAL:

M1.B HVAC LAYOUT & SCHEDULE OPTION "B"

PLUMBING:

		-
P1.B	PLUMBING PLANS & SCHEDULE OPTION "B"	
P2 B	PLUMBING DETAILS & RISER DIAGRAMS OPTION "B"	

SQUARE FOOTAGE LEGEND						
TOTAL SQUARE FOOTAGE	9,014 S.F.					
OVERALL BUILDING DIMENSIONS	70'-0" X 130'-0"					
SALES FLOOR DIMENSIONS	68'-0" X 104'-0"					
SALES AREA	7,161 S.F.					
STOCK ROOM AREA	1,088 S.F.					
CLEAR OFFICE AREA	158 S.F.					
REST RM, BREAK RM & HALL AREA	151 S.F.					
COVERED ENTRY	86 S.F.					

NOTE:

BUILDING MUST COMPLY WITH ALL BUILDING (FEDERAL, STATE AND LOCAL) FIRE, ADA AND HEALTH DEPARTMENT CODES.

NO TAPERED OR INTERIOR COLUMNS ALLOWED.

MAINTAIN INTERIOR CLEAR SPACE AS REQUIRED ON PLANS.


METAL BUILDING COLUMNS SHALL BE STRAIGHT TAPERED COLUMNS & INTERIOR COLUMNS REQUIRE WRITTEN APPROVAL. MAINTAIN INTERIOR CLEARANCE OF 68'-1 1/4" BETWEEN FACE OF COLUMNS ON SALES FLOOR.

70"-0 x 130'-0" FRONT ENTRY WITH RIGHT REAR EXIT PROTOTYPICAL PLAN "B"







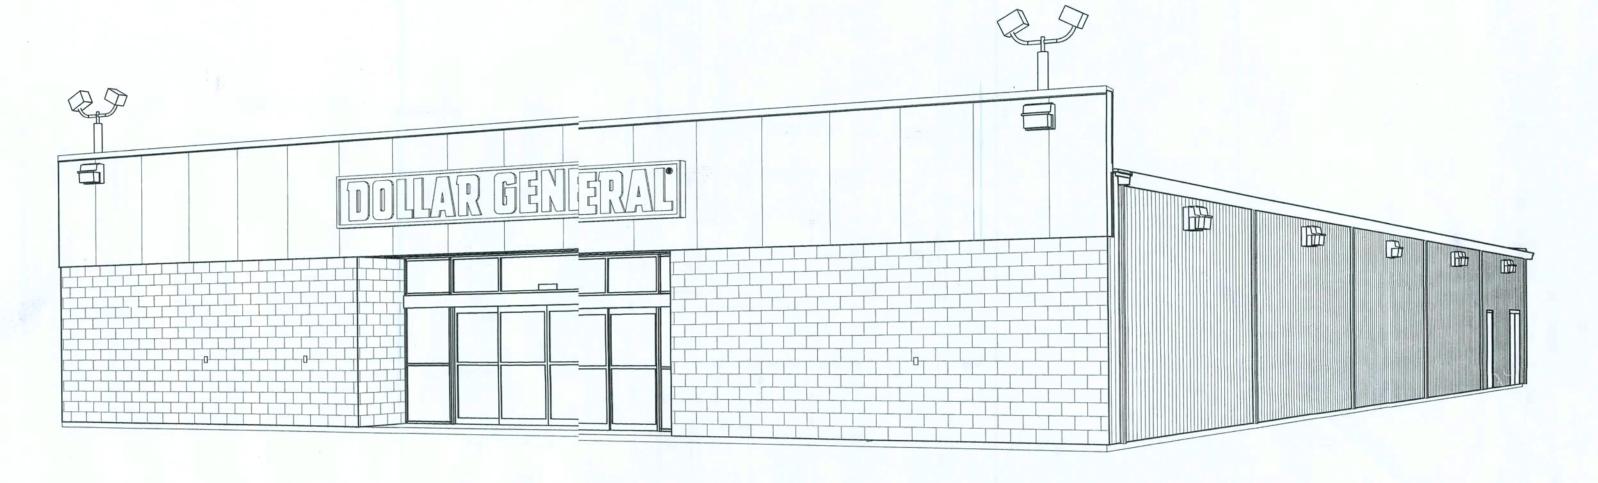

STRUCTURAL DESIGN DATA

CATAGORY II

7,98Ø S.F.

1,50 SF.

BASIC WIND SPEED:
WIND IMPORTANCE FACTOR (I):
BUILDING CATAGORY:
WIND EXPOSURE:
INTERNAL PRESSURE COEFFICIENT:
MUFRS PER TABLE 16092A (FBC 2007)

DESIGN WIND PRESSURES:

WALLS: +26.6 PSF
EAVES: -32.3 PSF

COMPONENTS & CLADING PER TABLES

16.09.20 & 16.09.2C (FBC 20.0T)

DESIGN WIND PRESSURES:

WALLS: +26.6 PSF
EAVES: -32.3 PSF
EAVES: -68.3 PSF
ROOF: +19.9 / -28.5 PSF

FOION ODITEDA

DESIGN CRITERA

FLORIDA BUILDING CODE 2007
FLORIDA PLUMBING CODE 2007
FLORIDA MECHANICAL CODE 2007
FLORIDA FIRE PREVENTION CODE
NEPA 101, LIFE SAFETY CODE, FLORIDA EDITION
OCCUPANCY CLASSIFICATION IS MERCHANTILE GROUP M

BUILDING AREA

SALES FLOOR, OFFICE/ RESTROOMS STOCK ROOM

TOTAL BUILDING AREA: 9,000 6F.

CLASSIFICATION & OCCUPANCY

BUILDING GROUP OCCUPANCY:

TABLE 503 TYPE OF CONSTRUCTION:

COCUPANCY BASED ON AREA SEE ASS.

GROUP M, SI
TYPE II - PROTECTED
254 TOTAL OCCUPANTS

AL PROTOTYPICAL PLAN INQUIRIES MAY BE CRECTED TO THE DOLLAR GENERAL AJTOCAD-STORE DESIGN DEPARTMENT AT (15) 855-4753 OR ONSTRUCTIONCAD@DOLLARGENERAL.COM

DECLUDED MALERALIA ACCOUNTS (EAS)	
	DODO
REQUIRED NATIONAL ACCOUNT VEN	DORS

COMPAANY	CONTACTS	PHONE #	REQUIRED ITEMS
- LOS OFFICIALISTS OFFICE	NATIONAL ACCOUNT SALES	888-774-3400	DOOR HARDWARE AND RESTROOM
BASS SECURITY SERVVICES, INC.		EXT. 2022	ACCESSORIES
MC CUE CORPORATIODN	DENISE CURRMAN	800-800-8503	CART BUMPERS AND CORNER GUARDS
		EXT. 290	PART# 9014 TRIMKIT
LENNOX	JOSHUA PLUMMER	800-367-6285 OPT.1	HVAC UNITS - (LOW GAS) KGA060S4B-DG / ELEC.) KCA060S4B-DG
CARRIER	ALISON HARTMAN	800-690-1081	HVAC UNITS - (HIGH GAS) 48TCFA06A1A3A0A0A0A1-DG
SHERWIN WILLIAMS	LOCAL SHERWIN WILLIAMS STORE		PAINT, PRIMER, CONCRETE SEALER
			AND BLOCK FILLER
STANLEY DOORS	ART BULLMAN	636-391-1508	AUTOMATIC DOORS AND STORE FRONT
	RYAN DRISCOLL	800-648-1401 OPT. 2, EXT. 6	GLAZING SYSTEM
D&P CUSTOM LIGHTINNG	NATIONAL ACCOUNT SALES	800-251-2200	CUSTOM POWER POLES
EMERSON CLIMATE TECHNOLOGIES	PETE STEVENS	770-425-2724	EMS SUPPLIER
RETROPLATE SYSTEMMS	LEO HENDERSON general-dollar@retroplatesystem.com	888-942-3144	CONCRETE POLISHING SYSTEMS
CONSOLIDATED ELECCTRICAL DISTRIBUTORS	ROBERT DECKER	270-781-2229	ELECTRICAL, LIGHTING SUPPLIES

OPTIONAL NATIONAL ACCOUNT VENDORS

COMPANY	CONTACTS	PHONE #	REQUIRED ITEMS	
LIBERTY BUILDING SYYSTEMS	DAVID ENGLISH	877-505-4596	PRE-ENGINEERED METAL BUILDING	
STAR BUILDING SYSTITEMS	JEFF HORN	866-664-8899	PRE-ENGINEERED METAL BUILDING	
NUCOR BUILDING SYSTEMS	TY DAVENPORT	803-799-9708	PRE-ENGINEERED METAL BUILDING	
CASCO	JOHN HARRIS	314-821-1100	PROFESSIONAL SERVICES	

NATIONAL ACCOUNT & CONTACT INFORMATION SUBJECT TO CHANGE

PROTOTYPE CRITERIA SET PLAN "B" - ADDENDA RELE

DATE


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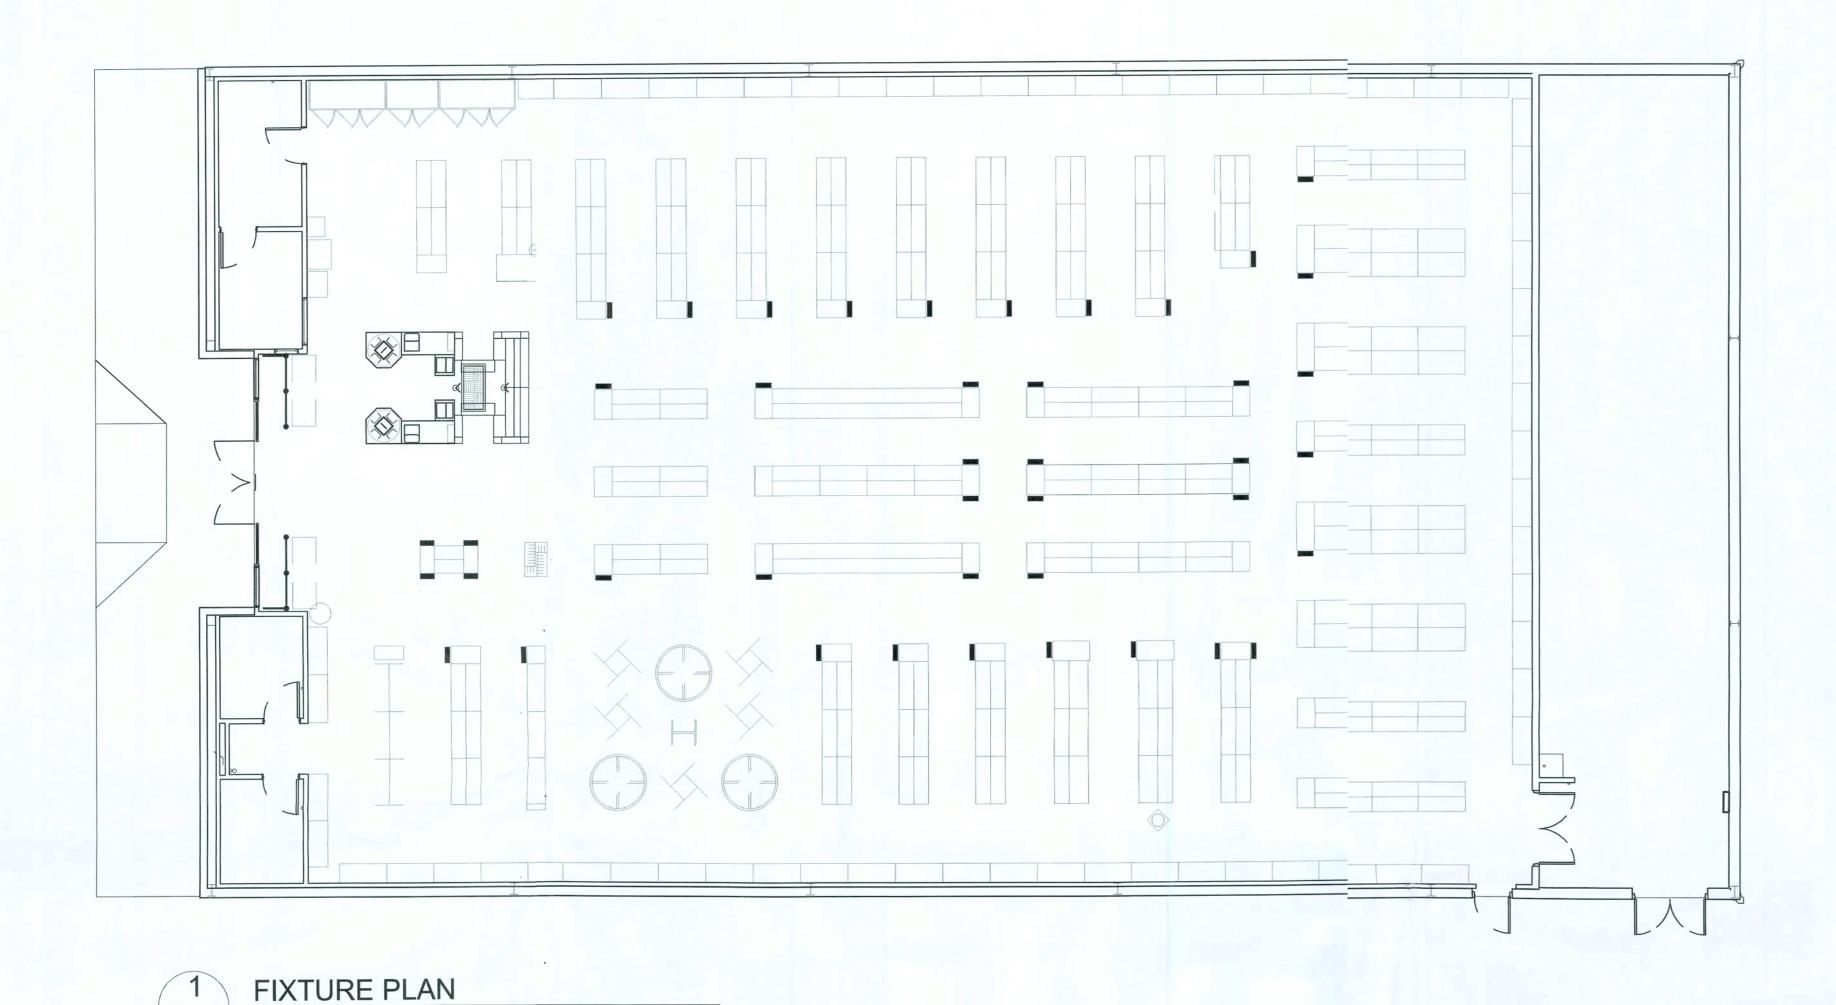
SHEET NUMBER

T1.E

TITLE SHEET OPTION "B"





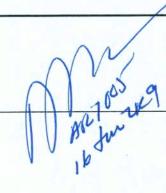

1/16" = 1'-0"

NOTE: IF THE LOCATION OF ANY ITEM (INCLUDING DOORS) CHANGES, PLEASE CONSULT THE DOLLAR GENERAL CONSTRUCTION DEPARTMENT FOR COOLER RECEPTACLE LOCATION.

NOTE: PLEASE NOTE: THAT THE ORIENTATION OF THE RESTROOMS AND THE OFFICE ALWAYS STAY THE SAME REGARDLESS OF THE LOCATION OF THE RECEIVING DOORS.





DATE


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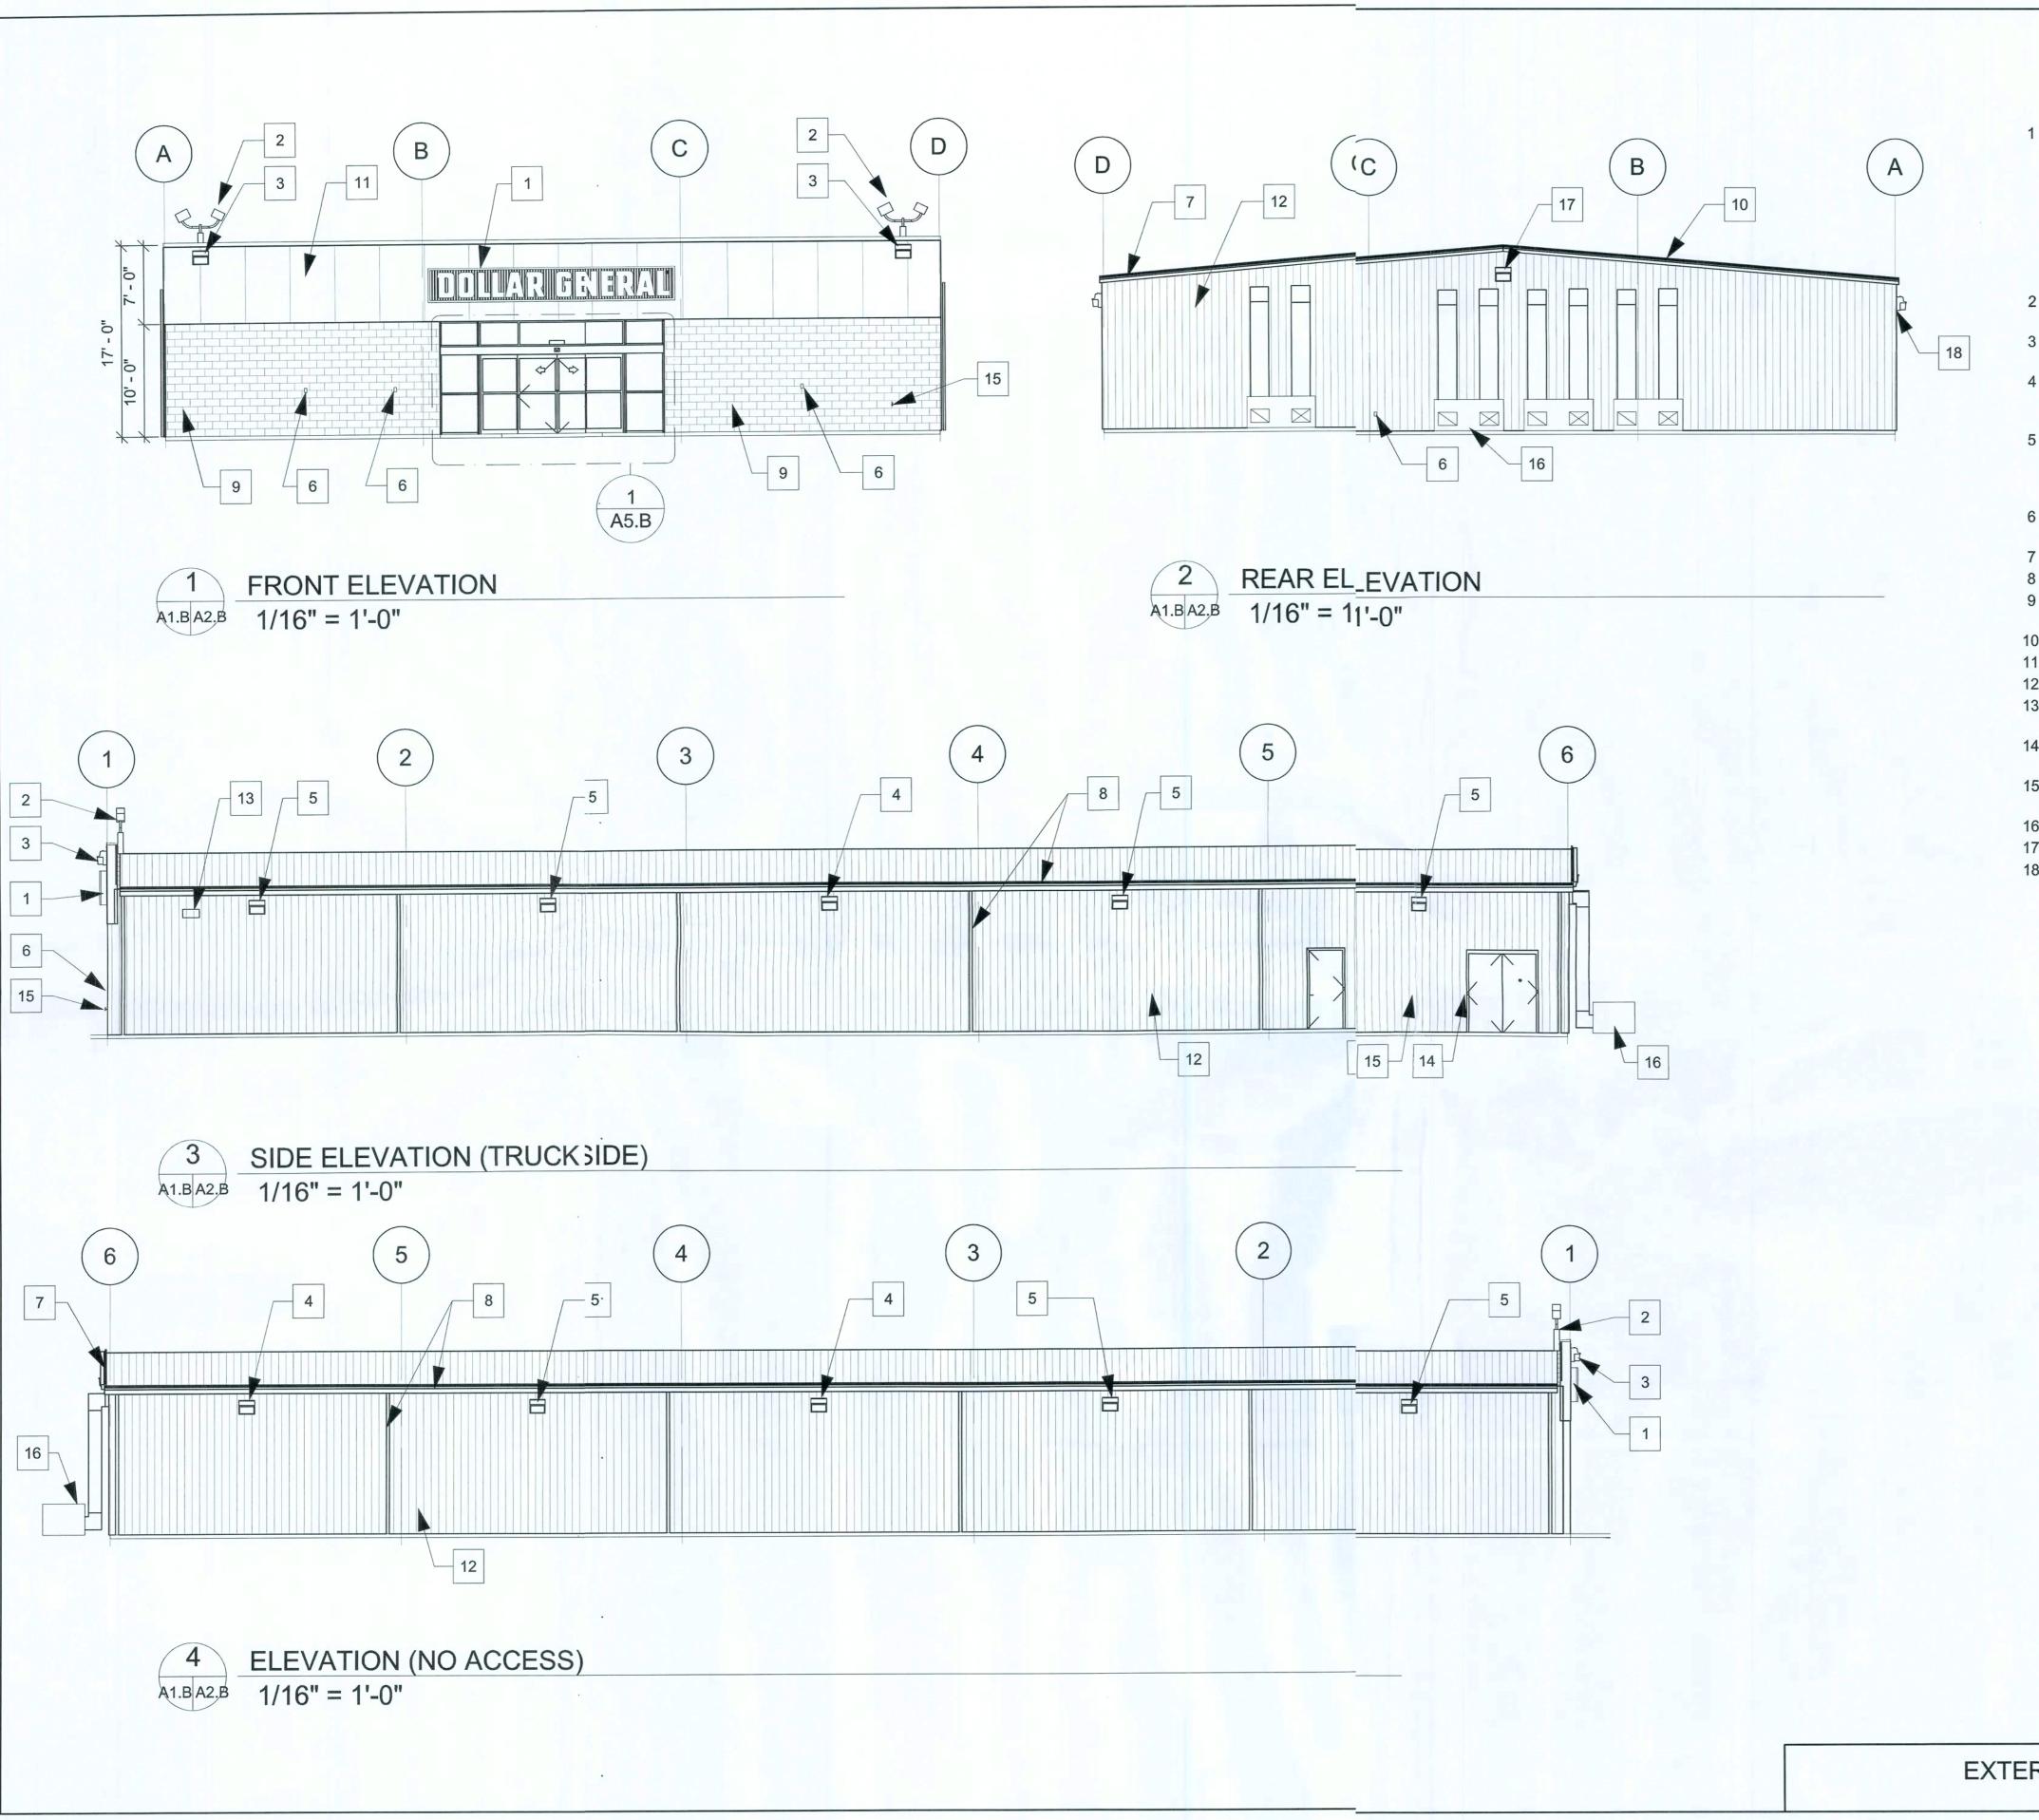
F1.B

SIGN DETAILS OPTION "B"

Donno Lica



16 du 100 2

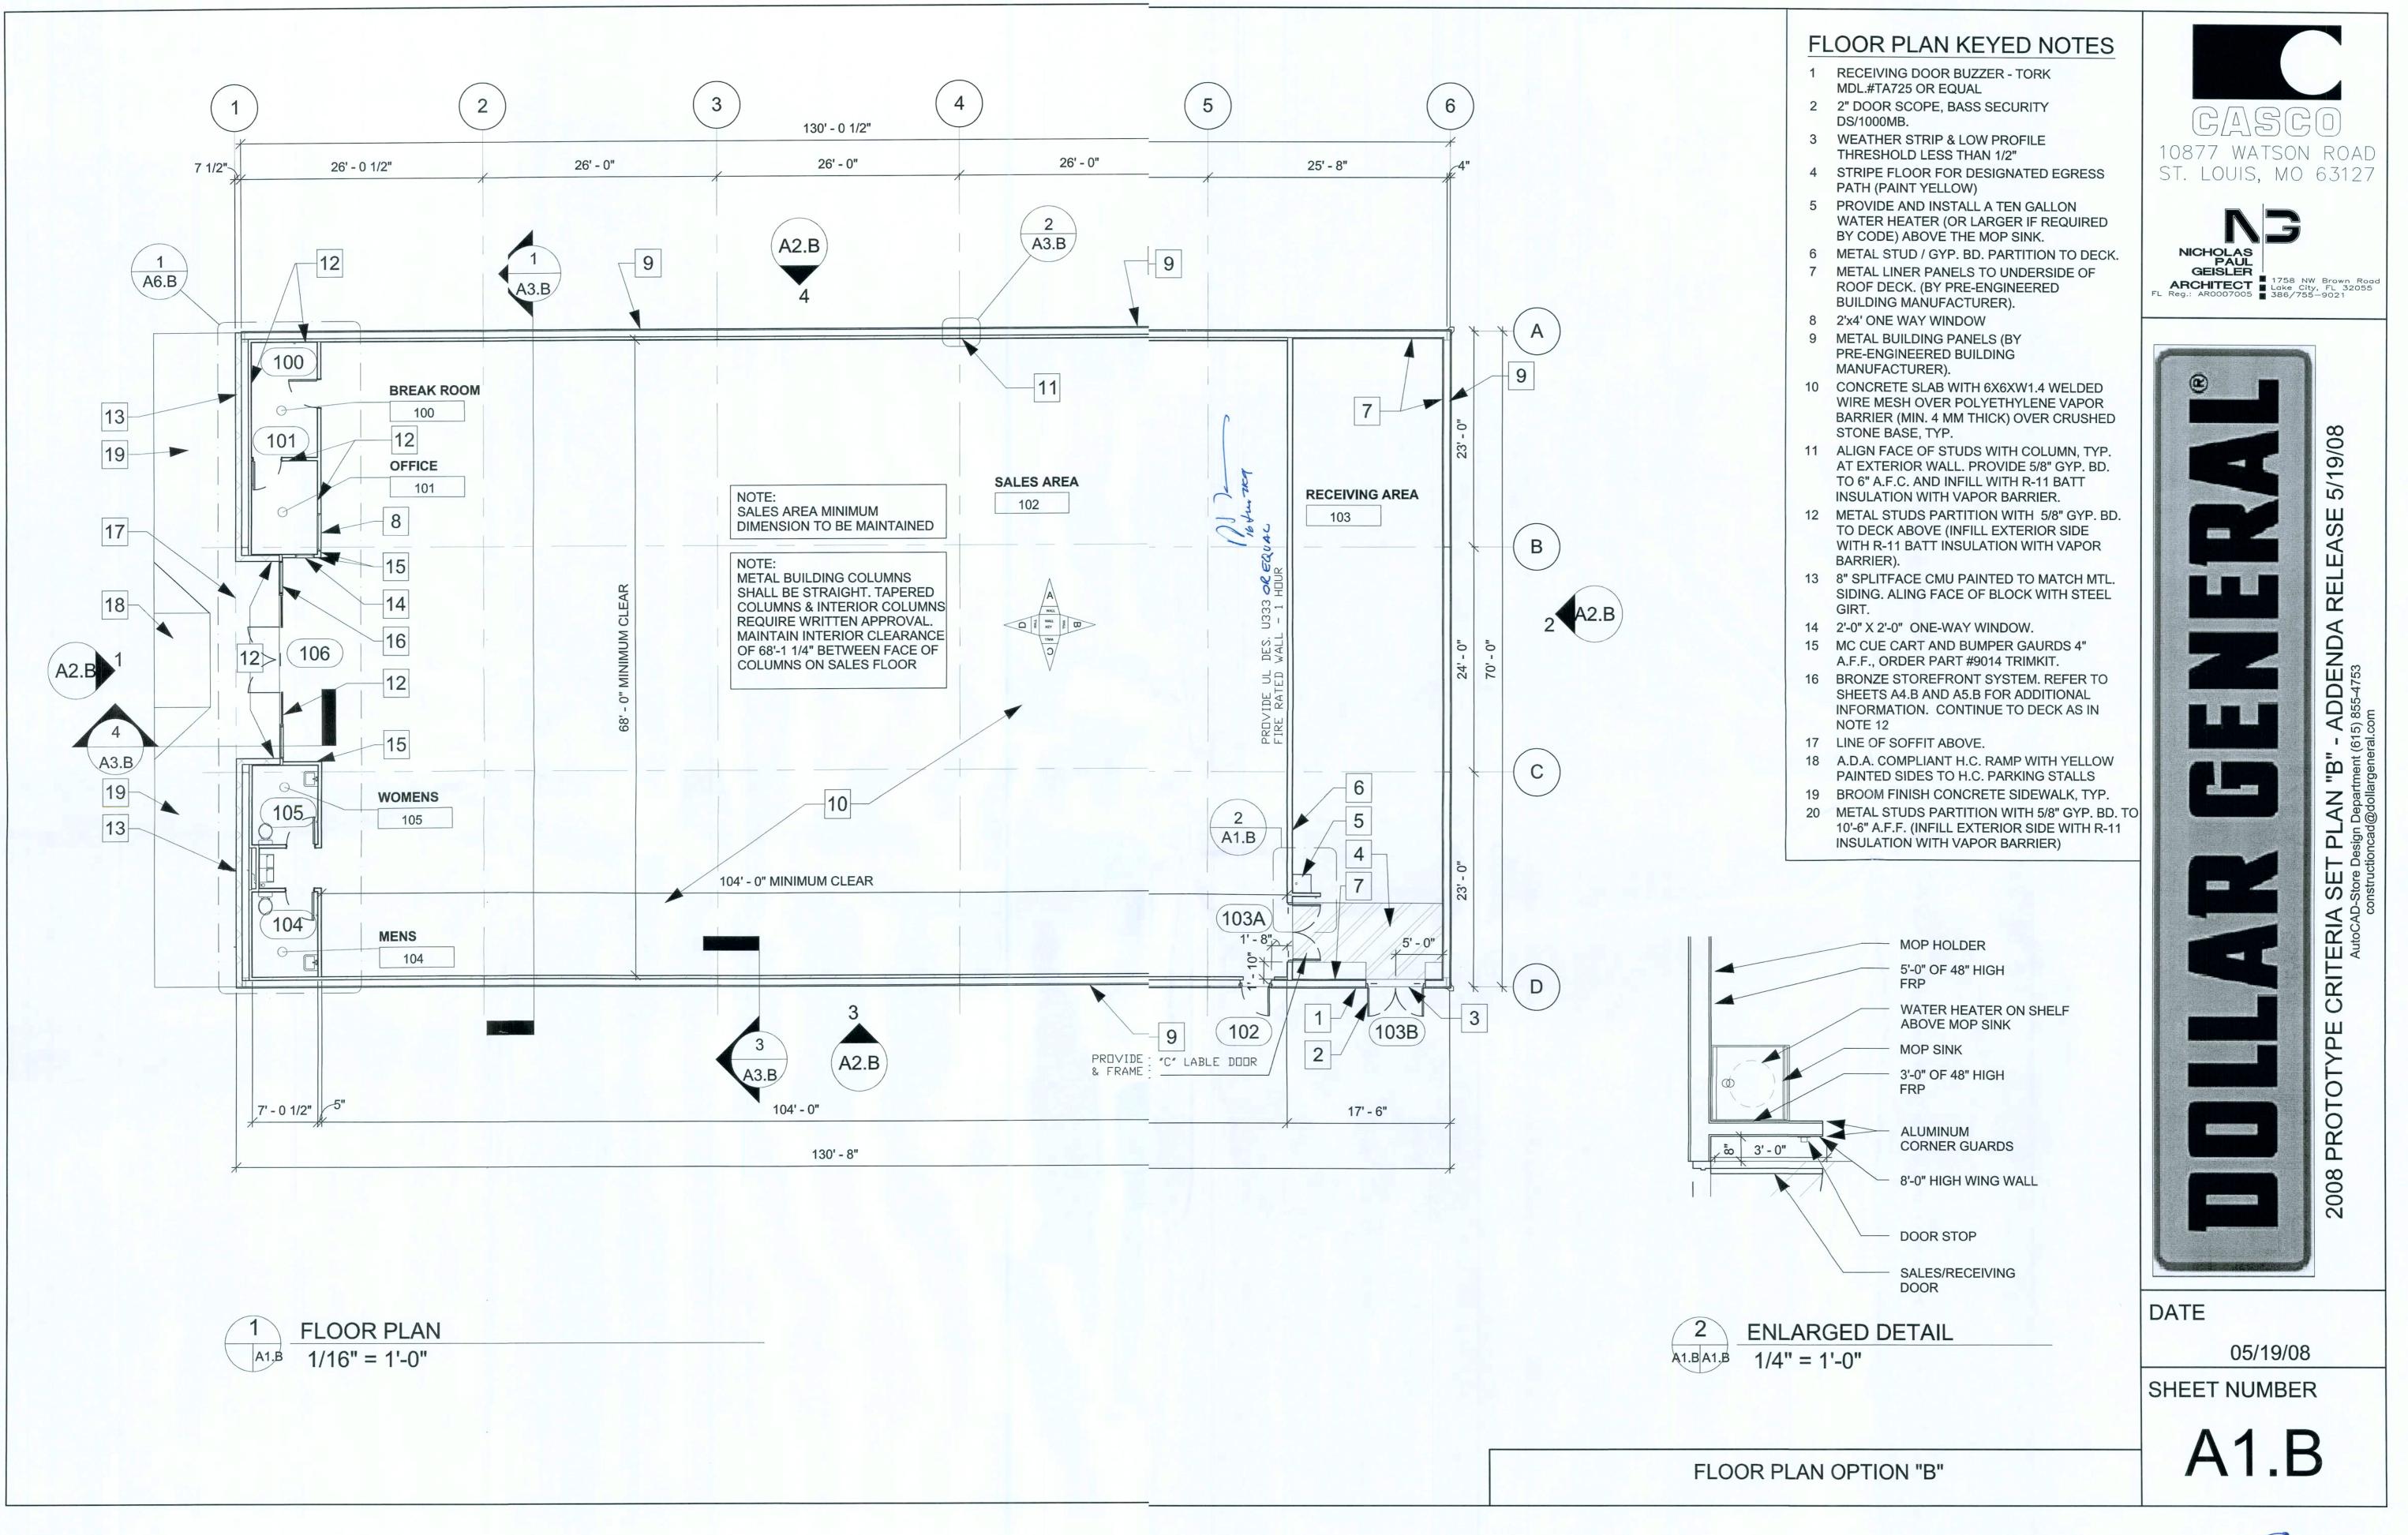

NOTES

- 1 SIGN FURNISHED AND INSTALLED BY DOLLAR GENERAL CORP. WITH CIRCUIT AS NOTED ON ELECTRICAL PLAN. SIGN TO BE CENTERED ON FRONT OF BUILDING. CONTRACTOR IS TO PROVIDE ADEQUATE BLOCKING AS REQUIRED BY SIGN MANUFACTURER TO SUPPORT SIGN WEIGHT OF UP TO 1,400 LBS. EXTERIOR CANOPY SIGN SHALL BE SUPPORTED BY THE FACE OF CANOPY. CONTRACTOR IS TO PROVIDE ADEQUATE STRUCTURE TO SUPPORT SIGN. COORDINATE THE PROPER SIGNAGE TO BE USED WITH DOLLAR GENERAL.
- 2 PARKING LOT LIGHT. REFER TO ES1.B ELECTRICAL DRAWINGS FOR ADDITIONAL INFORMATION.
- 3 WALL PACK. 16'-6" A.F.F. TO TOP OF WALL PACK. REFER TO ELECTRICAL DRAWINGS FOR ADDITIONAL INFORMATION.
- 4 WALL PACK 12'-0" A.F.F. TO TOP OF WALL PACK. (REQUIRED) REFER TO ELECTRICAL DRAWING E2.B FOR ADDITIONAL INFORMATION.
- 5 WALL PACK. (ALTERNATE PARKING LIGHT) REFER TO ELECTRICAL DRAWINGS FOR ADDITIONAL INFORMATION. REQUIRED ONLY IF THERE IS PARKING ON THIS SIDE OF BUILDING.
- 6 RECEPTACLE. REFER TO ELECTRICAL DRAWING E1.B FOR ADDITIONAL INFORMATION.
- 7 TRIM SEE SHEET S1.B FOR COLOR
- 8 GUTTER AND DOWNSPOUT SEE SHEET S1.B FOR COLOR
- 9 SPLIT FACE CONCRETE MASONRY UNIT. PAINT TO MATCH SIDE WALL PANELS.
- 10 ROOF PANEL. GALVALUME FINISH.
- 11 FASCIA PANEL. SEE SHEET S1.B FOR COLOR.
- 12 METAL PANEL. SEE SHEET S1.B FOR COLOR.
- 13 VENT FOR BATHROOM EXHAUST. REFER TO MECHANICAL M1.B DRAWING M1.A FOR ADDITIONAL INFORMATION.
- 14 DOOR BUZZER. REFER TO ELECTRICAL DRAWING E1.B FOR ADDITIONAL INFORMATION.
- 15 HOSE BIBB. REFER TO PLUMBING DRAWING P1.B FOR ADDITIONAL INFORMATION.
- 16 PACKAGE UNITS
- 17 WALL PACK 1'-0" BELOW GABLE PEAK.
- 18 MINIMUM EAVE HEIGHT IS 14'-0" A.F.F.



10877 WATSON ROAD ST. LOUIS, MO 63127

NICHOLAS
PAUL
GEISLER
ARCHITECT
Reg : AR0007005

ARCHITECT | 1758 NW Brown Road Lake City, FL 32055 | 386/755-9021



DATE


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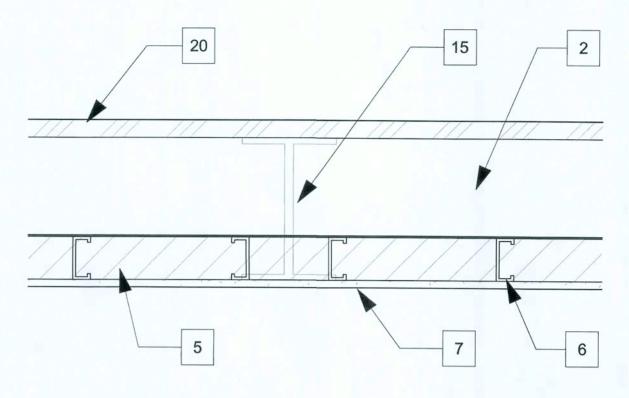
SHEET NUMBER

A2.B

EXTERIOR ELEVATIONS OPTION "B"

Manjor 29



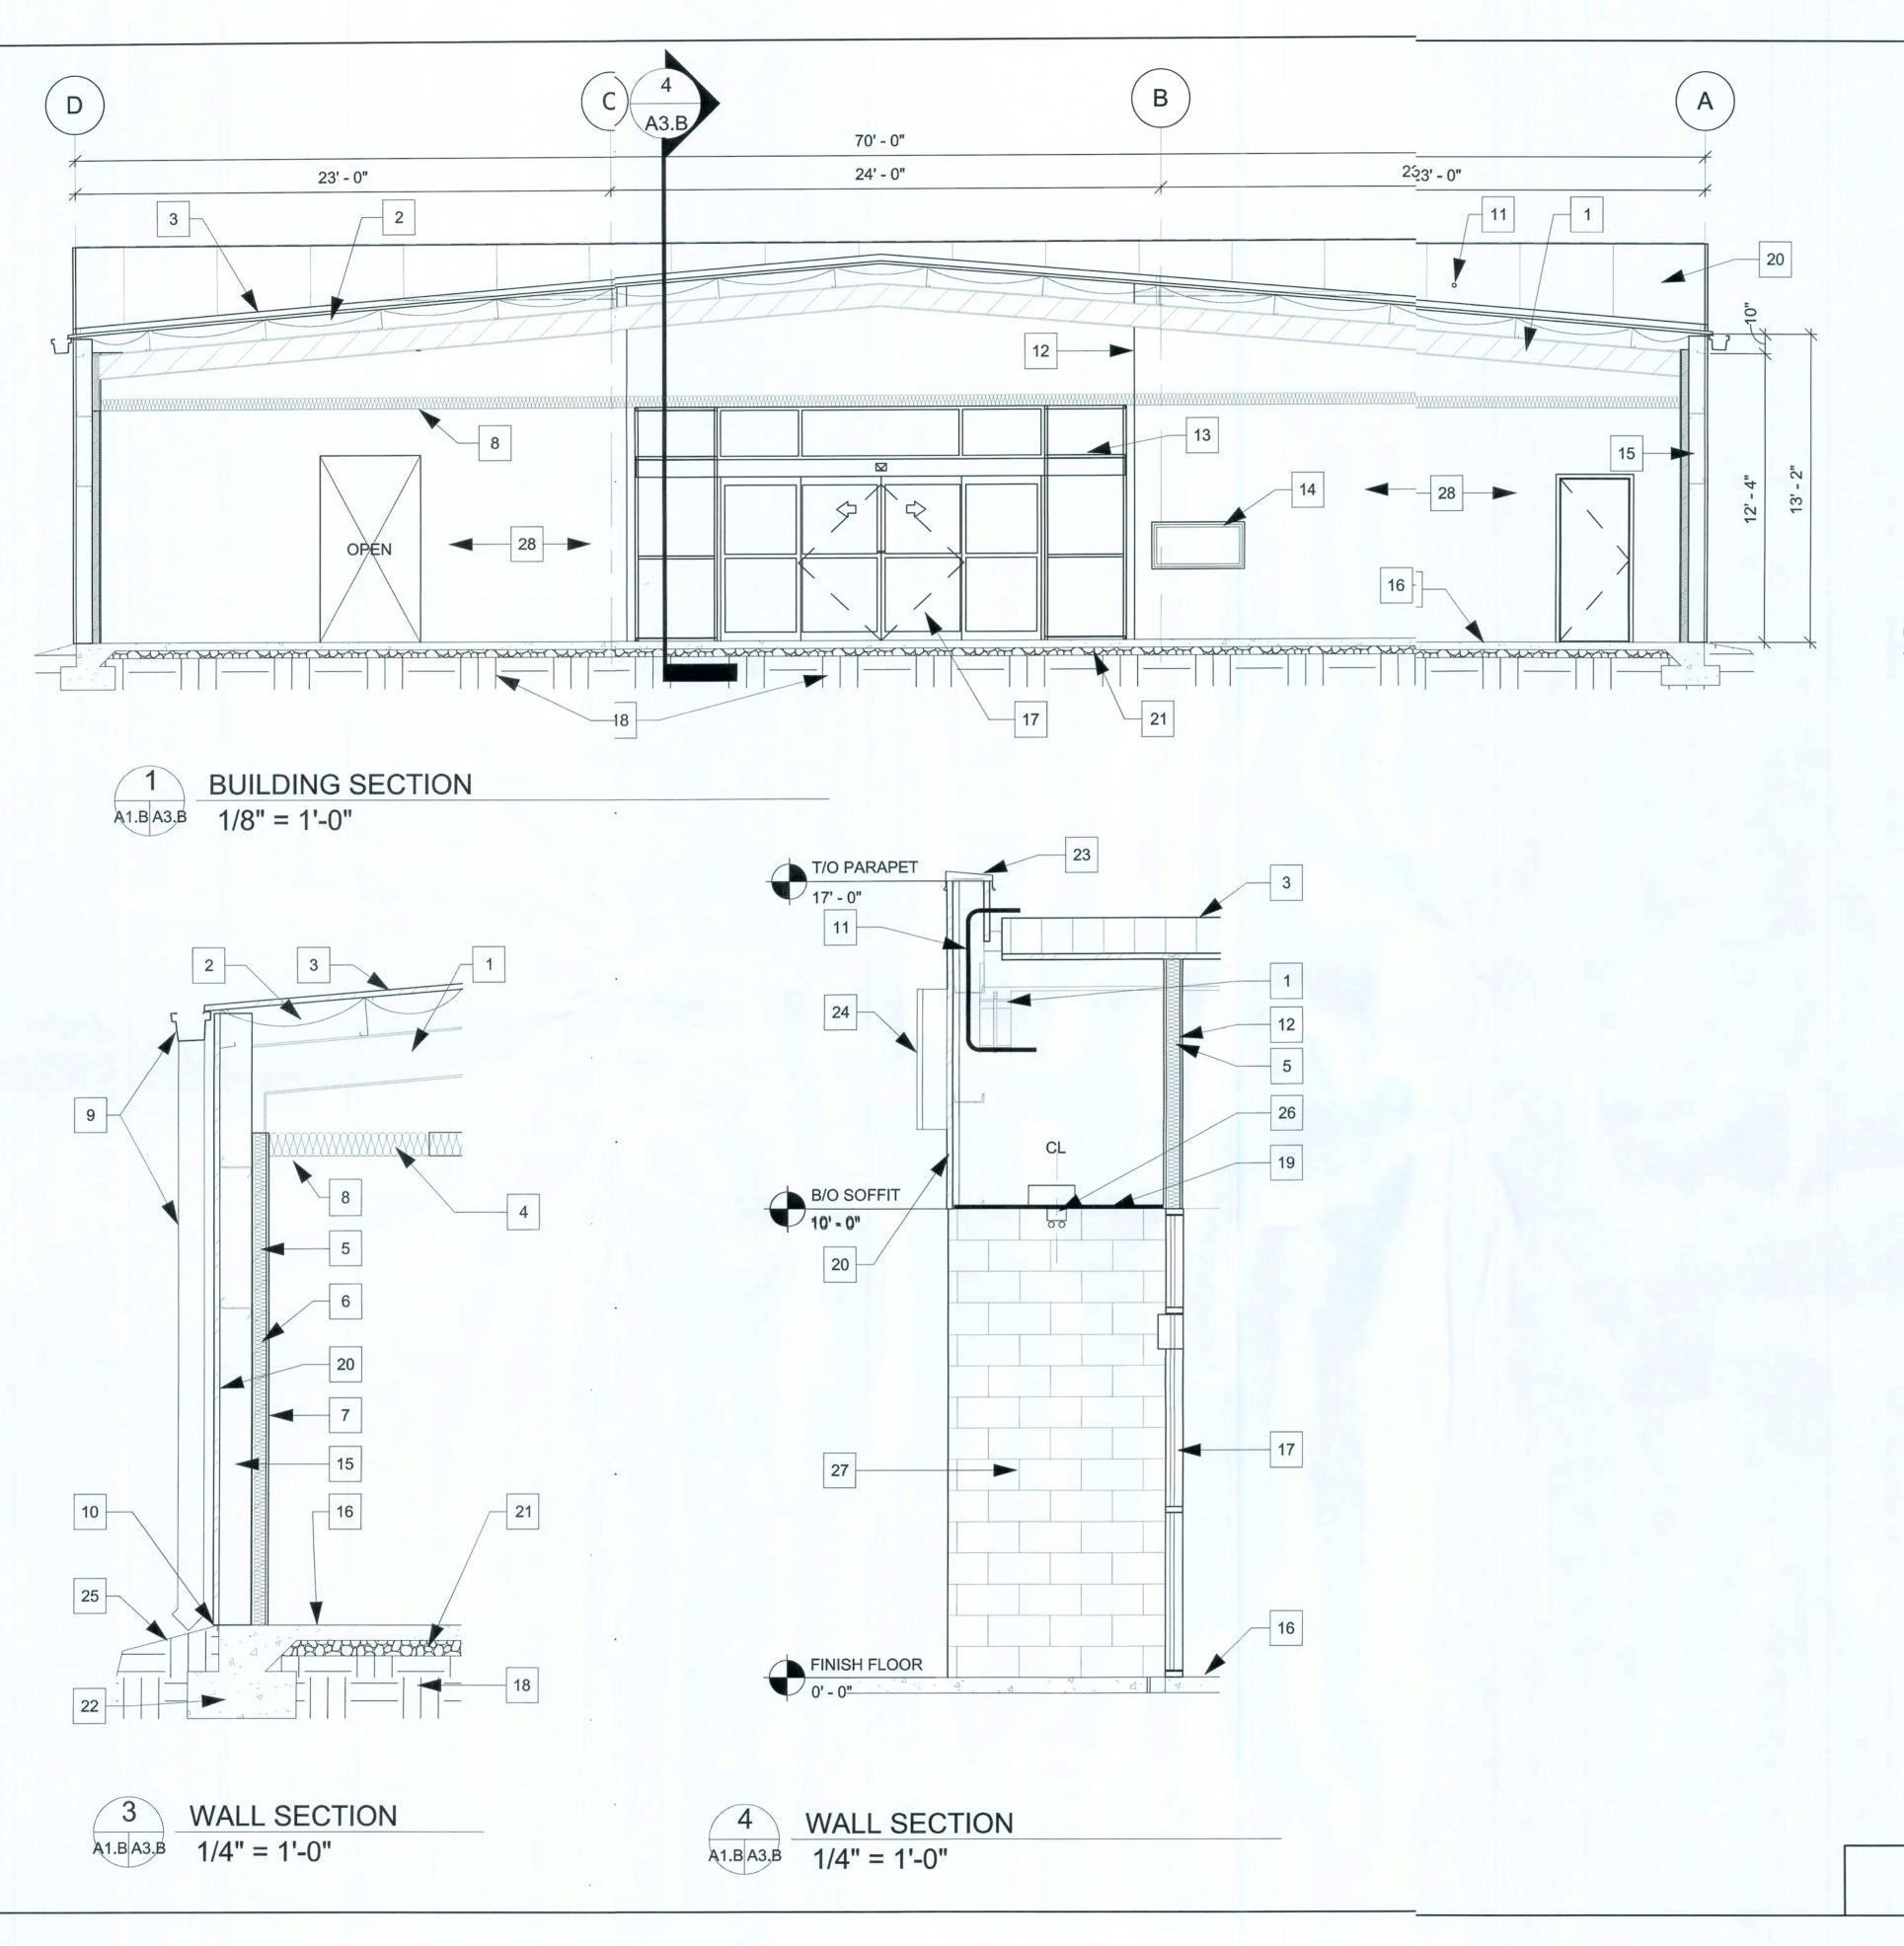

DETAIL @ COLUMN A1.B A3.B 3/4" = 1'-0"


KEYED NOTES

- PRE-ENGINEERED METAL BUILDING SYSTEM BY
- BUILDING MANUFACTURER. VINYL FACED R19 BATT INSULATION
- METAL ROOF GALVALUME
- R19 BATT INSULATION (OPTIONAL)
- R-11 BATT INSULATION
- METAL STUDS @ 16" O.C. FLUSH W/ FACE OF COLUMN
- **GYPSUM BOARD**
- ACOUSTICAL DROP CEILING @10'-0" A.F.F. PRE-FINISHED DOWNSPOUT & GUTTER
- PROVIDE METAL CLOSURE, SEAL, AND CAULK TO
- RODENT PROOF BUILDING
- 11 LOCATION OF 1" CONDUIT WITH PULLSTRING (ABOVE OFFICE) FOR SATELLITE LINE. PROVIDE WEATHER TIGHT SEAL AT PARAPET PENETRATION. CONTRACTOR RESPONSIBLE FOR
- 12 SHEET ROCK TO DECK AT THE STOREFRONT
- ENTRY TYP.

INSTALLATION OF CONDUIT

- 13 ALUM. STOREFRONT 2" TYP. WITH BRONZE FINISH 2'x4' WINDOW WITH ONE WAY GLASS
- METAL BUILDING COLUMNS SHALL BE STRAIGHT. TAPERED COLUMNS & INTERIOR COLUMNS REQUIRE WRITTEN APPROVAL. MAINTAIN INTERIOR CLEARANCE OF 68' 1 1/2" BETWEEN
- FACE OF COLUMNS ON SALES FLOOR. REIN. CONC. SLAB ON VINYL VAPOR BARRIER
- 17 STANLEY DURAGLIDE 2000 BIPART DOOR AND **GLAZING SYSTEM**
- UNDISTURBED EARTH AND COMPACTED SUB 18
- 19 SOFFIT PROVIDED BY PRE-ENGINEERED
- **BUILDING MANUFACTURER**
- PRE-FINISHED METAL WALL PANELS
- **GRANULAR FILL**
- REINF. CONCRETE FOOTING
- PREFINISHED METAL COPING EXTERIOR SIGNAGE
- FINISH GRADE SEE CIVIL DRAWINGS
- LIGHTING SEE ELECTRICAL
- WALL BEYOND
- INTERIOR WALL PAINTED SEE ROOM SCHEDULE FOR MORE INFORMATION

SECTIONS AND DETAILS OPTION "B"

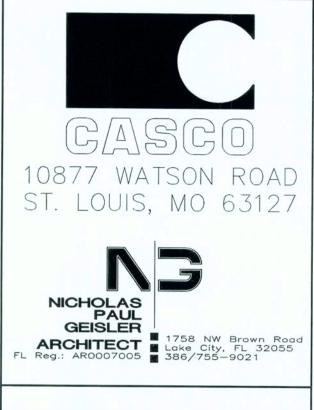

- ADDENDA | SET PLAN

-Store Design Depart
constructioncad@dolla RITERIA AutoCAD- $\overline{\circ}$ PROT 2008

DATE

05/19/08

SHEET NUMBER

A3.B

						14/411		M SCHEDULE :			_				
	FLO	OR	BAS	SE	A	WALL	В	WALL		C WALL	D	WALL	CEILING	CEILING	
O ROOM NAME	MATERIAL	FINISH	MATRIAL	FINISH	MATERIAL	FINISH	MATERIAL	FINISH	MATERIAL	FINISH	MATERIAL	FINISH	MATERIAL	FINISH	REMARKS
0 BREAK ROOM	CONCRETE FLOOR SEALED	S.W. ACRYLIC SILICONE SILK CHOCOLATE #HC-117	4" RUBBR/ VINYL BSE	BLACK	GYPSUM BOARD TO 8'-0" A.F.F.	SHERWIN WILLIAMS PAINT ANTIQUE WHITE LATEX SEMI GLOSS PRODUCT #B31W404	GYPSUM BOARD TO 8'-0" A.F.F.	PRODUCT #B31W4404	GYPSUM BOARD TO 8'-0" A.F.F.		TO ROOF DECK	SHERWIN WILLIAMS PAINT ANTIQUE WHITE, LATEX SEMI GLOSS PRODUCT #B31W404	2' X 4' ACCOUSTICAL CEILING 8'-0" A.F.F.	WHITE	
1 OFFICE	CONCRETE FLOOR SEALED	S.W. ACRYLIC SILICONE SILK CHOCOLATE #HC-117	4" RUBBR/ VINYL BSE	BLACK	GYPSUM BOARD TO 8'-0" A.F.F.	PRODUCT #B31W404	8'-0" A.F.F.	PRODUCT #B31W4404	GYPSUM BOARD TO 8'-0" A.F.F.	SHERWIN WILLIAMS PAINT ANTIQUE WHITE, LATEX SEMI GLOSS PRODUCT #B31W404	TO 8'-0"	SHERWIN WILLIAMS PAINT ANTIQUE WHITE, LATEX SEMI GLOSS PRODUCT #B31W404	2' X 4' ACCOUSTICAL CEILING 8'-0" A.F.F.	WHITE	
SALES AREA	CONCRETE FLOOR POLISHED	RETROPLATE POLISHED CONCRETE WITH RETROPLATE 99 SEALER	4" RUBBR/ VINYL BSE	BLACK	GYPSUM BOARD TO 10'-0" A.F.F.	SHERWIN WILLIAMS PAINT ANTIQUE WHITE LATEX SEMI GLOSS PRODUCT #B31W404	GYPSUM BOARD TO 10'-0" A.F.F.	SHERWIN WILLIAM INS PAINT ANTIQUE WHHITE, LATEX SEMI GLOSSS PRODUCT #B31W4404	GYPSUM BOARD TO 10'-0" A.F.F.	SHERWIN WILLIAMS PAINT ANTIQUE WHITE, LATEX SEMI GLOSS PRODUCT #B31W404	TO 10'-0"	SHERWIN WILLIAMS PAINT ANTIQUE WHITE, LATEX SEMI GLOSS PRODUCT #B31W404	2' X 4' ACCOUSTICAL CEILING 10'-0" A.F.F.	WHITE	
RECEIVING AREA	CONCRETE FLOOR SEALED	S.W. ACRYLIC SILICONE SILK CHOCOLATE #HC-117	N/A	N/A	METAL LINER PANEL TO ROOF DECK	LIGHT STONE	METAL LINER PANEL TO ROOF DECK	LIGHT STONE	GYPSUM BOARD TO ROOF DECK	REQ'D BY CODE, MTL.	BOARD TO ROOF DECK	TAPED, PAINTED IF REQ'D BY CODE, MTL. LINER PANEL TO DECK AS ALTERNATE	EXPOSED TO STRUCTURE ABOVE	N/A	
MENS	CONCRETE FLOOR SEALED	S.W. ACRYLIC SILICONE SILK CHOCOLATE #HC-117	4" RUBBR/ VINYL BSE	BLACK	GYPSUM BOARD TO 8'-0" A.F.F.	FIBERGLASS REINFORCED PANEL-WHITE 8'-0" HIGH	GYPSUM BOARD TO 8'-0" A.F.F.	FIBERGLASS REINFORCED PANEL-WHITE 8'-0" HIGH	GYPSUM BOARD TO 8'-0" A.F.F.	FIBERGLASS REINFORCED PANEL-WHITE 8'-0" HIGH	FET LOS DE TROPINS	FIBERGLASS REINFORCED PANEL-WHITE 8'-0" HIGH	2' X 4' ACCOUSTICAL CEILING 8'-0" A.F.F.	WHITE	
05 WOMENS	CONCRETE FLOOR SEALED	S.W. ACRYLIC SILICONE SILK CHOCOLATE #HC-117	4" RUBBR/ VINYL BSE	BLACK	GYPSUM BOARD TO 8'-0" A.F.F.	FIBERGLASS REINFORCED PANEL-WHITE 8'-0" HIGH	GYPSUM BOARD TO 8'-0" A.F.F.	FIBERGLASS REINFORCED PANEL-WHITE 8'-0" HIGH	GYPSUM BOARD TO 8'-0" A.F.F.			FIBERGLASS REINFORCED PANEL-WHITE 8'-0" HIGH	2' X 4' ACCOUSTICAL CEILING 8'-0" A.F.F.	WHITE	


			DOOF	3		
VO.	Type	WIDTH	HEIGHT	THICKNESS	DOOR HARDWARE	REMARKS
100	A	3' - 0"	7' - 0"		WALL STOP, ACO DOOR VIEWER MODEL #TA3310PC	SOLID CORE WOOD DOOR PAINTED TO MATCH THE WALL SURFACE.
101	Α	3' - 0"	7' - 0"		LEVER: DOOFHANDLE FALCON STOREROOM MODEL #W581PD-DANE-626 (KEY #1), DOOR CLOSER: DOR "O" MATIC MMODEL #SC94-AL, WALL STOP, "ACO DOOR VIEWER MODEL #TA3310PC	SOLID WOOD DOOR PAINTED TO MATCH THE WALL SURFACE.
102	С	3' - 0"	7' - 0"		DOOR CLOSE: DOR "O" MATIC MODEL #SC94-AL, PANIC HARDWARE: VON DUPRIN GUARD X LOCK MODEL #2670-US 528	FIRE RATED DOORS, SOLID CORE WOOD DOOR PAINTED TO MATCH THE CORRESPONDING SURFACES.
03A	В	6' - 0"	7' - 0"	0' - 1 3/4"	PULL HANDLI 8" KICK PLATE, DOOR CLOSER: DOR "O" MATIC MODEL #SC94-AL, PUSH PLATE, 4" KICK DOWN DOOR STOP	FIRE RATED DOORS, SOLID CORE WOOD DOOR OR HOLLOW METAL DOOR PAINTED TO MATCH THE WALL SURFACE.
103B	D	6' - 0"	7' - 0"	0' - 1 3/4"	The state of the s	PAINTED TO MATCH THE CORRESPONDING SURFACES.
104	Α	3' - 0"	7' - 0"		LEVER: DOOFHANDLE FALCON STOREROOM MODEL #W581PD-DANE-626 (KEY #2), DOOR CLOSER: DOR "O" MATIC N _{MODEL} #SC94-AL, WALL STOP	SOLID CORE WOOD DOOR PAINTED TO MATCH THE WALL SURFACE.
105	Α	3' - 0"	7' - 0"	0' - 1 3/4"	LEVER: DOOFHANDLE FALCON STROEROOM MODEL #W581PD-DANE-626 (KEY #2), DOOR CLOSER: DOR "O" MATIC NMODEL #SC94-AL, WALL STOP	SOLID CORE WOOD DOOR PAINTED TO MATCH THE WALL SURFACE.

COMPANY	CONTACS	PHONE #	REQUIRED ITEMS
	NATIONAL ACCOUNT SALE	888-774-3400	DOOR HARDWARE AND RESTROOM
BASS SECURITY SERVICES, INC.		EXT. 2022	ACCESSORIES
MC CUE CORPORATION	DENISE CURRMAN	800-800-8503	CART BUMPERS AND CORNER GUARDS
		EXT. 290	PART# 9014 TRIMKIT
LENNOX	JOSHUA PLUMMER	800-367-6285 OPT.1	HVAC UNITS - (LOW GAS) KGA060S4B-DG / ELEC.) KCA060S4B _{B-DG}
CARRIER	ALISON HARTMAN	800-690-1081	HVAC UNITS - (HIGH GAS) 48TCFA06A1A3A0A0A0A1-DG
SHERWIN WILLIAMS	LOCAL SHERWIN WILLIAM/STORE		PAINT, PRIMER, CONCRETE SEALER
			AND BLOCK FILLER
STANLEY DOORS	ART BULLMAN	636-391-1508	AUTOMATIC DOORS AND STORE FRONT
	RYAN DRISCOLL	800-648-1401 OPT. 2, EXT. 6	GLAZING SYSTEM
D&P CUSTOM LIGHTING	NATIONAL ACCOUNT SALE	800-251-2200	CUSTOM POWER POLES
EMERSON CLIMATE TECHNOLOGIES	PETE STEVENS	770-425-2724	EMS SUPPLIER
RETROPLATE SYSTEMS	LEO HENDERSON general-dollar@retroplatesys:m.com	888-942-3144	CONCRETE POLISHING SYSTEMS
CONSOLIDATED ELECTRICAL DISTRIBUTORS	ROBERT DECKER	270-781-2229	ELECTRICAL, LIGHTING SUPPLIES

BY DOOR MAUFACTURER TO BE RE-KEYED BY DOLLAR GENERAL AREA MANAGER W/ INSTA-KEY LOCKING CYLIND DER


106 E 14' - 0" 10' - 0"

COMPANY	CONTACS	PHONE #	REQUIRED ITEMS
IBERTY BUILDING SYSTEMS	DAVID ENGLISH	877-505-4596	PRE-ENGINEERED METAL BUILDING
STAR BUILDING SYSTEMS	JEFF HORN	866-664-8899	PRE-ENGINEERED METAL BUILDING
UCOR BUILDING SYSTEMS	TY DAVENPORT	803-799-9708	PRE-ENGINEERED METAL BUILDING
CASCO	JOHN HARRIS	314-821-1100	PROFESSIONAL SERVICES

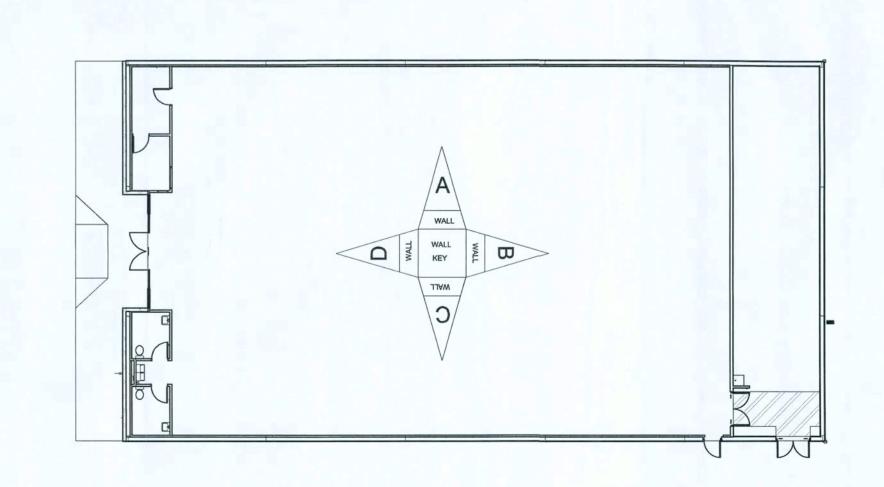

STANLEY DURA-GLIDE SERIES 2000 21'-0" BI-PART WITH TRANSOM AND GLASS. BRONZE FINISH

SCHEDULES OPTION "B"

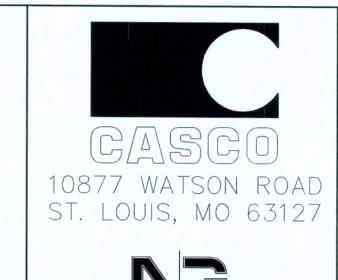







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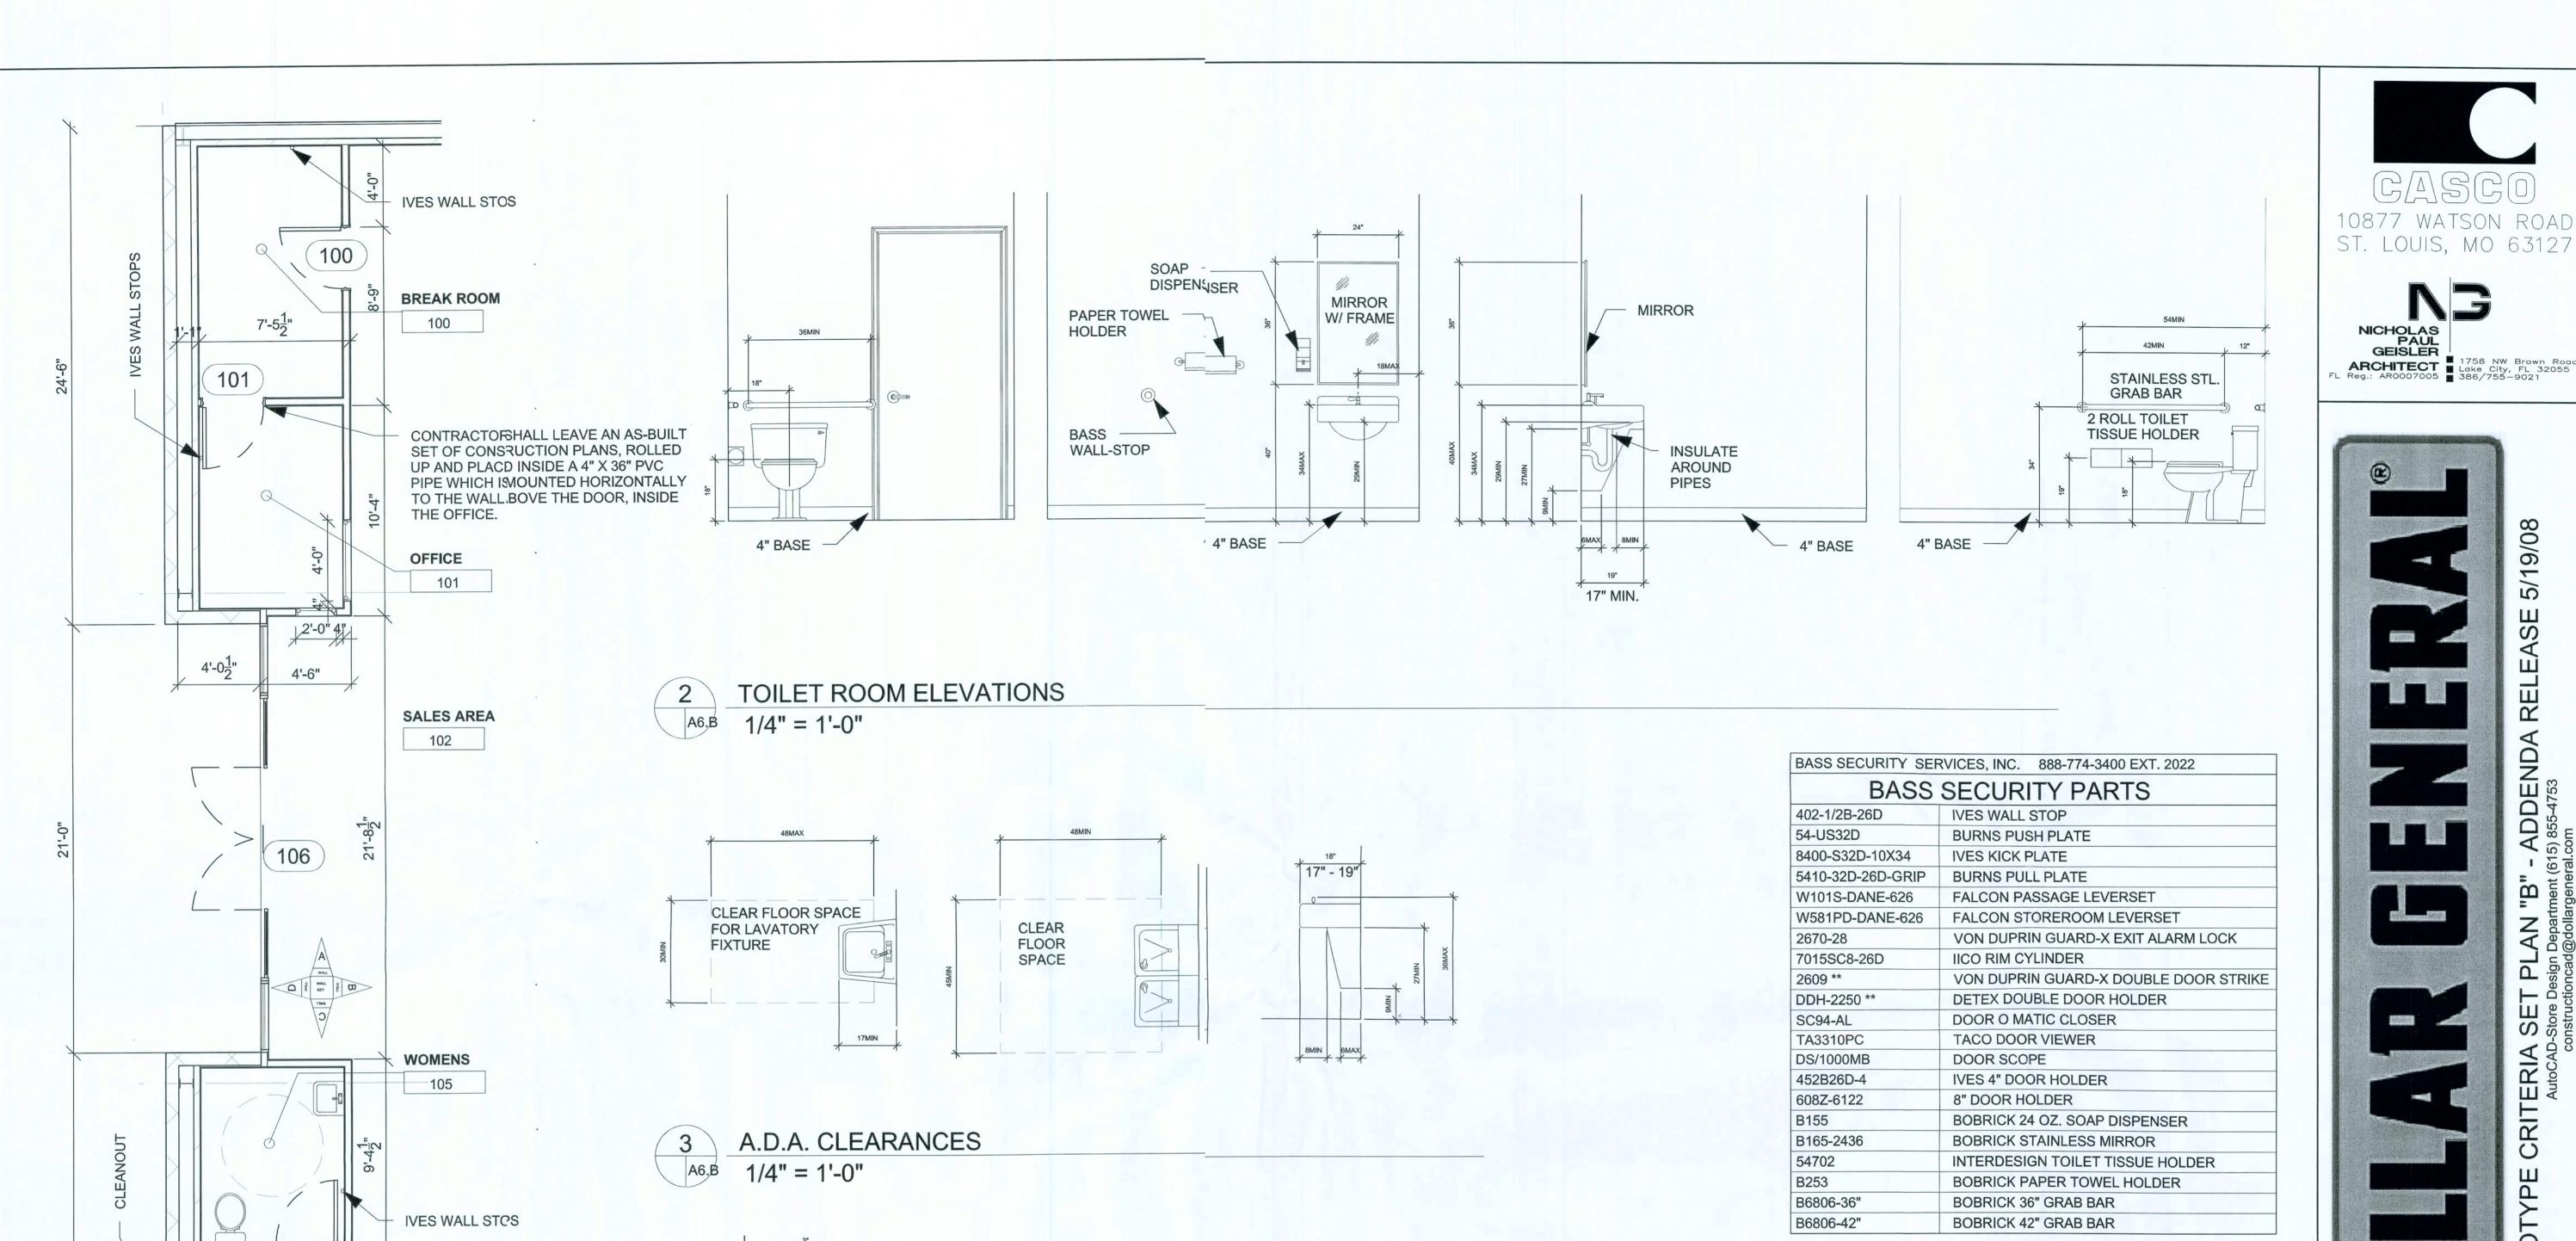
SHEET NUMBER

A4.B



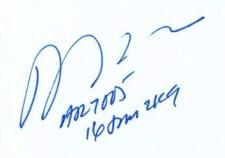

16 Jun 2005

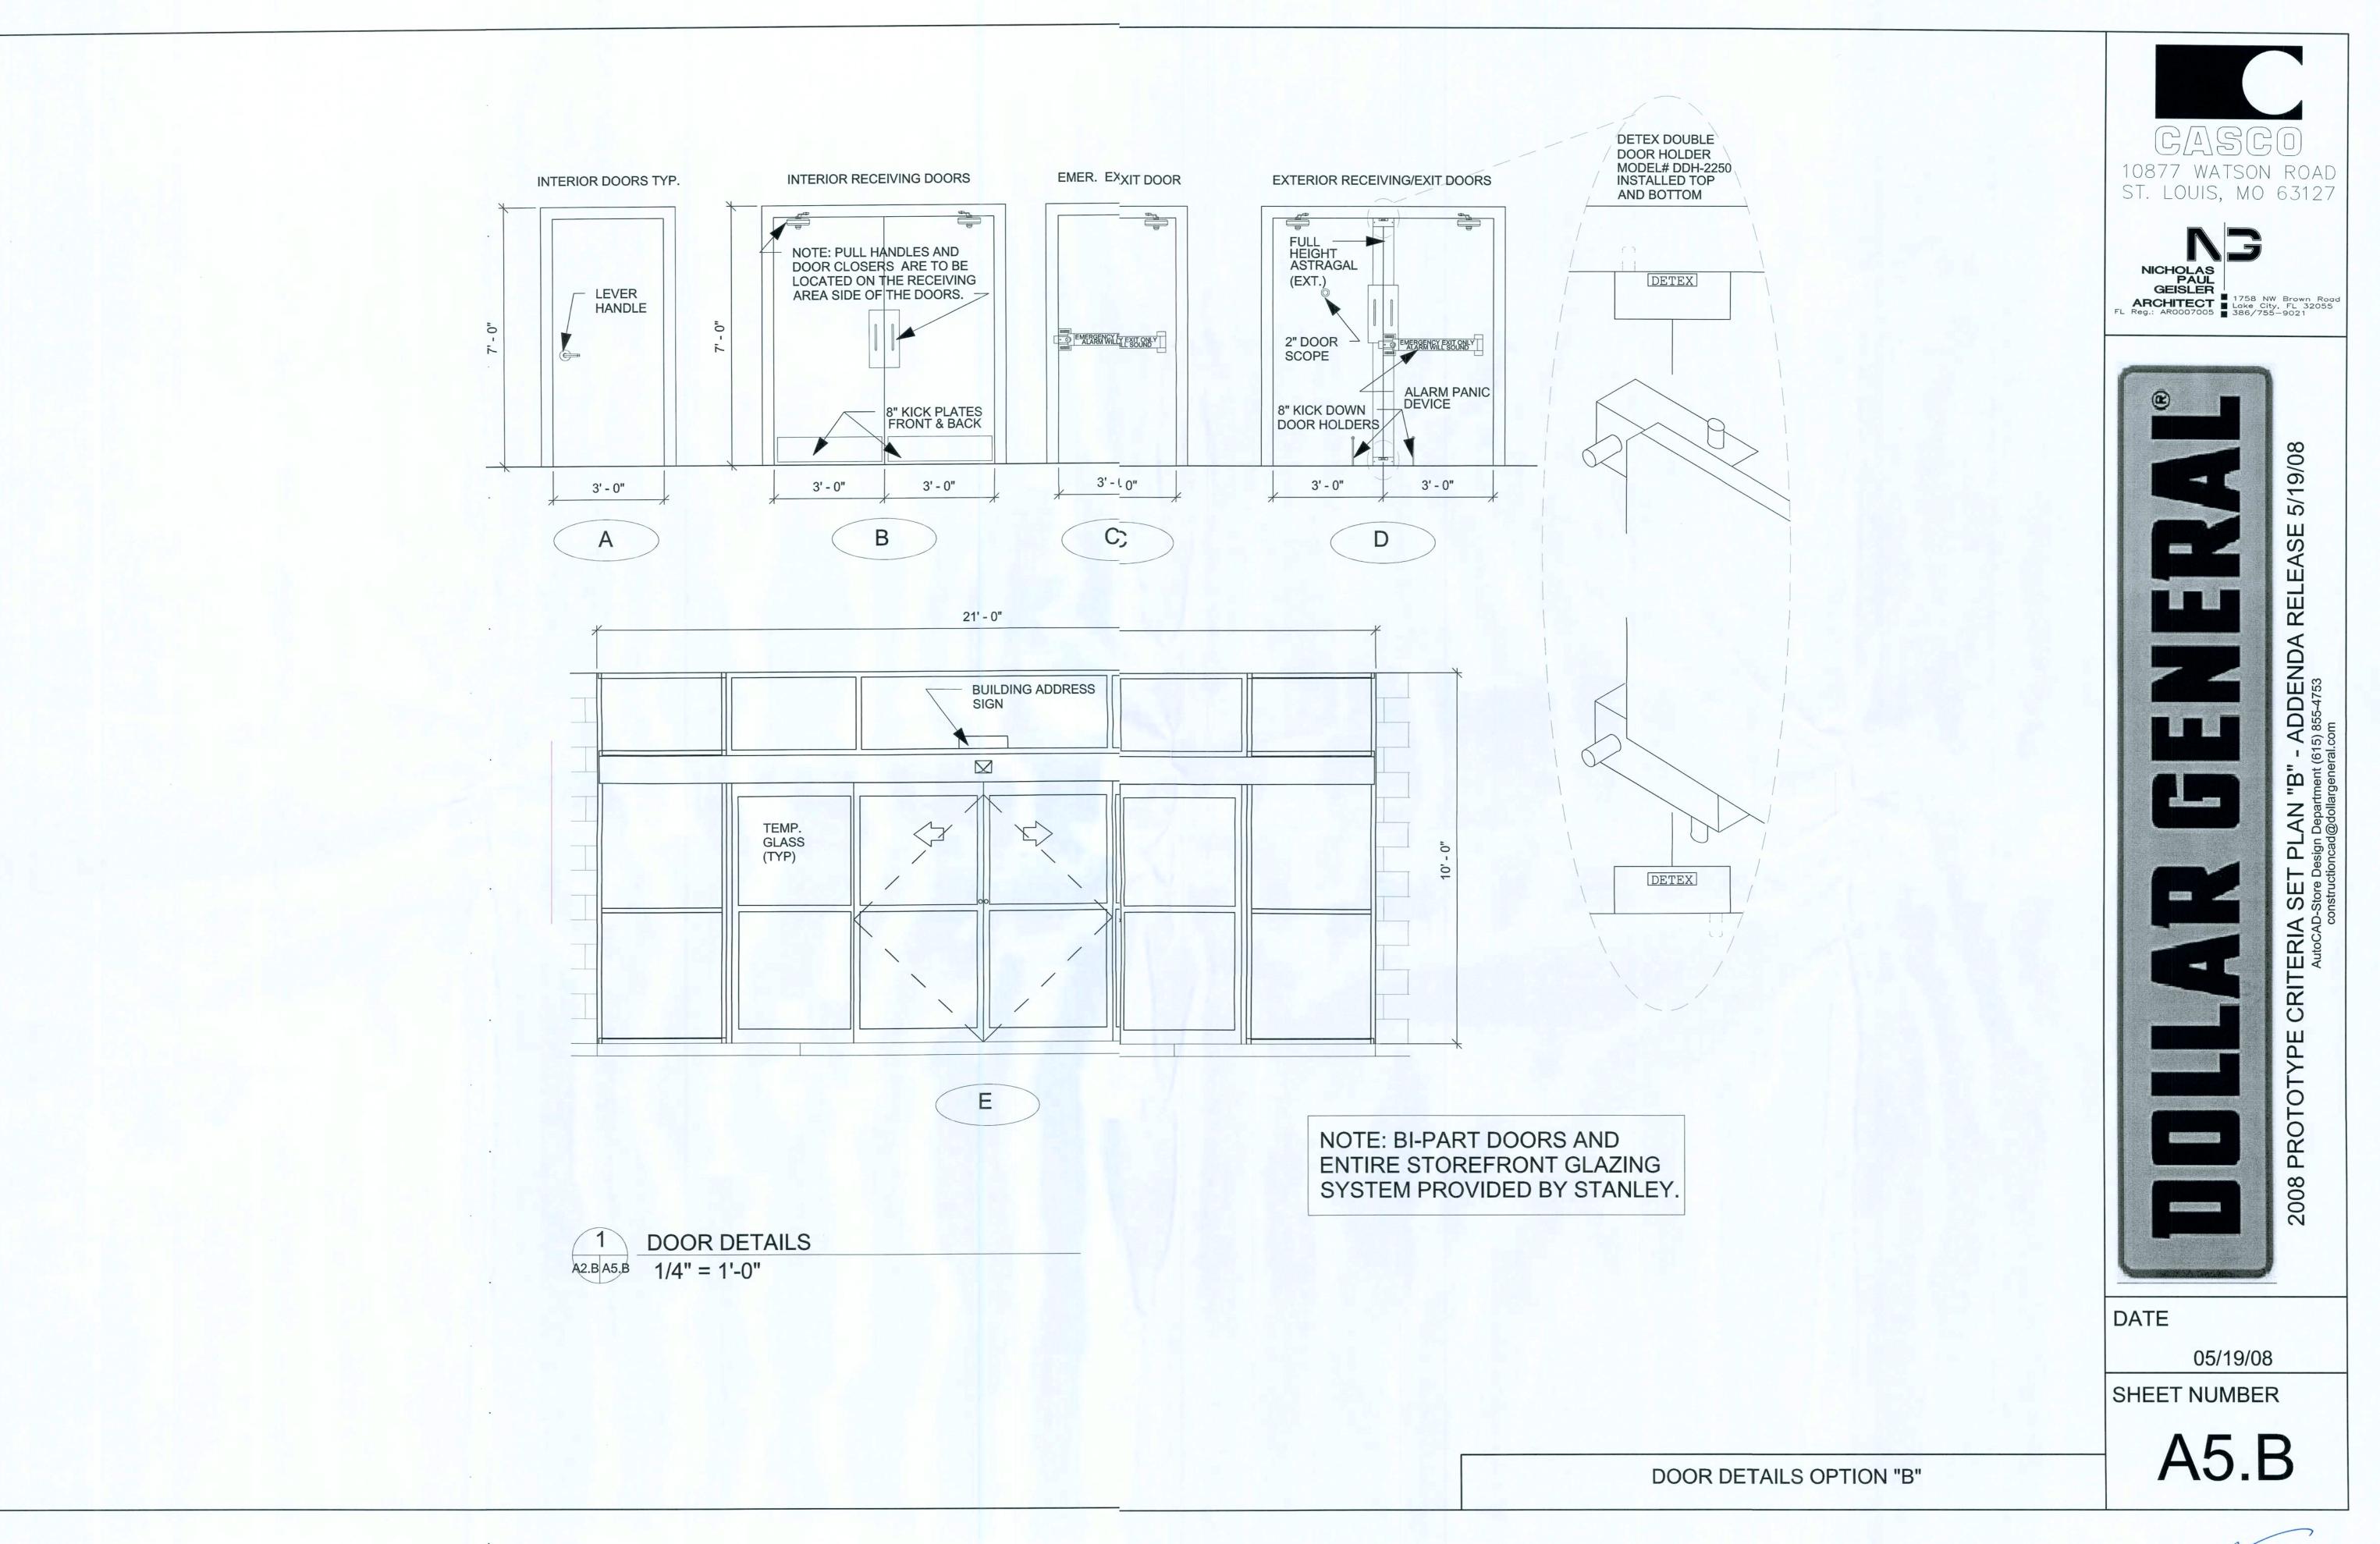

10 GAL. WATEFHEATER

34" A.F.F.

GRAB BAR DETAIL

3" = 1'-0"

MOUNTED ON

104

 $7'-0\frac{1}{2}"$

1/8" = 1'-0"

RESTROOM/OFFICE PLAN

WALL

SHELF/CEILING

IVES WALL STCS

104

REST ROOMS

1. ALL STORES MUST INCLUDE 2 REST ROOMS, EVEN WHEN NOT REQUIRED BY CODE. ANY VARIATION MUST BE APPROVED, IN WRITING, BY THE DOLLAR GENERAL CONSTRUCTION AUTOCAD DEPARTMENT.

2. REST ROOMS MUST COMPLY WITH ALL BUILDING (FEDERAL, STATE, AND LOCAL) FIRE, AND HEALTH DEPARTMENT CODES. ADA REQUIREMENTS MUST ALSO BE MET IN BOTH RESTROOMS. SOME CODES MAY REQUIRE ADDITIONAL TOILETS OR LAVATORIES. PLEASE CONTACT DOLLAR GENERAL CONSTRUCTION AUTOCAD DEPARTMENT FOR ALTERNATE PLANS FOR THESE SITUATIONS.

3. PROVIDE AND INSTALL 3' X 2' MIRROR (OR LARGER IF REQUIRED BY CODE) IN REST ROOMS ABOVE LAVATORY.

4. CONTRACTOR TO INSTALL SOAP DISPENSERS, TOILET PAPER HOLDERS, DOOR CLOSERS, DOOR HOLDERS, EXHAUST FANS, AND ALL BASS SECURITY PARTS IN BOTH RESTROOMS.

DATE

05/19/08

SHEET NUMBER

A6.B

TOILET PLAN & DETAILS OPTION "B"

STANDARD SIGN SPECIFICATIONS

	BOX SIGNS	
SIZE	AMPS / WATTS	WEIGHT
3' x 23'	2.5 AMPS / 292 WATTS	485 LBS.
3'-9" x 26'	5.0 AMPS / 584 WATTS	695 LBS.
5' x 40'	10 AMPS / 1168 WATTS	1400 LBS.
1' x 4'	0.70 AMPS / 65 WATTS	30 LBS.


	WARM CLIMATE AMPS	WEIGHT	
SIZE	COLD CLIMATE AMPS	WEIGHT	
40" L TDC	30MA - 7.88 AMPS	210 LBS.	
18" LTRS	60MA - 15.75 AMPS		
	30MA - 7.88 AMPS	245 LBS	
24" LTRS	60MA - 15.75 AMPS		
0011 TD0	30MA - 9.75 AMPS	330 LBS	
30" LTRS	60MA - 19.00 AMPS		
0011 TD0	30MA - 12.00 AMPS	400 L BC	
36" LTRS	60MA - 24.00 AMPS	400 LBS	

	PYLON SIGNS	
SIZE	AMPS / WATTS	WEIGHT
4' x 8'	1.7 AMPS / 198 WATTS	250 LBS.
5' x 10'	3.4 AMPS / 396 WATTS	389 LBS.
6' x 16'	5.0 AMPS / 584 WATTS	750 LBS.


SIGN SPECIFICATIONS

1. BUILDING SIGNS: PROVIDE CONDUIT FROM ELECTRICAL PANEL TCTHE CENTER OF THE SIGN CANOPY. THE CONDUIT IS TO BE 1" AND HAVENE SET OF 10/2 WIRE WITH GROUND AND A 20-AMP BREAKER AT THE PAEL: BUILDING CANOPY MUST BE SUFFICIENTLY BUILT TO SUPPORT THE DLLAR GENERAL SIGN OF UP TO 1400 LBS. NOTE: IF THE LEASE SPECIFIES, 5'-0" X 40'-0" BUILDING SIGN OR 24" LETTER SET (OR LARGER), 2 qty. - 10/2 /IRE WITH GROUND AND 2 qty. 20 AMP CIRCUITS REQUIRED.


- 2. PYLON SIGNS: PROVIDE CONDUIT FROM ELECTRICAL PANEL TO LOCATION OF THE PYLON SIGN BASE. BURY CONDUIT UNDER PARKIG AREA. THE CONDUIT IS TO BE 1" AND HAVE ONE SET OF 10/2 WIRE WTH GROUND AND A 20-AMP BREAKER AT THE PANEL.
- 3. FINAL ELECTRICAL CONNECTIONS FOR SIGN SHALL BE THE OWNES RESPONSIBILITY AFTER SIGNS ARE INSTALLED.
- 4. TIMERS AND PHOTOCELL COMBINATION ARE USED FOR ALL EXTEIOR SIGNS.
- 5. SEE CHART ABOVE FOR SIGN SPEC'S.
- 6. SEE SHEE S1.B FOR MOUNTING SUPPORT DETAILS

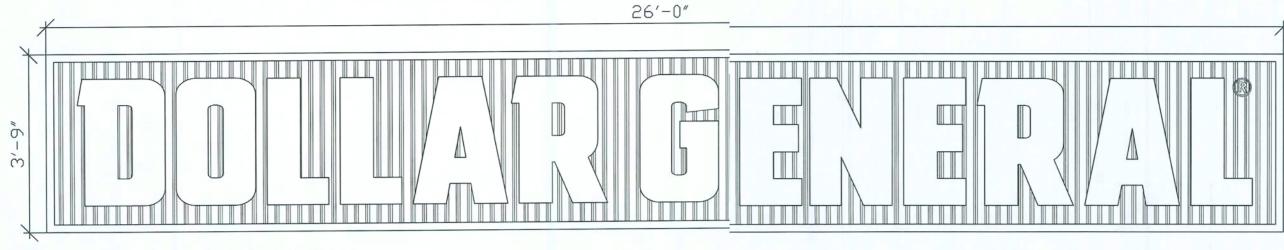

BUILDING DISTANCE FROM STREET:

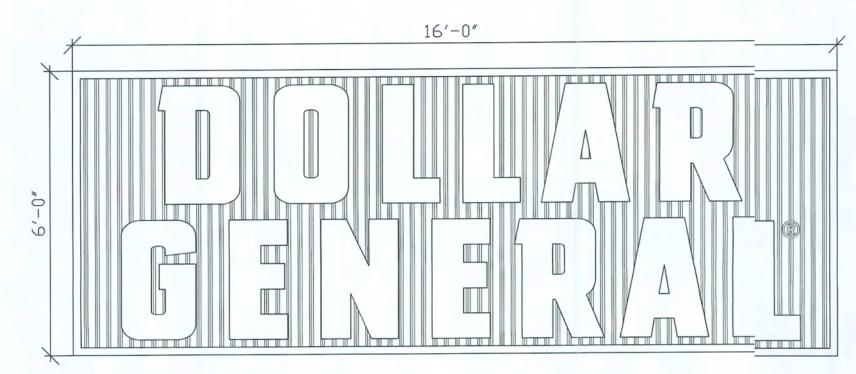

THIS IS THE PRIMARY SIGN FOR ALL LOCATIONS.

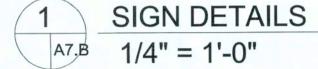

COMING SOON

THIS AREA IS FOR CONTRACTOR
AND DEVELOPER USE.

SAVE TIME. SAVE MONEY.

THIS SIGN IS TO BE PROVIDED AND INSTALLED AT THE BEGINNING OF CONSTRUCTION PROJECT.

GASGO

10877 WATSON ROAD
ST. LOUIS, MO 63127





DATE


05/19/08

SHEET NUMBER

A7.E

SIGN DETAILS OPTION "B"

Man 2005 rug

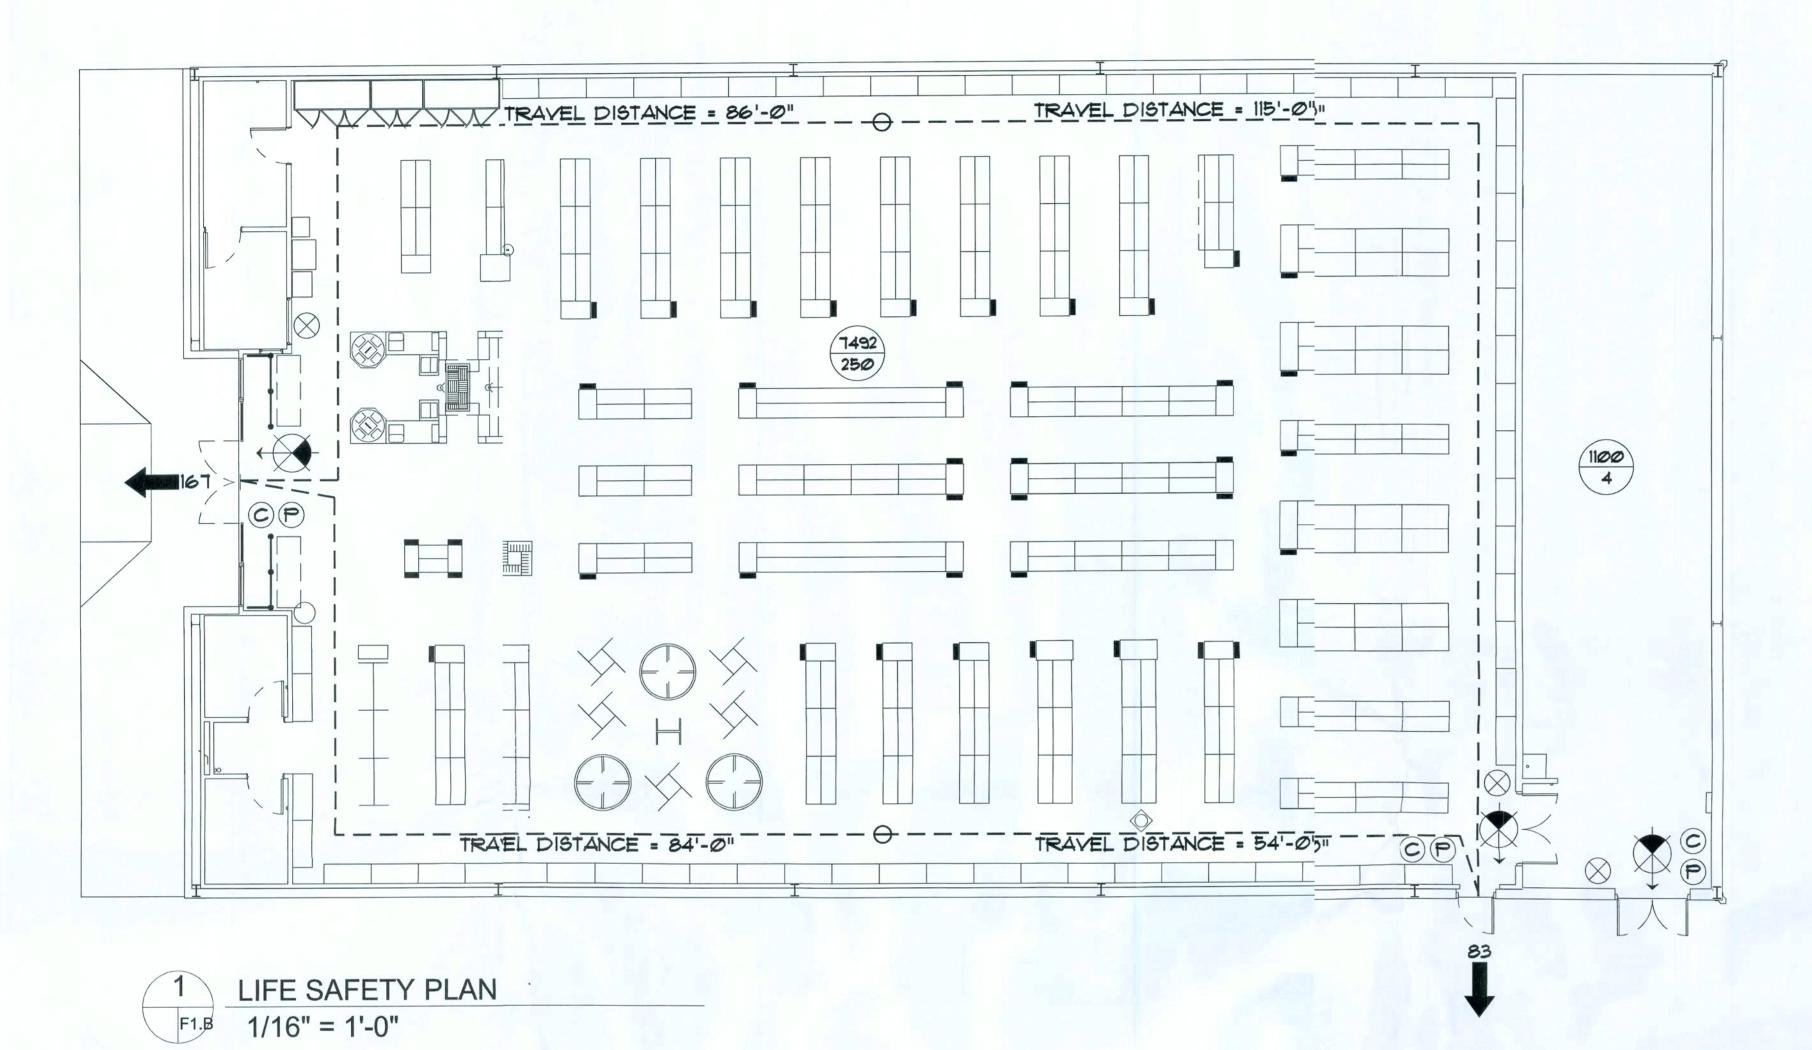

FIRE/INTRUSION ALARM SYSTEM

THIS BUILDING SHALL BE EQUIPPED WITH A SELF-CONTAINED FIRE ALARM - INTRUSION ALARM SYSTEM. THE OPPERATION OF WHICH SHALL ALERT THE BUILDING OCCUPANTS AND NOTIFY THE SII EMERGENCY RESPONSE SYSTEM. EQUIPMENT & SERVICE PROVIDER SHALL BE AS SELECTED BY THE OWNER, DETAILS OF INSTALLATION SHALL BE AS PER DUGS EMSIB - EMS4B

EMERGENCY LIGHTING AND EXIT SIGNS, SHALL BE PROVIDED AS DIRECTED BY THE FIRE MARSHAL, AND SHALL BE WIRED PER NEC 100-12F.

SMOKE DETECTORS SHALL BE MOUNTED NOT LESS THAN 90" ABOVE FINISHED FLOOR AND SHALL BE THE IONIZATION TYPE, INTERLOCKED TOGETHER, POWERED FROM EACH STORE PANEL W/BATTERY BACKUP

LEGEND

EXIT LIGHT - ARROW REPRESENTS DIRECTION REPRESENTS DIRECTION OF EXIT

HEAT DETECTOR - COORDINATE WITH ELECTRICAL DWGS.

WALL CABINET" FIRE EXTINGUISHER

DOOR /CLOSER FOR EXITING OR RATING REASONS

PANIC DEVICE

999 -- ROOM SQUARE FOOTAGE 30 - ROOM OCCUPANCY LOAD

999 -- ROOM SQUARE FOOTAGE 30 -- ROOM OCCUPANCY LOAD NON-CONCURRENT USE

PRIMARY EGRESS W/EXIT CAPACITY

FIRE EXTINGUISHER CABINETS

PROVIDE 10 LB ABC FIRE EXTINGUISHERS IN AL1. SEMI-RECESSED WALL CABINETS W/ BREAKAWAY GLASS FRONT PANEL-OCATE I CABINET AT EACH EXIT DOOR OF EACH SPACE, WITHIN 10 FEET OF 1E DOOR ANY OTHER LOCATIONS SHALL BE AS DIRECTED BY THE FIR MARSHAL AND/OR OWNER.

EXIT ACCESS TRAVEL DISTANCE PER FBC 1015, 1BLE 1015.1 OCCUPANCY - MERCHANTILE: 150 FT. (W/O SPRINKLER SYSTEM)

OCCUPANCY LOAD - MERCHANTILE

00001 /11101			
AREA	NET TOTAL SF.	ALLOWABLILE	TOTAL OCCUP.
SALES AREA	erit	1/30	239
OFFICE / R/R	313	1/30	11
STOCK ROOM	1100	1/300	4
BLDG. NET TOTAL	8592		254

ST. LOUIS, MO 63127 NICHOLAS PAUL GEISLER ARCHITECT | 1758 NW Brown Road Lake City, FL 32055 | 386/755-9021

19/08

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DATE

05/19/08

2008

SHEET NUMBER

LIFE SAFETY PLAN



	PEMB	LIBERTY	BUILDING	SYSTEM	S		STAF	BUILDIN	G SYSTEM	S		NUC	OR BUILD	ING SYSTE	EMS
	VENDOF	ATTN: DA	VID ENGI	_ISH (8	77) 505-45	96	ATTN	I: JEFF HO	ORN	866-66	4-8899	ATTI	N: TY DAV	ENPORT	803-799-970
EXTERIOR FINISHES		SHEDSIA		POLAR WHITE			MEDIUM BD	500 ONZE,	POLARIM	THINE (II)	37.5	TONE WELL	BRONZE		UME
EXTERIOR FINISHES ARE TO MATCH OR BE EQUAL TO LIBERTY METAL BUILDING SYSTEM'S FINISH SELECTION	4H917	BURWISHED S	BROWZE	POLAR	GAL VALLIM.	SIL. STA	MEDIL	BROWZE	POLAR	CALVALIA.	LIGHT ST	WED!	BROWZE	POLARIA	GALVALUME
GUTTERS	0					0					0				
DOWN SPOUTS	0 .					0					0				
SIDE AND REAR METAL WALL PANELS RECEIVING & EMER. EXIT DOORS	0					0					0				
ARCHITECTURAL BLOCK AT BUILDING FACADE SHOULD BE PRE FINISHED OR PAINTED (2 COATS - LOXON XP MASONRY COATING A24W400 SERIES) TO MATCH THE WALL MTL. PANEL	0					0					O				
FLAT METAL SOFFIT AT STOREFRONT VESTIBULE				0					0					0	
BUILDING PARAPET WALL		0					0					0			
STANLEY STOREFRONT SYSTEM			0					0					0		
ROOF					0					0					0

ANDREW CORP. MODEL # 61100(01 ANDREW CORP. MODEL #61100502 LOCATION OF CONDUIT (ABOVE)FFICE) FOR SATELLITE LINE. PROVIDE WEATHER

PREFERRED LOCATION OF NON'ENETRATING SATELLITE MOUNT (ABOVE OFFIE)

	TIGHT SEAL AT PARAPET PENETATION.	
1	SATELLITE LOCATION KEY	
S1.B	1/32" = 1'-0"	

OPTIONAL NATIONAL A	ACCOUJNT VENDORS		
COMPANY	CONTACTS	PHONE #	REQUIRED ITEMS
LIBERTY BUILDING SYSTEMS	DA _{AVID} ENGLISH	877-505-4596	PRE-ENGINEERED METAL BUILDING
STAR BUILDING SYSTEMS	JEEFF HORN	866-664-8899	PRE-ENGINEERED METAL BUILDING
NUCOR BUILDING SYSTEMS	TYY DAVENPORT	803-799-9708	PRE-ENGINEERED METAL BUILDING
CASCO	JOOHN HARRIS	314-821-1100	PROFESSIONAL SERVICES

NATIONAL ACCOUNT & CONTRACT INFORMATION SUBJECT TO CHANGE

STRUCTURAL NOTES:

The pre-manufactured metal building structure, concrete foundation, and interior concrete slab shall be designed, detailed, fabricated, and constructed in accordance with all applicable codes, standards and regulations. The most stringent requirements apply where inconsistencies occur between the Applicable Standards. In the absence of other criteria, loadings shall conform to the 2006 edition of the International Building Code.

The scope of the pre-manufactured metal building structure shall include the design, engineering, fabrication, delivery, and erection of the complete structural steel framing and exterior skin package. The metal building manufacturer shall be certified by American Institute of Steel Construction (AISC) Metal Building Certification Program.

The front fascia shall have (3) 12" perlins (mounted vertically so that the 12" face is against the building metal siding. These perlins shall be centered over the entrance and spaced 96" apart to provide adequate support for signage which may weigh up to 1,400 lbs.



NICHOLAS
PAUL
GEISLER
ARCHITECT
L Reg.: AR0007005

NICHOLAS
PAUL
1758 NW Brown Road
Lake City, FL 32055
386/755-9021



DATE

05/19/08

SHEET NUMBER

STRUCTURAL NOTES OPTION "B"

FLOOR SLAB

The concrete foundation and interior concrete slab shall be designd, detailed, and constructed to provide the safe and serviceable support of the prenanufactured metal building structure and all prescribed loads applied thereto and sha conform to the latest editions of all applicable standards of the American Concrete Instite. The soil sub-grade shall be prepared in accordance with site specific written recommedations provided by a registered Professional Geotechnical Engineer licensed in the stat where the project is located. In the absence of such recommendations, the soil sub-grade shall be prepared in accordance with the prescriptive requirements of the applicable mdel building code. Maintain 68' 1 1/2" from face of column to face of column width orsales floor.

The concrete foundation and concrete slab construction shall meethe following minimum performance requirements:

- (A) Minimum foundation bearing depths relative to final adjacent gade:
- (1) Site specific maximum frost penetration.
- (2) Depth required to attain minimum recommended/prescribe beitring pressure.
- (3) Depth required to limit settlement/heave to maximum value established herein.
- (B) Maximum vertical settlement/heaving of foundation and/or interior concrete slab over the time span of 25 years:
- (1) 1" total.
- (2) ½" differential across a horizontal distance of fifty feet.
- (C) Floor slab thickness shall be a minimum of 4" thick with WWM
- (1) No fiber reinforced concrete is allowed.
- (D) Interior concrete slab levelness and flatness requirements: (1) Levelness factor, 1/8" in 20'-0".

POLISHED CONCRETE FLOOR SUMMARY

- A. This section includes the following:
- 1. Grinding & Polishing of Concrete
- 2. Application of Retroplate 99 Densifier
- 3. Application of Retro Guard.
- 4. Installation of standard gray Polyurea joint fill.
- 5. Mandatory pre slab meeting.

B. Related Work:

- 1. Section 03300 Cast-In-Place Concrete
- C. CORPORATE ACCOUNT MANAGER: LEO HENDERSON PH 888-942-3144

EMAIL: LEO@RETROPLATESYSTEM.COM < mailto: LEO@FTROPLATESYSTEM.COM >

***ALL APPLICATORS ARE TO BE APPROVED IN WRITING OF ADVANCED FLOOR PRODUCTS LETTERHEAD REFERENCING DOLLAR GENERA.

A. Pre-Installation Conference:

1. Schedule and conduct pre-installation conference at Projecsite to establish guidelines and expectations for scheduling of floor treatment application, degree of polish, concrete finish specifications, floor flatness, and similar issues. Esure attendance at Pre-Installation Conference by at least:

- A. Dollar General Project Manager
- B. Flatwork Contractor
- C. Land lord's representative
- D. Prime Contractor
- E. Applicable subcontractorsF. Certified applicator

B. Product Variations: RetroPlate

1. The variegated colors and appearance are unique to each oncrete surface and depend on the chemical composition, mix design, porosity, ae texture and color of the concrete substrate. Mottling and wide variations in color and itensity may occur. If contaminants remain on the surface, the penetration of the Retrolate may be blocked. Concrete from different loads or pours, and in patched areas, mayappear significantly different from adjacent areas, when treated with RetroPlate.

C. Fly Ash:

1. No more than 20% of the weight of the Portland Cement sould be substituted with fly ash. If fly ash is to be substituted, Class C is minimum.

QUALITY ASSURANCE

A. Installer Qualifications:

- 1. Use a Dollar General certified installer and adequate n_{number} of skilled workman who are approved in writing by the manufacturer for Dollar General projects, NO EXCEPTIONS
- 2. Applicator shall be familiar with the specified requirements and the methods needed for proper performance of work of this section. Applicator must have availability of proper equipment to perform work within scope of this project on a timely basis. Applicator should have successfully performed a minimum of 5 projects of at least 5000 square feet each.

B. Manufacturer's Certification:

1. Provide letter of certification from Advanced Floor Proquets stating that installer is certified for Dollar General Project Not all applicators are approved

C. Protection:

- 1. No satisfactory chemical or cleaning procedure is availilable to remove petroleum stains from the concrete surface. Prevention is therefore essential.
 - A. All Hydraulic powered equipment must be diaperred to avoid staining of the concrete.
 - B. No trade will park vehicles on the inside slab. If nnecessary to complete their scope of work, drop cloths will be placed under vehicles at all times.
 - C. No pipe cutting machine will be used on the inside floor slab.
 - D. Steel will not be placed on interior slab to avoid rigust staining.
 - E. All equipment must be equipped with non-markinng tires.
 - F. Do not drag or drop equipment or material acrosss the slab which will scratch or chip it.
 - G. Protect the floor from drywall mud splatters.

DELIVERY, STORAGE AND HANDLING

A. Deliver materials in original containers, with seals unbrokeen, bearing manufacturer labels indicating brand name and directions for storage.

B. Dispense special concrete finish material from factory numbered and sealed containers. Maintain record of container numbers.

PROJECT CONDITIONS

- A. Environmental limitations: Comply with manufacturer's Wyritten instructions for substrate temperature and moisture content, ambient temperature and humidity, ventilation, and other conditions affecting topping performance.
 - Concrete must have an average Floor Flatness rating of at least 40 +/- 5.
 - 2. Concrete must have an average Floor Levelness ratiting of at least 40 +/- 5.
 - Concrete must be cured a minimum of 28 days or as_S directed by the manufacturer before application of Retro Plate can begin.
 - Application of Retro-Plate shall take place prior to in \(\sigma\) stallation of equipment, thus providing a complete, uninhibited concrete slab for application.
 - B. Close areas to traffic during floor application.
- C. The completed Retroplate slab will be covered to preevent damage by the other trades during store completion.
- D. Land lord will be responsible for providing a dumpsteer for disposal of products.

PART 2 - PRODUCTS

MATERIALS AND MANUFACTURERS

- A. HARDENING/SEALING AGENT (No substitution)
- 1. RetroPlate 99 manufactured by Advanced Floor Produucts, Inc., P.O. Box 50533, Provo, Utah 84605 LEO HENDERSON 801.602.0095 CELL: 888.942.3144:
- DOLLAR GENERAL@RETROPLATESYSTEM.COM
- A. Performance Criteria:
 - I. Abrasion Resistance: ASTM C779 Up to 400% in abrasion resistance.
- II. Impact Strength: ASTM C805 Up to 21% increase impact strength.
- III. Ultra Violet Light and Water Spray: ASTM G23-811 No adverse effect to ultra violet and water spray.
- IV. Reflectivity: Up to 30% increase in reflectivity.
- 2. Polyurea joint filler to be used in all control joints. Stanndard grey color. All joints are to be filled
- at the discretion of the certified installer.
- 3. Retroguard Heavy Duty Stain Inhibitor and Sealer: (Nqo substitution)
- 4.Ameripolish "Edge Tint" (Concrete Gray)

B. DIAMOND GRINDING AND POLISHING DISCS

Only grinding and polishing discs distributed by Advanced Floor Products are to be used. (No Substitutions).

RELATED MATERIALS

- A. Water:
- 1. Potable and on site.
- B. Temporary power for grinding and polishing equipmer nt will be provided by installer.

PART 3- EXECUTION

SURFACE CONDITIONS:

- A. GC or rep. to examine substrate, with installer present, for conditions affecting performance of finish. Correct conditions detrimental to timely and proper work. Do not proceed until unsatisfactory conditions are corrected.
- B. GC or rep. to verify that base slab meet finish and surface profile requirements in Division 3 Section
- Cast-In-Place Concrete, and Project Conditions above.
- C. Prior to application, verify that floor surfaces are free of construction latent's.

 ONCE
- APPLICATOR ACCEPTS THE FLOOR THEY AND THEY ALONE ARE SOLELY RESPONSIBLE FOR THE SPECIFICATIONS TO BE MET.

EQUIPMENT:

- A. PLANITARY EQUIPMENT ONLY, NO EXCEPTIONS'
- Initial grinding will be done with a machine with Planetary concrete grinding heads.
- It gives the best preliminary scratch pattern needed for a good finished sheen.

 2. Machines with at least 32 inch grinding area are required.

B. SCOPE OF WORK

The following RetroPlate process must be used. The following process will be used depending on the condition of the slab. Floors should be started using a 50 or 80 Grit Resin pad. A concrete grinding machine with Planetary Heads must be used. The remaining process follows:

New Construction

state for

- 1. This process will require the use of 50 or 80 Grit resin diamond. Multiple passes may be required. Salt & Pepper aggregate will be exposed.
- Grind the floor with 120 grit resin diamonds. Multiple passes may be required.
 Clean/scrub the floor via automatic scrubber with soft brushes/white pads to
- remove all dirt and debris from the floor. Allow floor to air dry.

 4. Apply a Retroplate to entire surface at 200 sq. ft per gallon and maintain wet
 - a minimum of 60 minutes.
- 5. Flush floor clean after material is spent and allow to air dry.
- 6. Grind the floor with 220 grit resin diamonds. Multiple passes may be required.
- Polish the floor with 400 grit resin diamonds. Multiple passes may be required.
 Polish the floor with 800 grit resin diamonds. Multiple passes may be required.
- 9. Apply Retro Guard at a rate of 1200-1500 sq. ft per gallon.
- 10. High speed burnish with 800 grit or higher Twister pad. Multiple passes may be required.
- 11. Chase and fill grout joints with Polyurea.
- 12. Use "Edge Tint" around the edges.
- *** Applicator reserves the right to alter or add any steps in order to ensure that the floor is 100% acceptable to the owner and meets required specifications for a "level two shine."

WORKMANSHIP AND CLEANING:

- A. The premises shall be kept clean and free of debris at all times.
- B. Remove spatter from adjoining surfaces, as necessary.
- C. Repair damages to surface caused by cleaning operations.
- D. Remove debris from jobsite in accordance with local regulations.

SPECIFIC QUALIFICATIONS / EXCLUSIONS(NOTE: This section, though not mandatory, will greatly improve the understanding and necessary procedures for performing this work properly.)

- A. No other trades will be allowed in the area being worked on due to possible safety and floor contamination issues.
- B. The areas to receive the RetroPlate 99 System will be delivered to the applicator in clean and swept condition. All equipment and supplies will be removed prior to turning the space over to the applicator. If the applicator is required to clean the space, and/or move other's supplies, staging and equipment, it will be done at time and materials.
- C. PROTECTION OF THE FLOOR FOLLOWING THE APPLICATION OF THE RETROPLATE 99 SYSTEM AND POLISHING IS THE RESPONSIBILITY OF THE OWNER.
- D. Upon completion the applicator will deliver a "level two shine" defined as at a distance of 30-35 feet. Light reflection will be well defined.

CONCRETE SUMMARY OPTION "B"








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S2.B

Mysmuca /



ANCHOR BOLT / FOUNDATION SIZING:

THE ANCHOR BOLT DIAMETERS AND DEVELOPED LENGTHS INDICATED IN THIS DRAWING WERE DETERMININED USING SHEAR FRICTION THEORY AS DESCRIBED IN AISC DESIGN GUIDE No.7, SECTION 9.2, ASSUMING AN ANCHOR BOLT MATERIAL OF ASTM A307 OR A36. THE COMBINED FORCE: ACTING AT THE BASE OF THE STEEL FRAME RESULTING IN A VERTICAL REACTION ACTING UPON THE FOUNDATION WERE DEVELOPED AS FOLLOW

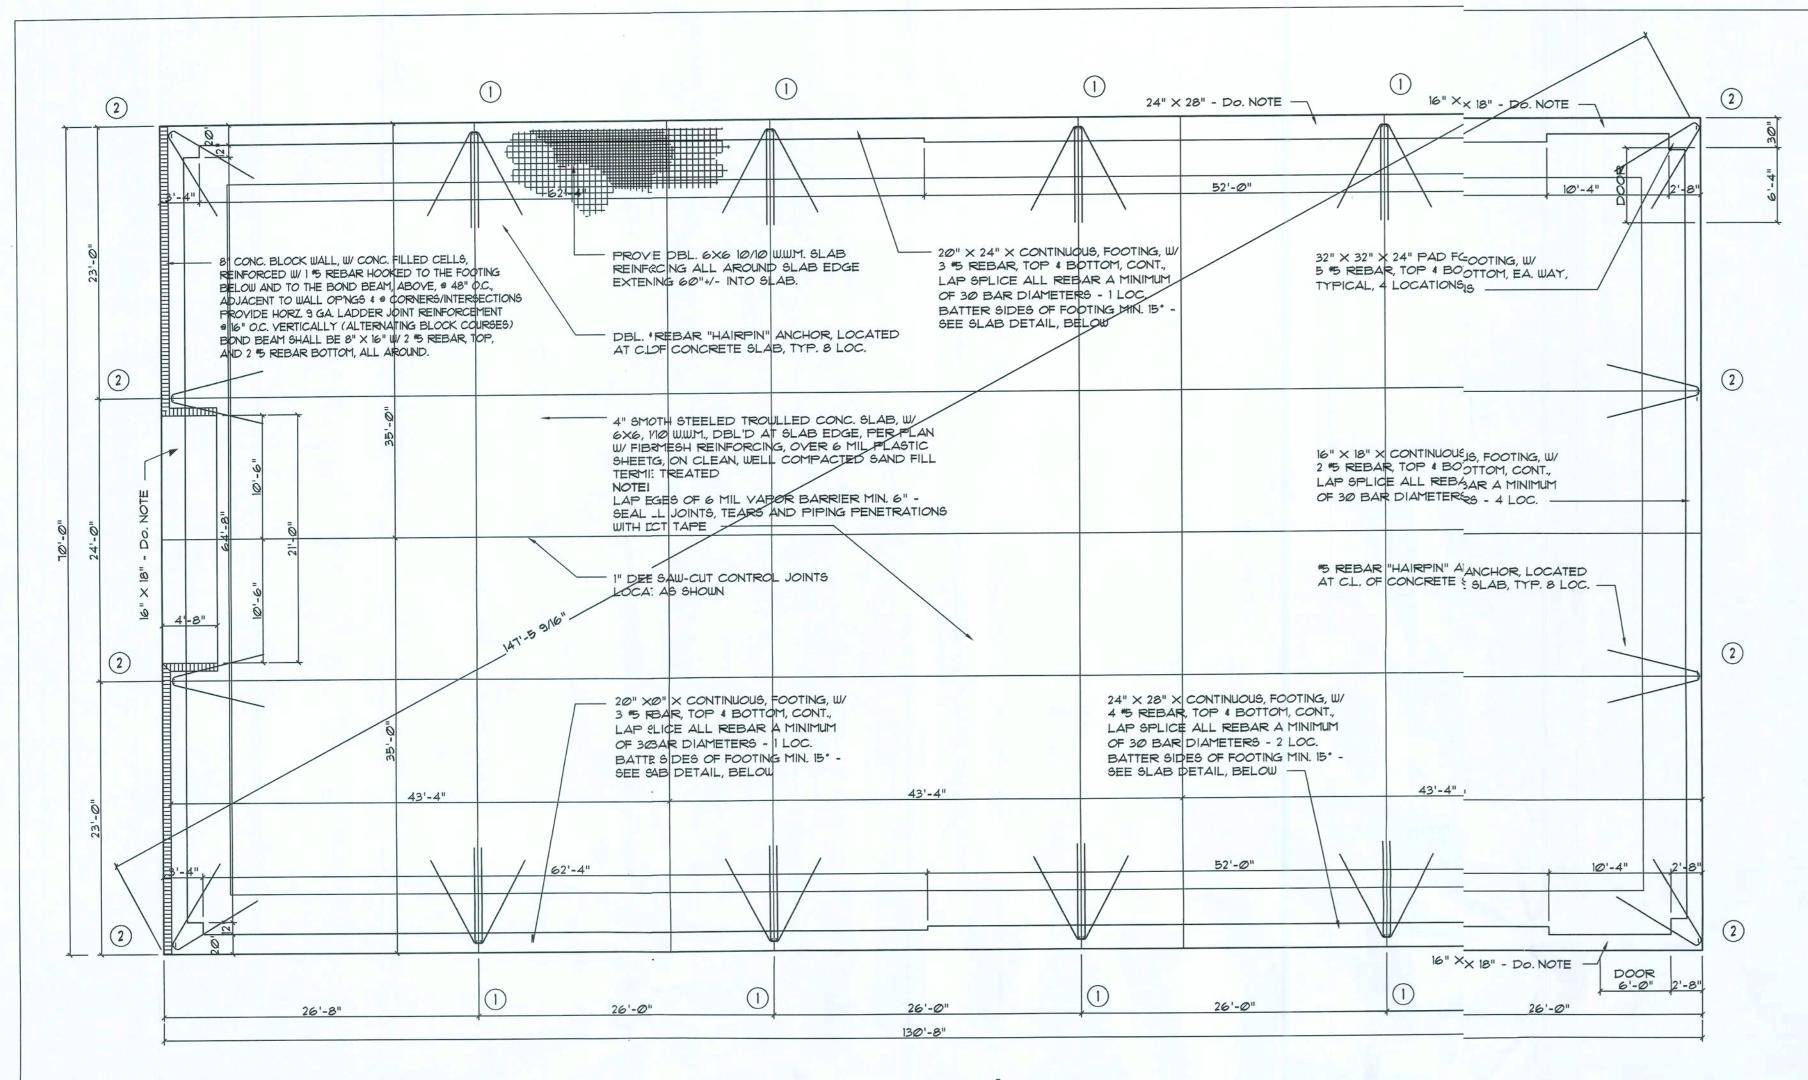T = Td + Tsf

WHERE

† = TOTAL TENSILE FORCE PER BOLT

T = TOTAL TENSILE FORCE PER BOLT

Td = TENSILE FORCE PER BOLT DUE TO DIRECTLY APPLIED LOAD = P.

Taf = TENSILE FORCE PER BOLT DUE TO SHEAR FRICTION = V / (n × u)

WHERE


- P = TOTAL UPLIFT TO BE RESISTED BY ANCHOR BOLT GROUP
 V = V = TOTAL SHEAR FORCE TO BE RESISTED BY ANCHOR BOLT GROP
- n = n = Number of Anchor Bolts u = u = coefficient of Friction (taken as 0.7 for ungrouted bas
- PLATES OR Ø.9 FOR GROUTED BASE PLATES)

Foundation PLAN

SHALL HAVE PRECEDENCE OVER THESE DRAWINGS.

SCALE: 1/8" = 1'-0"

REFER TO THE METAL BUILDING SHOP DRAWINGS FOR ALL DETAILS AND INFORMATION REGARDING ANCHOR BOLT PLICEMENT NUMBER, DIAMETER, ARRANGEMENT, ORIENTATIOS AND SOFRTH. METAL BUILDING MANUFACTURERS ENGINEERED SHOP DRAINGS

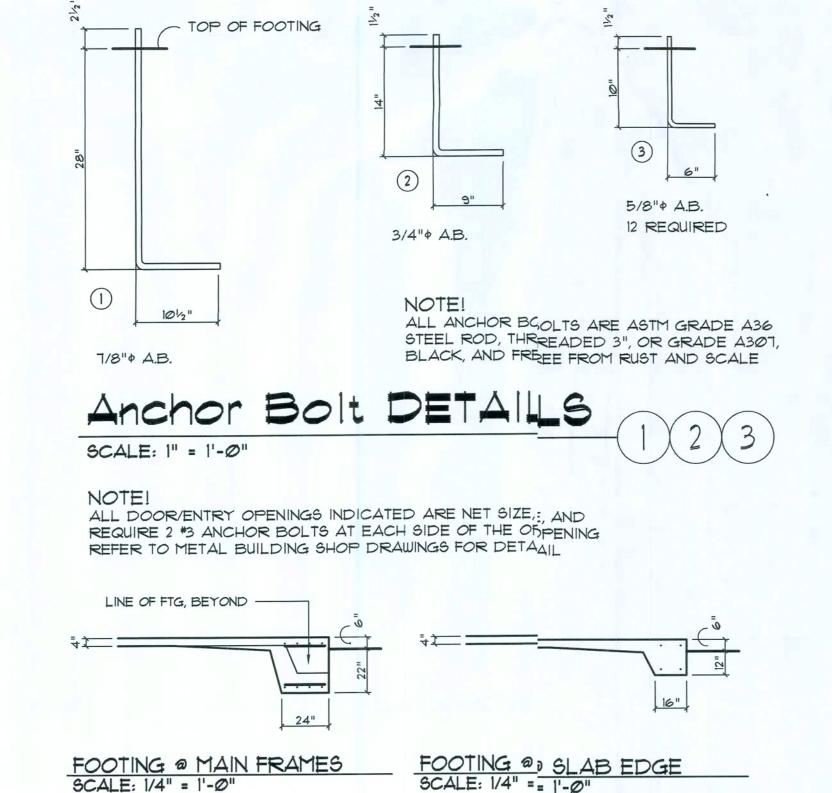

GENERAL STRUCTURAL NOTES

GENERAL:

I. THE DRAWINGS ARE INTENDED TO SHOW THE GENERAL ARRANGEMENT, DESIGN AND EXTENT OF THE WORK AND ARE PARTIALLY DIAGRAMMATIC. THEY ARE NOT INTENDED TO BE SCALED FOR ROUGH-IN MEASUREMENTS, OR TO SERVE AS SHOP DRAWINGS OR PORTIONS THEREOF.

2. ALL DETAILS AND SECTIONS SHOWN ON THE DRAWINGS ARE INTENDED TO BE TYPICAL AND SHALL BE CONSTRUED TO APPLY TO ANY SIMILAR SITUATION ELSEWHERE ON THE PROJECT, EXCEPT WHERE A DIFFERENT DETAIL OR SECTION IS SHOWN.

3. PRIOR TO START OF CONSTRUCTION, THE CONTRACTOR AND ALL THE SUBCONTRACTORS SHALL VERIFY ALL GRADES, LINES, LEVELS, DIMENSIONS AND COORDINATE EXISTING CONDITIONS AT THE JOB SITE WITH THE PLANS AND SPECIFICATIONS. THEY SHALL REPORT ANY INCONSISTENCIES OR ERRORS IN THE ABOVE TO THE ARCHITECT/ENGINEER BEFORE COMMENCING WORK. THE CONTRACTOR AND HIS SUBCONTRACTORS SHALL LAY OUT THEIR WORK FROM ESTABLISHED REFERENCE POINTS AND BE RESPONSIBLE FOR ALL LINES, ELEVATIONS AND MEASUREMENTS IN CONNECTION WITH THEIR WORK.

4. IF ANY ERRORS OR OMISSIONS APPEAR IN THE DRAWINGS, GENERAL NOTES OR OTHER DOCUMENTS, THE CONTRACTOR SHALL NOTIFY THE ARCHITECT IN WRITING OF SUCH OMISSION OR ERROR PRIOR TO PROCEEDING WITH ANY WORK WHICH APPEARS IN QUESTION. IN THE EVENT OF THE CONTRACTOR'S FAILING TO GIVE SUCH AN ADVANCED NOTICE, HE SHALL BE HELD RESPONSIBLE FOR THE RESULTS OF ANY SUCH ERRORS OR OMISSIONS AND THE COST OF RECTIFYING THE SAME.

5. THE CONTRACTOR SHALL USE THE STRUCTURAL DRAWINGS AND SPECIFICATIONS TOGETHER WITH THE ARCHITECTURAL, MECHANICAL, ELECTRICAL AND OTHER TRADE DRAWINGS AND SHOP DRAWINGS, TO LOCATE DEPRESSED SLABS, SLOPES, DRAINS, OUTLETS, RECESSES, OPENINGS, BOLT SETTING, SLEEVES, DIMENSIONS, ETC. NOTIFY ARCHITECT/ENGINEER, IN WRITING, OF ANY POTENTIAL CONFLICTS BEFORE PROCEEDING WITH THE WORK.

SHOP DRAWINGS AND DELEGATED ENGINEERING:

I. ALL SHOP DRAWINGS SHALL BE SUBMITTED FOR ARCHITECT'S REVIEW ONLY AFTER THEY HAVE BEEN THOROUGHLY REVIEWED BY THE CONTRACTOR FOR CONSTRUCTION METHODS, DIMENSIONS AND OTHER TRADE REQUIREMENTS, AND STAMPED WITH THE CONTRACTOR'S APPROVAL STAMP. THE ARCHITECT ASSUMES NO RESPONSIBILITY FOR DIMENSIONS, QUANTITIES, ENGINEERING DESIGN BY DELEGATED ENGINEERS, ERRORS OR OMISSIONS AS A RESULT OF REVIEWING ANY SHOP DRAWINGS. ANY ERRORS OR OMISSIONS MUST BE MADE GOOD BY THE CONTRACTOR, IRRESPECTIVE OF RECEIPT, CHECKING OR REVIEW OF DRAWINGS BY THE ENGINEER AND EVEN THOUGH WORK IS DONE IN ACCORDANCE WITH SUCH DRAWINGS.

2. BEFORE STRUCTURAL INSPECTIONS CAN BE MADE ON A PORTION OF THE STRUCTURE, ALL RELATED SHOP DRAWINGS, DELEGATED ENGINEERING, PRODUCT APPROVAL, MANUFACTURER'S DATA AND OTHER RELATED INFORMATION, MUST BE REVIEWED AND ACCEPTED BY THE ARCHITECT-OF-RECORD AND APPROVED BY THE BUILDING DEPARTMENT.

 SHOP DRAWINGS SHALL CONTAIN ALL INFORMATION SHOWN ON THE STRUCTURAL PLANS (RELATED TO THE DELEGATED DESIGN) INCLUDING ALL DESIGN LOADS, IN ADDITION TO THE INFORMATION REQUIRED BY THE DELEGATED ENGINEER'S DESIGN.

4. ARCHITECT WILL REVIEW ALL SUBMITTED SHOP DRAWINGS, PREPARED AND SIGNED AND SEALED BY THE CONTRACTOR'S DELEGATED ENGINEER, ONLY FOR GENERAL COMPLIANCE WITH THE DESIGN INTENT, REQUIRED LOADING AND COORDINATION WITH THE STRUCTURAL DESIGN.

5. CONTRACTOR SHALL SUBMIT TO THE ARCHITECT TWO SETS OF BLUE PRINTS OF THE STRUCTURAL SHOP DRAWINGS FOR ARCHITECT REVIEW, BEFORE STARTING FABRICATION. THE ARCHITECT WILL RETURN ONE MARKED UP AND STAMPED COPY TO THE CONTRACTOR. THE MARKED-UP COPY SHALL BE USED TO MAKE THE PRINTS REQUIRED FOR SHOP DRAWING DISTRIBUTION.

CONSTRUCTION MEANS AND METHODS:

I. THE CONSTRUCTION MEANS, METHODS, TECHNIQUES, SEQUENCE OR PROCEDURES, SAFETY PRECAUTIONS, SHORES, RESHORES, LATERAL BRACING AND PROGRAMS IN CONNECTION WITH THE PROJECT, ARE THE SOLE RESPONSIBILITY OF THE CONTRACTOR. OUR SERVICES DO NOT GUARANTEE NOR ASSURE LIABILITY FOR THE JOB SAFETY, TEMPORARY SHORING AND BRACING AND THE PERFORMANCE OF THE CONTRACTOR.

2. THE CONTRACTOR IS RESPONSIBLE AND SHALL COMPLY WITH THE SAFETY REQUIREMENTS OF THE 2004 FLORIDA BUILDING CODE AND APPLICABLE LOCAL, STATE AND FEDERAL LAWS.

3. PROVIDE ALL SHORING, BRACING AND SHEETING AS REQUIRED FOR SAFETY, STRUCTURAL STABILITY AND FOR THE PROPER EXECUTION OF THE WORK. REMOVE WHEN WORK IS COMPLETED.

4. PROVIDE AND MAINTAIN GUARD LIGHTS AT ALL BARRICADES, RAILINGS, OBSTRUCTIONS IN THE STREETS, ROADS OR SIDEWALKS AND ALL TRENCHES OR PITS ADJACENT TO PUBLIC WALKS OR ROADS.

WIND, STORMS OR THE SUN), SO AS TO MAINTAIN ALL WORK, MATÉRIALS, APPARATUS AND FIXTURES FREE FROM INJURY OR DAMAGE.

6. AT THE END OF THE DAYS WORK, COVER ALL WORK LIKELY TO BE

5. AT ALL TIMES, PROVIDE PROTECTION AGAINST WEATHER (RAIN,

6. AT THE END OF THE DAYS WORK, COVER ALL WORK LIKELY TO BE DAMAGED. ANY WORK DAMAGED BY FAILURE TO PROVIDE PROTECTION SHALL BE REMOVED AND REPLACED WITH NEW WORK AT THE CONTRACTOR'S EXPENSE.

7. THE CONTRACTOR SHALL PAY FOR ALL DAMAGES TO ADJACENT STRUCTURES, SIDEWALKS AND TO STREETS OR OTHER PUBLIC PROPERTY OR PUBLIC UTILITIES.

STRUCTURAL DESIGN CRITERIA:

I. THE DESIGN COMPLIES WITH THE REQUIREMENTS OF THE 2004 FLORIDA BUILDING CODE - SECTION 1609 AND OTHER REFERENCED CODES AND SPECIFICATIONS. ALL CODES AND SPECIFICATIONS SHALL BE LATEST EDITION AT TIME OF PERMIT.

2. WIND LOAD CRITERIA:

BASED ON ANSI/ASCE 7-97. BASIC WIND VELOCITY IIO MPH,

3. ROOF DESIGN LOADS:
SUPERIMPOSED DEAD LOADS:
SUPERIMPOSED LIVE LOADS:
20 PSF

4. FLOOR DESIGN LOADS:
SUPERIMPOSED DEAD LOADS:
SUPERIMPOSED DEAD LOADS:
SUPERIMPOSED LIVE LOADS:
RESIDENTIAL
BALCONIES
40 PSF

5. WIND NET UPLIFT: ARE AS INDICATED ON PLANS

FOUNDATIONS: (SPREAD FOOTINGS)

I. FOUNDATIONS ARE DESIGNED TO BEAR ON WELL COMPACTED GRADE OR CLEAN FILL OF AN ALLOWABLE BEARING CAPACITY OF 1,000 PSF MINMUM. FOR REQUIRED SOIL BEARING CAPASITIES GREATER THAN 1,000 PSF, A CERTIFIED TESTING LABORATORY SHALL BE ENGAGED BY THE OWNER TO VERIFY THAT THE REQUIRED BEARING CAPACITY WAS OBTAINED. SAID SOIL CAPACITY SHALL BE CERTIFIED AND TESTED BY A FLORIDA REGISTERED FOUNDATION ENGINEER, PRIOR TO CASTING OF CONCRETE IN THE FOOTINGS.

2. NATURAL GRADE (OR FILL) BELOW FOOTINGS SHALL BE COMPACTED TO 98 % MODIFIED PROCTOR (ASTM D-1557).

3. TOP OF WALL FOOTINGS TO BE AT THE SAME ELEVATION AS TOP OF COLUMN PAD FOOTINGS. STEP WALL FOOTING FROM HIGHER COLUMN FOOTING TO THE LOWER ONE (AS DETAILED ON THE PLANS).

4. BOTTOM OF ALL FOOTINGS TO BE A MINIMUM I'-6" BELOW THE TOP OF CONCRETE SLAB ON GRADE (UNLESS OTHERWISE NOTED) OR MINIMUM I'-0" BELOW FINISHED GRADE, WHICHEVER IS LOWER. IN THE EVENT THAT THE SLAB STEPS ON EACH SIDE OF THE FOOTING, THE FOOTING SHALL BE I'-6" BELOW TOP OF THE LOWER SLAB.

5. REINFORCING IN THE CONTINUOUS WALL FOOTINGS (MONOLITHIC AND NON-MONOLITHIC) SHALL BE SPLICED 40 BAR DIAMETERS MINIMUM AND SHALL EXTEND CONTINUOUSLY THRU ALL FOOTING PADS,

6. ALL LONGITUDINAL REBARS IN THE CONTINUOUS WALL FOOTINGS, SHALL BE CONTINUED AT BENTS AND CORNERS BY BENDING THE REBARS 48 BAR DIAMETERS AROUND THE CORNERS OR ADDING MATCHING CORNER BARS, EXTENDING 48 BAR-DIAMETERS INTO FOOTING EACH SIDE OF CORNER OR BENT.

7. ALL FOOTINGS SHALL BE 12" MINIMUM THICKNESS.

CONCRETE SLABS ON GRADE:

1. ALL INTERIOR AND EXTERIOR SLABS AND WALKWAYS AS SHOWN ON THE STRUCTURAL OR ARCHITECTURAL PLANS, SHALL BE FOUR INCHES THICK MINIMUM REINFORCED WITH 6 X 6 - WI.4 X WI.4 WELDED WIRE FABRIC (UNLESS OTHERWISE NOTED).

2. ALL SLABS ON GRADE TO BE CONSTRUCTED IN ACCORDANCE WITH LATEST A.C.I - "GUIDE FOR CONCRETE FLOOR AND SLAB CONSTRUCTION" (A.C.I. - 302.IR)

3. JOINTS SHALL BE PROVIDED IN ALL INTERIOR SLABS ON GRADE AT LOC. INDICATED ON THE PLANS DIVIDING THE SLAB INTO SQUARE PANELS NOT TO EXCEED 20 X 20 FT. IN SIZE. CAST SLAB IN LONG ALTERNATE STRIPS. PROVIDE A CONTRACTION JOINT BETWEEN EACH STRIP. SEE PLAN FOR SAW-CUT, CONTRACTION AND ISOLATION JOINT DETAILS.

4. PROVIDE SAW-CUT JOINTS AT ALL SIDEWALKS AT A MAXIMUM SPACING OF FIVE FEET ON CENTERS AND ISOLATION JOINTS AT 20 FEET O.C. (ILON)

5. FILL MATERIAL SHALL BE PLACED IN LIFTS NOT EXCEEDING 12"
AND COMPACTED TO 98 % MODIFIED PROCTOR (ASTM D-1557) WITHIN A
DISTANCE OF 3 FEET BEYOND ALL FOOTING EDGES. TAKE AT LEAST ONE
DENSITY TEST FOR EACH 1,600 SQ.FT. OF AREA AND 12" BELOW SURFACE. SEND
RESULTS OF THE TEST TO OWNER, ARCHITECT AND ENGINEER.

CONCRETE AND REINFORCING:

1. CONCRETE DESIGN AND REINFORCEMENT IN ACCORDANCE WITH "BUILDING CODE REQUIREMENTS FOR REINFORCED CONCRETE" (A.C.I. 318 - LATEST EDITION) AND WITH "DETAILS AND DETAILING OF CONCRETE REINFORCEMENT" - (A.C.I. 315 - LATEST EDITION).

2. ALL CONCRETE WORK IN ACCORDANCE WITH "SPECIFICATIONS FOR STRUCTURAL CONCRETE FOR BUILDING" (A.C.I. 301 - LATEST EDITION). PRODUCTION OF CONCRETE, DELIVERY, PLACING AND CURING TO BE IN ACCORDANCE WITH "HOT WEATHER CONCRETING" (A.C.I. 305R - LATEST EDITION).

3. ALL CONCRETE TO BE REGULAR WEIGHT WITH A DESIGN STRENGTH OF 3,000 P.S.I. AT 28 DAYS. MAXIMUM SLUMP 5".

4. ALL REINFORCING TO BE NEW BILLET STEEL CONFORMING TO THE LATEST A.S.T.M. A-615 GRADE 60, FABRICATED IN ACCORDANCE WITH C.R.S.I. MANUAL OF STANDARD PRACTICE AND PLACED IN ACCORDANCE WITH A.C.I. 315 AND C.R.S.I. MANUAL OF STANDARD PRACTICE.

(TOP \$ SIDES) 2"

CENTERED W/SLAB

5. CONCRETE COVER UNLESS OTHERWISE DETAILED ON DRAWINGS:

SLABS ON GRADE:

FOOTINGS:

6. BEAM REINFORCEMENT: LAPPED 36 BAR DIAMETER OR MINIMUM 18 INCHES. BOTTOM BARS SPLICED ONLY AT SUPPORTS, TOP BARS SPLICED ONLY AT MID-SPAN. ALL TOP BARS HOOKED AT NONCONTINUOUS EDGES (U.O.N.). ALL HOOKS TO BE STANDARD 90 DEGREE HOOKS AS REQUIRED (U.O.N.).

7. ADDED REINFORCEMENT: PROVIDE ADDITIONAL CORNER BARS BENT 36 INCHES MINIMUM EACH WAY AT "L" AND "T" CORNERS IN OUTER FACES OF ALL BEAMS TO MATCH ALL HORIZONTAL BAR (TOP, BOTTOM AND INTERMEDIATE REBARS).

8. SEE PLAN FOR MINIMUM SIZE CONCRETE TIE BEAM REQUIREMENTS.

NOTE!

REFER TO THE METAL BUILDING SHOP DRAWINGS PREPARED BY BUTLER METAL BUILDINGS, INC., FOR EXACT LOCATION OF ALL EMBEDDED ANCHOR BOLTS.

NOTE!

ADDED FILL SHALL BE APPLIED IN 12" LIFTS - EA. LIFT SHALL BE CONPACTED TO 98% DRY COMPACTION PER THE "MODIFIED PROCTOR" METHOD.

NOTE! THE DESIG

THE DESIGN WIND SPEED FOR THIS PROJECT IS 110 MPH PER 2004 FBC 1609 AND LOCAL JURISDICTION REQUIREMENTS

NOTE! ALL ANCHO

ALL ANCHOR BOLTS ARE ASTM GRADE A36 STEEL ROD, THREADED 3 1/2", BLACK AND FREE FROM RUST AND SCALE

CASCO

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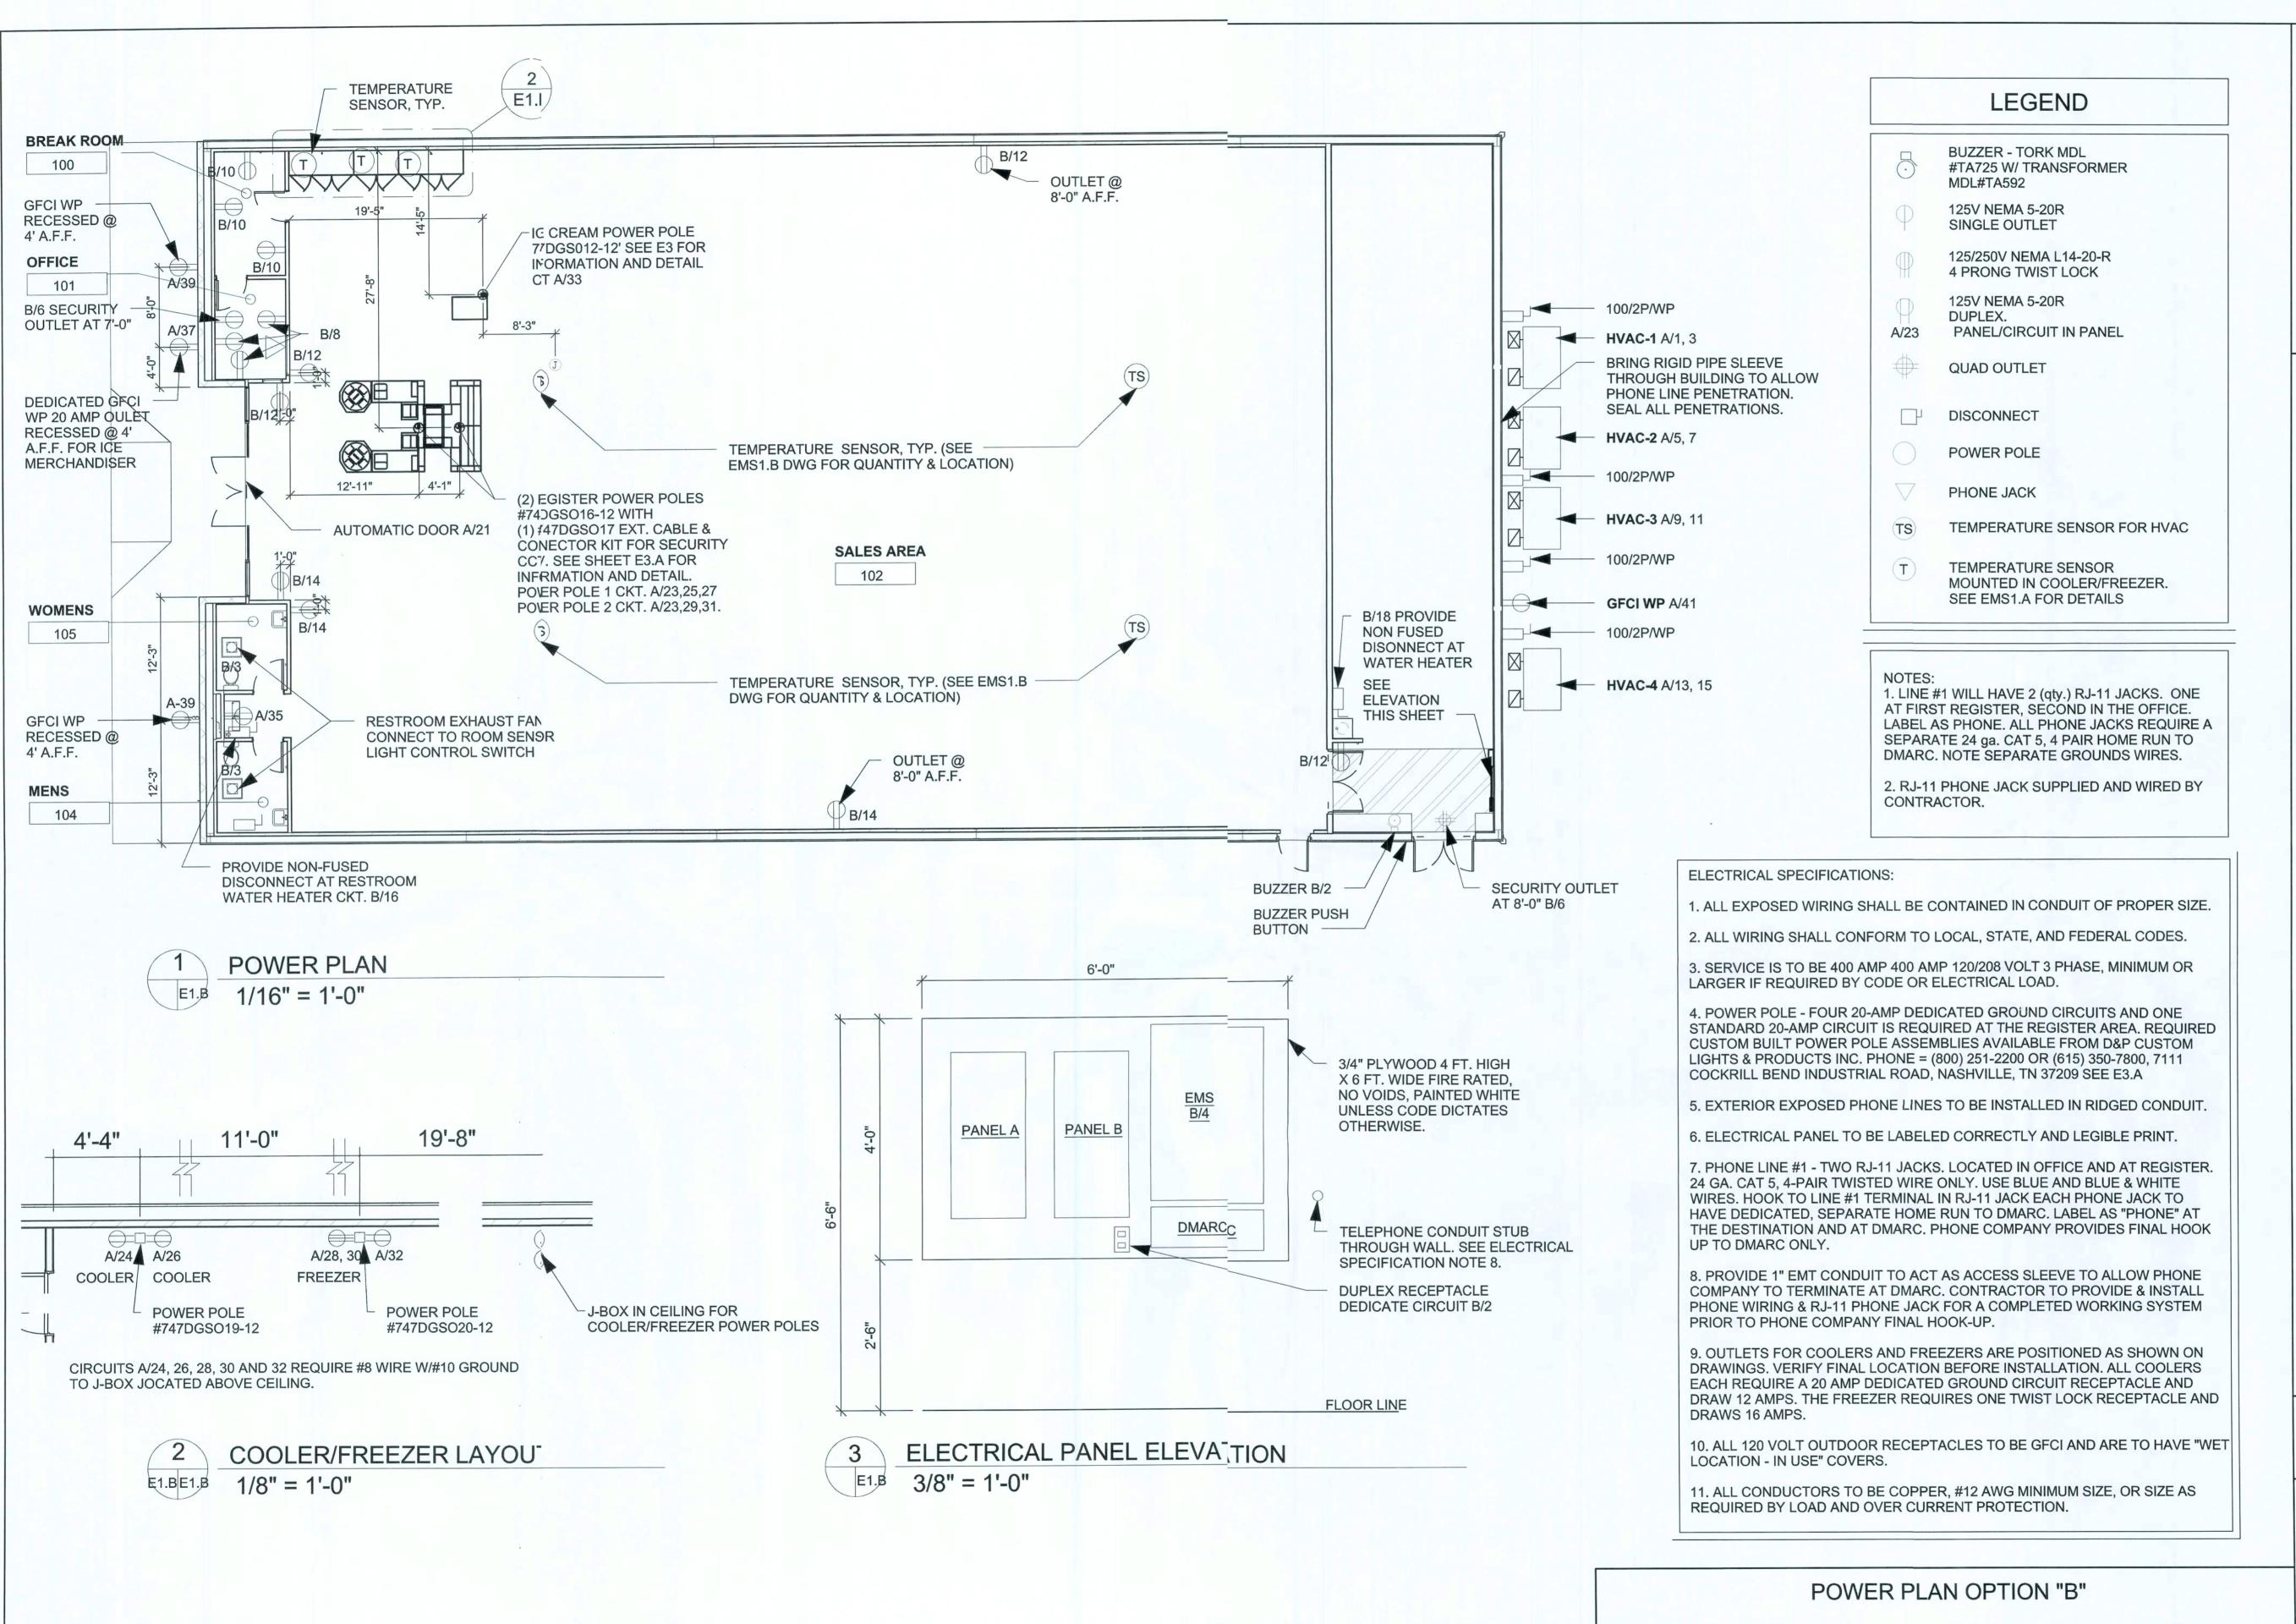
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S3.B

FOUNDATION PLAN OPTION "B"

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GASGO 10877 WATSON ROAD ST. LOUIS, MO 63127

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2008 PROTOTYPE CRITERIA SET PLAN "B" - ADDENDA RELEASE 5/19/08

AutoCAD-Store Design Department (615) 855-4753

Constructionced @dollargeneral.com


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E1.E

14 Jun 2005



NICHOLAS
PAUL
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DATE


LIGHTING PLAN OPTION "B"

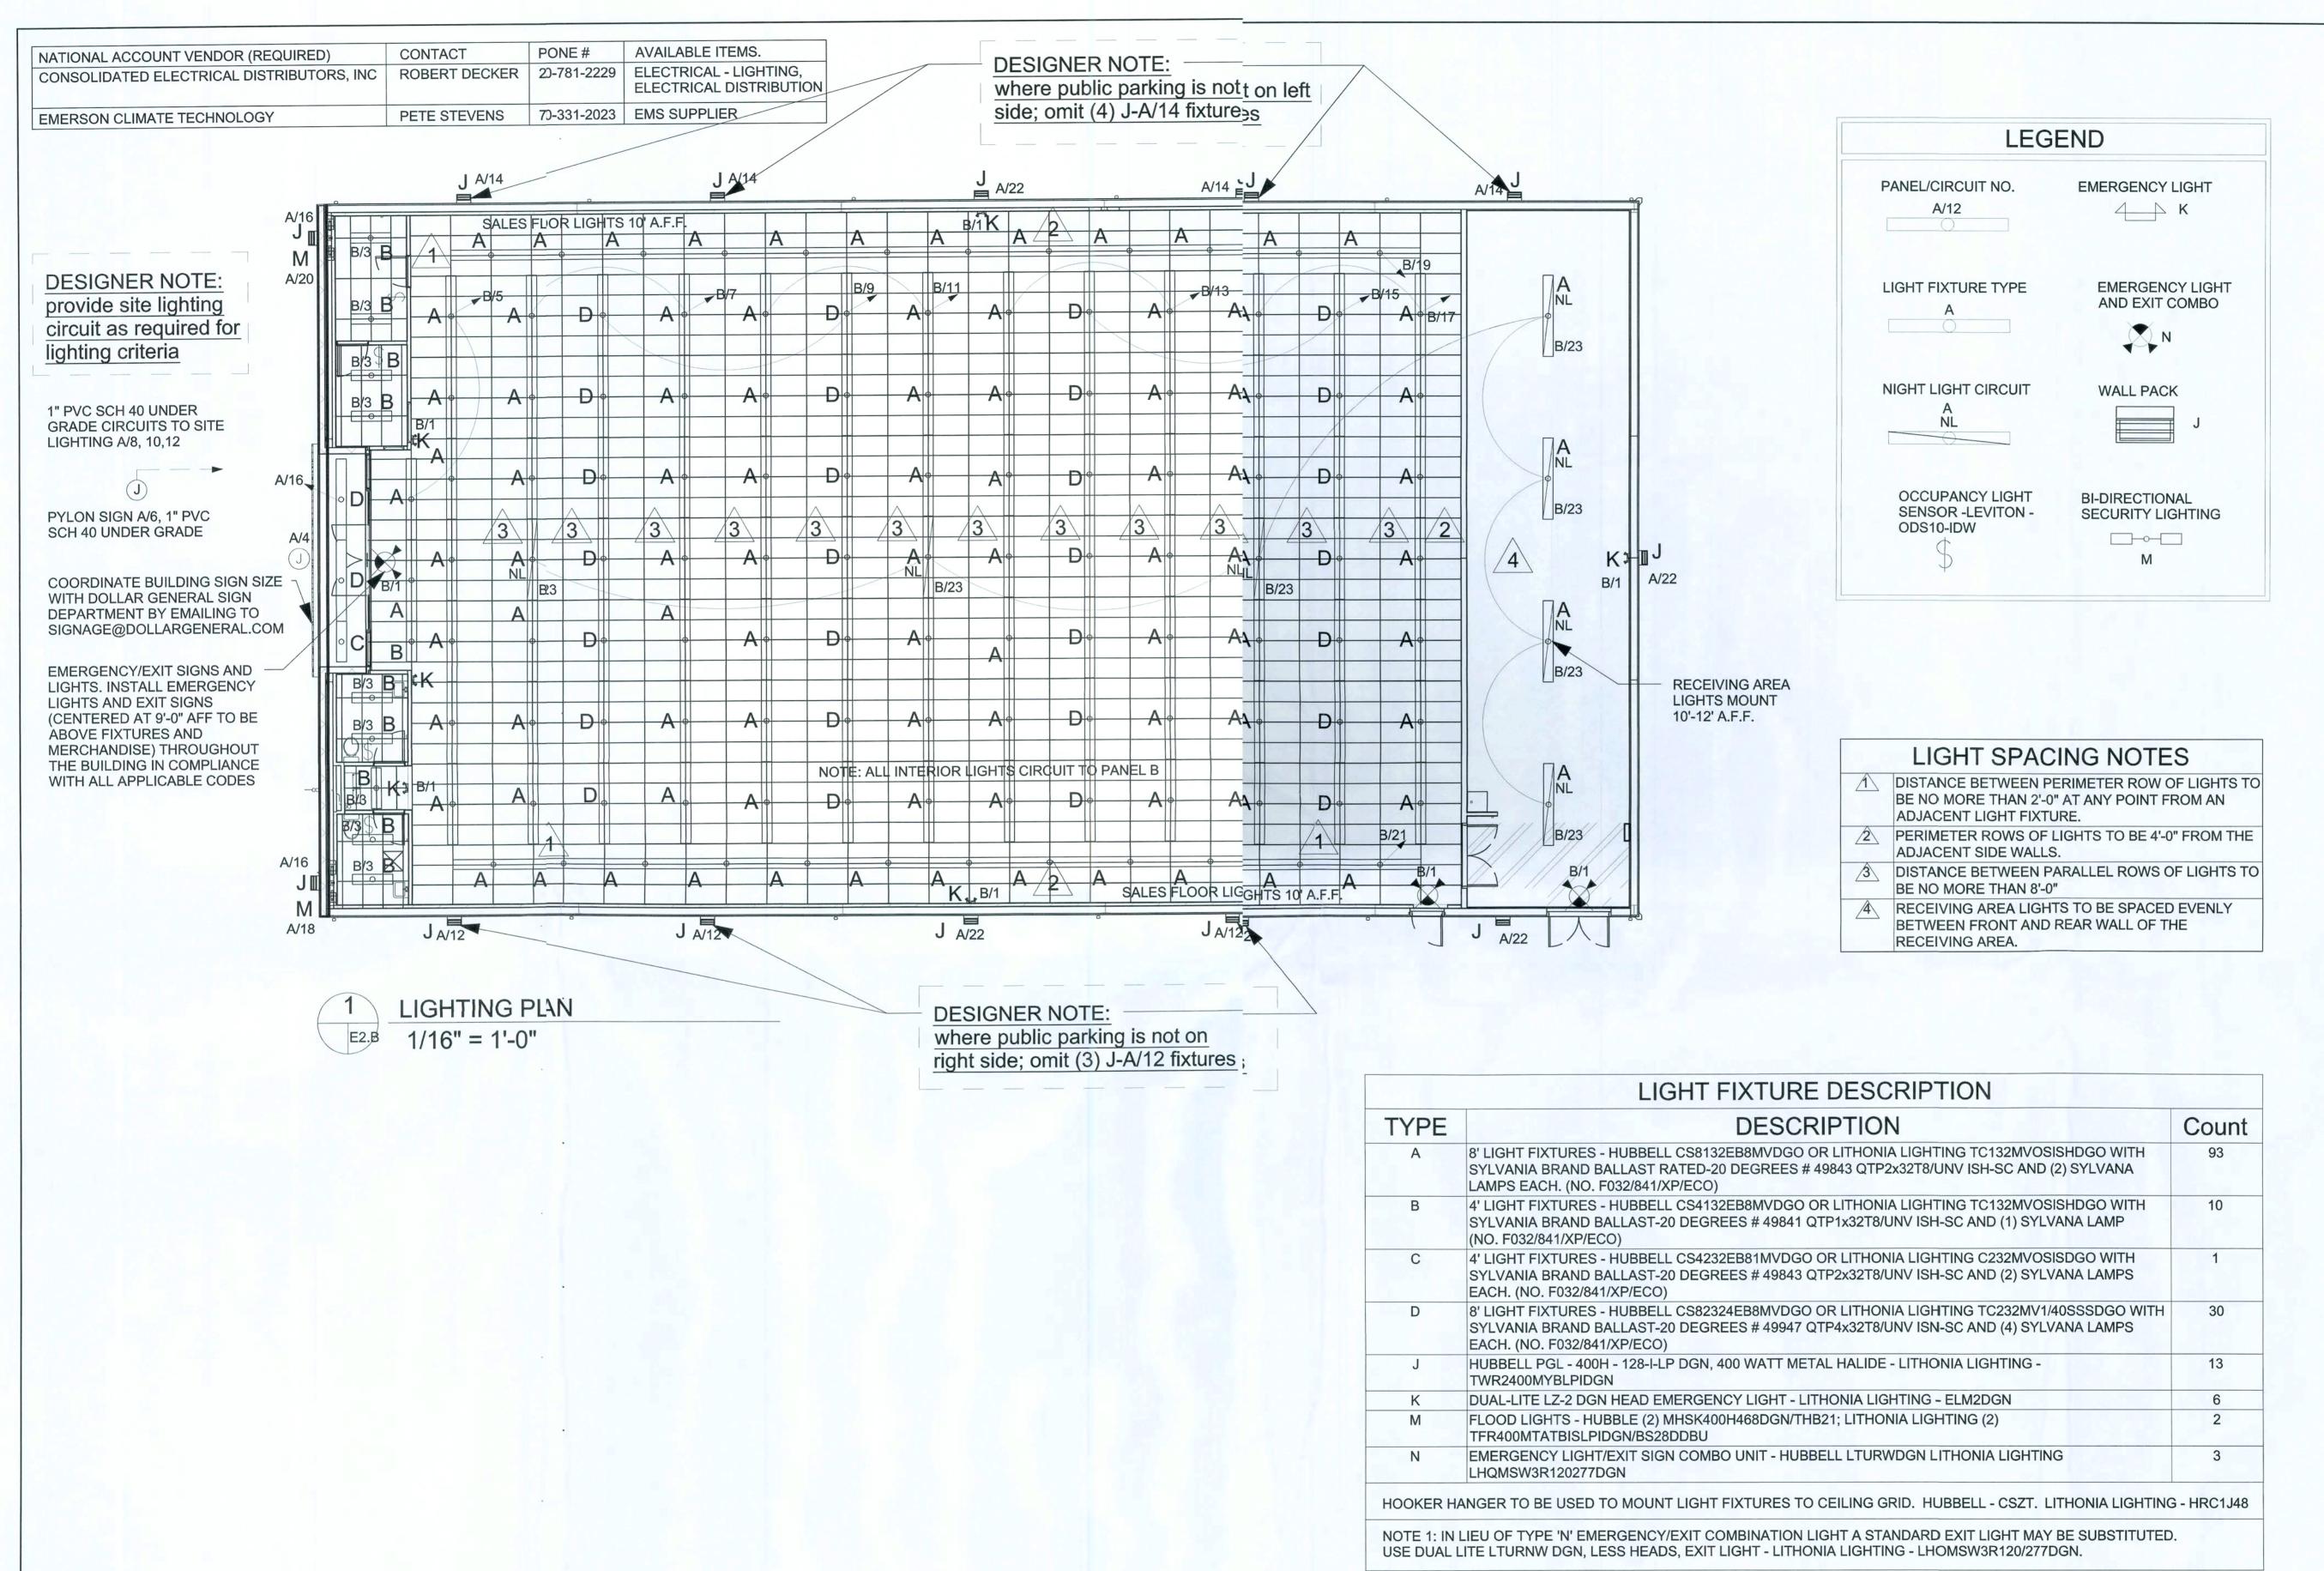05/19/08


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E2.B

A mooning



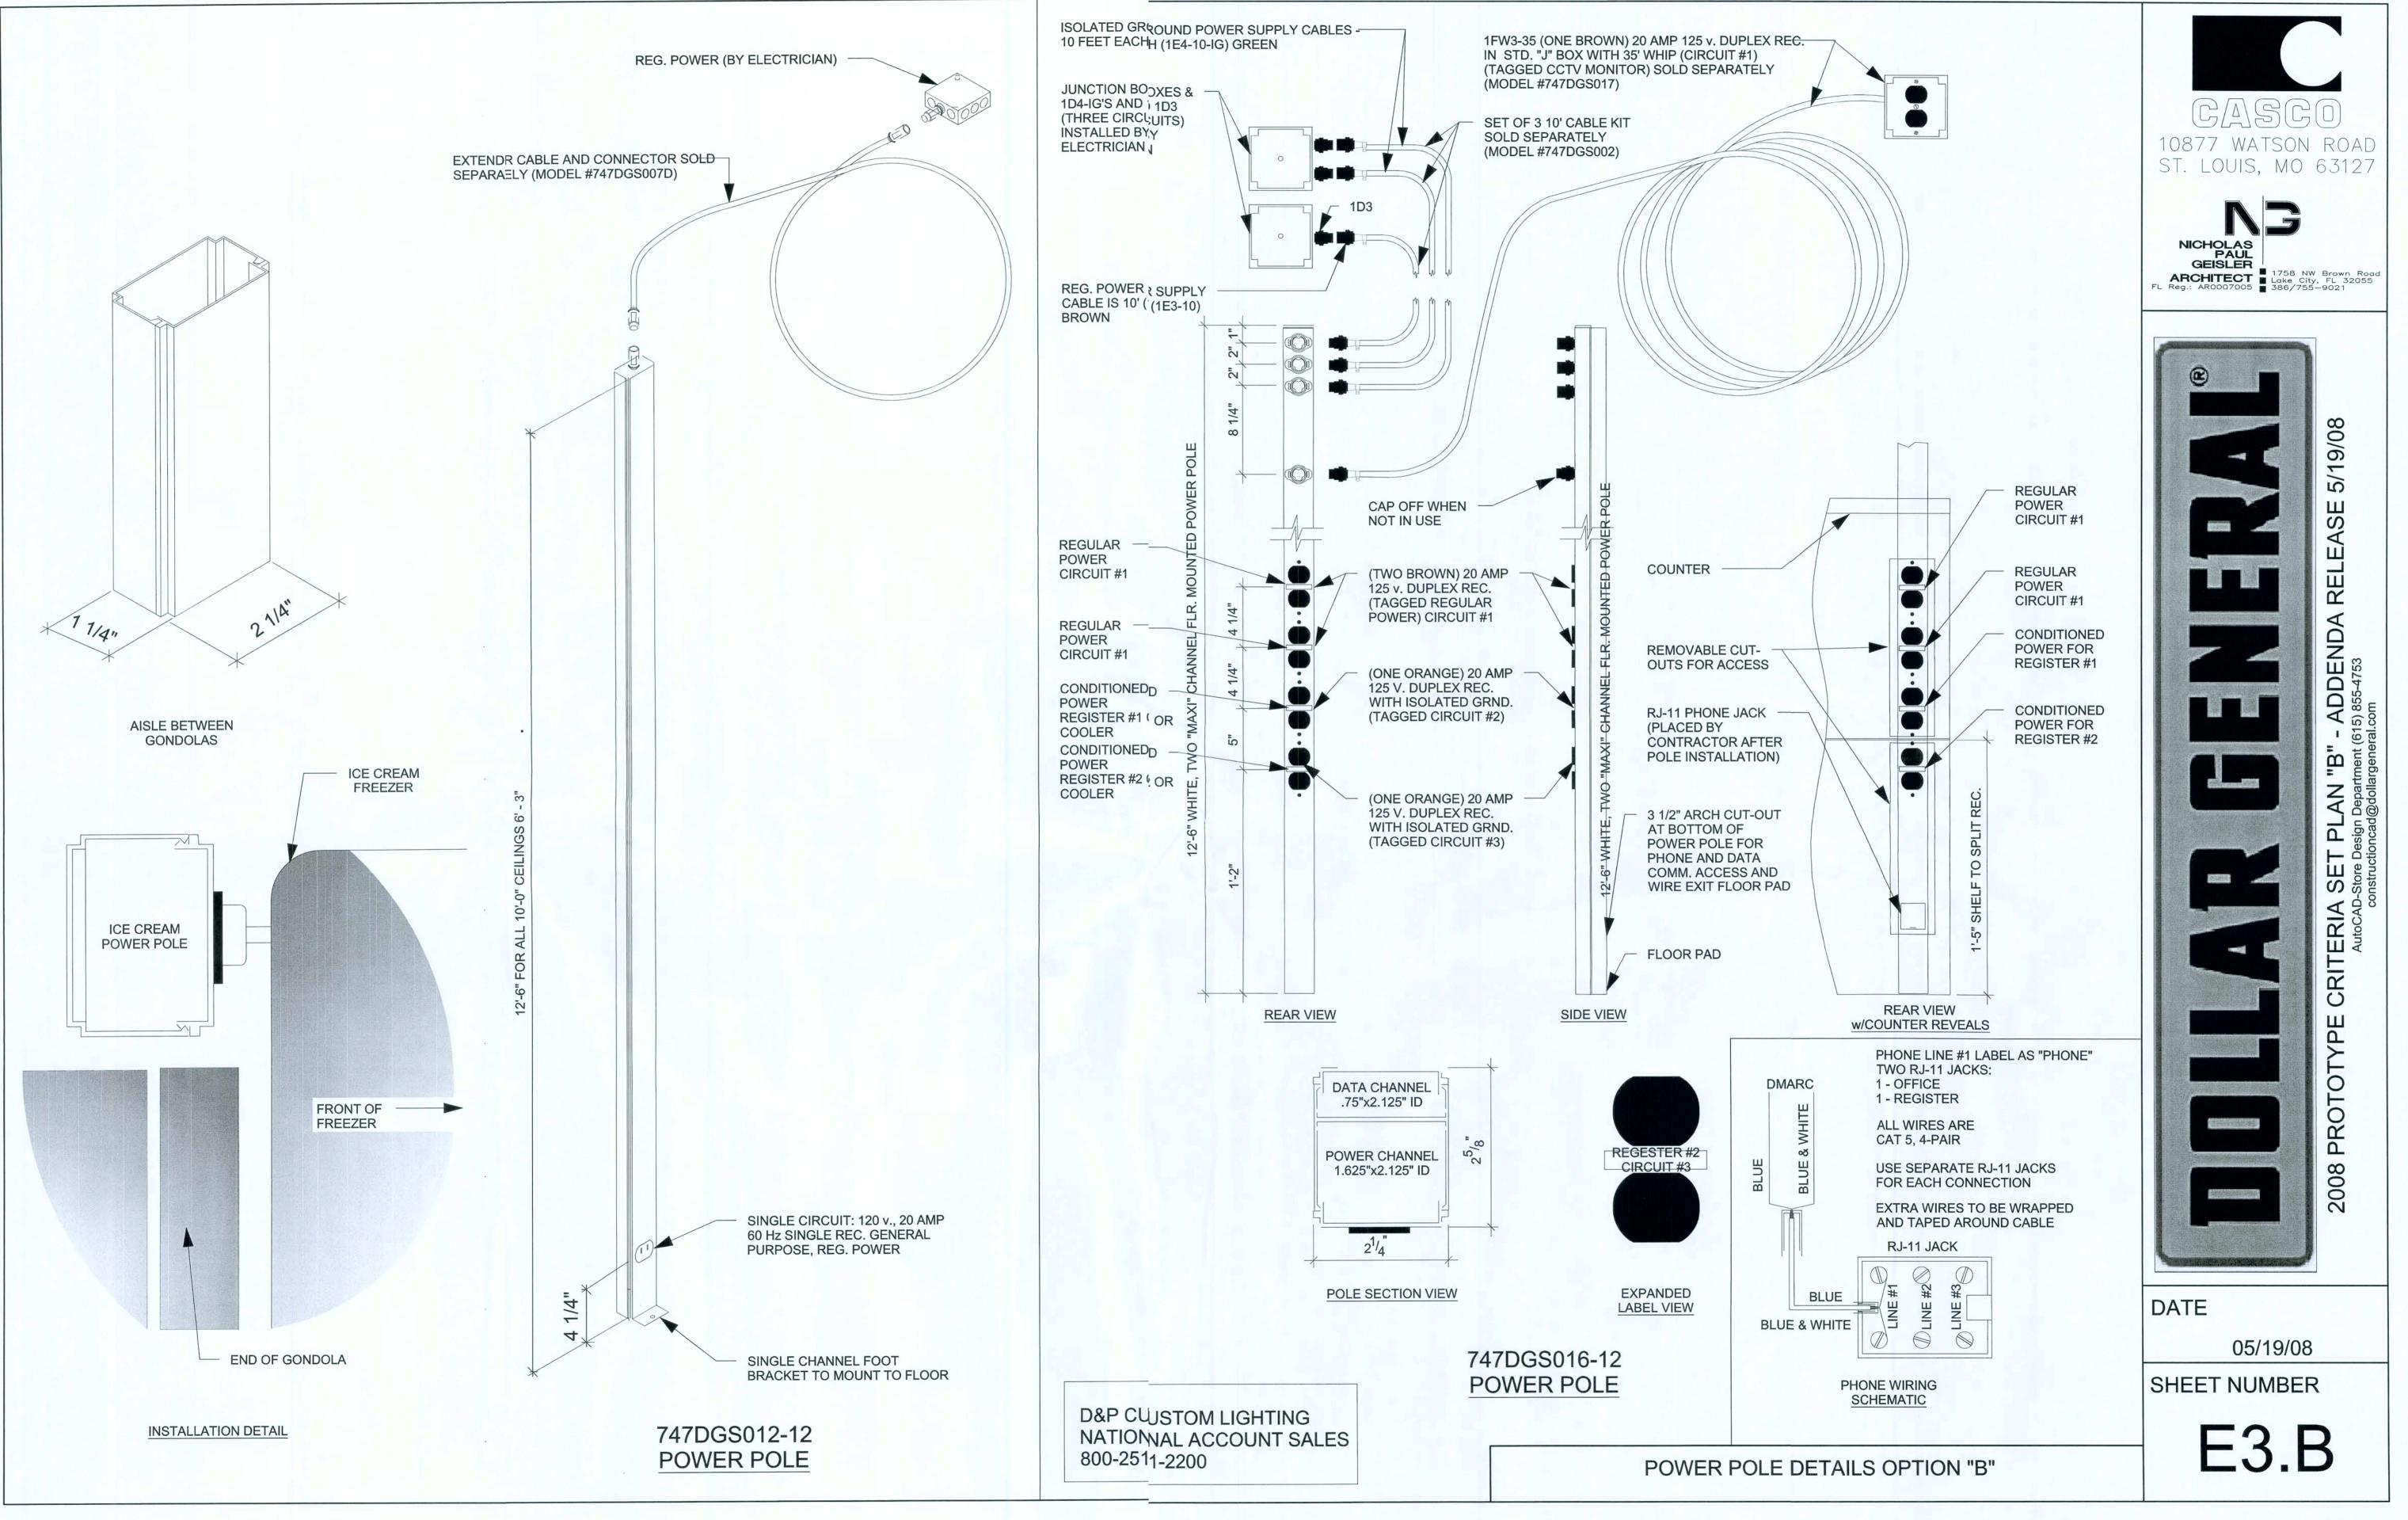

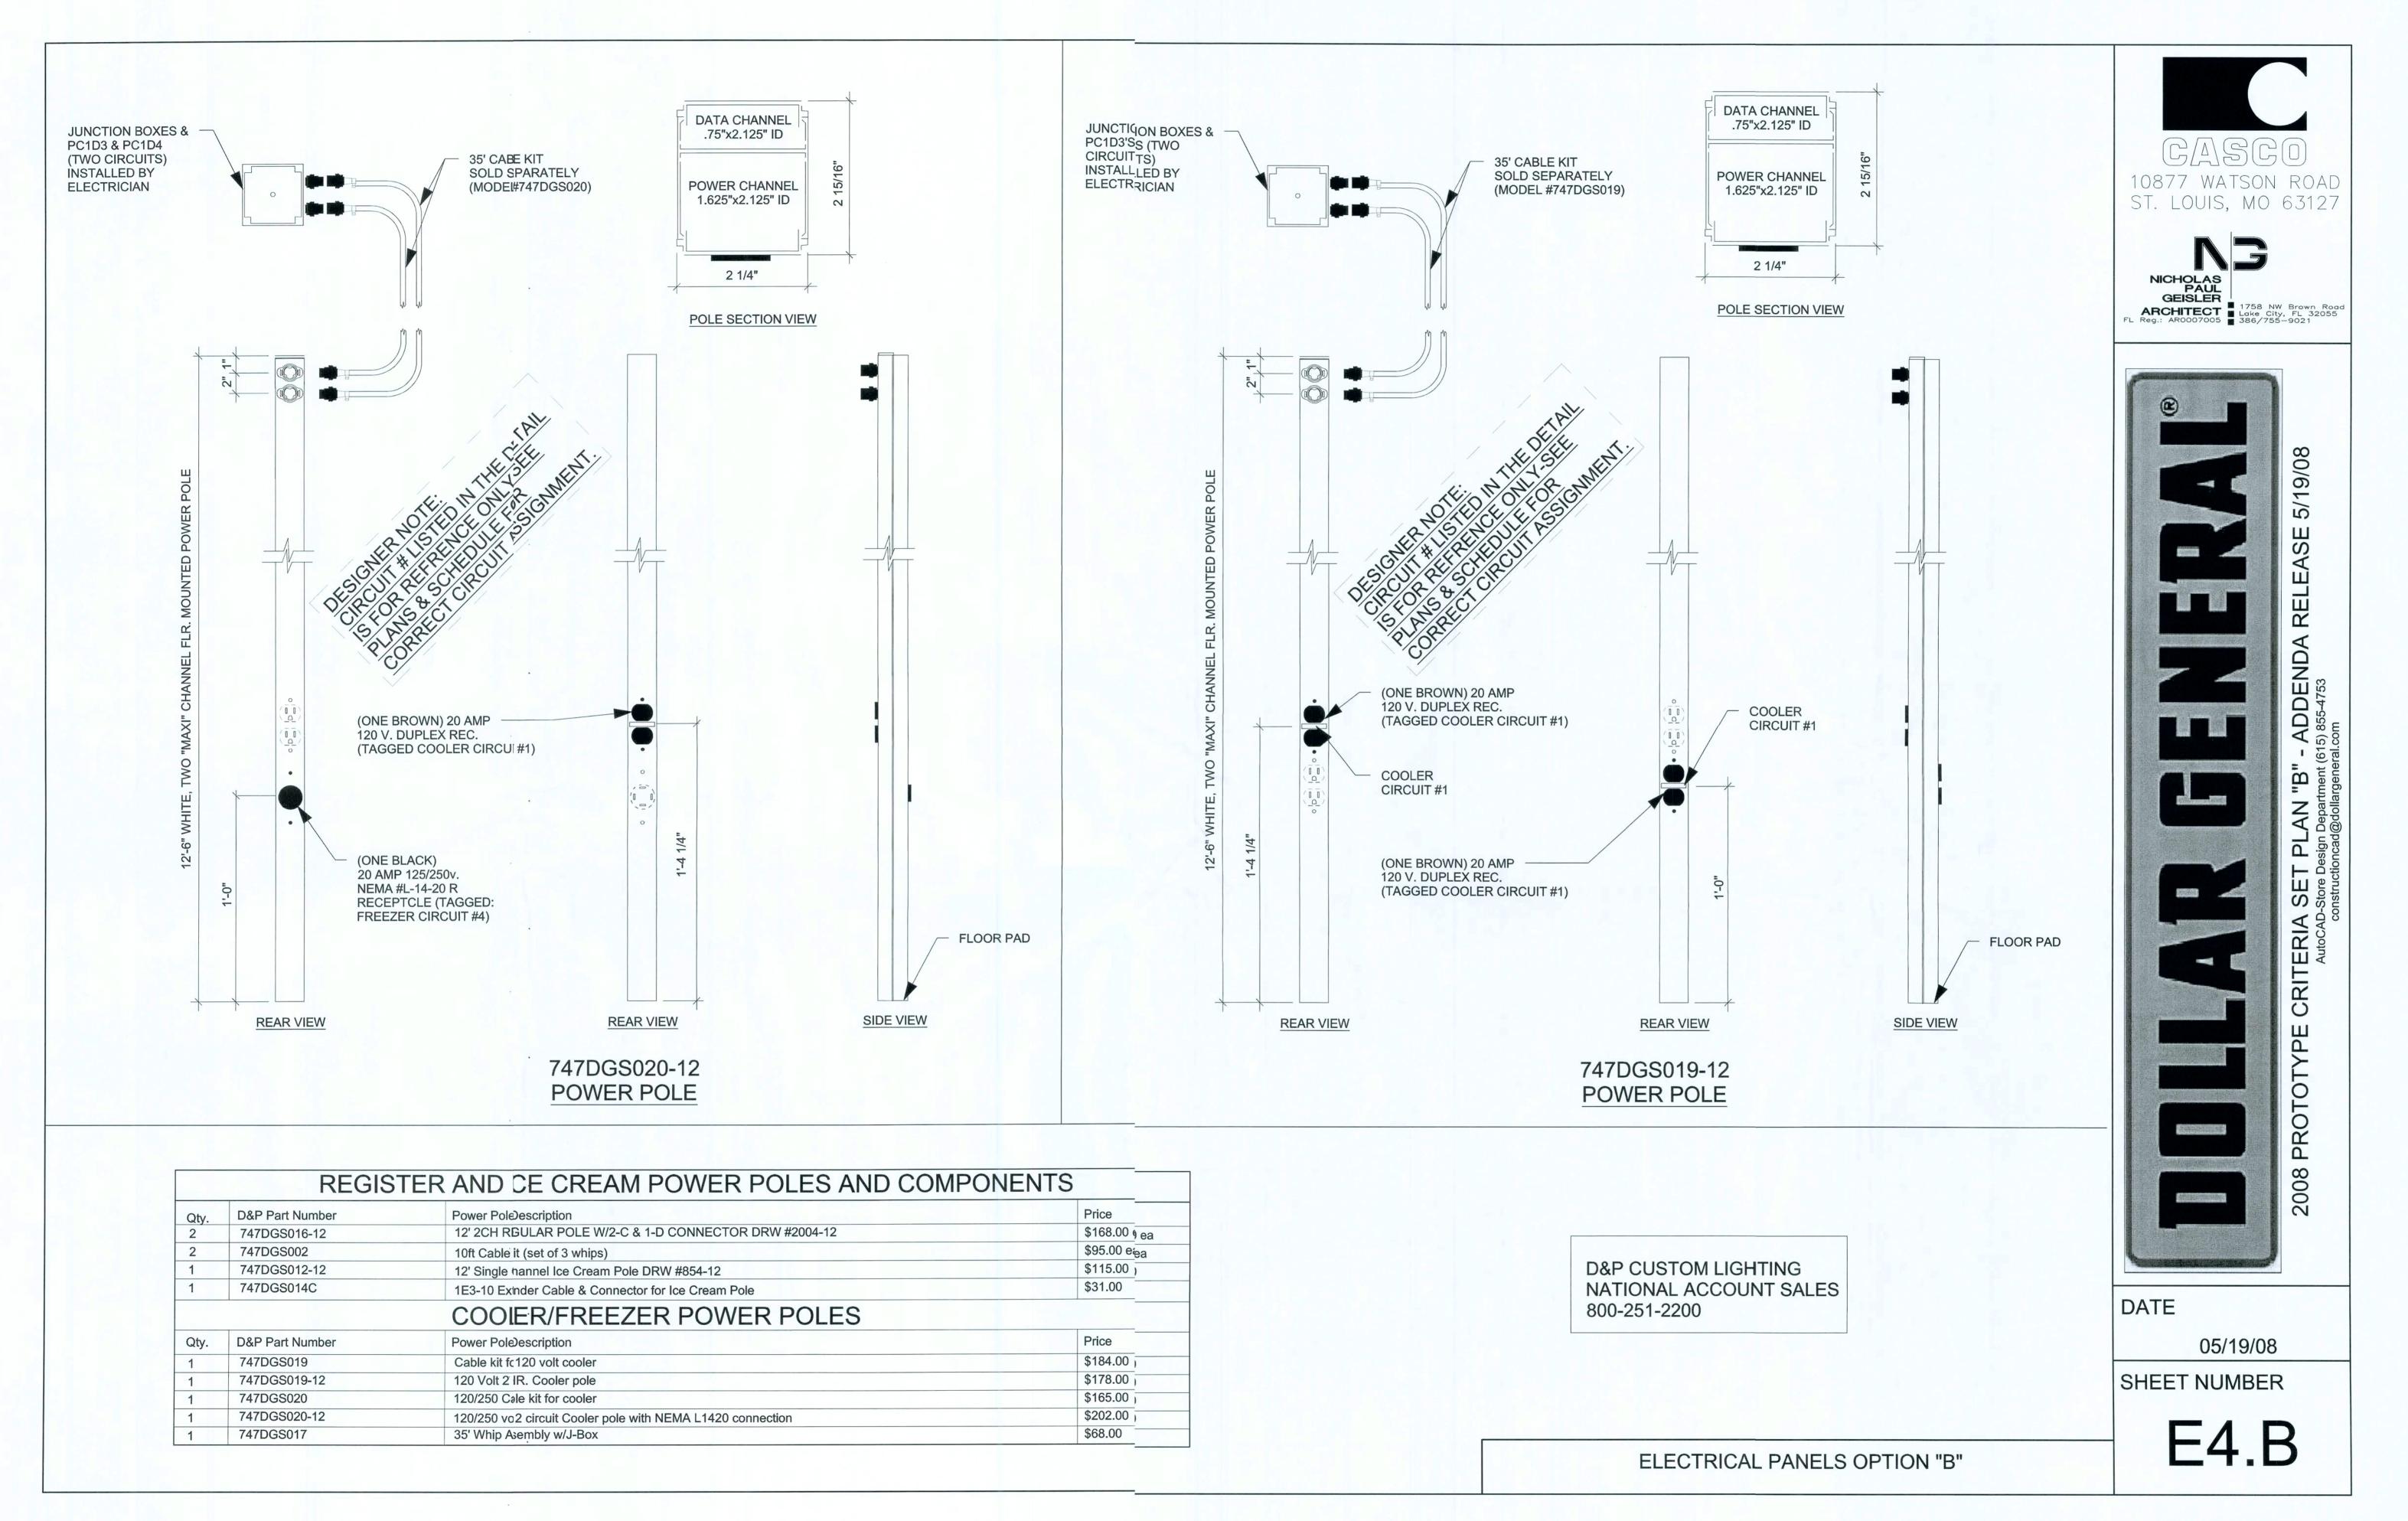

M 14 dnn 169

URF			12012	40 V, 1∅, 3	, , ,	MCB 400)A
KT #	DESCRIPTION		LOAD AØ	S KW BØ		ESCRIPTION	CK
1		80	180		\cap	SPARE	2
3	HVAC-1	\cap		900	\cap		4
5	111/4000	80	900		\cap		6
7	HVAC-2	\cap		860 5040	\cap		8
9	HVAC-3	80	860 5040		\cap		10
11	HVAC-3	\cap		1720 5040	\cap		12
13	HVAC-4	80	1720 5040		\cap		14
15	HVAC-4	\cap		293 5040	\cap		16
17	SPARE	\cap	- 860		\cap		18
19	SPARE			860 540	\cap		20
21	AUTOMATIC DOOR	\cap	1290		\cap		22
23	POWER POLE SHARED	\cap		1220 1000	\cap	COOLER #1	24
25	POWER POLE 1 CKT. 1	\cap	1220 360		\cap	COOLER #2	26
27	POWER POLE 1 CKT. 2	\cap		1620 180	\cap	FREEZER	28
29	POWER POLE 2 CKT. 3	\cap	1620 360				30
31	POWER POLE 2 CKT. 4	\cap		1220	\cap	FITURE COOLER	32
33	ICE CREAM POWER POLE	\cap	1200		\cap	SPARE	34
35	DRINKING FOUNTAIN	\cap		540	\cap	SPARE	36
37	OUTDOOR ICE MERCHANDISE	R (800		\cap	SPARE	38
39	OUTDOOR DRINK VENDING	\cap		8882 1200	100	PANEL B	40
41	OUTDOOR HVAC REC.	\cap	8649 180		\cap	7 XI 3 bin bit bir	42

PANEL A NOTES:

1) ALL BREAKERS 20/1 UNO
2) PANEL A TO BE SERVICE ENTRANCE RATED WITH AIC RATING OF 22 MINIMUM.

3) BREAKERS FOR HVAC UNITS SHALL BE SIZED PER MANUFACTURER EQUIREMENTS.

4) BREAKERS SERVICING HVAC EQUIP AND MOTOR LOADS (COOLERS, REEZERS, ETC) TO BE HACR.

5) BREAKERS SERVICING LIGHTS TO BE SWITCHING DUTY AND HID RAED. 6) MAIN CIRCUIT BREAKER SHALL BE RATED FOR 100% CONTINUOUS DAD.

7) CIRCLED CIRCUIT DENOTES BREAKER LOCKS
8) SHADED DESCRIPTION DENOTES A ROUTING TO THE EMS PANEL

	OVERHEAD OR UNDERGROUPER UTILITY AND SITE-SPEC	
	(3) 600 MCM OR 2 SETS (3) #	3/COPPER THWN.
		RQUIRED. OUTDOOR MAIN SERVICE DISCONNECT ONLY IF REQ'D E. SEK, DOLLAR GENERAL AUTOCAD STORE DESIGN APPROVAL.
		00 A., MCB, 120/240 V., 1 PH., 3 W.
		() #2, #6G, 1 1/2"C
M	A B	10 A., ML0, 120/240 V., 1 PH., 3 W.
	#	D SYSTEM GROUND TO FOOTING REBAR, METAL WATER IPE AND BUILDING STRUCTURAL STEEL, PER NEC 250.66
		DTE; PROVIDE GROUND ELECTRICAL IF EXTERIOR DISCONNECT IF IT IS BED
EXTERIOR - IN	TERIOR	

ELECTRICAL PANEL SCHEMATD E5.B N.T.S.

SURF/ FLUSH		В	120/2	40 V, 1Ø,	3W, 1	00 A MLO MCB	
CKT #	DESCRIPTION		LOAD AØ	S KW BØ		DESCRIPTION	CKT #
1	EMERGENCY/EXIT LIGHT _{TS}	\cap	180		\cap	TELEPHONE BOARD	2
3		\cap		180 920	\cap	ENERGY MANAGEMENT	4
5		\cap	540 541		\cap	SECURITY OUTLETS	6
7		\cap		540 845	\cap	OFFICE OUTLETS	8
9		\cap	540 1596		\cap	BREAK ROOM OUTLETS	10
11		\cap		720 541	\cap	LEFT SIDE SALES OUTLETS	12
13		\cap	540 541		\cap	RIGHT SIDE SALES OUTLETS	14
15				1250 1596	20	WATER HEATER RECTROOMS	16
17		<u> </u>	1250 541		\cap	WATER HEATER RESTROOMS	18
19		0		1250 780	20	WATER HEATER RECEIVING	20
21			1250 780		\cap	WATER HEATER RECEIVING	22
23 RI	ECEIVING LIGHTS/NIGHT LIG _{GHTS}			260	\cap	SPARE	24
25	SPARE	\cap	-		\cap	SPARE	26
27	SPARE	\cap			\cap	SPARE	28
29	SPARE	\cap			\cap	SPARE	30
			8649	8882			

PANEL B NOTES: 1) CIRCLED CIRCUIT DENOTES BREAKER LOCKS 2) ALL BREAKERS 20/1 UNO

3) ALL BREAKERS SWD, HID RRATED
4) PANEL B SERIES RATED WIVITH PANEL A
5) SHADED DESCRIPTION DEPNOTES A ROUTING TO THE EMS PANEL

CONNECTIVE LOAD SUMMATION

TOTAL LOAD =

INTERIOR LIGHTING = 10398 VA SITE AND SIGN LIGHTING = 10263 VA RECEPTACLE LOAD = 3960 VA HVAC LOAD = 40320 VA EQUIPMENT LOAD = 16793 VA

81734 VA

341 AMPS

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DATE

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E5.B

ELECTRICAL PANELS OPTION "B"



SYMBOL	DESCRIPTION	CABLE TYPE
AT	AHU TERMINAL STRIP	8C T-STAT CABLE
DS	DOOR CONTACT SWITCH	BELDEN 8761 OR EQUIVALEN (22AWG, 2C, STRANDED, SHILDED)
N	NETWORK CABLE	CAT5
	MOTION SENSOR	(18AWG, 4C, STRANDED, SHILDED)
(M)		LEVITON EZ-FIND ODC0S-ID\
OT	OUTDOOR AIR TEMP	BELDEN 8761 OR EQUIVALEN (22AWG, 2C, STRANDED, SHILDED)
ST	SUPPLY TEMP (501-1121)	BELDEN 8761 OR EQUIVALEN (22AWG, 2C, STRANDED, SHILDED)
T	TEMPERATURE SENSOR (501-1121)	BELDEN 8761 OR EQUIVALENT (22AWG, 2C, STRANDED, SHILDED)
TS	TEMPERATURE SENSOR (809-6590)	BELDEN 8761 OR EQUIVALEIF (22AWG, 2C, STRANDED, SHILDED)
\$	MOTION SENSOR	LEVITON EZ-FIND ODS-10-IW

SENSOR PLAN KEYED NOTES 1 THE EXACT MOUNTING LOCATION OF THE SENSOR WILL VARY DEPENDING ON THE STORE LAYOUT AND DUCT CONFIGURATION. REFER TO SITE SPECIFIC DRAWINGS FOR EXACT SENSOR MOUNTING LOCATIONS

ELECTRICAL CONTRACTOR TO INSTALL (1) CONDUIT TO CHANNEL (3) 22AWG, 2C, STRANDED & SHIELDED LOW VOLTAGE WIRES FROM CEILING TO WALL BEHIND COOLERS & FREEZERS AND COVER JUNCTION BOX WITH SOLID WALL PLATE. WALL PENETRATION SHALL BE 6'-0" AFF AND 56'-0" FROM FRONT SALES FLOOR/BREAK ROOM WALL. PROVIDE 20' OF EXTRA COILED LOW VOLTAGE WIRE ABOVE THE CELING. DOLLAR GENERAL WILL PROVIDE FINAL CONNECTIONS TO TEMPEATURE SENSORS.



NICHOLAS PAUL GEISLER ARCHITECT | 1758 NW Brown Road Lake City, FL 32055 | 386/755-9021

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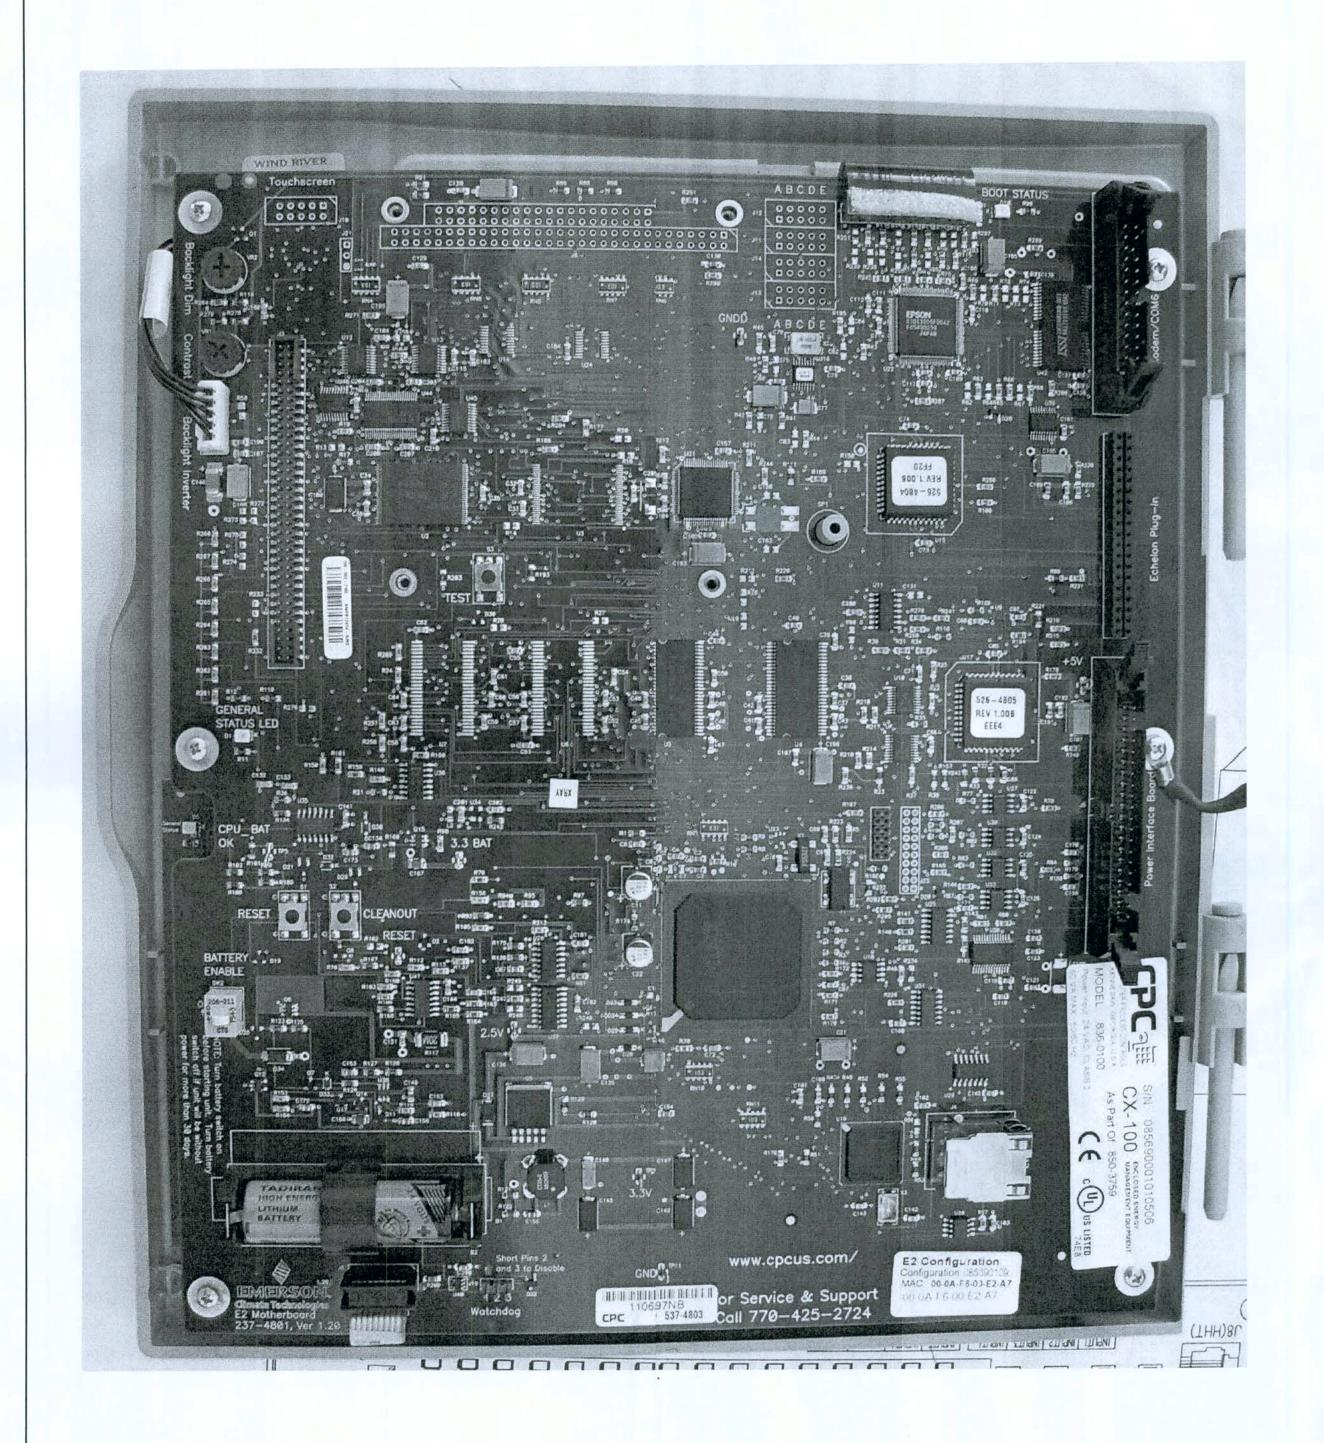
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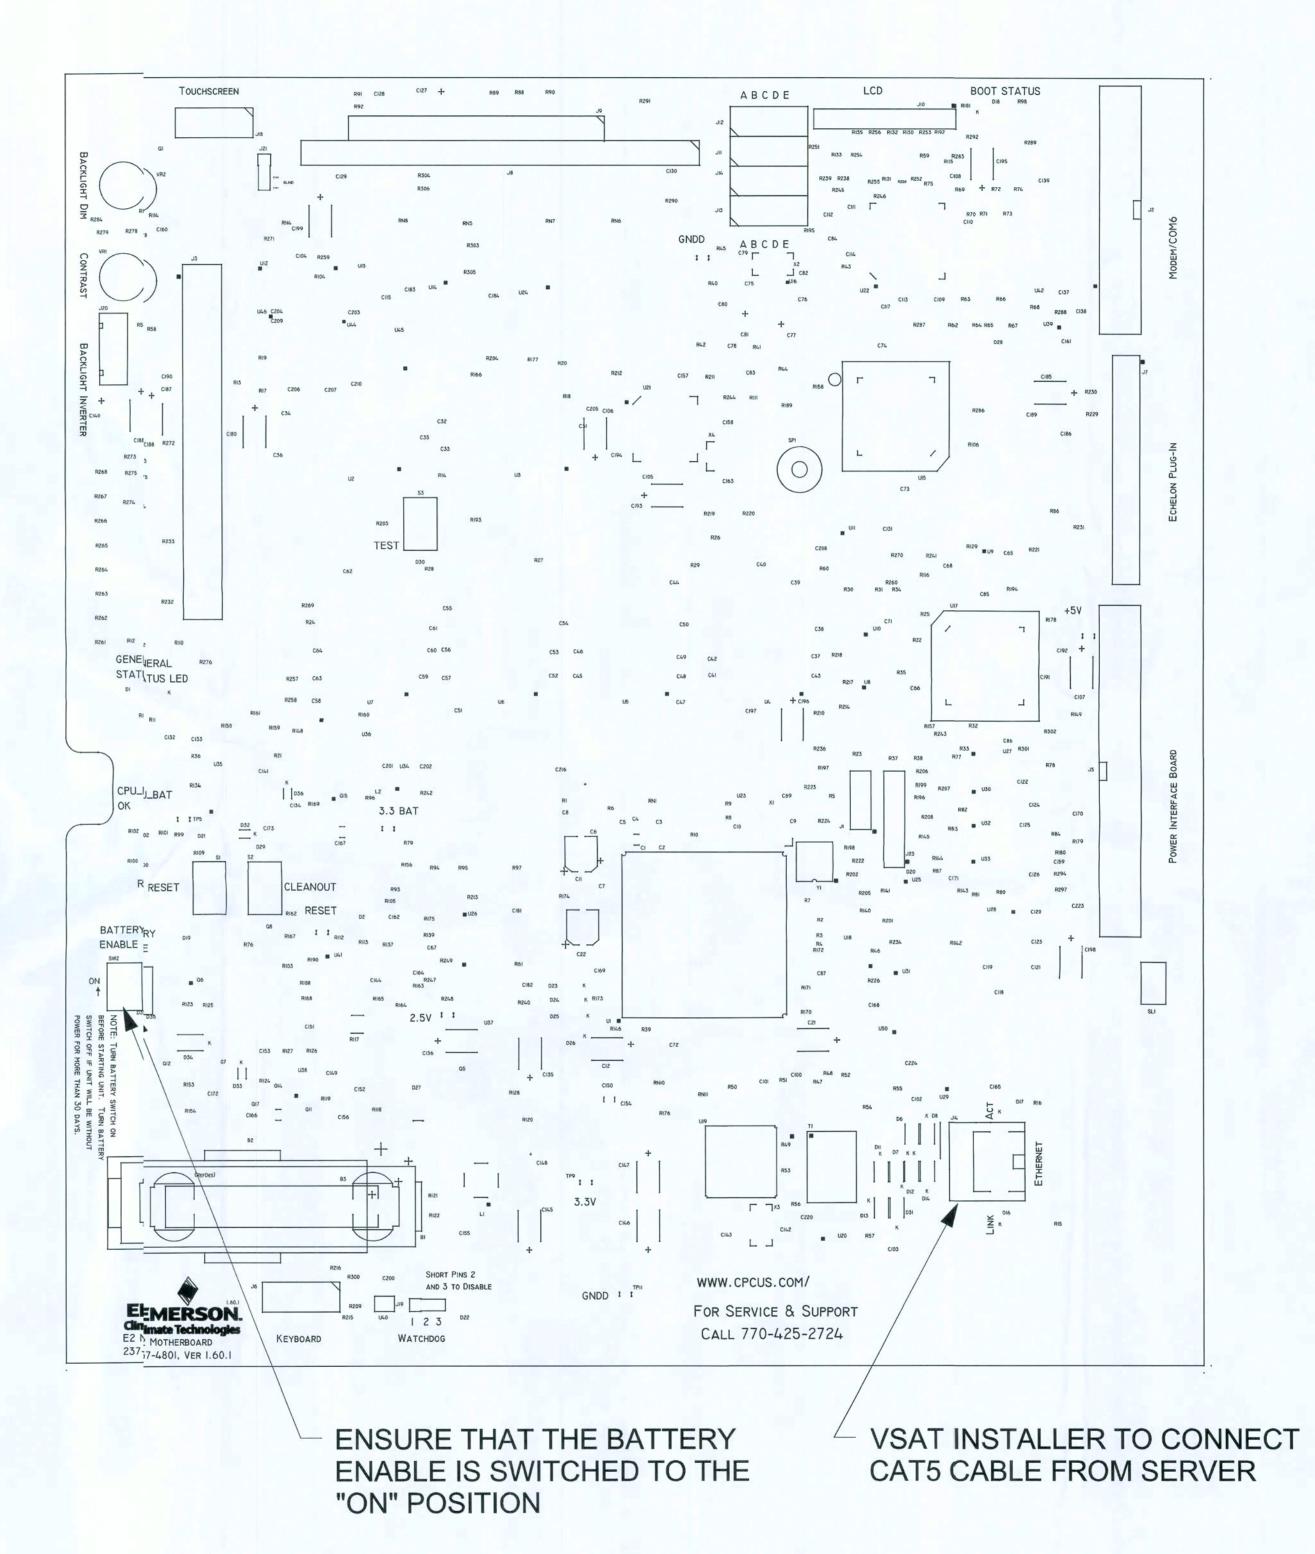
EMS1.B

COOLER ___ \FREEZER -----CASH REGISTER STATION (APPROXIMATE LOCATION) EMS PANEL

NOTE: ALL QUESTIONS PERTAINING TO THE EMS PANEL, SYSTEM INSTALLATION & SETJP SHOULD BE DIRECTED TO 770-425-2724.

SENSOR LOCATION PLAN OPTION "B"







DATE


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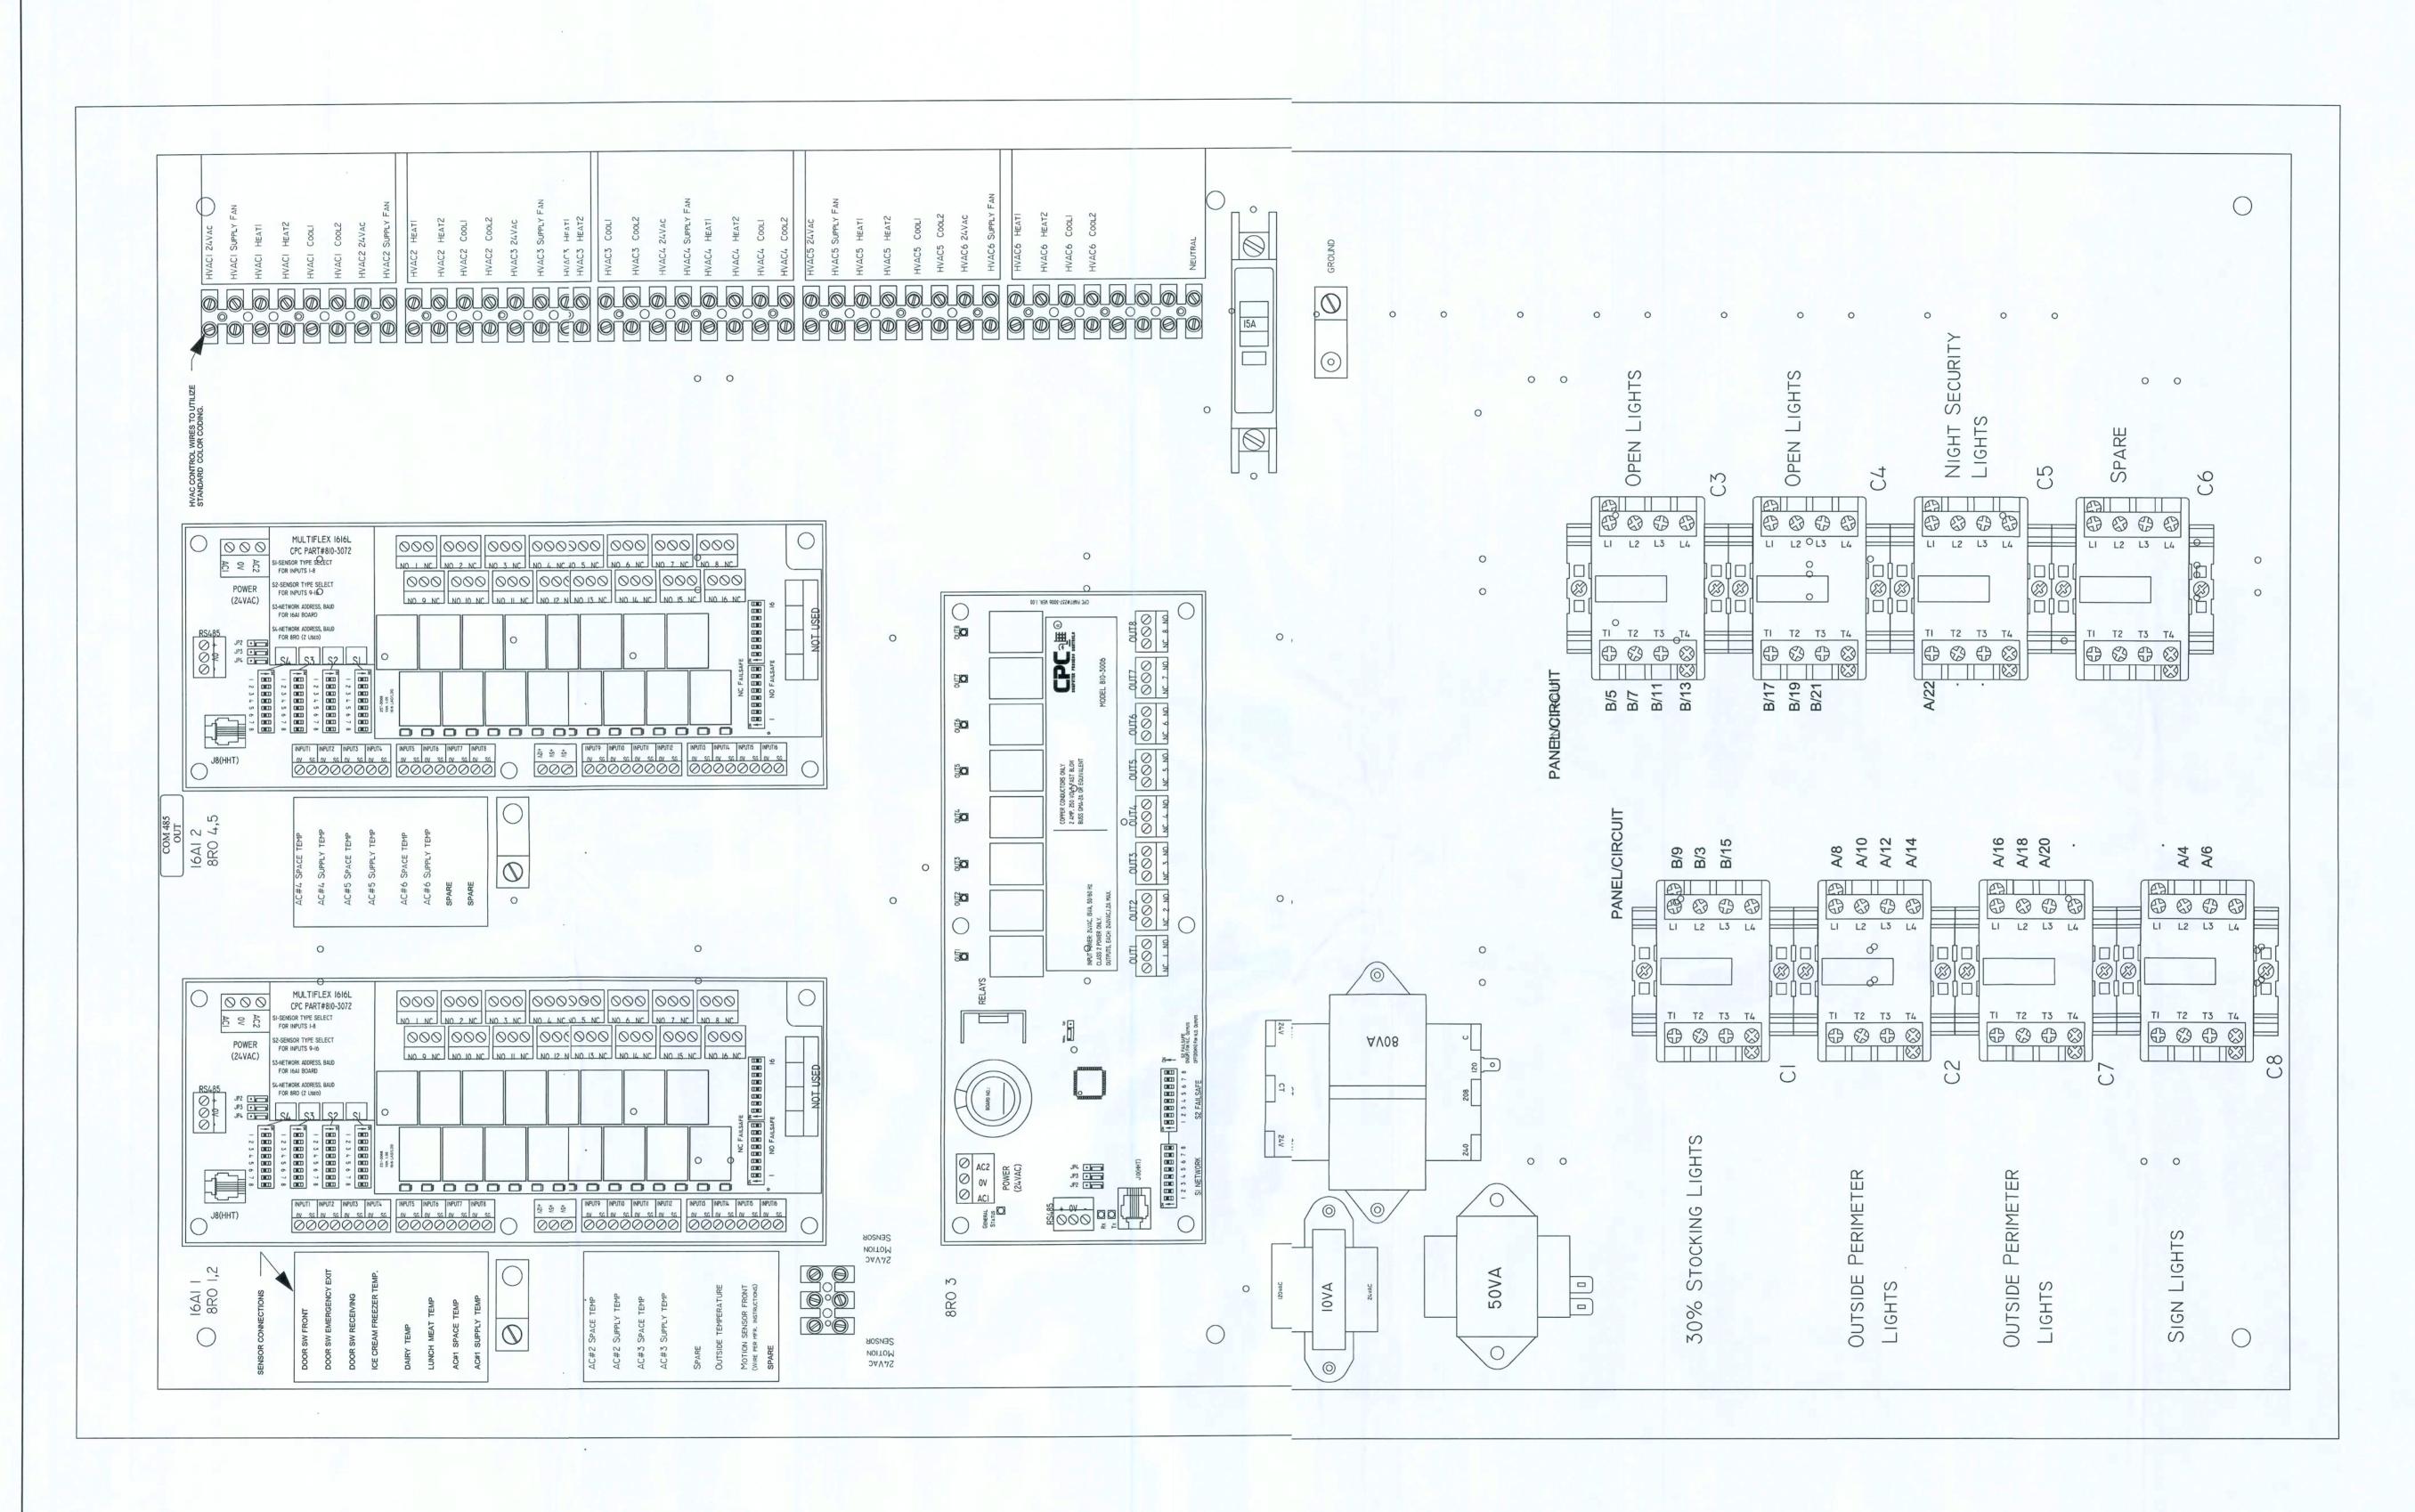
EMS2.B

SENSOR LOCATION PLAN OPTION "B"





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- ADDENDA 15) 855-4753 E CRITERIA SET PLAN "
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EMS4.B

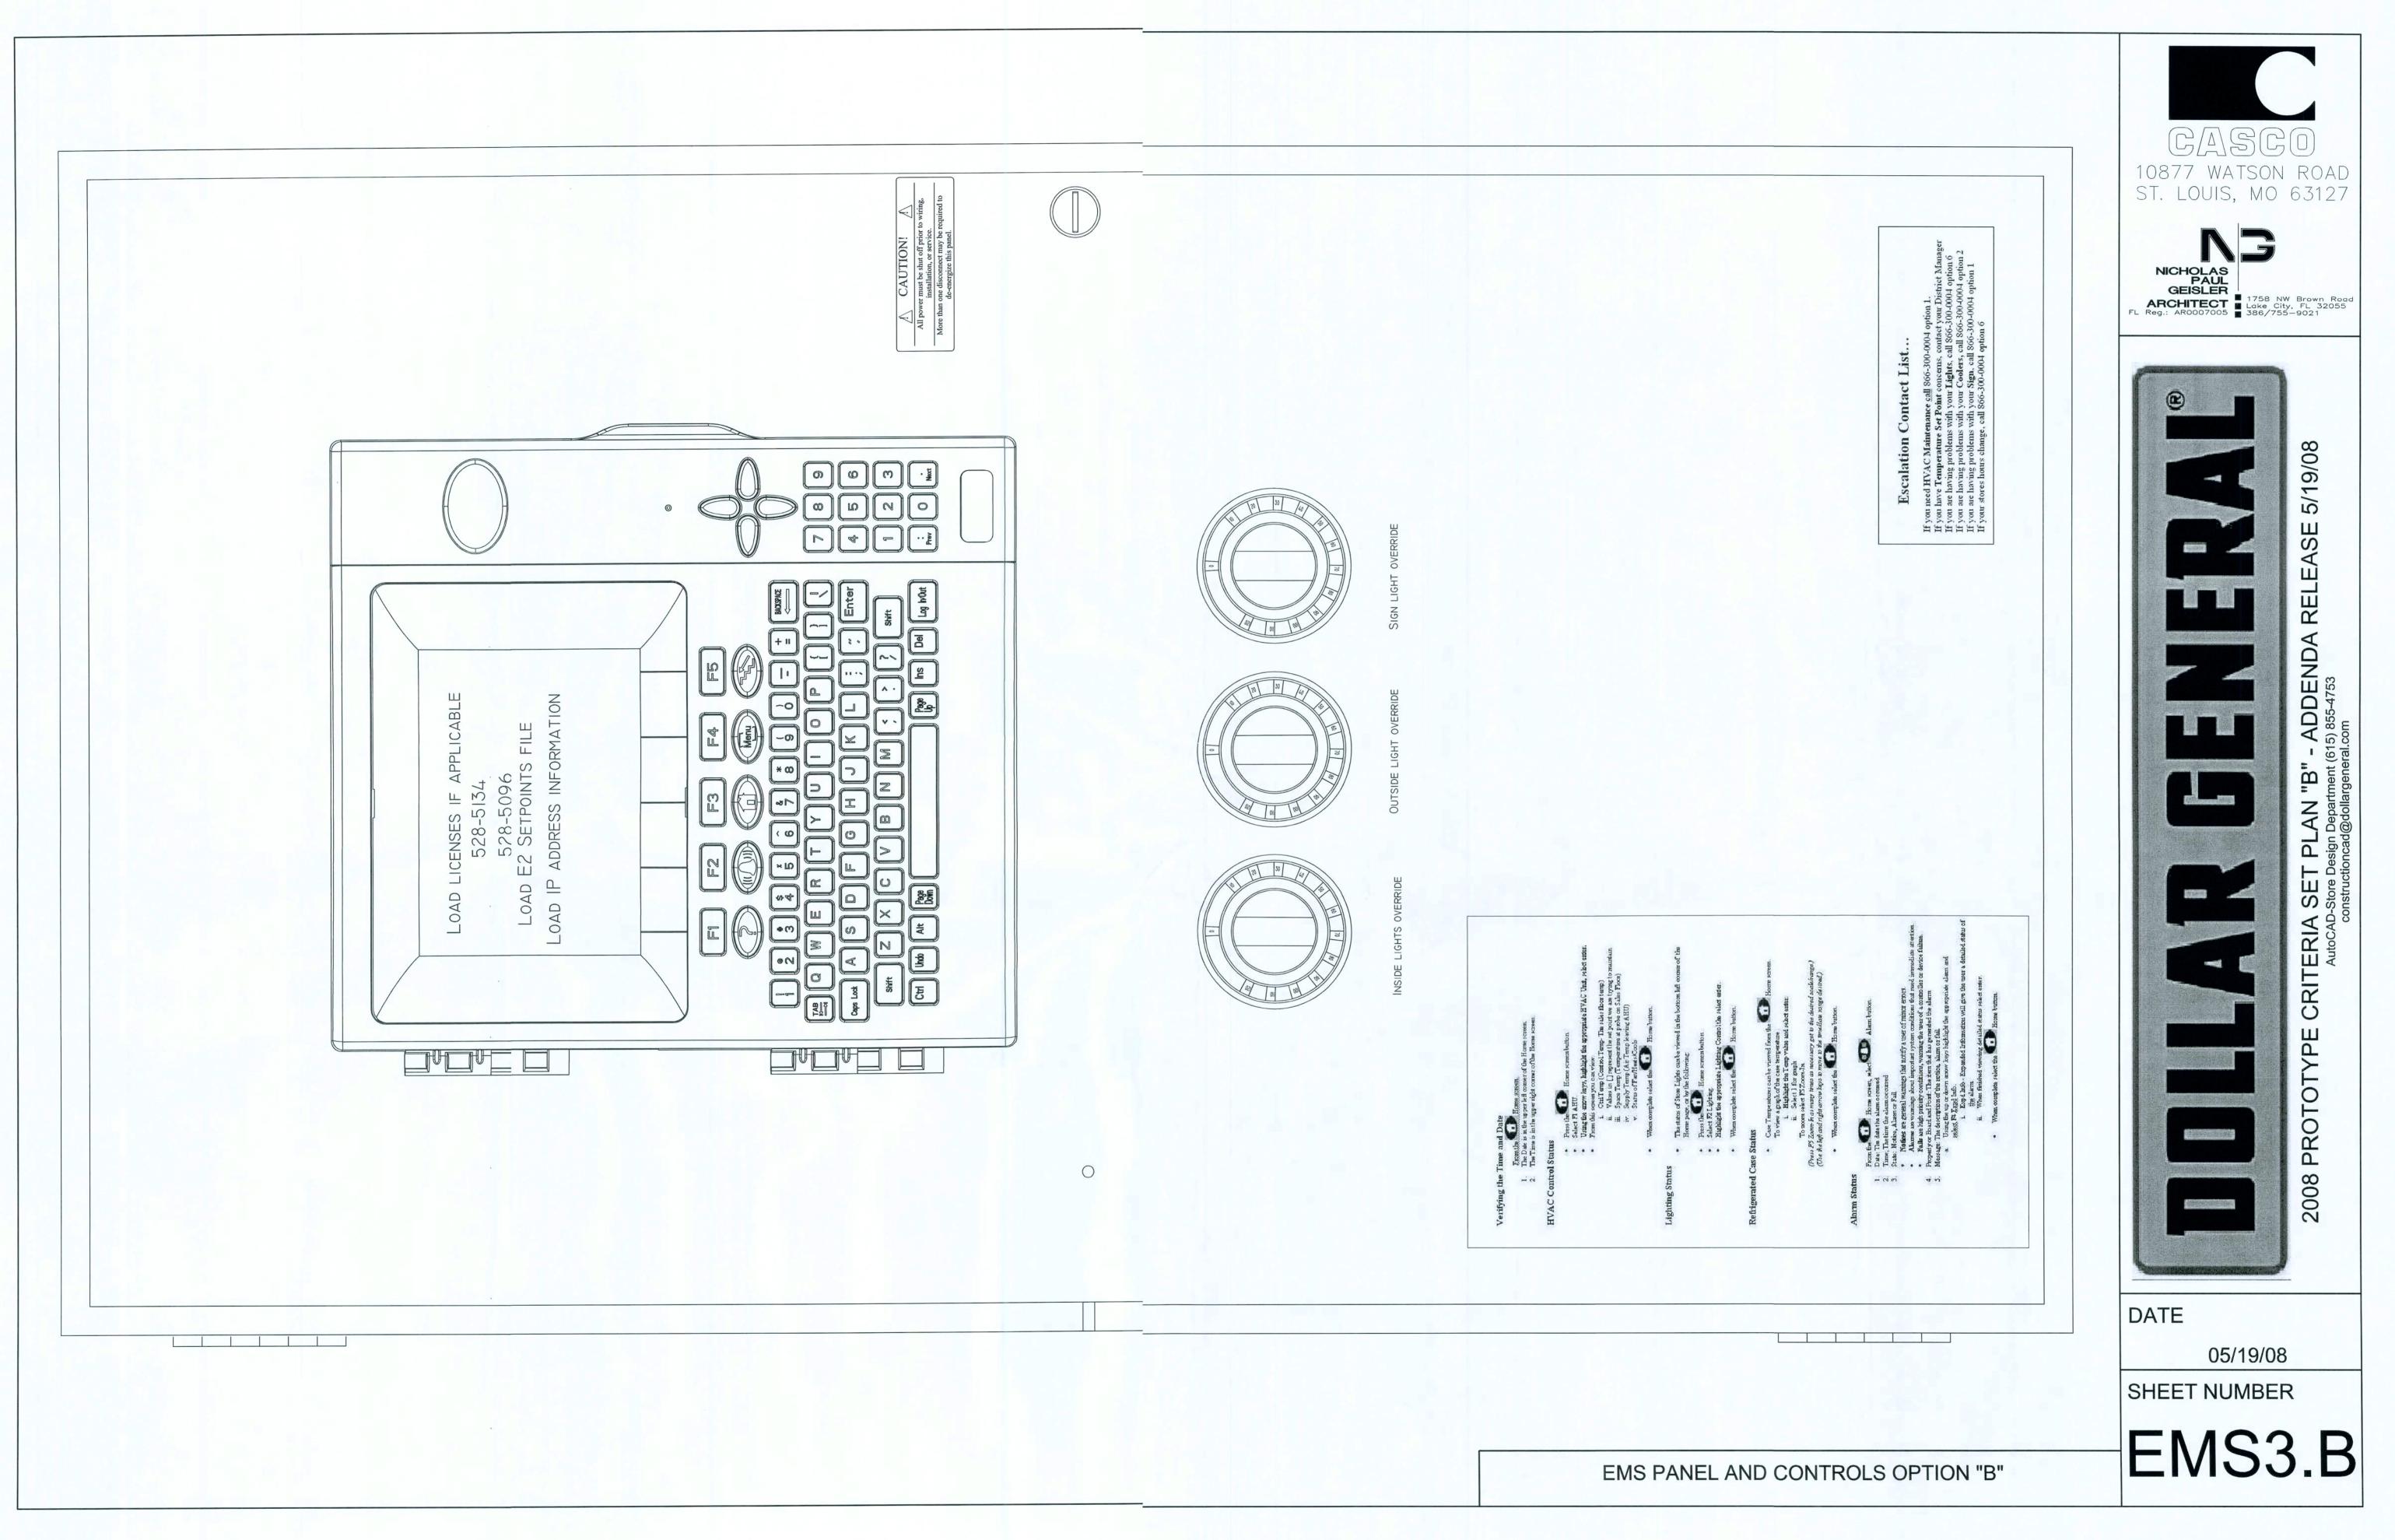EMS PANEL AND CONTROLS OPTION "B"

1. FINAL SIGN CONNECTION AND UNDERGROUND CONUIT IS LANDLORD RESPONSIBILITY. PROVIDE CONDUIT FROM THE ELECTRICAL PANEL TO DCATION OF THE PYLON SIGN BASE. BURY CONDUIT UNDER PARKING AREA. THE CONDUIT; TO BE 1" AND HAVE ONE SET TO 10/2 WIRE WITH GROUND AND A 20-AMP TWO POLE BREAKR AT THE PANEL. A TEMPORARY 3' TALL STAKE SHALL BE PROVIDED TO DESIGNATE THE YLON SIGN LOCATION UNTIL THE SIGN IS PERMANENTLY INSTALLED. REMOVE POST AFTER SIN IS INSTALLED.

2. SITE / PARKING LOT LIGHTING: PROVIDE ADEQUATPOLE AND/ OR WALL LIGHTING FOR NIGHT VISION. AROUND ENTRY, PARKING AND DUMPSER PAD AREAS

3. MINIMUM OF TWO FOOT-CANDLES REQUIRED FOR AL PAVED AREAS EXCLUDING 15' PERIMETER FROM EDGE OF PAVEMENT.

4. REQUIRED LIGHTING: A COMBINATION OF POLE LIGTS, BI-DIRECTIONAL SECURITY LIGHTS AND WALL PACKS WILL BE USED. REFER TO ELECTRICAL S'E PLAN AND SHEET E2.B FOR ADDITIONAL INFORMATION

5. PLEASE NOTE THAT LIGHTING DESIGN AND LAYOUTS SITE SPECIFIC AND MAY REQUIRE ADDITIONAL LIGHTING TO COMPLY WITH SITE DESIGNOONDITIONS. THEREFORE, MAKE PROVISIONS FOR MORE POLE LIGHTING WHEN A SPECIFIC SITE RECUIRES IT.


6. UNDERGROUND ELECTRICAL SHALL BE PROVIDED O THE SITE LIGHT POLES.

7. WHERE LOCAL JURISDICTIONS DO NOT ALLOW DOLLR GENERAL'S REQUIRED LIGHTING PLAN, AN ALTERNATE SITE LIGHTING PLAN & PHOTOMETRIC PLA MUST BE SUBMITTED FOR APPROVAL TO THE DOLLAR GENERAL AUTOCAD-STORE PLAN DEPARTMENT.


8. PHOTO METRIC SITE ANALYSIS AVAILABLE THROUG DOLLAR GENERAL VENDOR CONSOLIDATED ELECTRICAL DISTRIBUTORS CONTACT ROBERT DECKR AT (270) 781-2229.

9. DOLLAR GENERAL VENDOR PRICING FOR WALL PACS OR POLE LIGHTING AVAILABLE FROM CONSOLIDATED ELECTRICAL DISTRIBUTORS ELECTRIAL. CONTACT ROBERT DECKER AT 270-781-2229.

10. SEE SHEET E2.B FOR MORE INFORMATION.

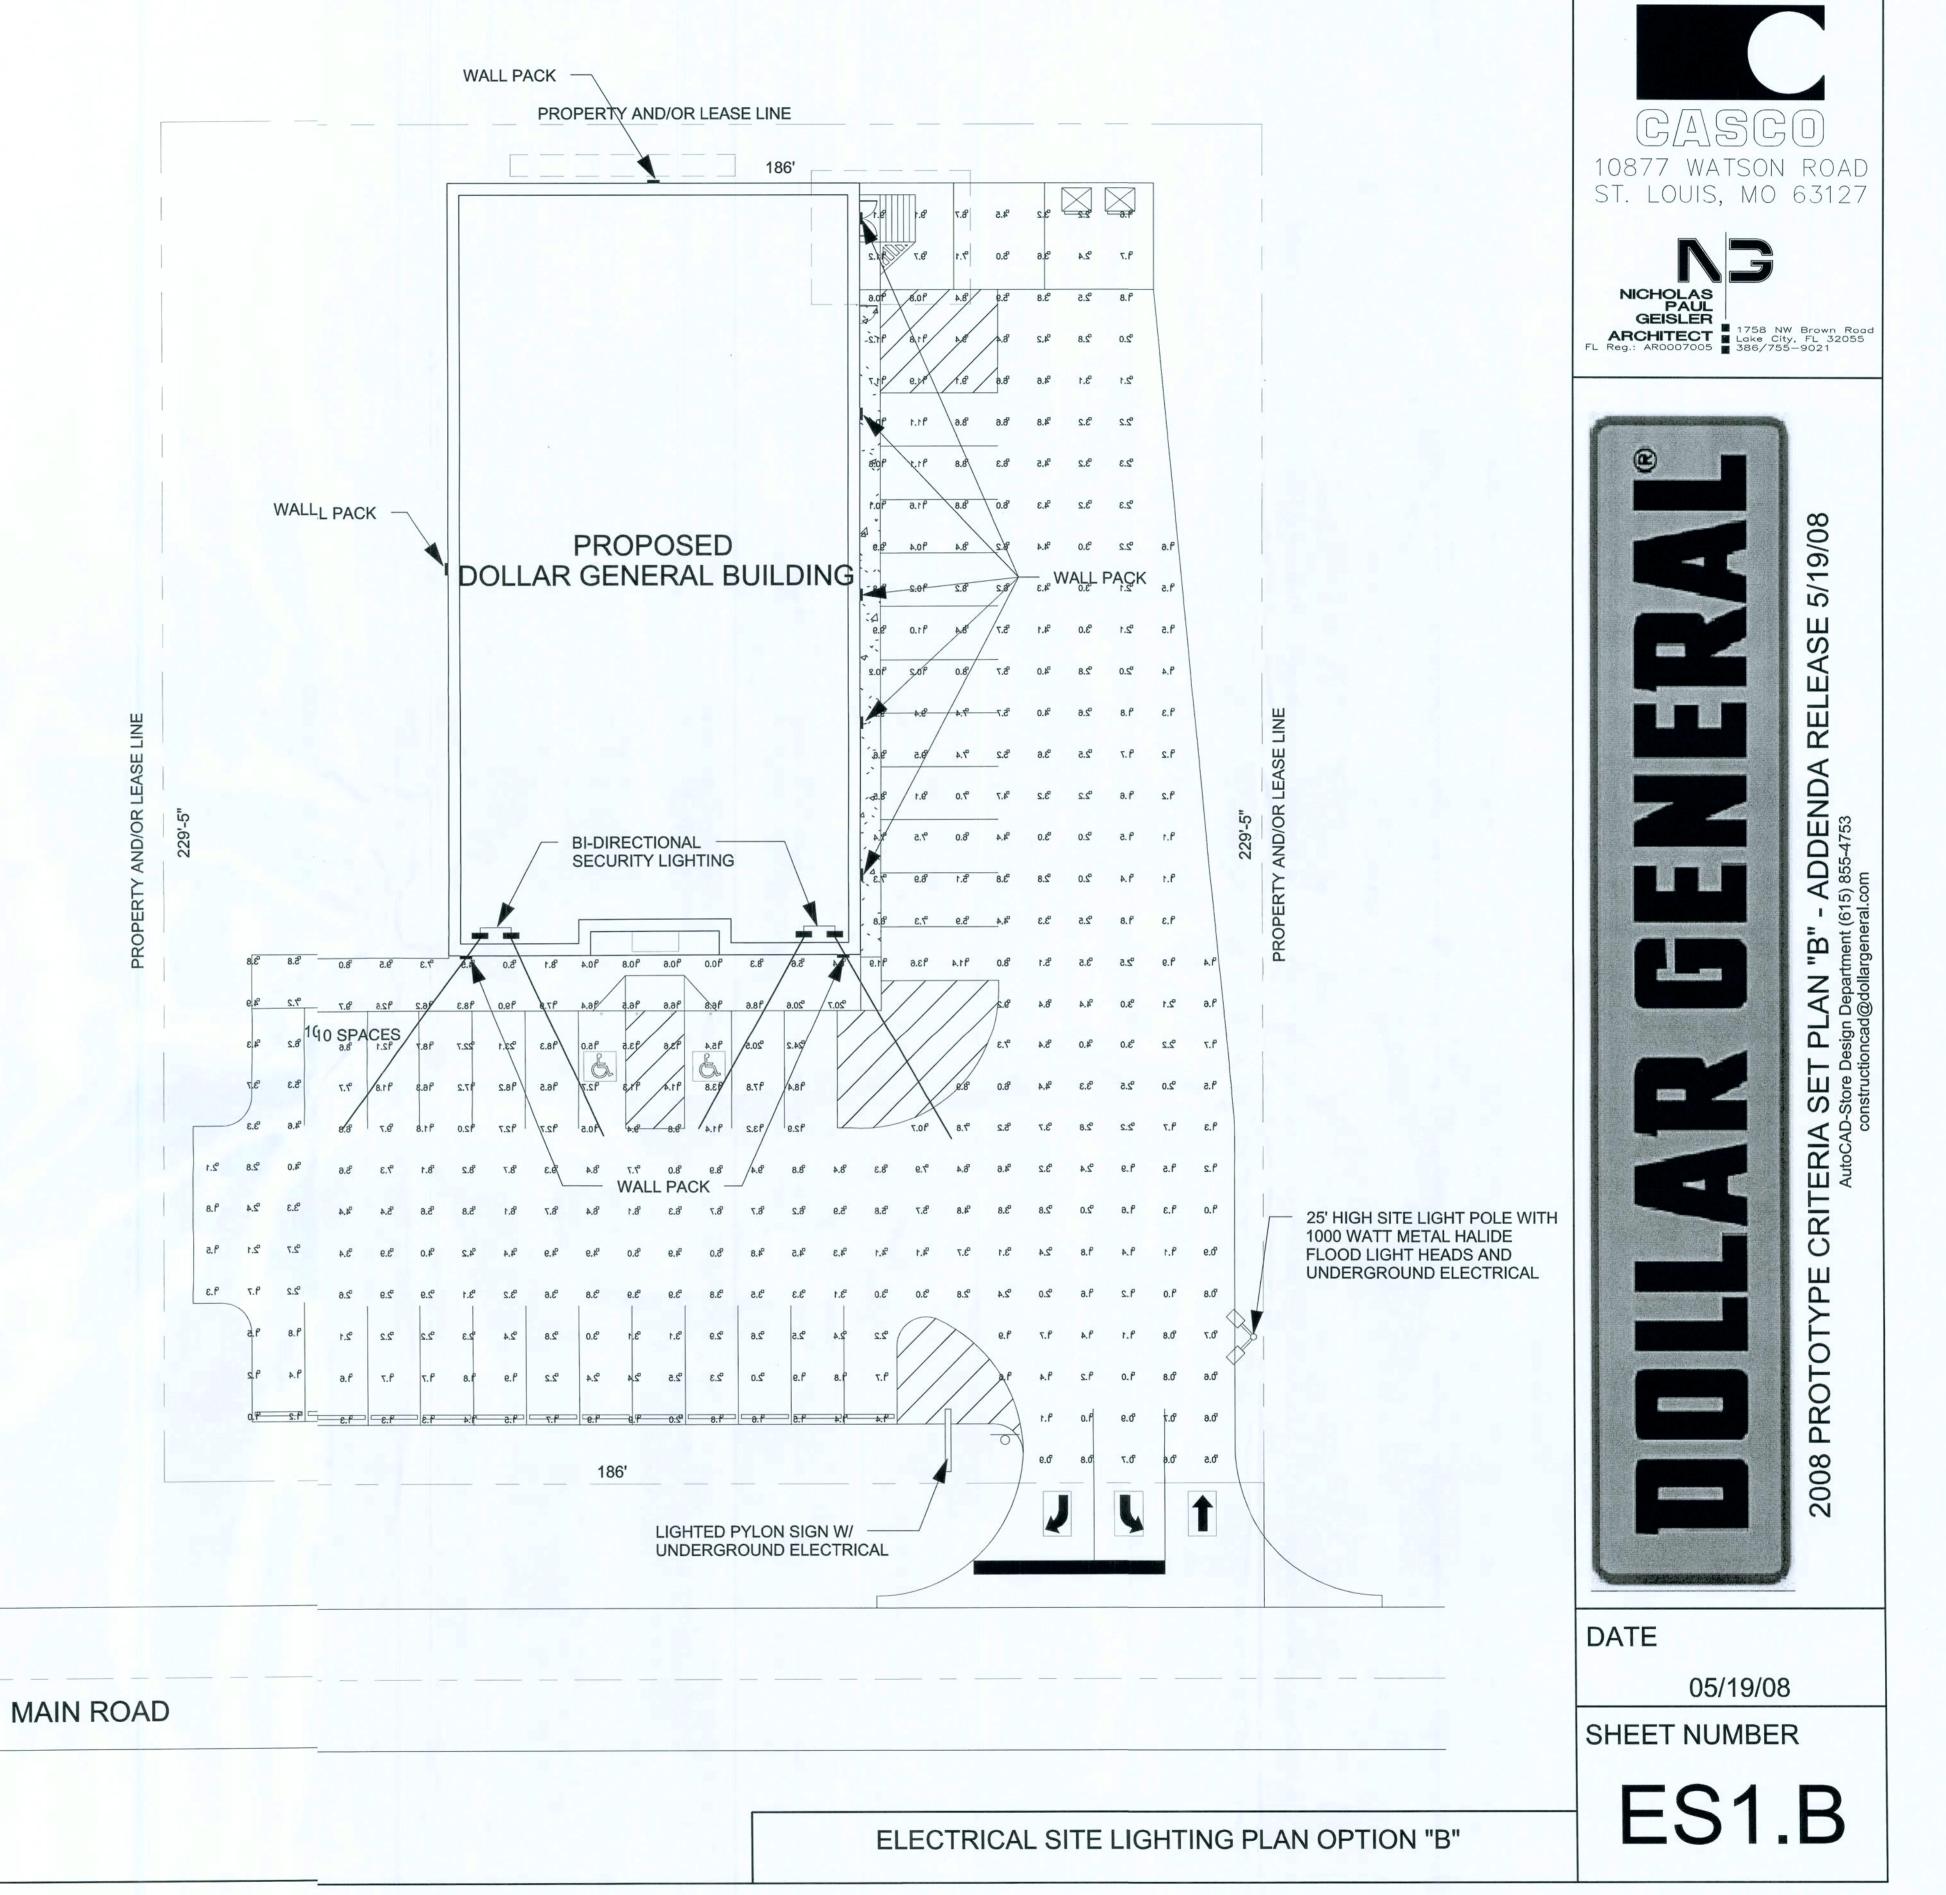

Manion &

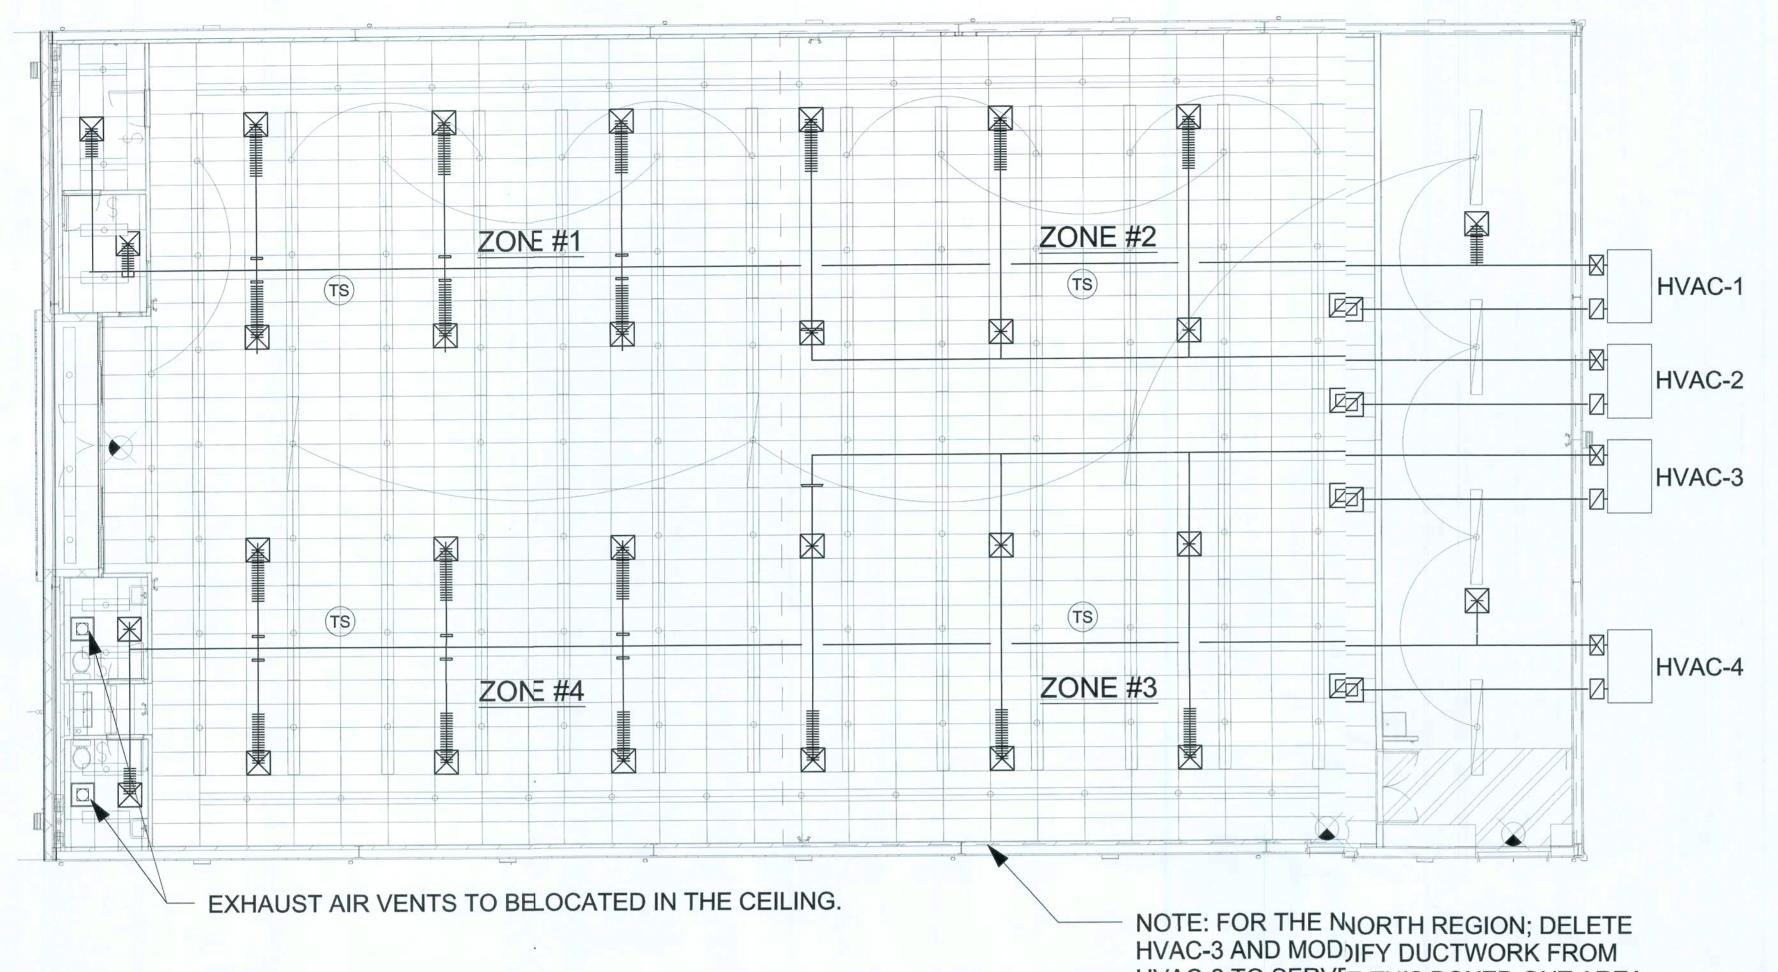

HVAC-2.

HVAC SPECIFICATIONS

SALES FLOOR, OFFICES, REST ROOM, AND STOCKROOM AREAS.

2. ALL DUCTWORK MUST BE ABOVE 10'-6" A.F.F.

3. FOR HVAC SENSOR LOCATIONS SEE EMS1.B SHEET

4. CARRIER AND/OR YORK PACKAGED H.V.A.C. SYSTEMS ARE REQUIRED.

5. PROVIDE INLINE EXHAUST FAN FOR RESTROOM AREAS, INTERLOCK W/ RESTROOM LIGHTS.

6. UNITS SHALL BE PLACED UPON ADEQUATE SIZED, ELEVATED

SYMBOL LEGEND:

EXHAUST FAN

SUPPLY AIR GRILL

RETURN AIR GRILL

TEMPERATURE SENSOR

	REC	Breake		
MFG	TONAGE	Gas Input	MODEL NUMBER	Size
CARRIER	(3) 5 Ton	High Gas	48TCFA06A1A3A0A0A0A1-DG	60
LENNOX	(4) 5 Ton	Low Gas	KGA060S4B-DG	70
LENNOX	(4) 5 Ton	Electric	KCA060S4B-DG	80

NOTE: ELEC. UNITS REQUIRE A SINGLE POINT KIT AND 10 KW HEAT STRIP. ALL UNITS REQUIRE MANUAL OR ECONOMIZER DAMPERS.

LENNOX NATIONAL ACCOUNTS - JOSHUA PLUMMER - PHONE# 800-367-6285 OPT. 2

HVAC LAYOUT & SCHEDULE OPTION "B"








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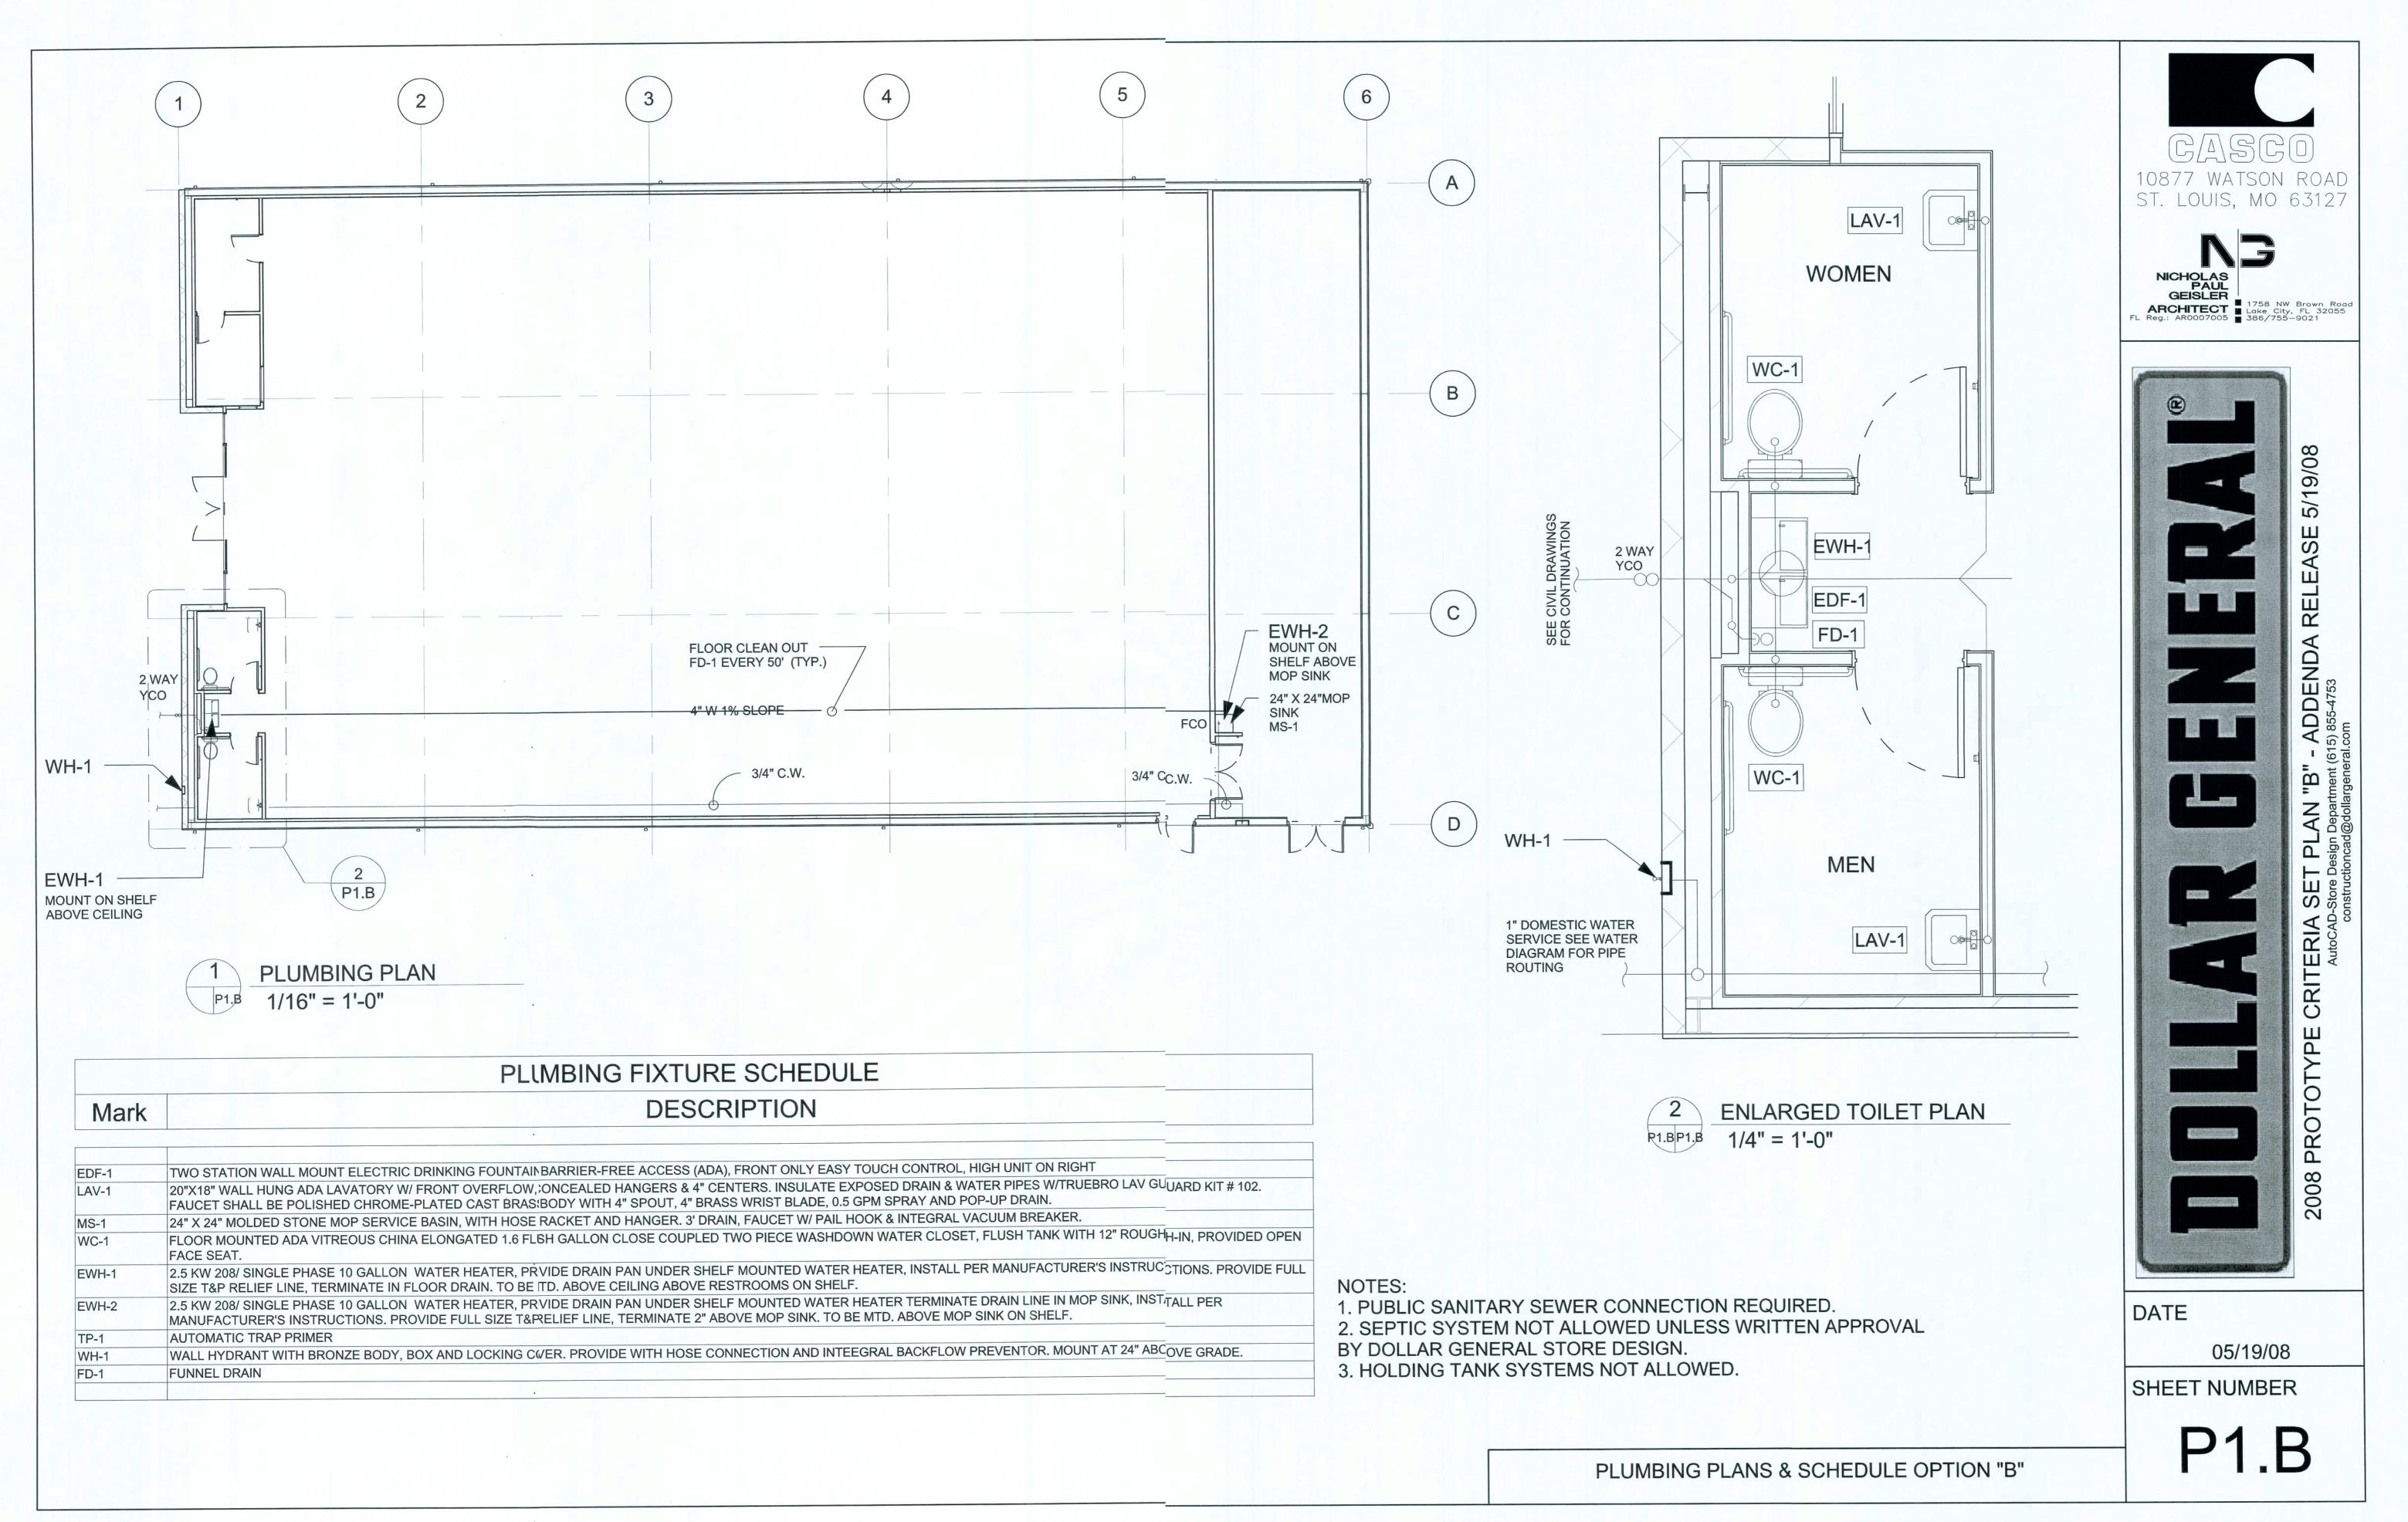
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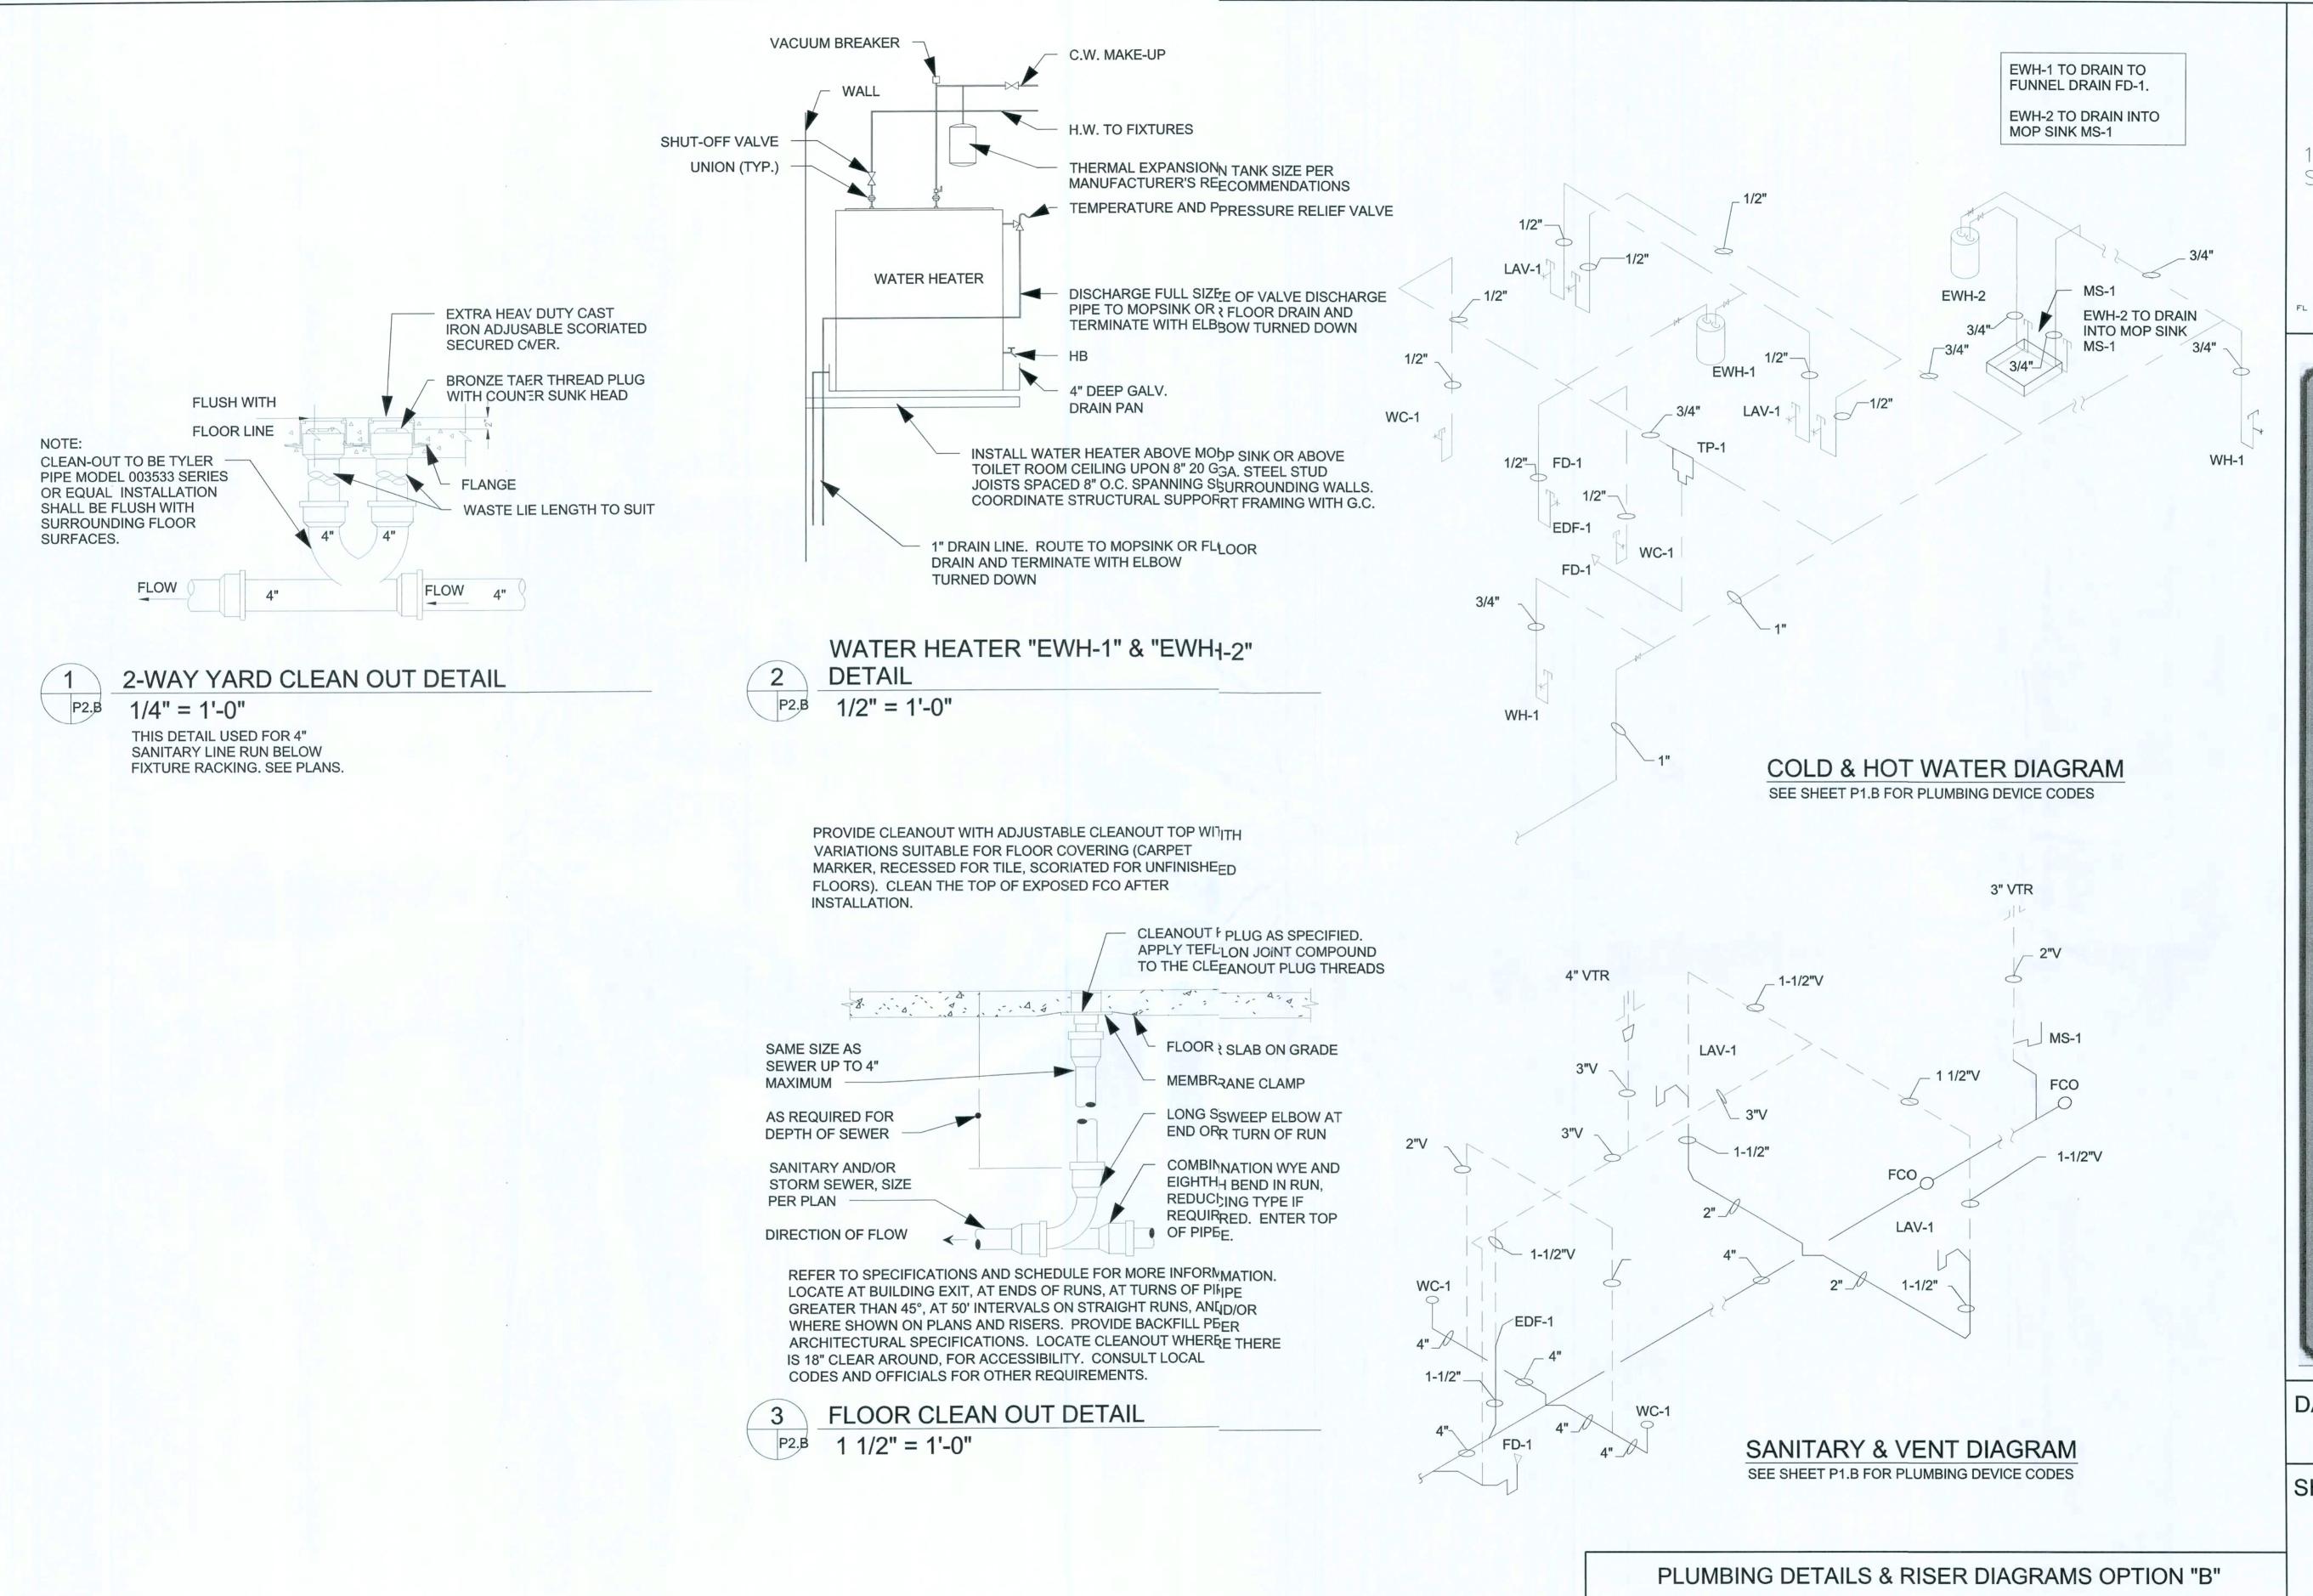


LENNOX LENNOX **LENNOX**

> NOTE: PROPANE IS NOT ALLOWED AS A SUBSTITUTE FOR GAS OR ELECTRIC SERVICE UNLESS APPROVED BY DG AUTOCAD STORE DESIGN. IF PROPANE IS USED, TANKS ARE REQUIRED TO BE BURIED.

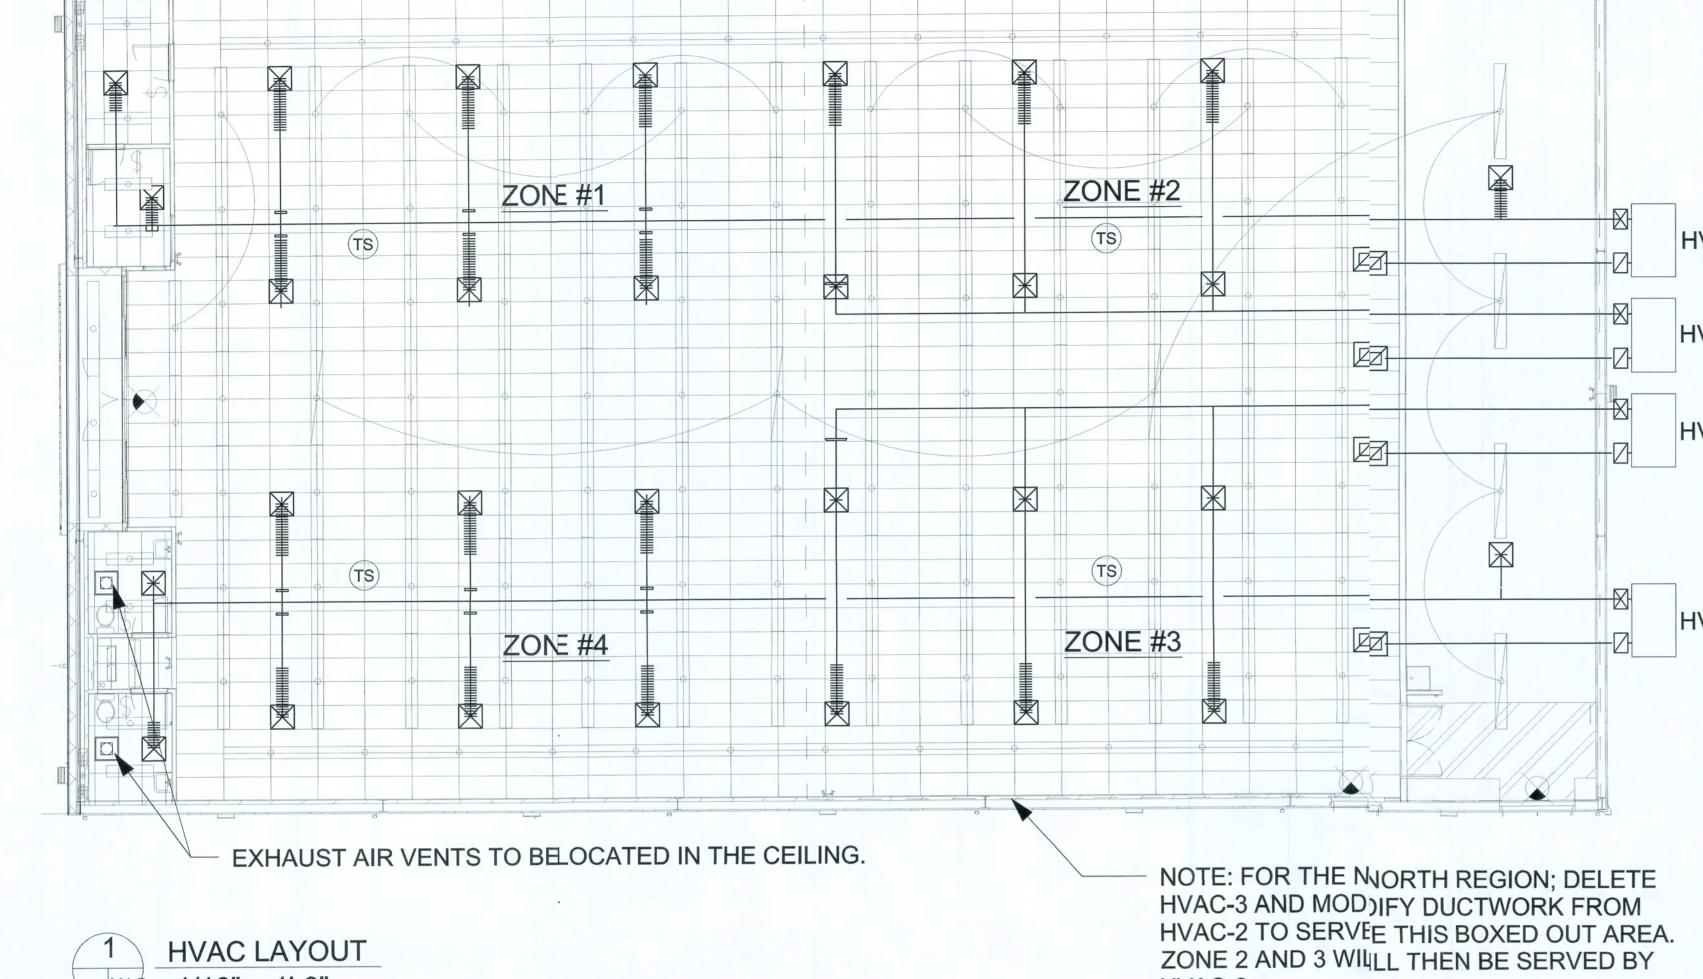

16 dm 249





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