
ARRAY DESCRIPTION						
ROOF	# OF MODULES	AZIMUTH	TILT	TRUSS SIZE	TRUSS SPACING	ROOF MATERIAL
#1	14	90	7/12 (30.26°)	2X4	24"O.C.	COMP SHINGLE
#2	5	180	8/12 (33.69°)	2X4	24"O.C.	COMP SHINGLE



DESIGN SPECIFICATION				
RISK CATEGORY	II			
CONSTRUCTION	SFD			
ZONING	RESIDENTIAL			
SNOW LOAD (ASCE 7-16)	0 PSF			
EXPOSURE CATEGORY	В			
WIND SPEED (ASCE 7-16)	120 MPH			

FRONT OF RESIDENCE

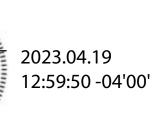


TATE OF TATE O THIS ITEM HAS BEEN DIGITALLY SIGNED AND SEALED BY OMAR TIRADO ON THE DATE ADJACENT TO THE SEAL. PRINTED COPIES OF THIS DOCUMENT ARE NOT VCONSIDERED SIGNED AND SEAL, AND THE SIGNATURE MUST BE VERIFIED ON ANY ELECTRONIC COPIES

- ROOF'S GENERAL NOTES
  CONTRACTOR/INSTALLER TO VERIFY ROOF CONDITIONS FOR PROPER INSTALLATION OF THE PV SYSTEM.
- CONTRACTOR/INSTALLER TO NOTIFY THE OWNER IMMEDIATELY OF ANY ROOF DEFICIENCIES AND/OR REPAIR REQUIRED TO INSTALL THE PV SYSTEM. EOR DOES NOT ASSUME ANY RESPONSIBILITY FOR THE INSTALLATION OF
- ANY PV SYSTEM ON DEFICIENT ROOFS.
  CONTRACTOR/INSTALLER ASSUMES ALL RESPONSIBILITY TO INSTALL AS PER MANUFACTURER STANDARDS.

ROOF INSPECTION NOTES
PV MODULES IN LAYOUTS IS CONSIDERED NON-EXPOSED AFTER COMPLYING WITH THE FOLLOWING STATEMENTS BASED ON ASCE 7-16:

- 1. NO INDIVIDUAL PV MODULE IS MORE THAN 0.5 (MEAN ROOF HEIGHT) AWAY
- FROM ROOF EDGE OR ANOTHER MODULE.
  2. NO INDIVIDUAL PV MODULE IS MORE THAN 4FT AWAY FROM ROOF EDGE OR ANOTHER MODULE.
- 3. INDIVIDUAL PV MODULE IS MORE THAN 1.5 (MODULE LENGTH) AWAY FROM CLOSEST EXPOSED EDGE.

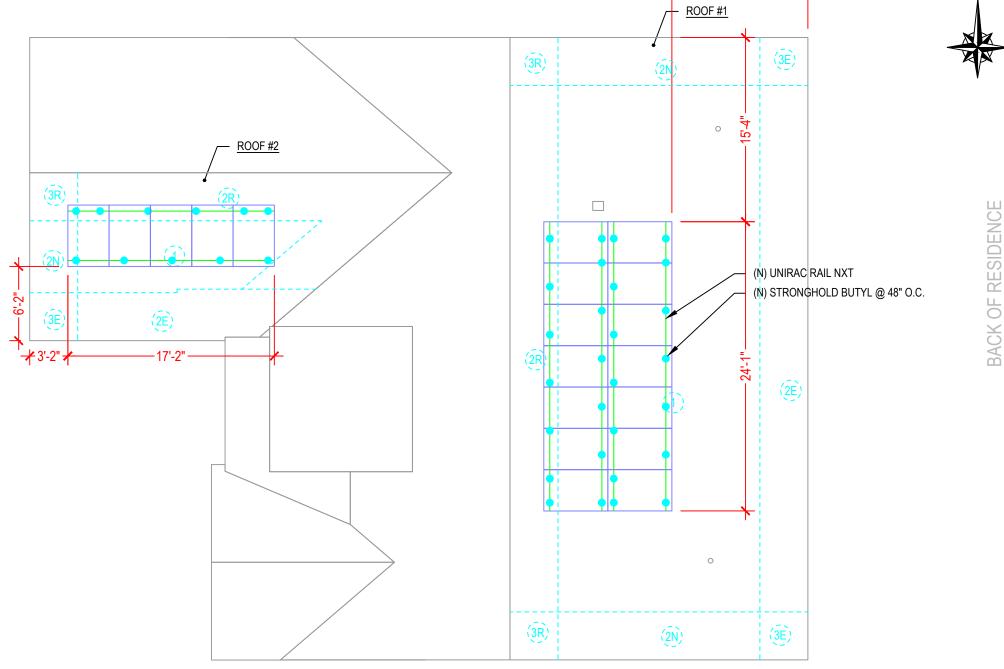

**LEGEND** 

(E) - EXISTING (N) - NEW

ROOF PLAN AND MODULES

S-0

SCALE: NTS

ATLANTIC KEY ENERGY LLC 12600 CHALLENGER PARKWAY SUITE 200 ORLANDO, FL 32826 1 (407) 988-0273 PROJECT # P-0074750 123 NW NOVEMBER CT LAKE CITY, FL 32055 NANCY TURNER RESIDENCE SIGNATURE WITH SEAL REVISIONS DESCRIPTION DATE REV

4/18/2023

SHEET NAME

**ROOF PLAN AND** 

**MODULES** 

SHEET NUMBER

S-0

# **STRONGHOLD**\*| BUTYL



## Unirac's STRONGHOLD' Butyl is efficient, dependable, and optimized for UNIRAC's NXT UMOUNT' system.

The pre-applied butyl pad removes the need for additional flashing. Just peel the liner, place the attachment, and tasten it to the roof. In addition, the butyl, used throughout the roofing and solar industries for its reliability, conforms to the screws and roof for a robust, dependable seal with no extra work! Couple this with the NXT UMOUNT" system, and you have a highly reliable, easy-to-install system with integrated wire management.




### KITTED WIT


 ONE (1) STRONGHOLD' Butyl direct-to-deck attachment with pre-applied butyl patch (Extra patches for shimming available.) TWO (2) screws for rafter installation (Additional screws for direct-to-deck applications available.)


installation • ONE (1) NXT Rail Clamp ct-to-deck

FOR QUESTIONS OR CUSTOMER SERVICE CONTACT: 505-242-6411 | SALES@UNIRAC.COM | WWW.UNIRAC.COM

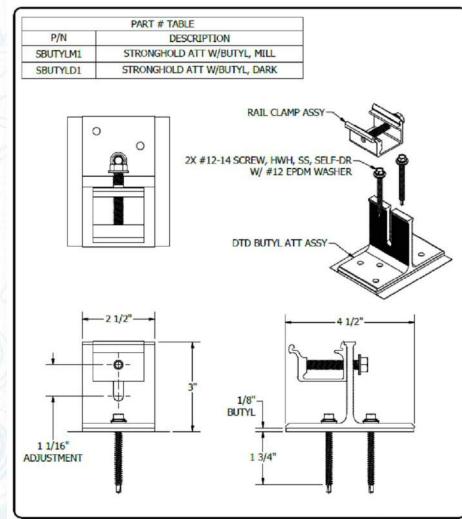

P/N	DESCRIPTION	LENGTH
084RLM1	NXT UMOUNT RAIL 84" MILL	84"
084RLD1	NXT UMOUNT RAIL 84" DARK	84"
168RLM1	NXT UMOUNT RAIL 168" MILL	168"
168RLD1	NXT UMOUNT RAIL 168" DARK	168"
208RLM1	NXT UMOUNT RAIL 208" MILL	208"
208RLD1	NXT UMOUNT RAIL 208" DARK	208"
246RLM1	NXT UMOUNT RAIL 246" MILL	246"
246RLD1	NXT UMOUNT RAIL 246" DARK	246"
171RLM1	NXT UMOUNT RAIL 171" MILL	171.50"
171RLD1	NXT UMOUNT RAIL 171" DARK	171.50"

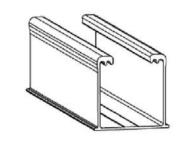

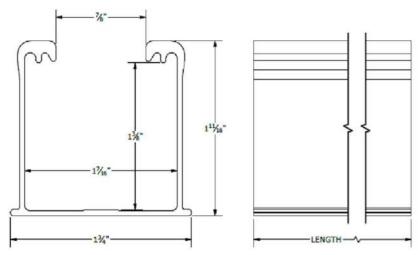

1411 BROADWAY BLVD, NE ALBUQUERQUE, NM 87102 USA PHONE: 505.242.6411 WWW.UNIRAC.COM	PRODUCT LINE:	NXT UMOUNT	DRAWING NOT TO SCALE ALL DIMENSIONS ARE	-A10
	DRAWING TYPE:	PARTS	NOMINAL	
	DESCRIPTION:	SH BUTYL ATTACHMENT	PRODUCT PROTECTED BY ONE OR MORE US PATENTS	N
	REVISION DATE:	2/3/2023	LEGAL NOTICE	SHEET

1411 BROADWAY BLVD. NE ALBUQUERQUE, NM 87102 USA PHONE: 505.242.6411 WWW.UNIRAC.COM

PRODUCT LINE:	NXT UMOUNT	$\overline{\gamma}$
DRAWING TYPE:	PART DETAIL	
DESCRIPTION:	RAIL	$\Box$
REVISION DATE:	11/17/2022	$\mathbb{I}$

DRAWING NOT TO SCALE
ALL DIMENSIONS ARE
NOMINAL
PRODUCT PROTECTED BY
ONE OR MORE US PATENTS

LEGAL NOTICE

Date: SHEET NAME

EQUIPMENT SPECIFICATIONS

SHEET NUMBER

S-1

ATLANTIC KEY ENERGY LLC 12600 CHALLENGER PARKWAY SUITE 200 ORLANDO, FL 32826 1 (407) 988-0273 PROJECT # P-0074750 123 NW NOVEMBER CT LAKE CITY, FL 32055 NANCY TURNER RESIDENCE SIGNATURE WITH SEAL NU-P01 REVISIONS DESCRIPTION DATE REV SHEET 4/18/2023