


工 3

3/21/05 W.H.F. REVISIONS SHEET A-5

DRAWN BY

PROJECT NO.

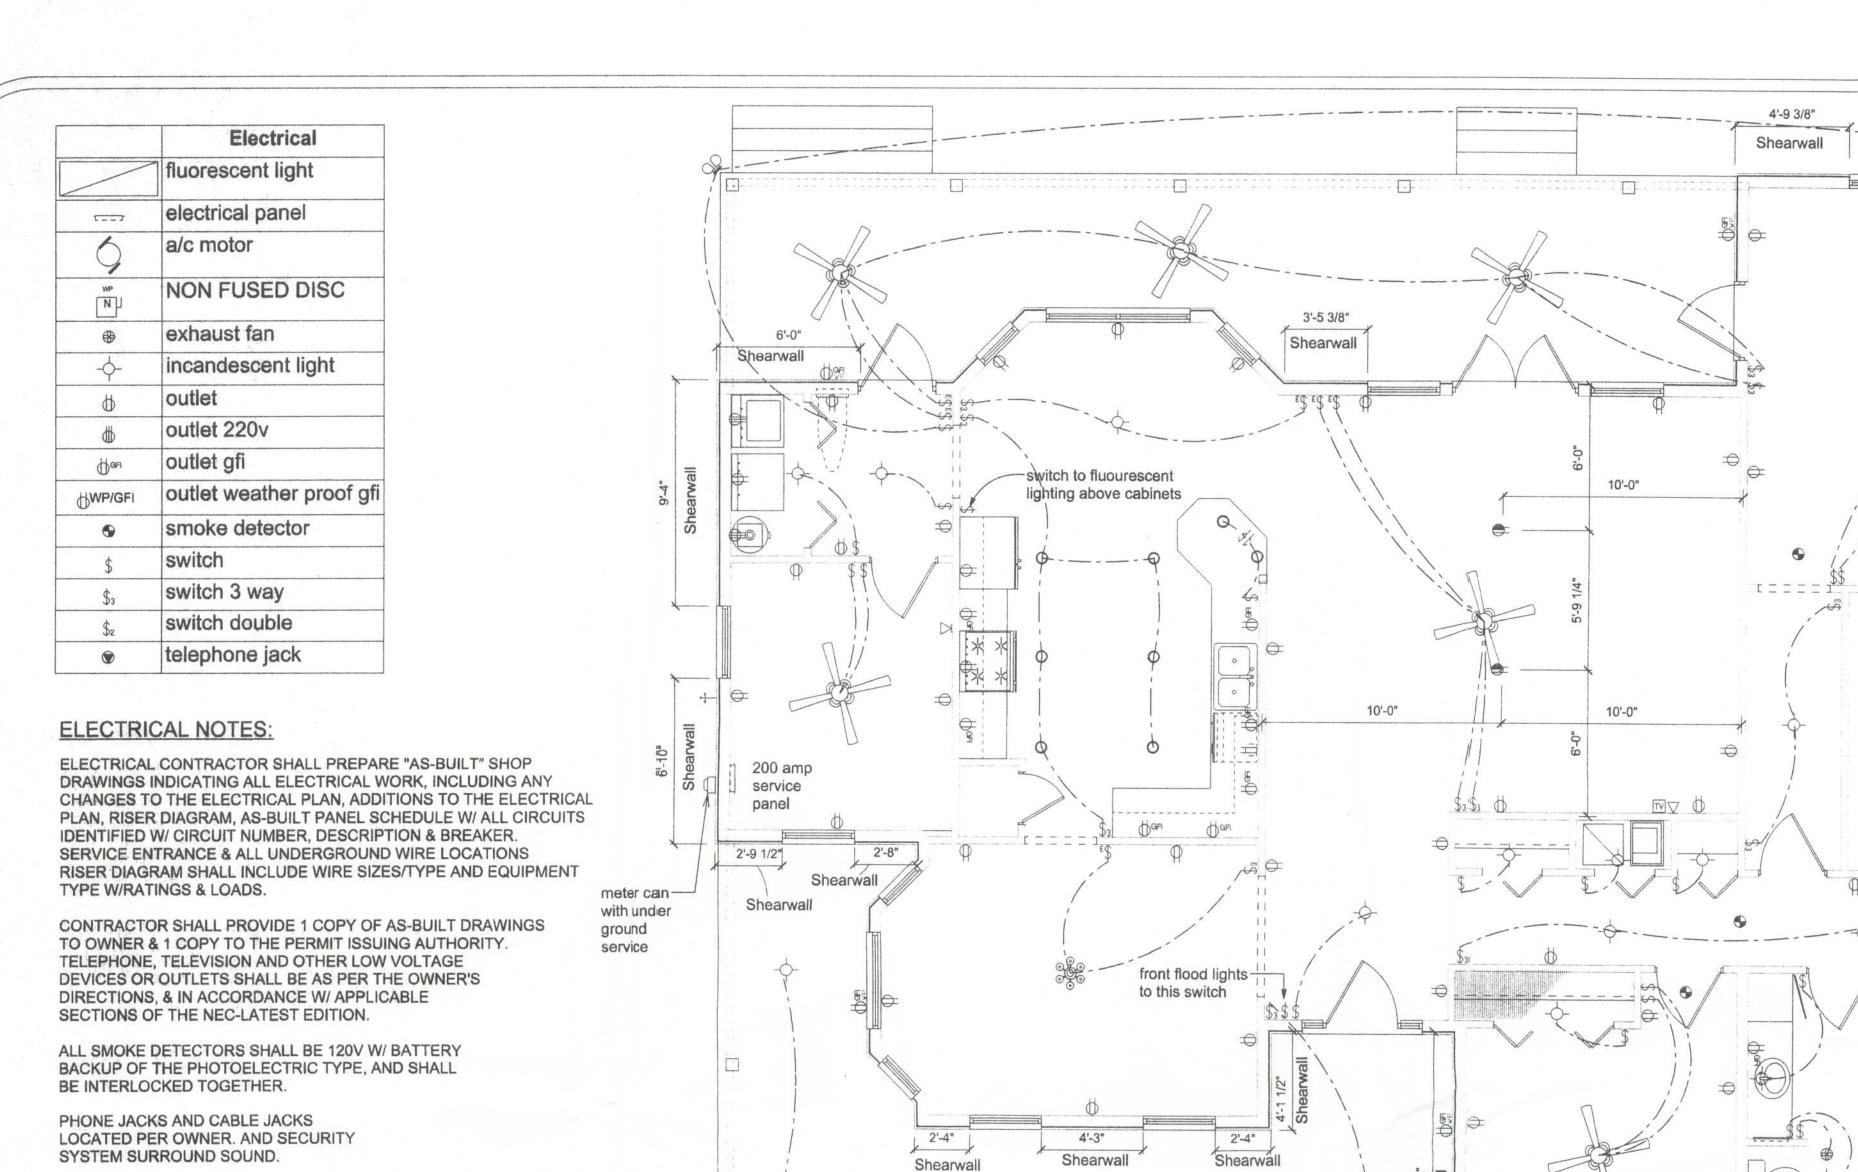

SIMPSON SPH4 @ 48" O.C.

HEADER

-JACK STUDS

MAX. CLEAR

OPENING WIDTH

SHEARWALI

SHEARWALL DETAILS

SCALE: 1/2" = 1'-0"

SEGMENT

SIMPSON SPH4 @ 48" O.C.

ROOF TRUSSES

-HEADER HOLD DOWN ANCHOR

-1/2" DIA. ANCHOR BOLTS

-HOLD DOWN ANCHOR

WASHER, TYPICAL

FOUNDATION

W/ 2"x2"x 1/8" STEEL PLATE

SEE PLAN

TWO KING STUDS MIN.

NOTE:

ALL BRANCH CIRCUITS THAT SUPPLY 125-VOLT, SINGLE PHASE, 15 AND 20 AMP OUTLETS INSTALLED IN DWELLING UNIT BEDROOMS SHALL BE PROTECTED BY AN ARC FAULT CIRCUIT INTERRUPTER LISTED TO PROVIDE PROTECTION OF THE ENTIRE BRANCH CIRCUIT.

ROOF TRUSS ANCHORAGE-

DOUBLE

CORNER

IN SHEATHING

EDGE OR FLAT

(2) 16d TOE NAILS

EACH END, EACH

P.T. BOTTOM PLATE-

PIECE, TYPICAL

TOP PLATE-

END OF SHEARWALL

SEGEMENT BUILDING

BLOCKING @ JOINTS-

ELECTRICAL PLAN

SCALE: 1/4" = 1'-0"

- ALL SHEARWALLS SHALL BE TYPE 2 SHEARWALLS
- 3. ALL SHEATHING SHALL BE ATTACHED TO FRAMING ALONG ALL FOUR EDGES WITH JOINTS FOR ADJACENT
- OR ALONG BLOCKING.
- 12" O.C. IN THE FIELD.
- 5. TYPE 2 SHEARWALLS ARE DESIGNED FOR THE OPENING IT CONTAINS. MAXIMUM HEIGHT OF OPENING SHALL BE 5/6 TIMES THE WALL HEIGHT. THE MINIMUM DISTANCE BETWEEN OPENINGS SHALL BE THE WALL HEIGHT/3.5 ie. FOR 8'-0" WALLS - (2'-3").

OPENING WIDTH	SILL PLATES	16d TOE NAILS EACH END	
UP TO 6'-0"	(1) 2x4 OR (1) 2x6	1	
> 6' TO 9'-0"	(3) 2x4 OR (1) 2x6	2	
> 9' TO 12'-0"	(5) 2x4 OR (2) 2x6	3	

SHEARWALL NOTES:

AS DEFINED BY STD 10-99 305.4.3.

2. THE WALL SHALL BE ENTIRELY SHEATHED WITH 7/16" O.S.B. INCLUDING AREAS ABOVE AND BELOW OPENINGS.

PANELS OCCURING OVER COMMON FRAMING MEMBERS

3'-2 1/2"

Shearwall

4. NAIL SPACING SHALL BE 6" O.C. EDGES AND

FIREBLOCKING NOTES:

Shearwall

attic access

⁺ 6'-9 1/2" Shearwall

3'-2 1/2"

Shearwall

FIREBLOCKING SHALL BE INSTALLED IN WOOD FRAME CONSTRUCTION IN THE FOLLOWING LOCATIONS:

- 1. IN CONCEALED SPACES OF STUD WALLS AND PARTITIONS INCLUDING FURRED SPACES AT CEILING AND FLOOR LEVELS.
- 2. AT ALL INTERCONNECTIONS BETWEEN CONCEALED VERTICAL AND HORIZONTAL SPACES SUCH AS OCCUR AT SOFFITS, DROP CEILINGS, COVE CEILINGS, ETC.
- 3. IN CONCEALED SPACES BETWEEN STAIR STRINGERS AT THE TOP AND BOTTOM OF THE RUN.
- 4. AT OPENINGS AROUND VENTS, PIPES, DUCTS, CHIMNEYS AND FIREPLACES AT CEILING AND FLOOR LEVELS WITH PYROPANEL MULTIFLEX SEALANT
- 5. AT ALL INTERCONNECTIONS BETWEEN CONCEALED VERTICAL STUD WALL OR PARTITION SPACES AND CONCEALED SPACES CREATED BY AN ASSEMBLY OF FLOOR JOISTS, FIREBLOCKING SHALL BE PROVIDED FOR THE FULL DEPTH OF THE JOISTS AT THE ENDS AND OVER THE SUPPORTS.

OPENING CONNECTION REQUIREMENTS					
CLEAR OPENING WIDTH	HEADER SIZE #2 GRADE OR BETTER	END BEARING	CONNECTOR AT EACH END OF OPENING	ANCHORAGE TO FOUNDATION @ EACH END OF OPENING	
0' - 3'	(2) 2x8	1.5"	SIMPSON H2.5	SIMPSON SPH4	
>3' - 6'	(2) 2x10	3"	(1) SIMPSON LSTA30	(2) SIMPSON SPH4	
>6' - 9'	(2) 2x12	3"	(1) SIMPSON LSTA30	(2) SIMPSON SPH4	
>9' - 12'	(2) 1 3/4" x 11 1/4" LVL - 2.0E	3"	(1) SIMPSON LSTA30	(2) SIMPSON SPH4	
>12' - 15'	(2) 1 3/4" x 11 1/4" LVL - 2.0E	3"	(2) SIMPSON LSTA30	SIMPSON HD5A	
>15' - 18'	(2) 1 3/4" x 11 1/4" LVL - 2.0E	3"	(2) SIMPSON LSTA30	SIMPSON HD5A	