

SCOPE




- ## DAMAGE ASSESSMENT



- ## ADDITIONAL NOTES

1. THE GENERAL CONTRACTOR IS RESPONSIBLE FOR ALL TEMPORARY SHORING AND BRACING. CONSTRUCTION MEANS AND METHODS ARE THE SOLE RESPONSIBILITY OF THE GENERAL CONTRACTOR.
2. THE GENERAL CONTRACTOR IS RESPONSIBLE FOR ALL OTHER REPAIRS TO THE SUBJECT PROPERTY OTHER THAN THE STRUCTURAL REPAIRS ADDRESSED IN THIS PLAN; INCLUDING, BUT NOT LIMITED TO: WATERPROOFING, CLADDING, FENESTRATIONS, APPLIANCES, ELECTRICAL, PLUMBING, AND MECHANICAL COMPONENTS.
3. ALL DIMENSIONS ARE APPROXIMATE. CONTRACTOR TO FIELD VERIFY ALL DIMENSIONS AND MATCH EXISTING.
4. IF ADDITIONAL STRUCTURAL DAMAGES ARE FOUND, -STOP- AND CONTACT IFG FOR ADDITIONAL REVIEW.

SYMBOL

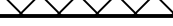TYPE


	2 x FRAMED BEARING WALL (EXTERIOR). WIDTH MAY NOT BE SHOWN TO SCALE AS SITE MEASUREMENTS MAY INCLUDE EXTERIOR CLADDING.
	2 x FRAMED BEARING WALL (INTERIOR).
	NON BEARING INTERIOR WALL.

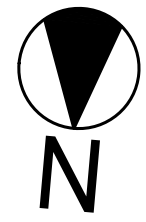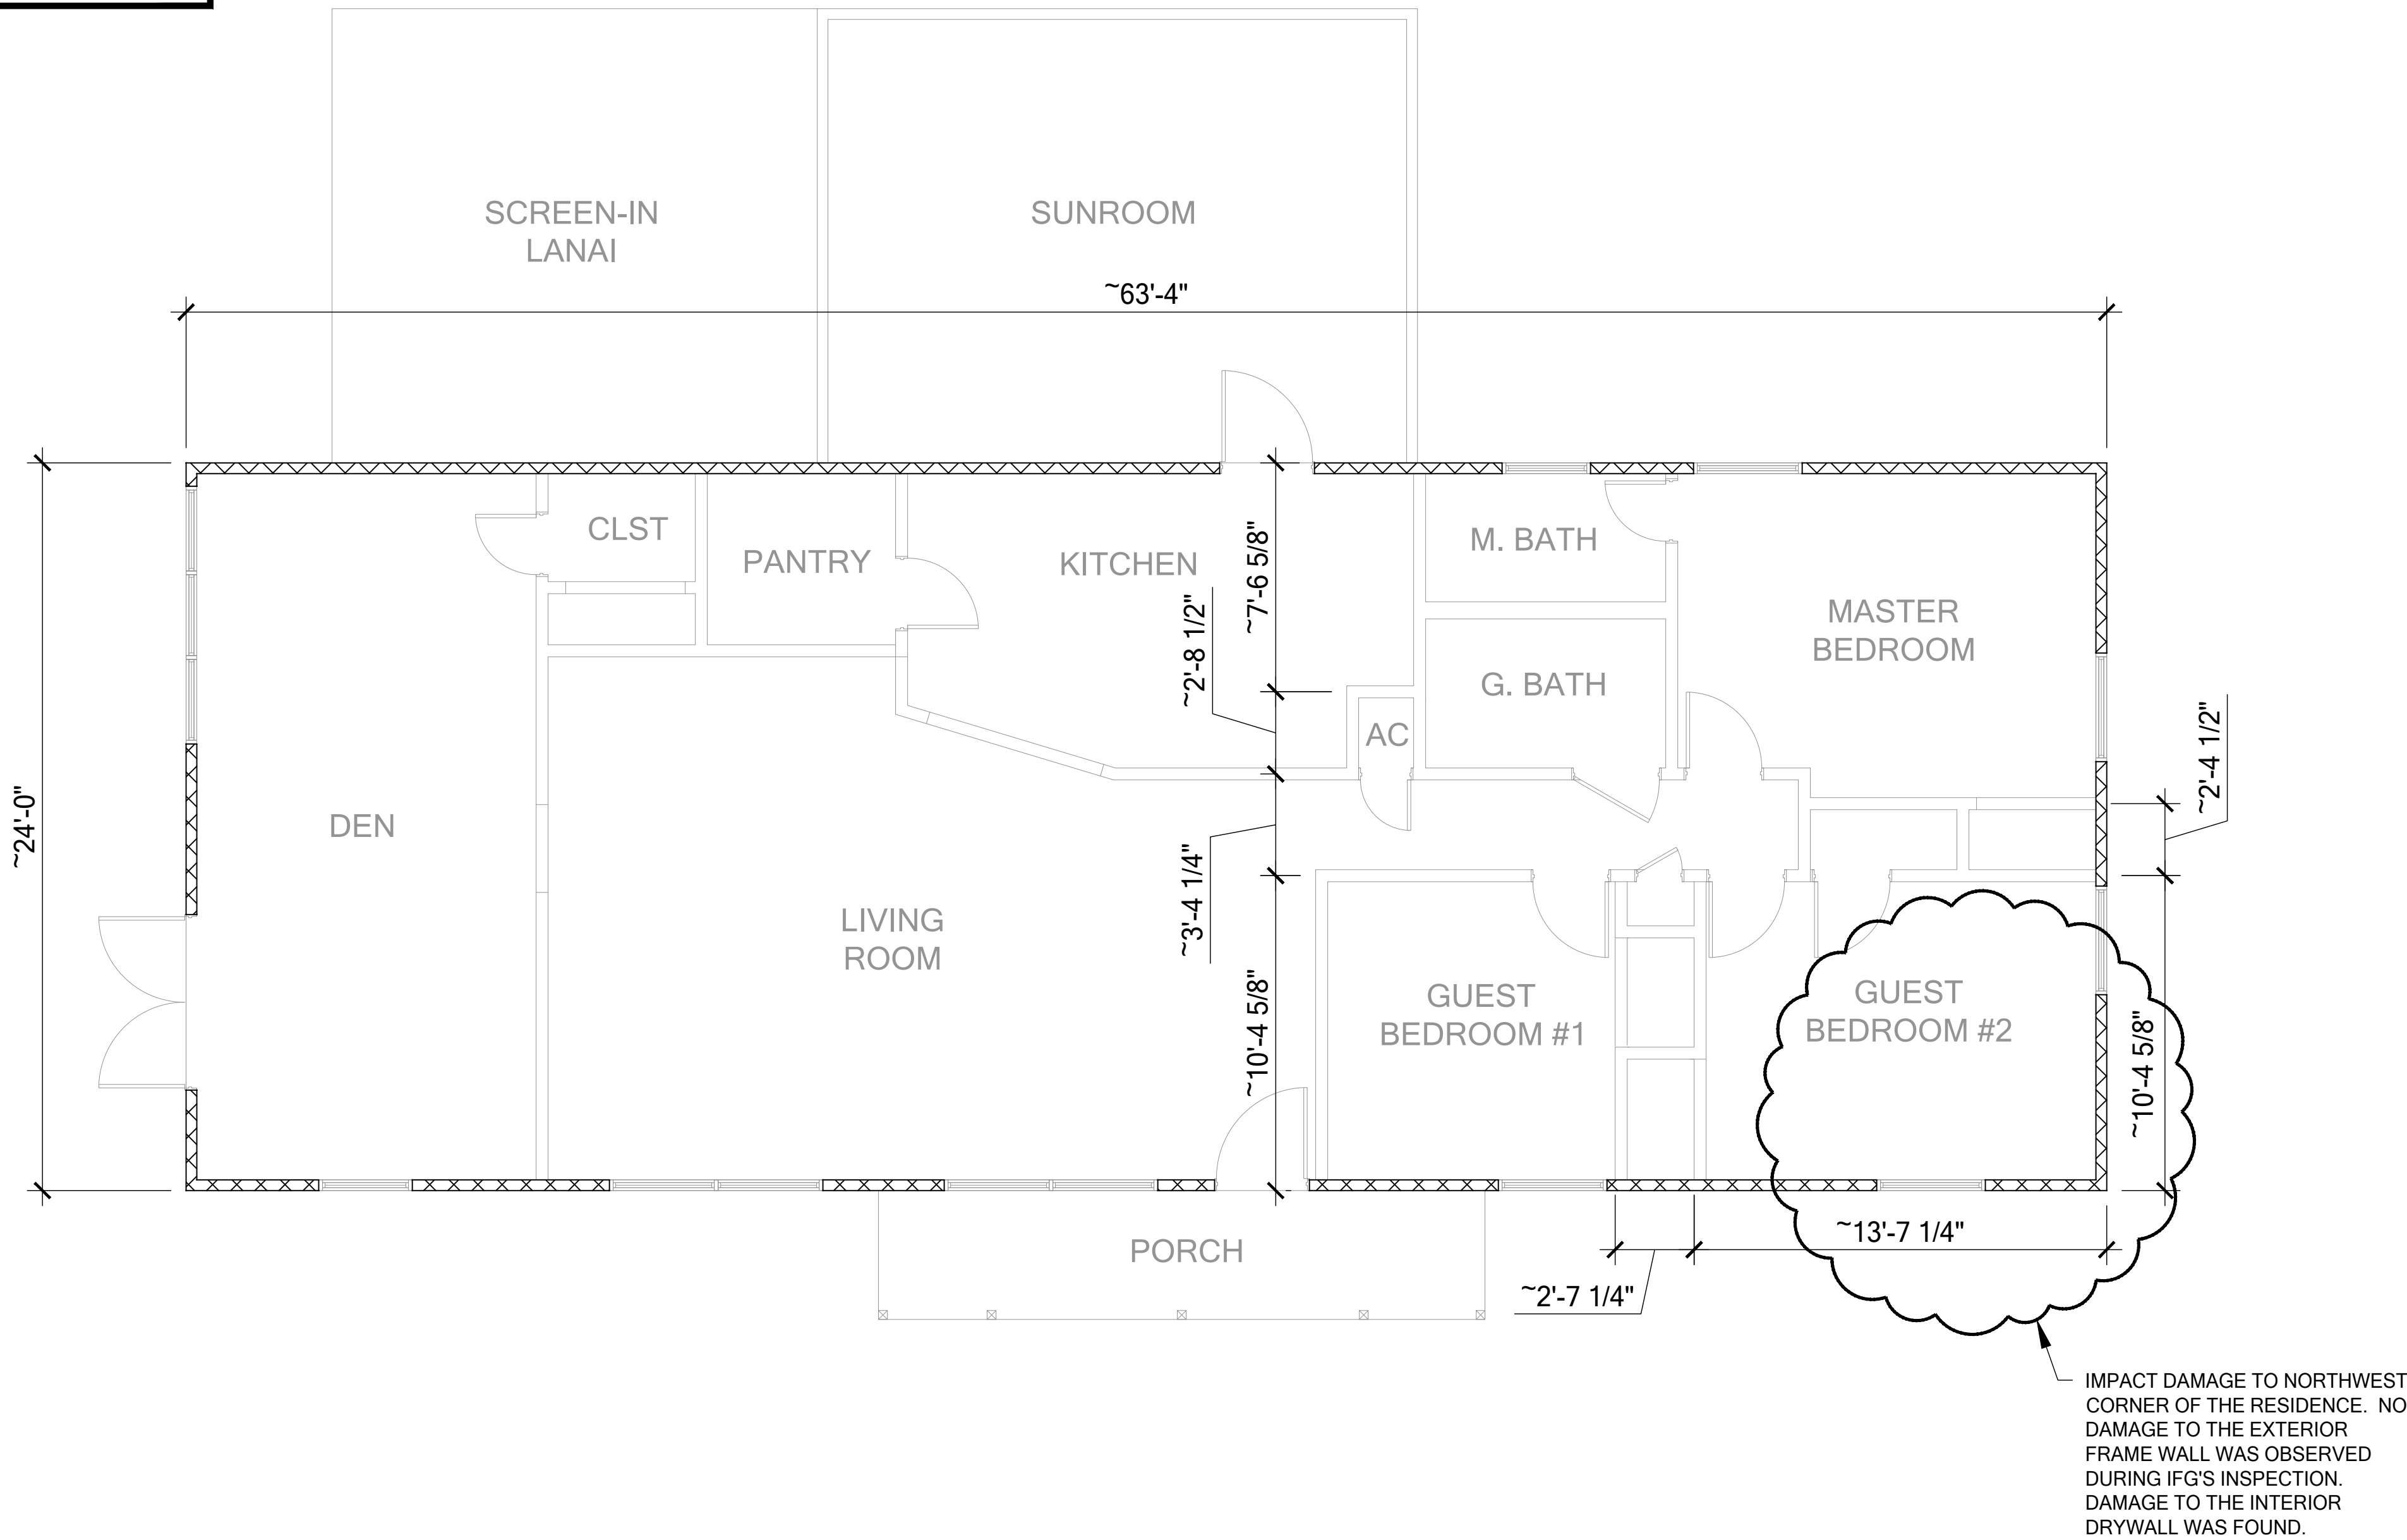

EXISTING FLOOR PLAN

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ENGINEER:

ENGINEER:
RYAN M. GISSAL, P.E.
PE #: 78615

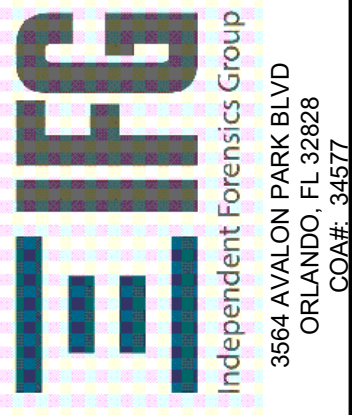DATE: REFERENCE DIGITAL
SIGNATURE

PROJECT:

GARDE RESIDENCE
2094 NW THUNDER STREET
WHITE SPRINGS, FLORIDA 32096
IFG#: IFG240292

PLAN HISTORY

[illegible]

SHEET DATA:

ENGINEERED BY: RMG

DRAWN BY: RMG

SHEET DESCRIP:

DAMAGE ASSESSMENT - FLOOR LAYOUT

SHEET

\$1.0



SCOPE

- ## DAMAGE ASSESSMENT

- ## ADDITIONAL NOTES

- ## MAIN FLOOR WALL TYPE

EXISTING ROOF PLAN

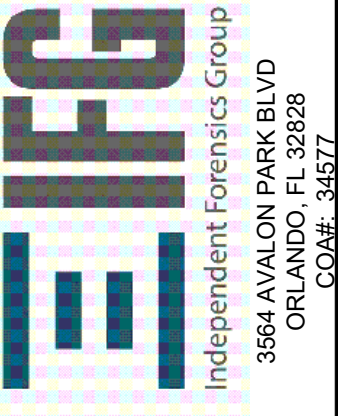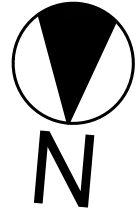

ENGINEER:

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WHITE SPRINGS, FLORIDA 32096
IFG#: IFG240292

PLAN HISTORY

[illegible]

SHEET DATA:

ENGINEERED BY: RMG

DRAWN BY: RMG

SHEET DESCRIP:

DAMAGE ASSESSMENT
- ROOF LAYOUT

SHEET

S2.0

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BEARING WALL LEGEND

HEADER LEGEND

BEARING CONNECTOR SCHEDULE					
MARK	CONNECTION & FASTENERS		STUD SPACING	LUMBER SPECIES	UPLIFT CAP. [plf]
	TOP	BOTTOM			
A	(2) 16d TOENAILS	(2) 16d TOENAILS	12"	SPF	NO UPLIFT
				SYP	NO UPLIFT
			16"	SPF	NO UPLIFT
				SYP	NO UPLIFT
B	(1) SIMPSON SP2 W/ (6)-10d NAILS	(1) SIMPSON SP1W/ (6)-10d NAILS	12"	SPF	535
				SYP	585
			16"	SPF	402
				SYP	439
C	SIMPSON SP4 W/ (12)-10d x 1-1/2" NAILS	SIMPSON SP4 W/ (12)-10d x 1-1/2" NAILS	12"	SPF	1030
				SYP	1200
			16"	SPF	770
				SYP	900

MARK	HEADER SIZE & GRADE	MARK	HEADER SIZE & GRADE
A	2x6 #2 SYP	E	1½ x 11½ LVL 2.0E Fb=2950
B	2x8 #2 SYP	F	1½ x 11½ LVL 2.0E Fb=2950
C	2x10 #2 SYP	G	1½ x 16 LVL 2.0E Fb=2950
D	2x12 #2 SYP	H	

HEADER SUPPORT NO. OF JACKS & STUDS REQ. AT OPENINGS


OPENING SIZE	2x4 WALL		2x6 OR 2x8 WALL	
	JACKS EA END	KINGS EA END	JACKS EA END	KINGS EA END
1'-0" - 3'-11"	(2)	(1)	(2)	(1)
4'-0" - 10'-5"	(2)	(2)	(2)	(2)
10'-6" - 16'-0"	(3)	(4)	(3)	(4)

GENERAL BEARING WALL NOTES

- SEE FLOOR PLAN FOR WALL SIZE, ASSUME 2x4 STUDS USED UNO.
- ALL STRUCTURAL LUMBER TO BE SYP #2 OR SPF UNO ON PLAN.
- CONNECTIONS TO BE INSTALLED TO EACH STUD AS INDICATED
- CONTACT E.O.R. IF SP4'S, SP6'S OR SP8'S CONNECTORS ARE SUBSTITUTED. TO VERIFY THEY MEET THE STRUCTURAL REQUIREMENTS.

GENERAL HEADER NOTES


- VERIFY W/ PLAN CORRECT LENGTH OF HEADER REQUIRED
- IF HEADER IS ON THE 1ST FLOOR SEE PLAN FOR BEARING WALL TYPE AND FOLLOW DOWN INSTRUCTIONS WITHIN BEARING WALL SCHEDULE FOR REQUIRED CORRECTIONS UNO ON PLAN.
- IF HEADER IS ON THE 2ND FLOOR SEE PLAN FOR INDICATED HEADER CONNECTION FOR REQUIRED CONNECTIONS.
- ALL HEADER JACK AND KING STUDS SHALL BE FASTENED TO EACH PER DETAIL WF11.
- FASTEN ALL MULTI-PLY HEADERS TOGETHER W/2" ROWS 10d COMMON NAIL AT 6" ALONG EACH EDGE OR (3) ROWS IF 2x10 OR LARGER.
- FASTEN ALL HEADERS TO KING STUDS WITH (3) 10d TOENAILS PER SIDE.
- IF HEADER IS NOT SPECIFIED CONTACT E.O.R.

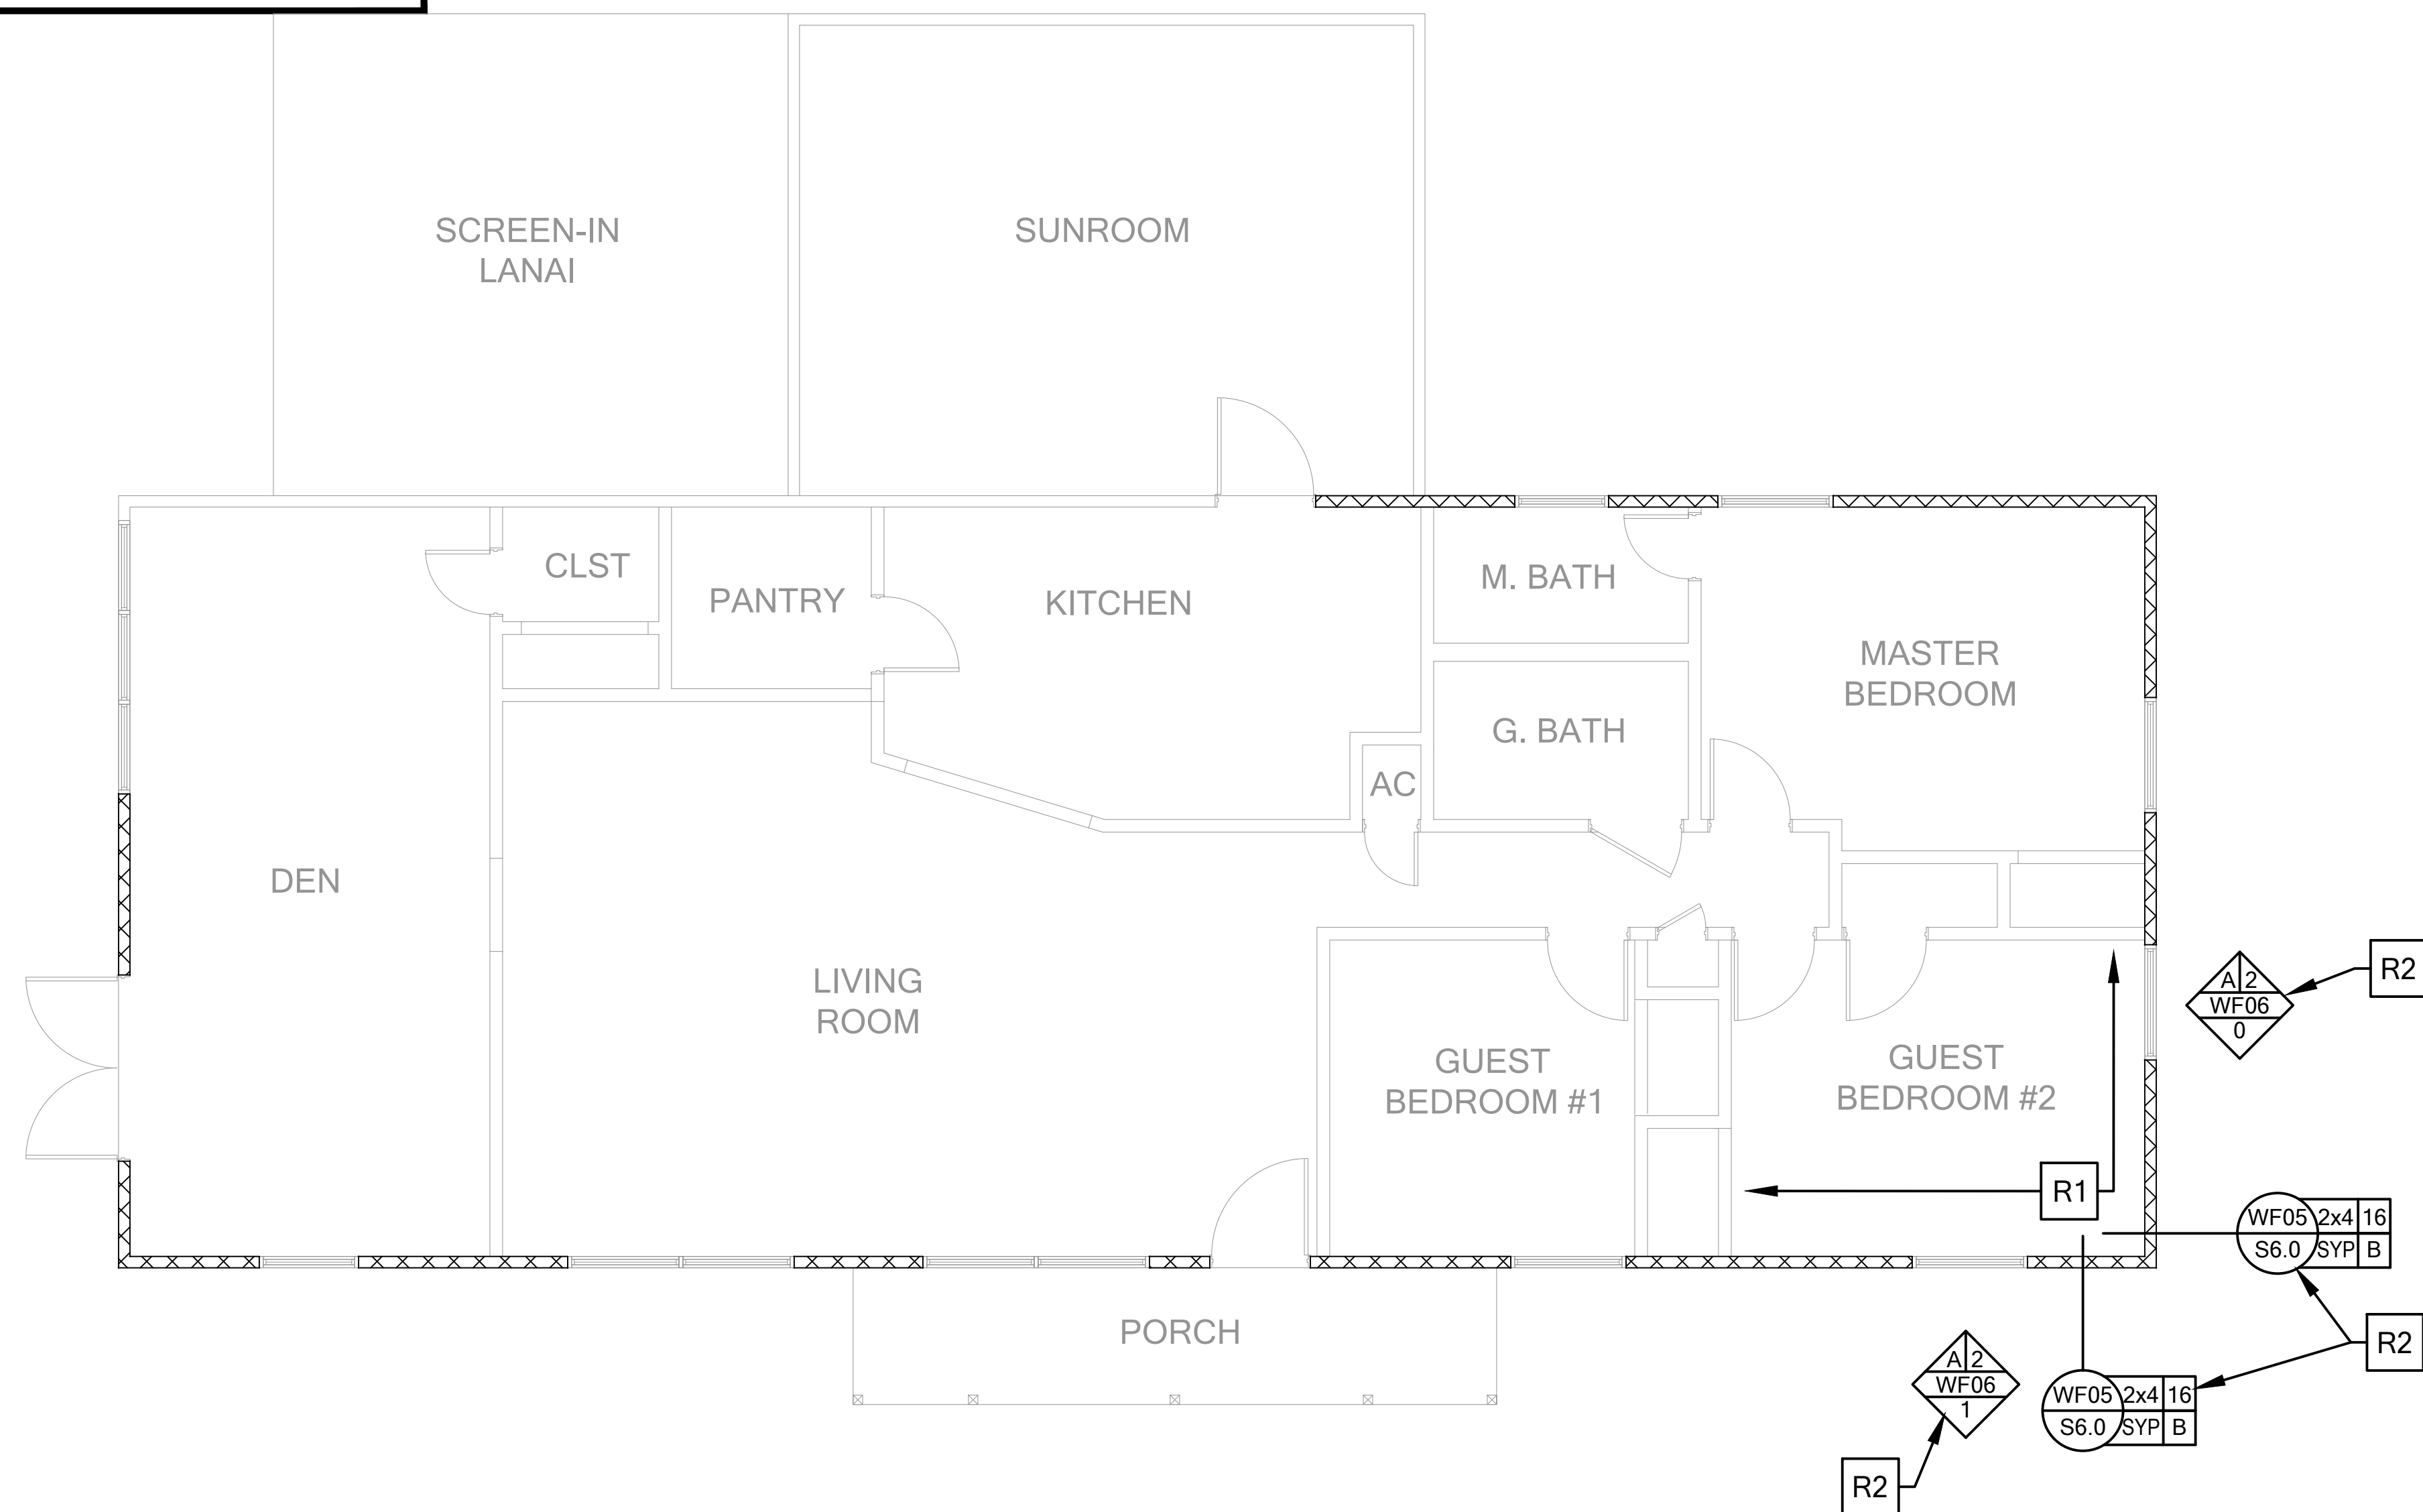

REPAIR FLOOR PLAN

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ENGINEER:

RYAN M. GISSAL, P.E.
PE#: 78615

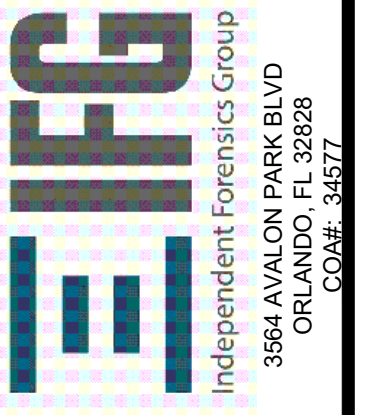SIGNATURE

PROJECT:

GARDE RESIDENCE
2094 NW THUNDER STREET
WHITE SPRINGS, FLORIDA 32096
IFG#: IFG240292

PLAN HISTORY

[illegible]

SHEET DATA:

ENGINEERED BY: RMG

RAWN BY: RMG

SHEET DESCRIP:

REPAIR FLOOR LAYOUT

SHEET

S3.0

REPAIR NOTES


GENERAL CONTRACTOR IS RESPONSIBLE FOR ALL TEMPORARY SHORING AND BRACING DURING REPAIRS. SHOULD FIELD CONDITIONS DIFFER FROM THESE PLANS, OR ANY ADDITIONAL STRUCTURAL DAMAGES FOUND DURING REPAIRS, --STOP-- AND CONTACT E.O.R. FOR ADDITIONAL REVIEW.

REMOVE DAMAGED ROOF SHEATHING FROM THE NORTH-FACING ROOF SLOPE MEASURED AT APPROXIMATELY 12'-0" FROM THE WESTERN RAKE. REMOVE AND REPLACE ANY DAMAGED ROOF OR CEILING FRAMING AS FOLLOWS. ALL REPLACEMENT LUMBER SHALL BE SYP #2 OR BETTER. NAIL OR FASTEN ALL SIMPSON STRAPS PER SIMPSON'S WRITTEN SPECIFICATIONS:

ROOF TRUSS DAMAGE IS DOCUMENTED ON SHEET S7.0. SOME TRUSSES MAY REQUIRE PRE-ENGINEERED AND PRE-FABRICATED JACK SCABS. G.C. TO COORDINATE WITH TRUSS SUPPLIER, AND SUBMIT REPAIR DRAWINGS TO IFG FOR APPROVAL.

ALL REPAIRED TRUSSES SHALL BE ATTACHED TO BEARING WALLS WITH SIMPSON H2.5A ON EACH END, OR (2)- 6" SIMPSON SDWC SCREWS. REFER TO SIMPSON SPECIFICATIONS FOR APPROVED INSTALLATION GEOMETRY.


ANY DAMAGED ROOF SHEATHING SHALL BE REMOVED AND REPLACED WITH LIKE MATERIAL: MIN. 7/16" EXPOSURE 1 SHEATHING, NAILED TO EA. RAFTER WITH NAILS AT 6" O.C. AT EDGES AND 12" O.C. IN THE FIELD. NAIL SIZES PER FBC-R803.

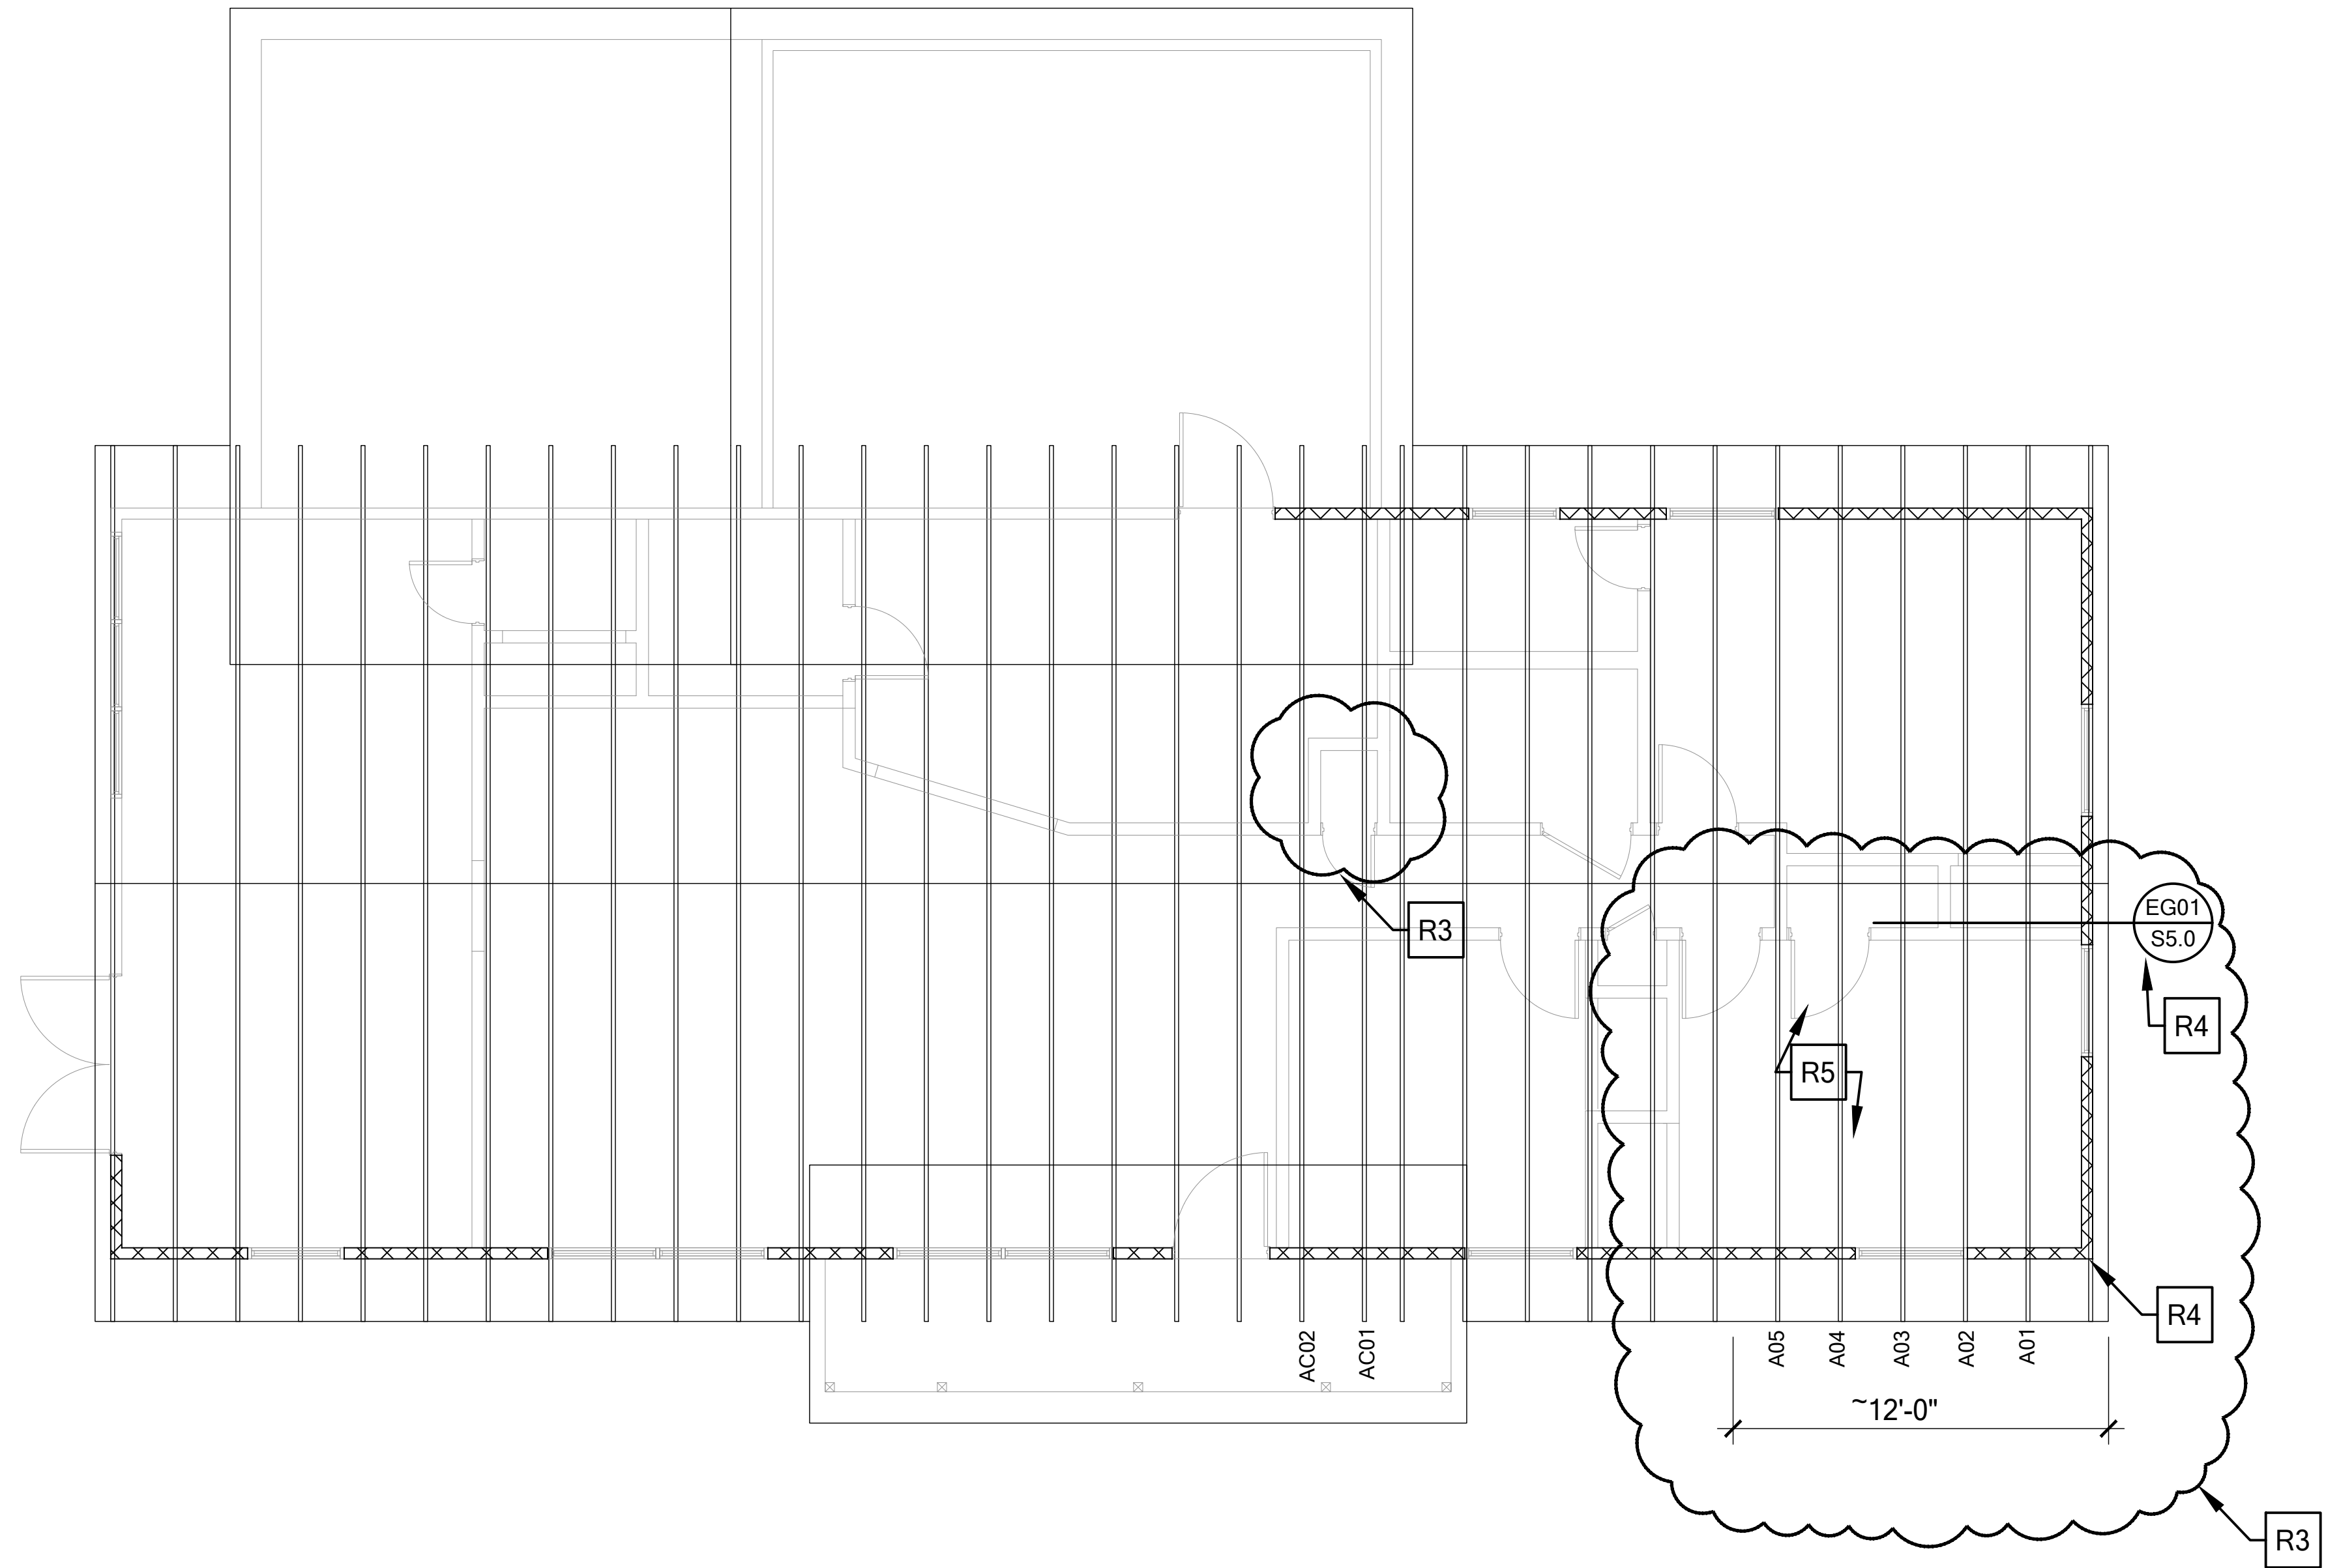

REPAIR ROOF PLAN

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ENGINEER:

ENGINEER:
J. M. GISSAL, P.E.
PE #: 78615

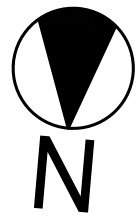PE#: 78615

DATE: REFERENCE DIGITAL
SIGNATURE

PROJECT:

GARDE RESIDENCE

WHITE SPRINGS, EL OBIDA 33006

IFG#: IFG240292

PLAN HISTORY

DATE	DESCRIP:
------	----------

[illegible]

SHEET DATA:

ENGINEERED BY: RMG

DRAWN BY: RMG

SHEET DESCRIP:

REPAIR ROOF LAYOUT

SHEET

S4.0



TRUSS NOTES:


1. WOOD TRUSS ERECTOR SHALL PROVIDE BRACING ACCORDING TO ANSITP1 (TRUSS PLATE INSTITUTE) NOTE THAT THE COMBINED WIND AREA IS GREATER BEFORE THE ROOF SHEATHING IS APPLIED, AND BRACING SHALL THEREFORE BE INSTALLED AS THE TRUSSES ARE ERECTED. INADEQUATE TRUSSES BRACING IS THE MOST COMMON CAUSE OF ACCIDENT IN WOOD TRUSS CONSTRUCTION. FULL BUNDLES OF PLYWOOD SHALL NOT BE PLACED ON TRUSSES. THIS CONSTRUCTION LOAD SHOULD BE LIMITED TO 8 SHEETS OF PLYWOOD ON ANY PAIR OF TRUSSES & SHALL BE LOCATED ADJACENT TO THE SUPPORTS. NO EXCESS CONCENTRATION OF ANY CONSTRUCTION MATERIAL (SUCH AS GRAVEL OR SHINGLES) SHALL BE PLACED ON THE TRUSSES IN ANY ONE AREA THEY SHALL BE SPREAD OUT EVENLY OVER A LARGE SO AS TO AVOID OVERLOADING ANY ONE TRUSS.

2. ALL BRACING (DB, CBB, BB) SHOWN ABOVE SHALL BE IN ADDITION TO CONTINUOUS LATERAL BRACING SPECIFIED BY THE TRUSS MANUFACTURER ALL LATERAL BRACING SPECIFIED BY TRUSS MANUF. SHALL HAVE ADDITIONAL DIAGONAL BRACES AT 20'-0" O.C. MAXIMUM.

3. ALL BRACES SHALL BE 2x4 NOMINAL DIMENSION LUMBER & SHALL BE ATTACHED W/ (2)- 16d NAILS AT EACH TRUSS INTERSECTION.

4. ADDITIONAL BOTTOM CHORD BRACING SHALL BE INSTALLED AS REQUIRED BY TRUSS DESIGN WHEREVER ADEQUATE STRUCTURAL CEILING ARE NOT ATTACHED DIRECTLY TO THE BOTTOM CHORD OF THE TRUSS.

5. PROVIDE TRUSS BLOCKING AT ALL TRUSS BEARING SUPPORTS WHERE DEPTH EXCEEDS STANDARD HELL HEIGHT. SEE TYP. TRUSS BLCKING DETAILS.

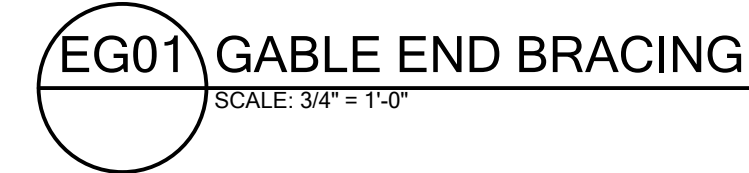

IFG
Independent Forensics Group
3554 AVALON PARK BLVD
ORLANDO, FL 32828
COAH# 34577

ENGINEER:

ENGINEER:
RYAN M. GISSAL, P.E.
PE#: 78615

SIGNATURE

PROJECT:

GARDE RESIDENCE
2034 NW THUNDER STREET
WHITE SPRINGS, FLORIDA 32096
IFG#: IFG240292

PLAN HISTORY

[illegible]

SHEET DATA:

ENGINEERED BY: RMG

RAWN BY: RMG

SHEET DESCRIP:


STRUCTURAL DETAILS

SHEET


S5.0

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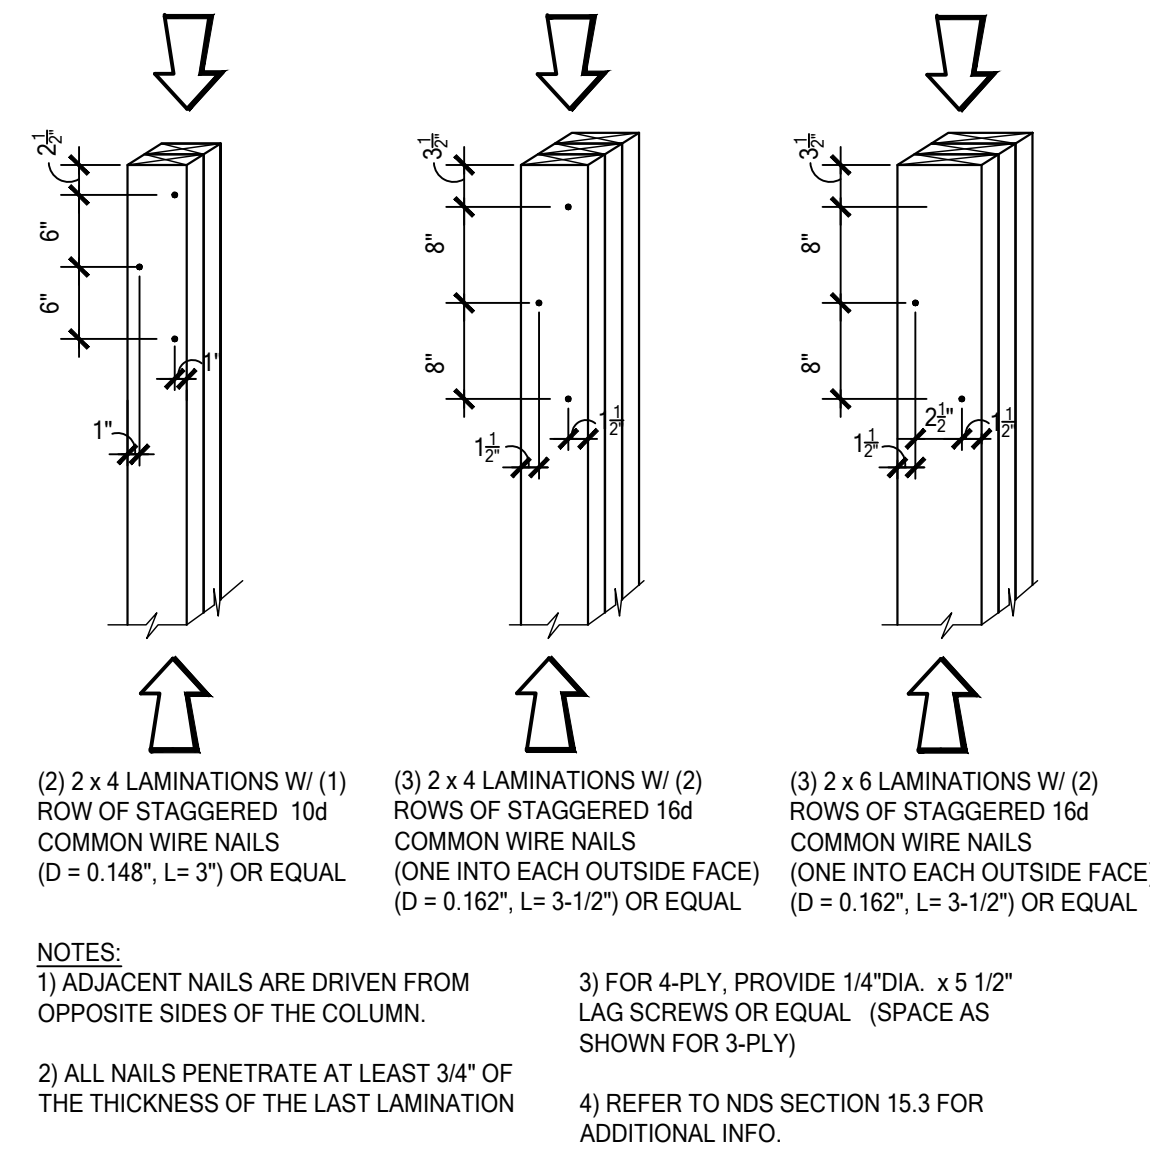
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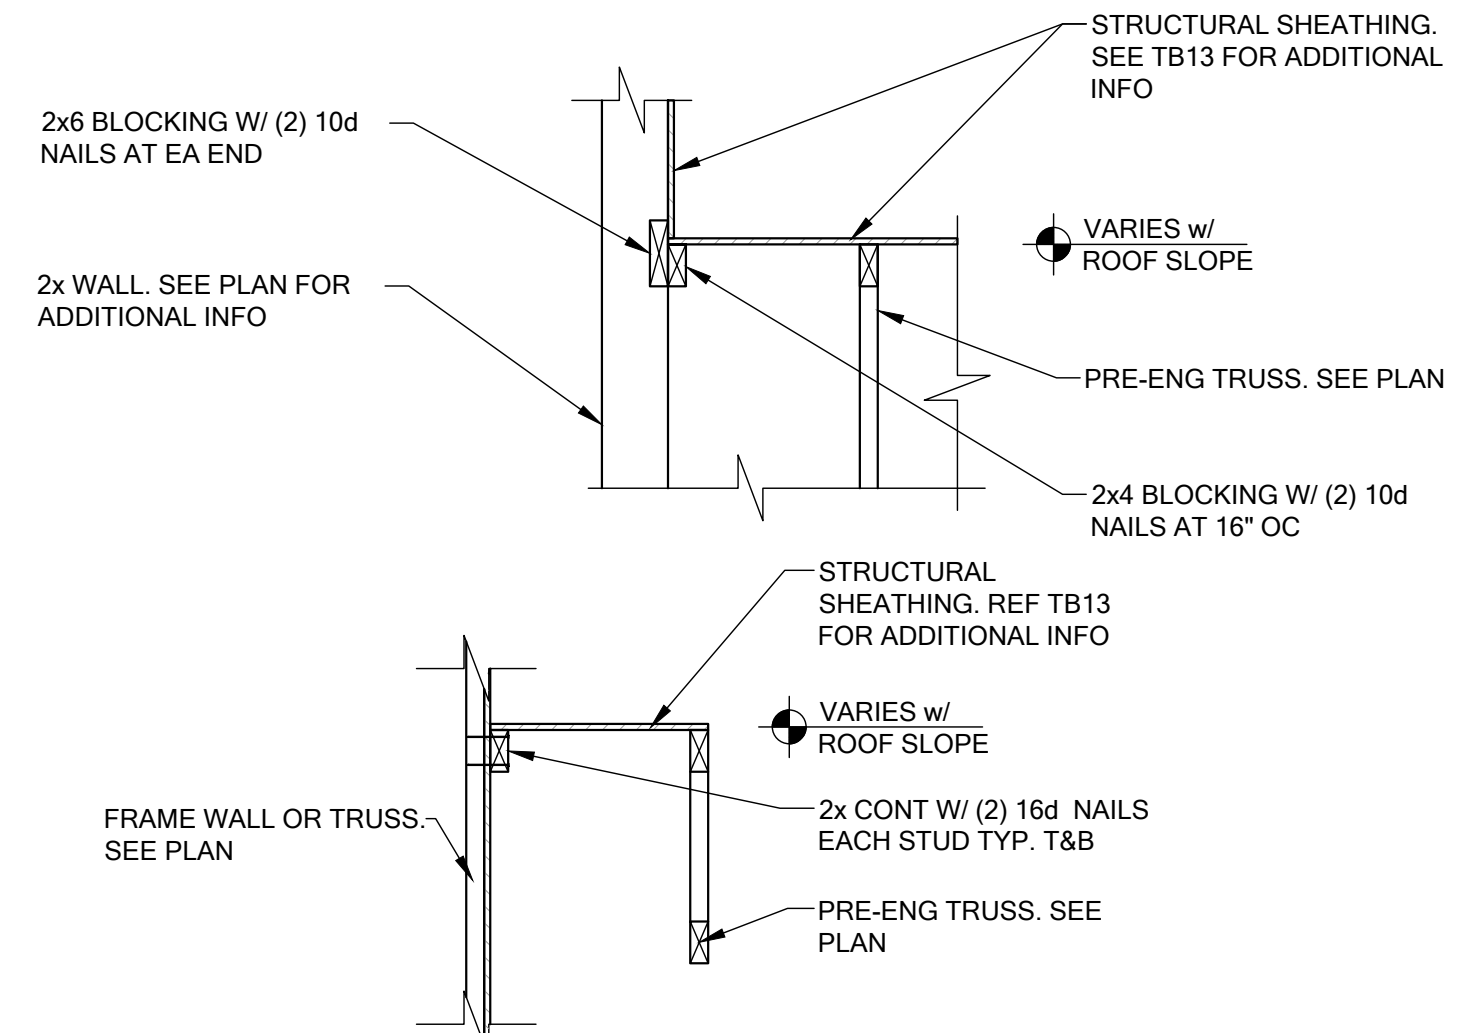
WF08 TOP PLATE SPLICE DETAIL
SCALE: 3/4" = 1'-0"

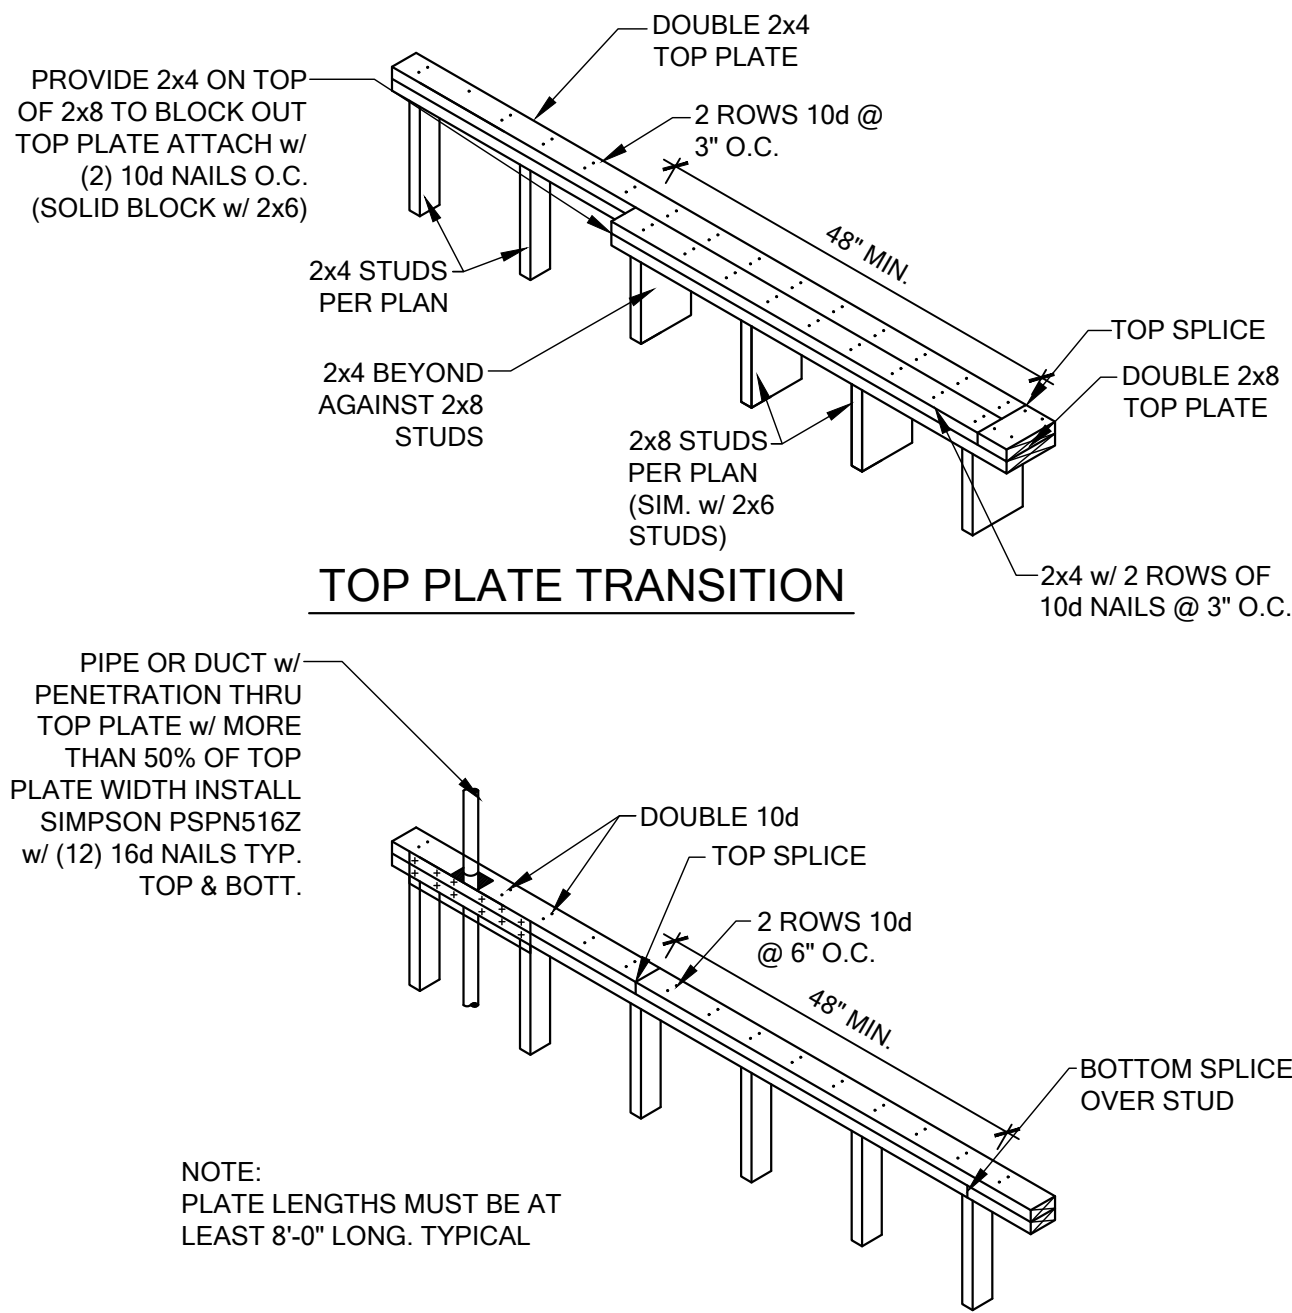


WF10 TYP. INTERIOR NON BEARING
SCALE: 3/4" = 1'-0"

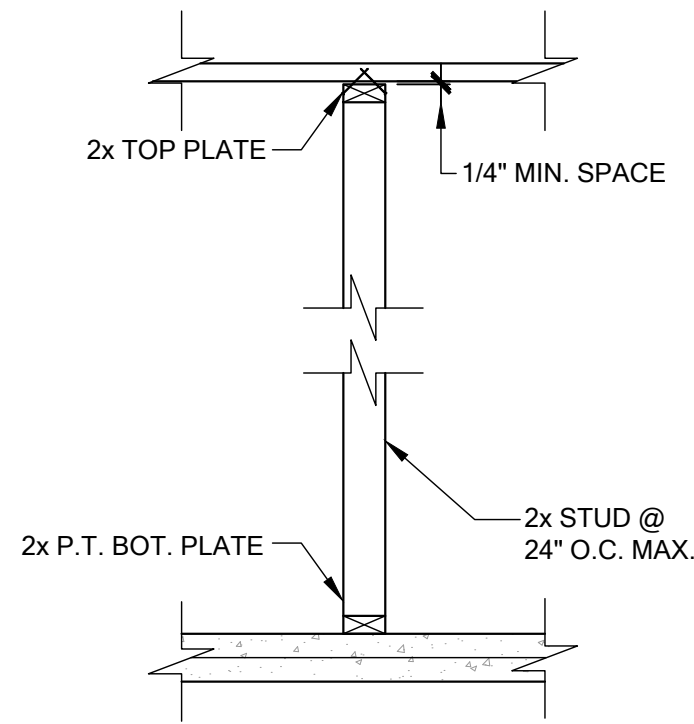

WF11 BUILT UP COLUMN NAILING SCHEDULE
SCALE: 3/4" = 1'-0"




LD02 SHEAR TRANSFER EXT. WALL
SCALE: 3/4" = 1'-0"

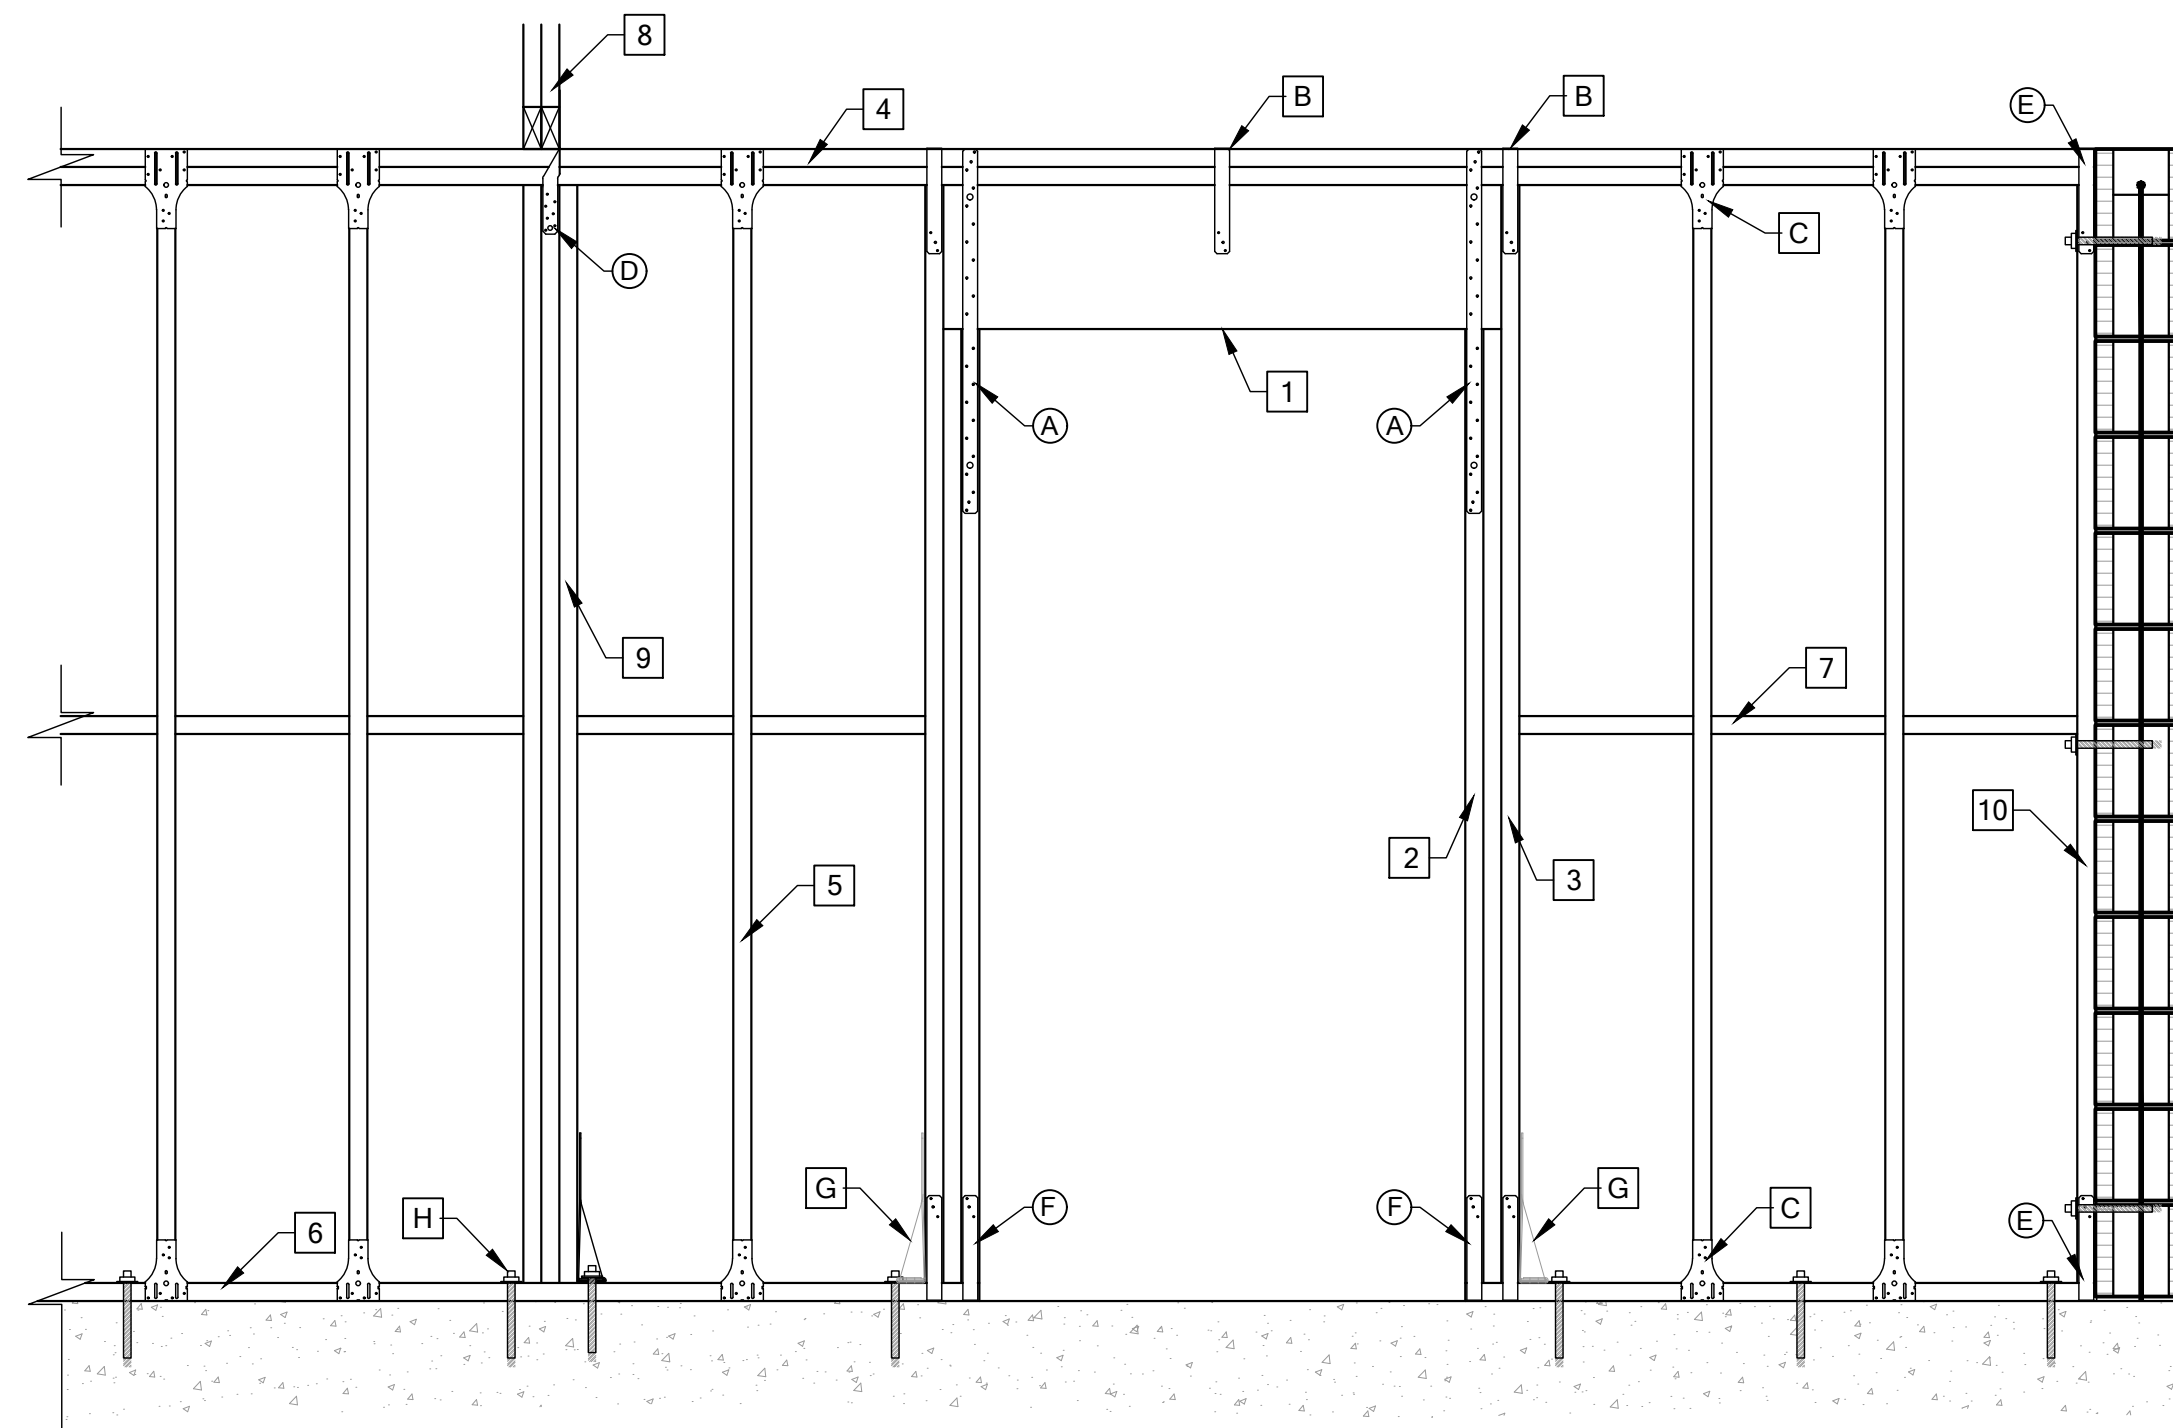

WF05 FIRST FLOOR WOOD-FRAMED BEARING WALL
SCALE: 3/4" = 1'-0"

- 1 OPENING HEADER SEE FLOOR PLAN FOR SIZE AND TYPE. IF NO HEADERS ARE SPECIFIED ON PLANS USE (2) 2X12 SYP #2.
 - 2 JACK STUDS BELOW HEADER. SEE FLOOR PLAN FOR JACK STUD REQUIREMENTS.
 - 3 2x KING STUDS AT END OF HEADER. SEE FLOOR PLAN FOR KING STUD REQUIREMENTS.
 - 4 (2) 2x TOP PLATE. SEE WF08 FOR SPLICE IN TOP PLATE.
 - 5 2x STUDS @ 16" O.C. U.N.O. ON PLANS. ATTACH STUDS TO TOP AND BOTTOM PLATES WITH (2) 10d NAILS.
 - 6 2x P.T. SILL PLATE
 - 7 2X MID HEIGHT BLOCKING W/ (2) 10d NAILS EACH END.
 - 8 GIRDER/BEAM. SEE PLAN FOR ADDITIONAL INFORMATION.
 - 9 COLUMN UNDER GIRDER/BEAM. SEE PLAN FOR SIZE, TYPE, AND BASE CONNECTION OF COLUMN.
 - 10 2X P.T. STUD AT EXTERIOR WALL CONDITION. CONNECT TO CMU WITH ONE OF THE FOLLOWING METHODS:
(3) 1/2"x8" J-BOLTS
(3) 1/2"x6" EXPANSION BOLTS
(6) 3/2"x1/2" TAPCONS
(8) 2 1/2" HILTI TTX-DNI NAILS
- A SIMPSON LSTA30 w/ (22)- 10d NAILS @ EACH END OF HEADER TO JACK STUD IF SPECIFIED ON PLANS. DOUBLE IF SPECIFIED ON PLANS.
 - B SIMPSON SP4 W/ (6) 10d x 1 1/2" NAILS AT EACH KING STUD AND @ 24" O.C. ABOVE HEADER OPENING WHERE STRAPS ARE SPECIFIED AT EACH END OF HEADER ON PLANS.
 - C CONNECTOR AT TOP AND BOTTOM OF EACH STUD IF SPECIFIED ON PLANS.
 - D SEE PLAN FOR GIRDER/BEAM CONNECTION.
 - E SIMPSON SP4 W/ (6) 10d x 1 1/2" NAILS AT TOP OF BOTTOM OF END STUD.
 - F (2) SIMPSON SP4 W/ (6) 10d x 1 1/2" NAILS AT EACH END OF OPENING. USE ALTERNATE CONNECTION (G) WHEN STRAPS AT HEADER ABOVE ARE DOUBLED.
 - G SIMPSON HTT5 W/ (18) 16d NAILS AND 5/8" EXPANSION ANCHOR w/ 6" EMBEDMENT TYPICAL (8 1/2" AT STEP-DOWN CONDITION).
 - H 1/2" ANCHOR BOLTS @ 32" O.C. AND 6" FROM ENDS OF SILL PLATE W/ MIN. 7" EMBEDMENT. IN LIEU OF ANCHOR BOLTS USE 1/2" SIMPSON TITEN HD AT SAME SPACING AND EMBEDMENT.

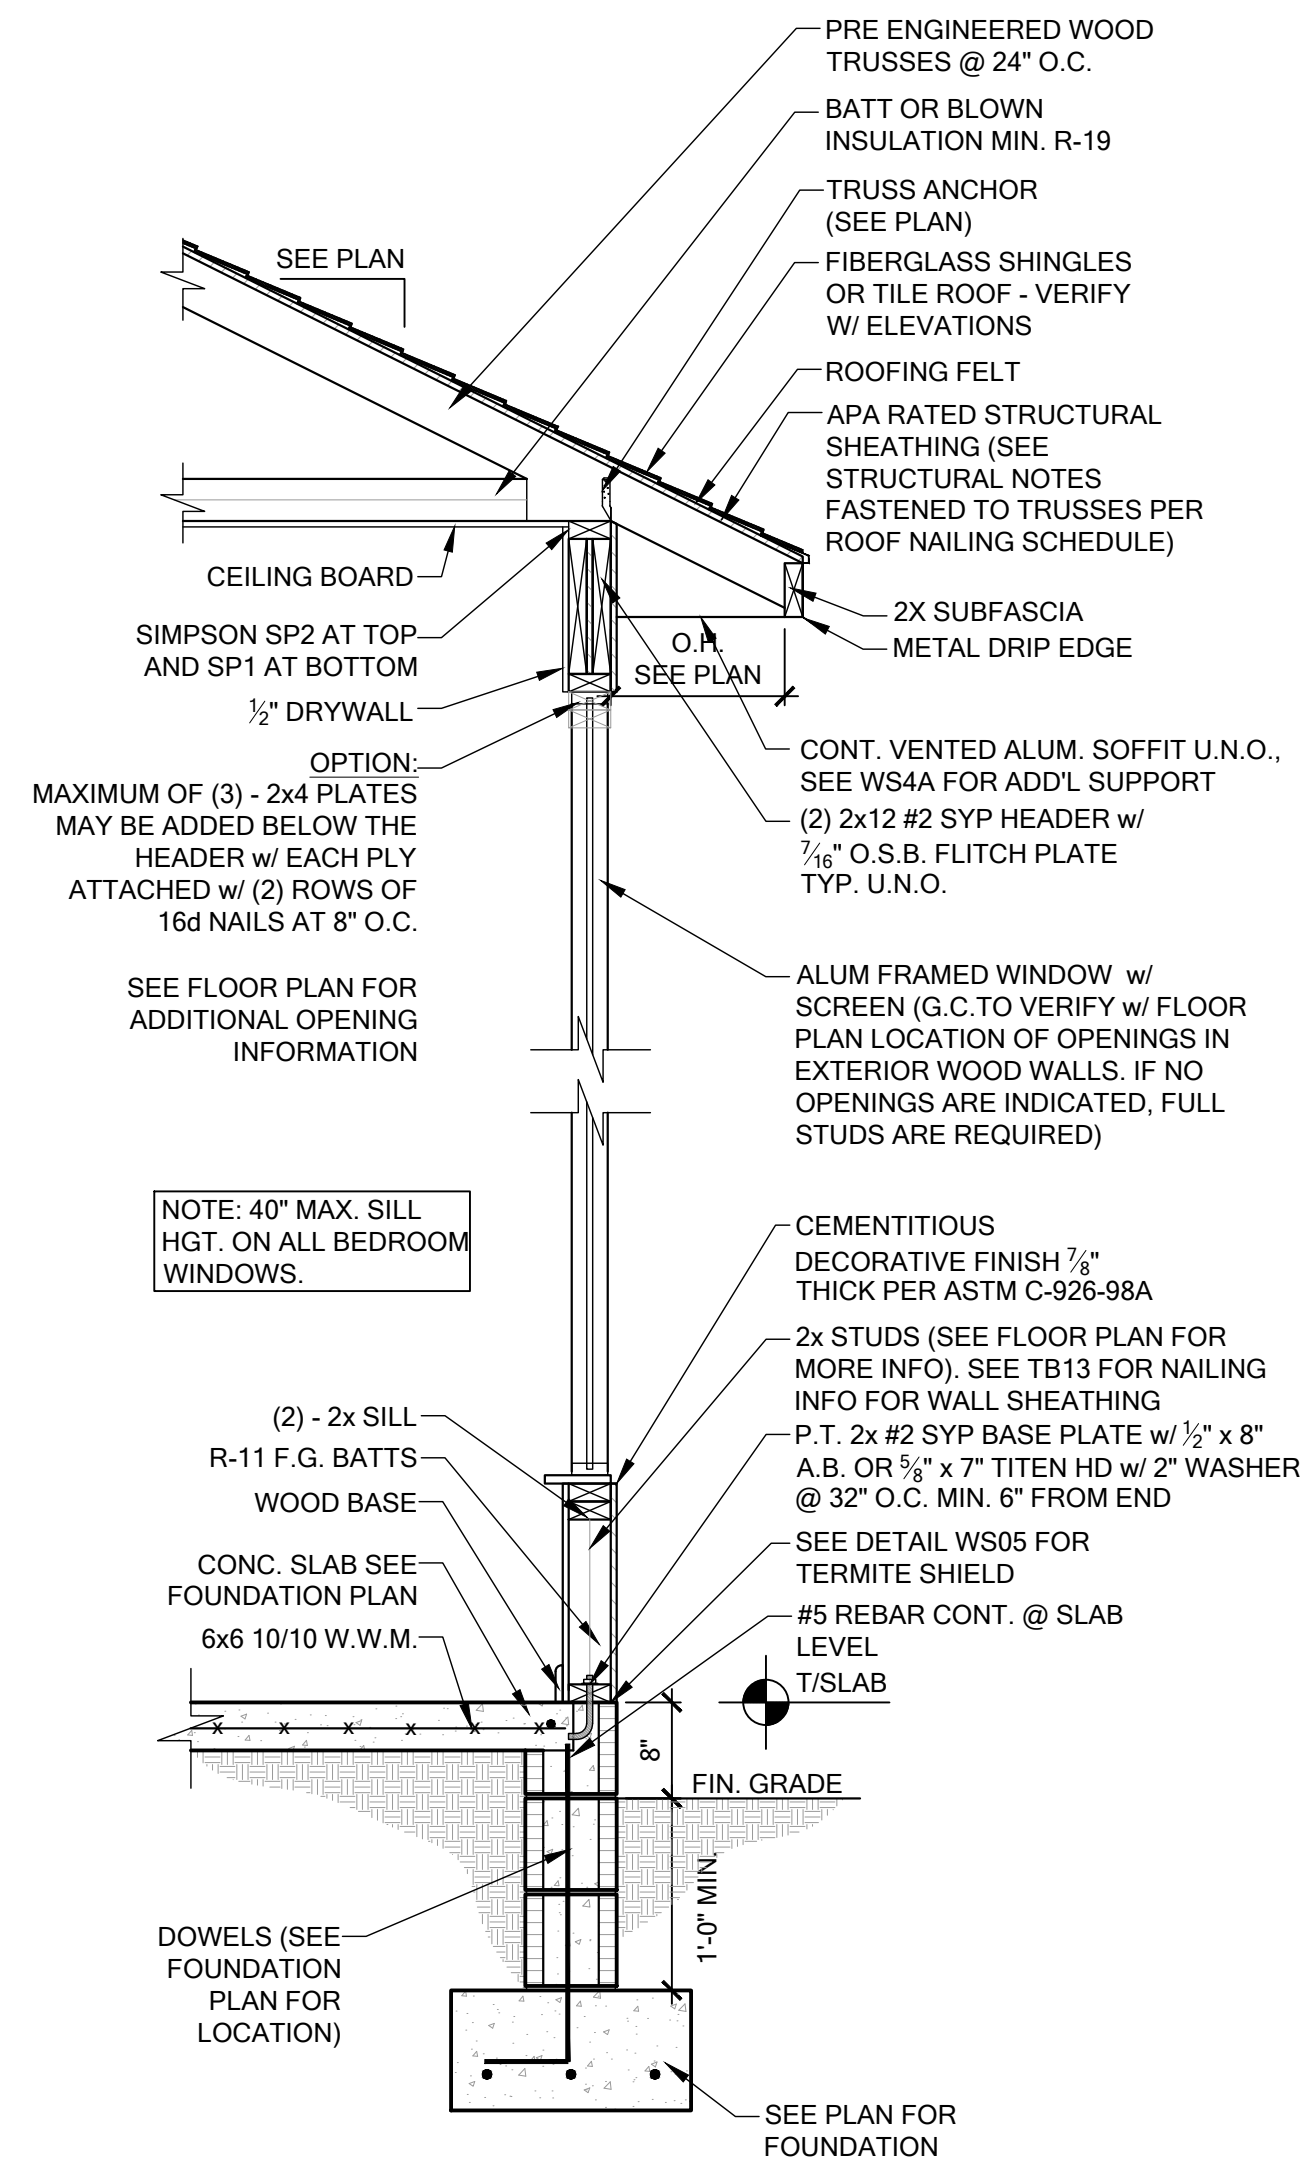

WS02 TYPICAL WALL SECTION

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ENGINEER:

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RYAN M. GISSAL, P.E.
P.E.#: 78615
DATE: REFERENCE DIGITAL SIGNATURE

PROJECT:

GARDE RESIDENCE
2094 NW THUNDER STREET
WHITE SPRINGS, FLORIDA 32096
IFG#: IFG240292

PLAN HISTORY

DATE	DESCRIP:

SHEET DATA:

ENGINEERED BY: RMG

DRAWN BY: RMG

SHEET DESCRIP:

STRUCTURAL DETAILS

SHEET

S6.0





- LEGEND:

R RETRACTED, BENT, OR DAMAGED TRUSS PLATE

X DAMAGED MEMBER **⚡** APPROXIMATE EXTENT OF DAMAGE

DRAWINGS PROVIDED FOR ESTIMATION PURPOSES ONLY. TRUSS SUPPLIER / G.C. SHALL VERIFY ALL DIMENSIONS.

IF ADDITIONAL DAMAGES ARE FOUND, CONTACT E.O.R. FOR REVIEW.

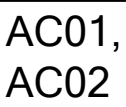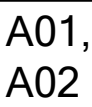

WEBS AND BOTTOM CHORD
CUT OR REMOVED ON TWO
TRUSSES TO MAKE ROOM FOR
AC PLENUM.

TRUSS BOTTOM CHORDS APPEAR TO PICK UP BEARING ON THE INTERIOR WALLS SURROUNDING THE AC CLOSET. CONTACT IFG IF BEARING POINTS ARE NEEDED ON THESE WALLS FOR REPAIRS, AND THE REQUIRED REACTIONS, AS THIS WILL TRIGGER ADDITIONAL REVIEW OF THE WALLS BELOW.



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IFG#: IFG240292

PLAN HISTORY

[illegible]

SHEET DATA:

ENGINEERED BY: RMG

DRAWN BY: RMG

SHEET DESCRIP:

TRUSS DAMAGE SKETCHES

SHEET

\$7.0

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