

FLOOR PLAN

SCALE: 1/4" = 1'-0"

ALL WINDOWS WITHIN 12" OF FINISH FLOOR  
HEIGHT ARE SAFETY GLASS

## AREA SUMMARY

**LIVING AREA**

COVERED PORCH AREA 512 S. F.

**TOTAL AREA UNDER POF** 1,843 S. E.

## SPRAY FOAM INSULATION, NO RIDGE VENTING


## REVISIONS

**SOFTPLAN**  
ARCHITECTURAL DESIGN SOFTWARE

## FRONT ELEVATION



## RIGHT ELEVATION

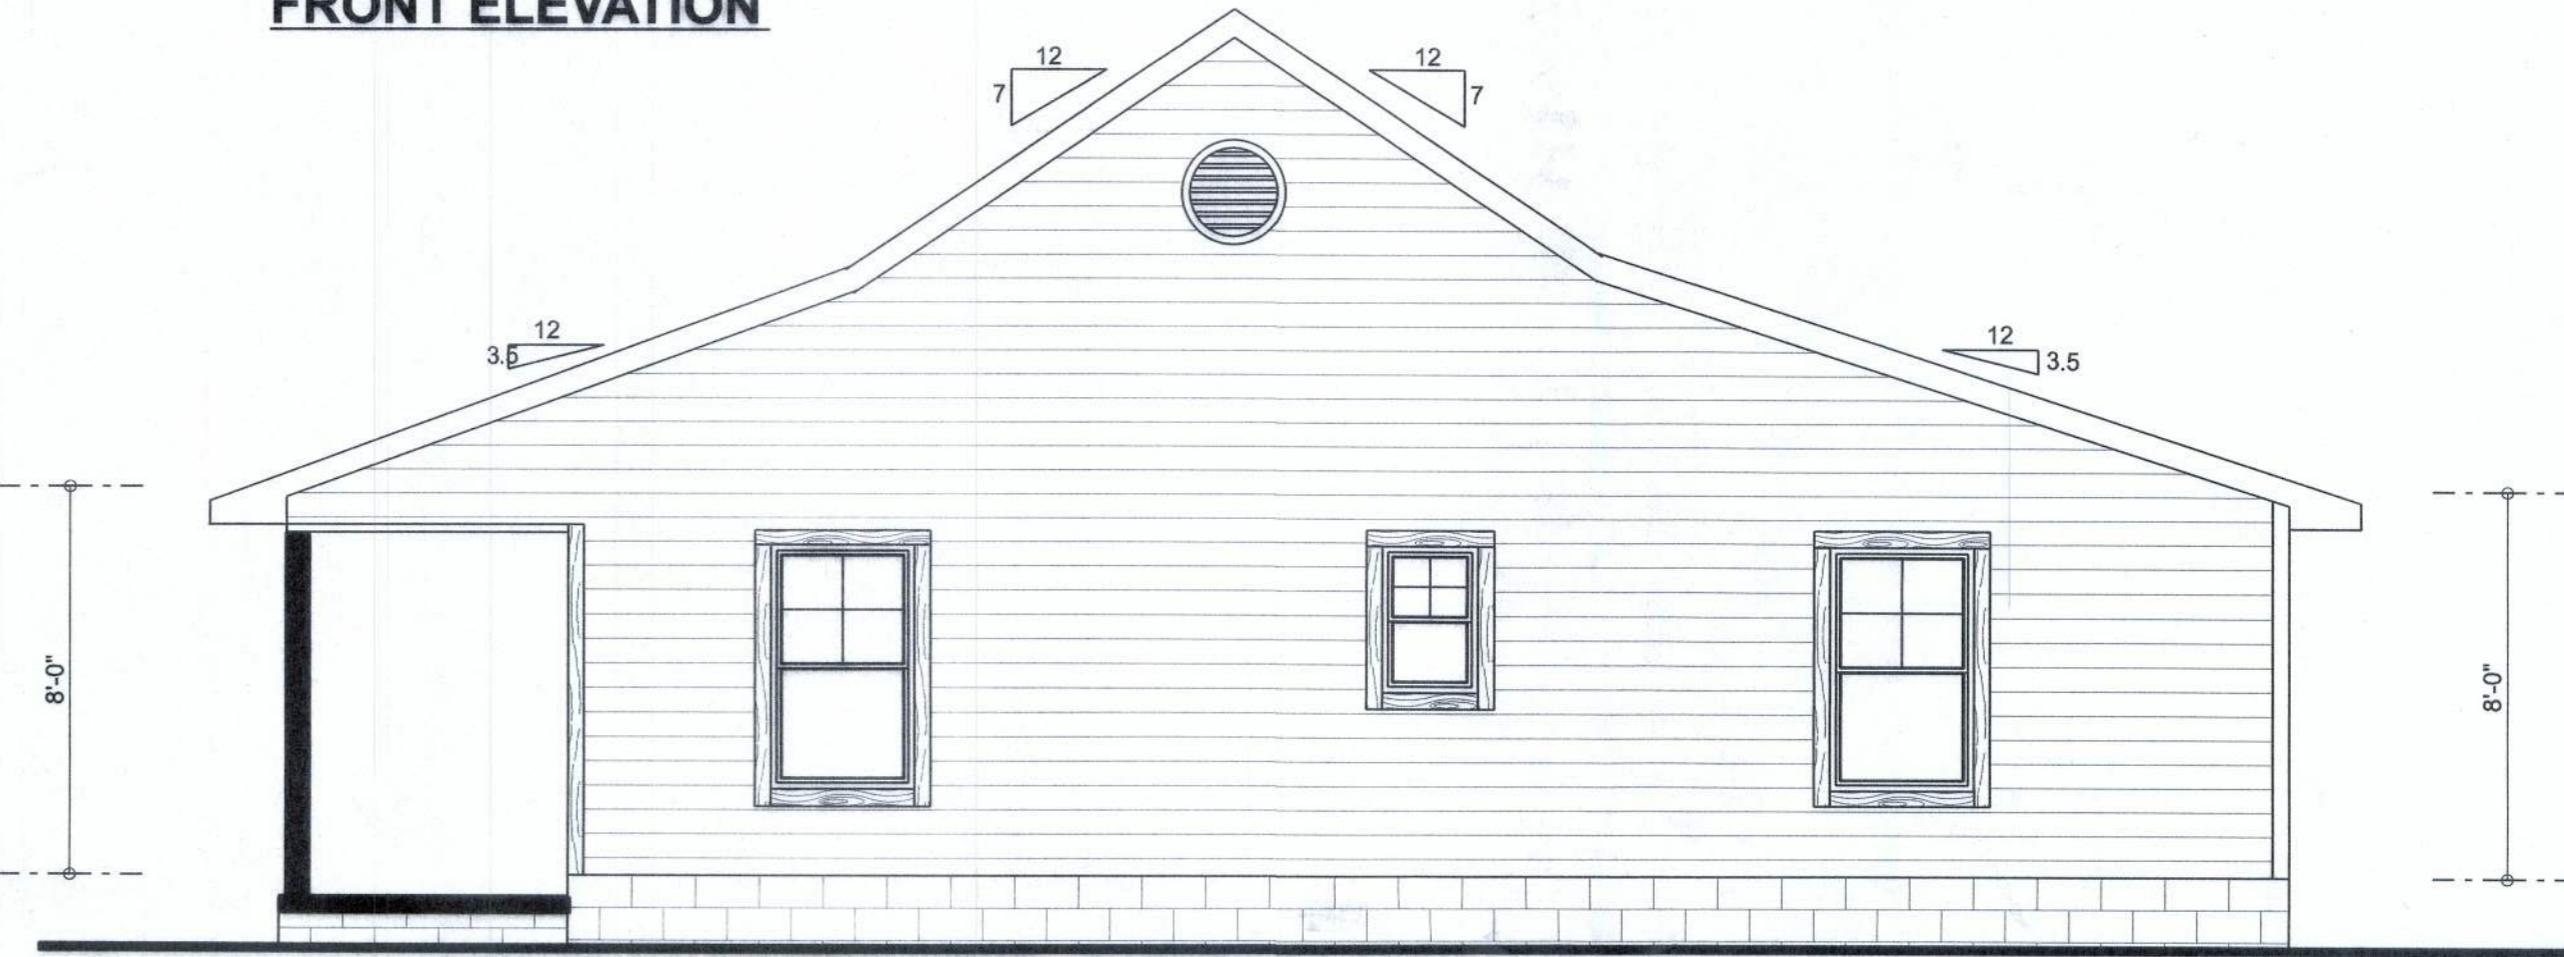

## LEFT ELEVATION



## **REAR ELEVATION**



**ERKINGER**  
**CONSTRUCTION**  
**GROUP**

William W. & Robin C.  
Wentworth

ADDRESS:  
2SW Sassafras Street  
White, Florida 32038  
Columbia County

PARCEL #  
S-17-03816-320

Sunday, April 25, 2021

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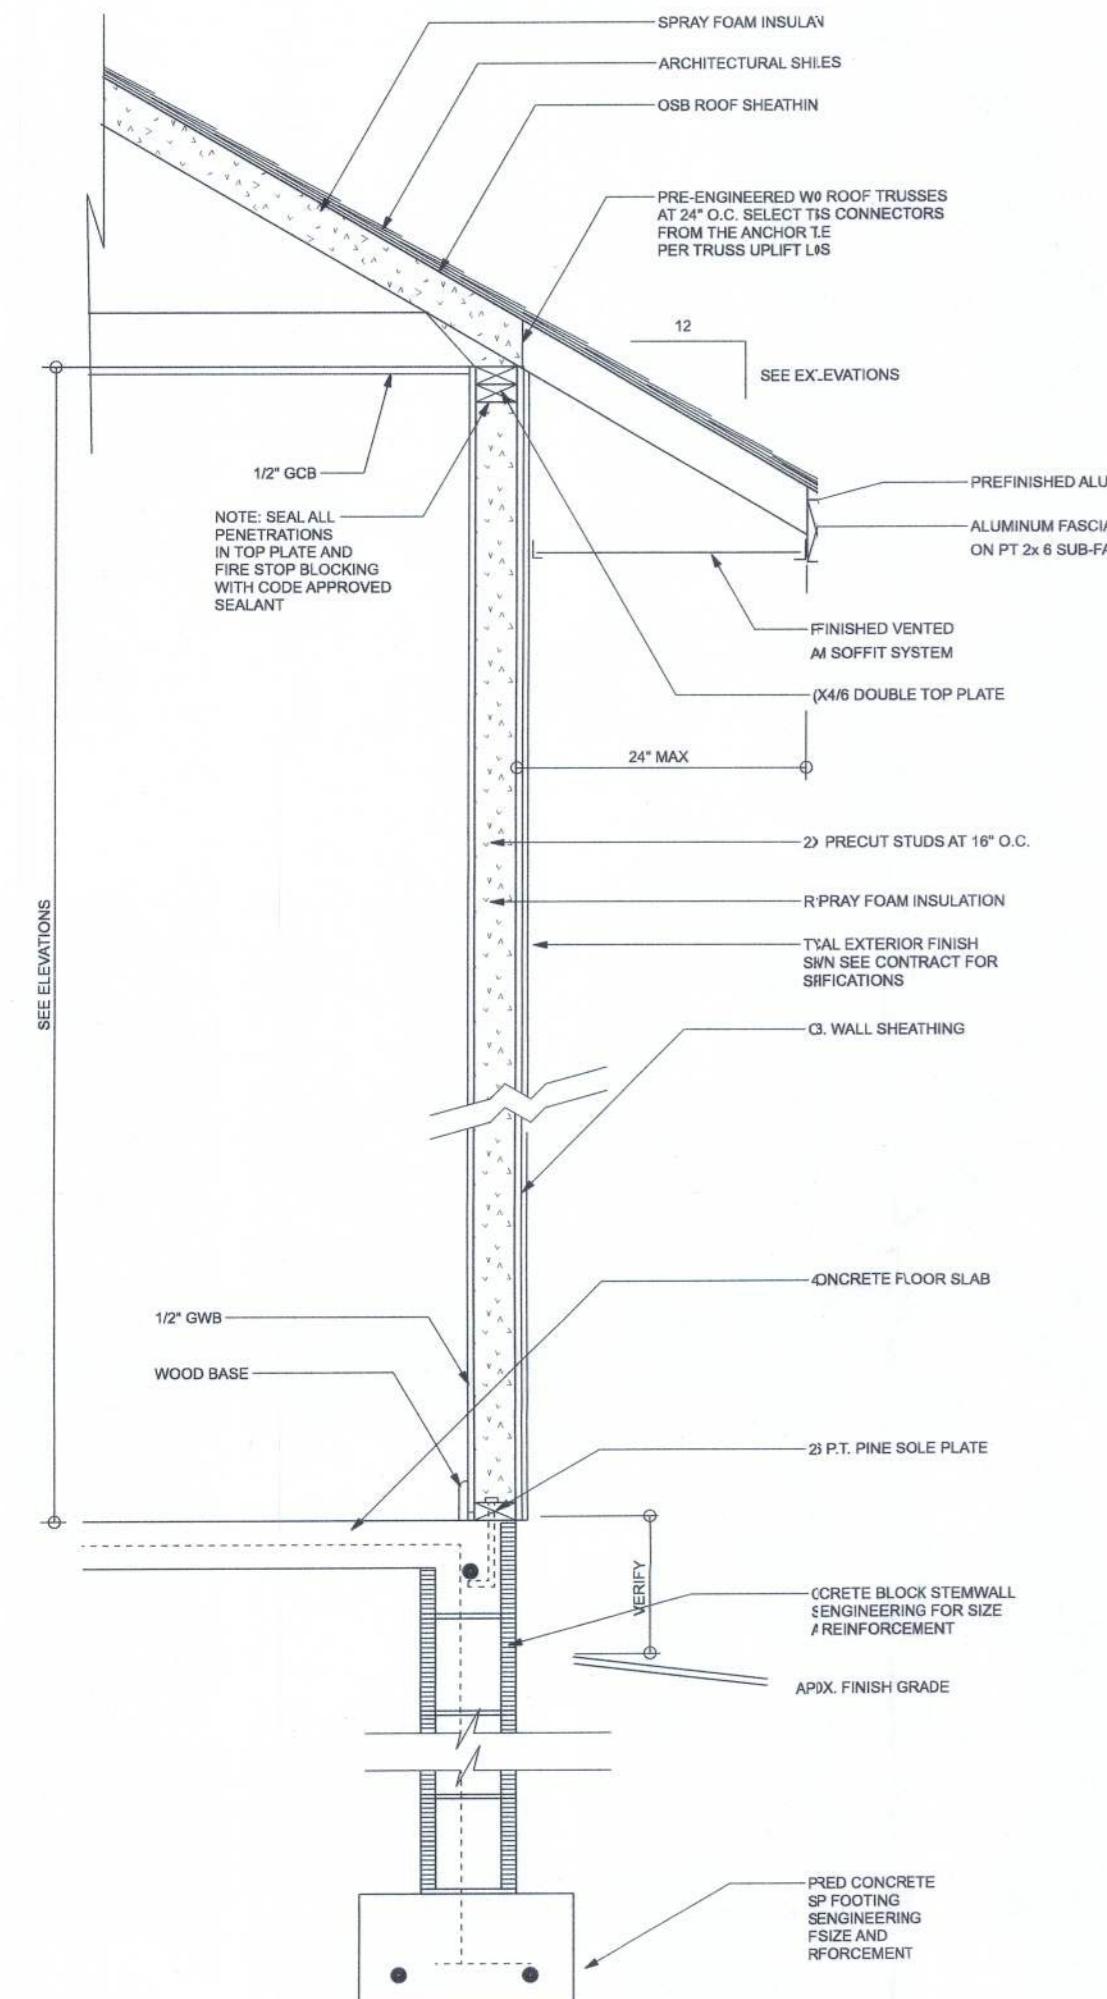
DRAWN BY:  
Matthew A Erkinger Sr.

DRAWING NUMBER

OF 2 SHEETS

#41940

REVISIONS	




TYPICAL DESIGN WALL SECTION  
NON-STRUCTURAL DATA

SCALE: 1" = 1'-0"

ELECTRICAL	SYMBOL
AC Disconnect	
com - data TV	
fan - Bath fan light	
fan - ceiling fan	
light - can light	
light - exterior spotlights	
light - fluorescent 1 x 4	
outlet	
outlet - 220v	
outlet - WP	
outlet - gfi	
switch	
switch - 3 way	
switch - 4 way	
chandelier 01	
pendant large	
exterior craftsman light fixture	
pull chain light	
wall mounted 01 2 lights	
detector - smoke	
detector - CO	

ELECTRICAL PLAN NOTES:	
E - 1	WIRE ALL APPLIANCES, HVAC UNITS AND OTHER EQUIPMENT PER NATIONAL ELECTRIC CODE.
E - 2	COULD THE OWNER FOR THE NUMBER OF SEPERATE TELEPHONE LINES TO BE INSTALLED.
E - 3	ALL INSTALLATIONS SHALL BE PER NATL. ELECTRIC CODE.
E - 4	ALL SMOKE DETECTORS SHALL BE 120V W/ BATTERY BACKUP OF THE PHOTOELECTRIC TYPE, AND SHALL BE LOCATED TOGETHER. INSTALL INSIDE AND NEAR ALL BEDROOMS.
E - 5	TELEPHONE, TELEVISION AND OTHER LOW VOLTAGE DEVICES OR OUTLETS SHALL BE AS PER THE OWNERS DIRECTIONS OR ACCORDING TO THE APPROPRIATE SECTIONS OF NEC-LATEST EDITION.
E - 6	ELECTRICAL CONTR. SHALL BE RESPONSIBLE FOR THE DESIGN AND SIZE OF THE CIRCUITS AND CIRCUITS.
E - 7	ENTRY OR SERVICE (UNDERGROUND OR OVERHEAD) TO BE DETERMINED BY POWER COMPANY.
E - 8	ALL 120-VOLT, SINGLE-PHASE, 15- AND 20-AMPERE BRANCH CIRCUITS SUPPLYING OUTLETS INSTALLED IN DWELLING UNIT FAMILY ROOMS, DRAFTING ROOMS, KITCHENS, PANTRIES, BREAKFAST ROOMS, SUN ROOMS, RECREATION ROOMS, CLOSETS, HALLWAYS, OR SIMILAR ROOMS, OR AREAS SHALL BE PROTECTED BY LISTED ARC-FAULT CIRCUIT INTERRUPTER (AFCI)-TYPE INSTALLED TO PROVIDE PROTECTION OF THE BRANCH CIRCUIT.
E - 9	ALL OUTLETS TO BE LOCATED ABOVE BASE FLOOD ELEVATION.
E - 10	A SERVICE DISCONNECT WITH OVER CURRENT PROTECTION SHALL BE LOCATED OUTSIDE OF THE BUILDING, ON THE LOAD SIDE OF THE METER, AT THE PLACE ELECTRIC CONDUCTORS ENTER THE BUILDING.
E - 11	SMOKE MONITOR ALARMS SHALL BE REQUIRED WITHIN 10' OF ALL ROOMS FOR THE PURPOSES IN BUILDINGS HAVING A FOSSIL-FUEL-BURNING HEATER OR APPLIANCE, A FIREPLACE, OR ATTACHED GARAGE.
E - 12	ALL OUTLETS IN RESIDENTIAL TO BE TAMPER-RESISTANT PER NEC.
E - 13	A MINIMUM OF 75% OF PERMANENTLY INSTALLED LAMPS OR LIGHTING FIXTURES SHALL BE HIGH EFFICACY FBC EC SEC. R404.1

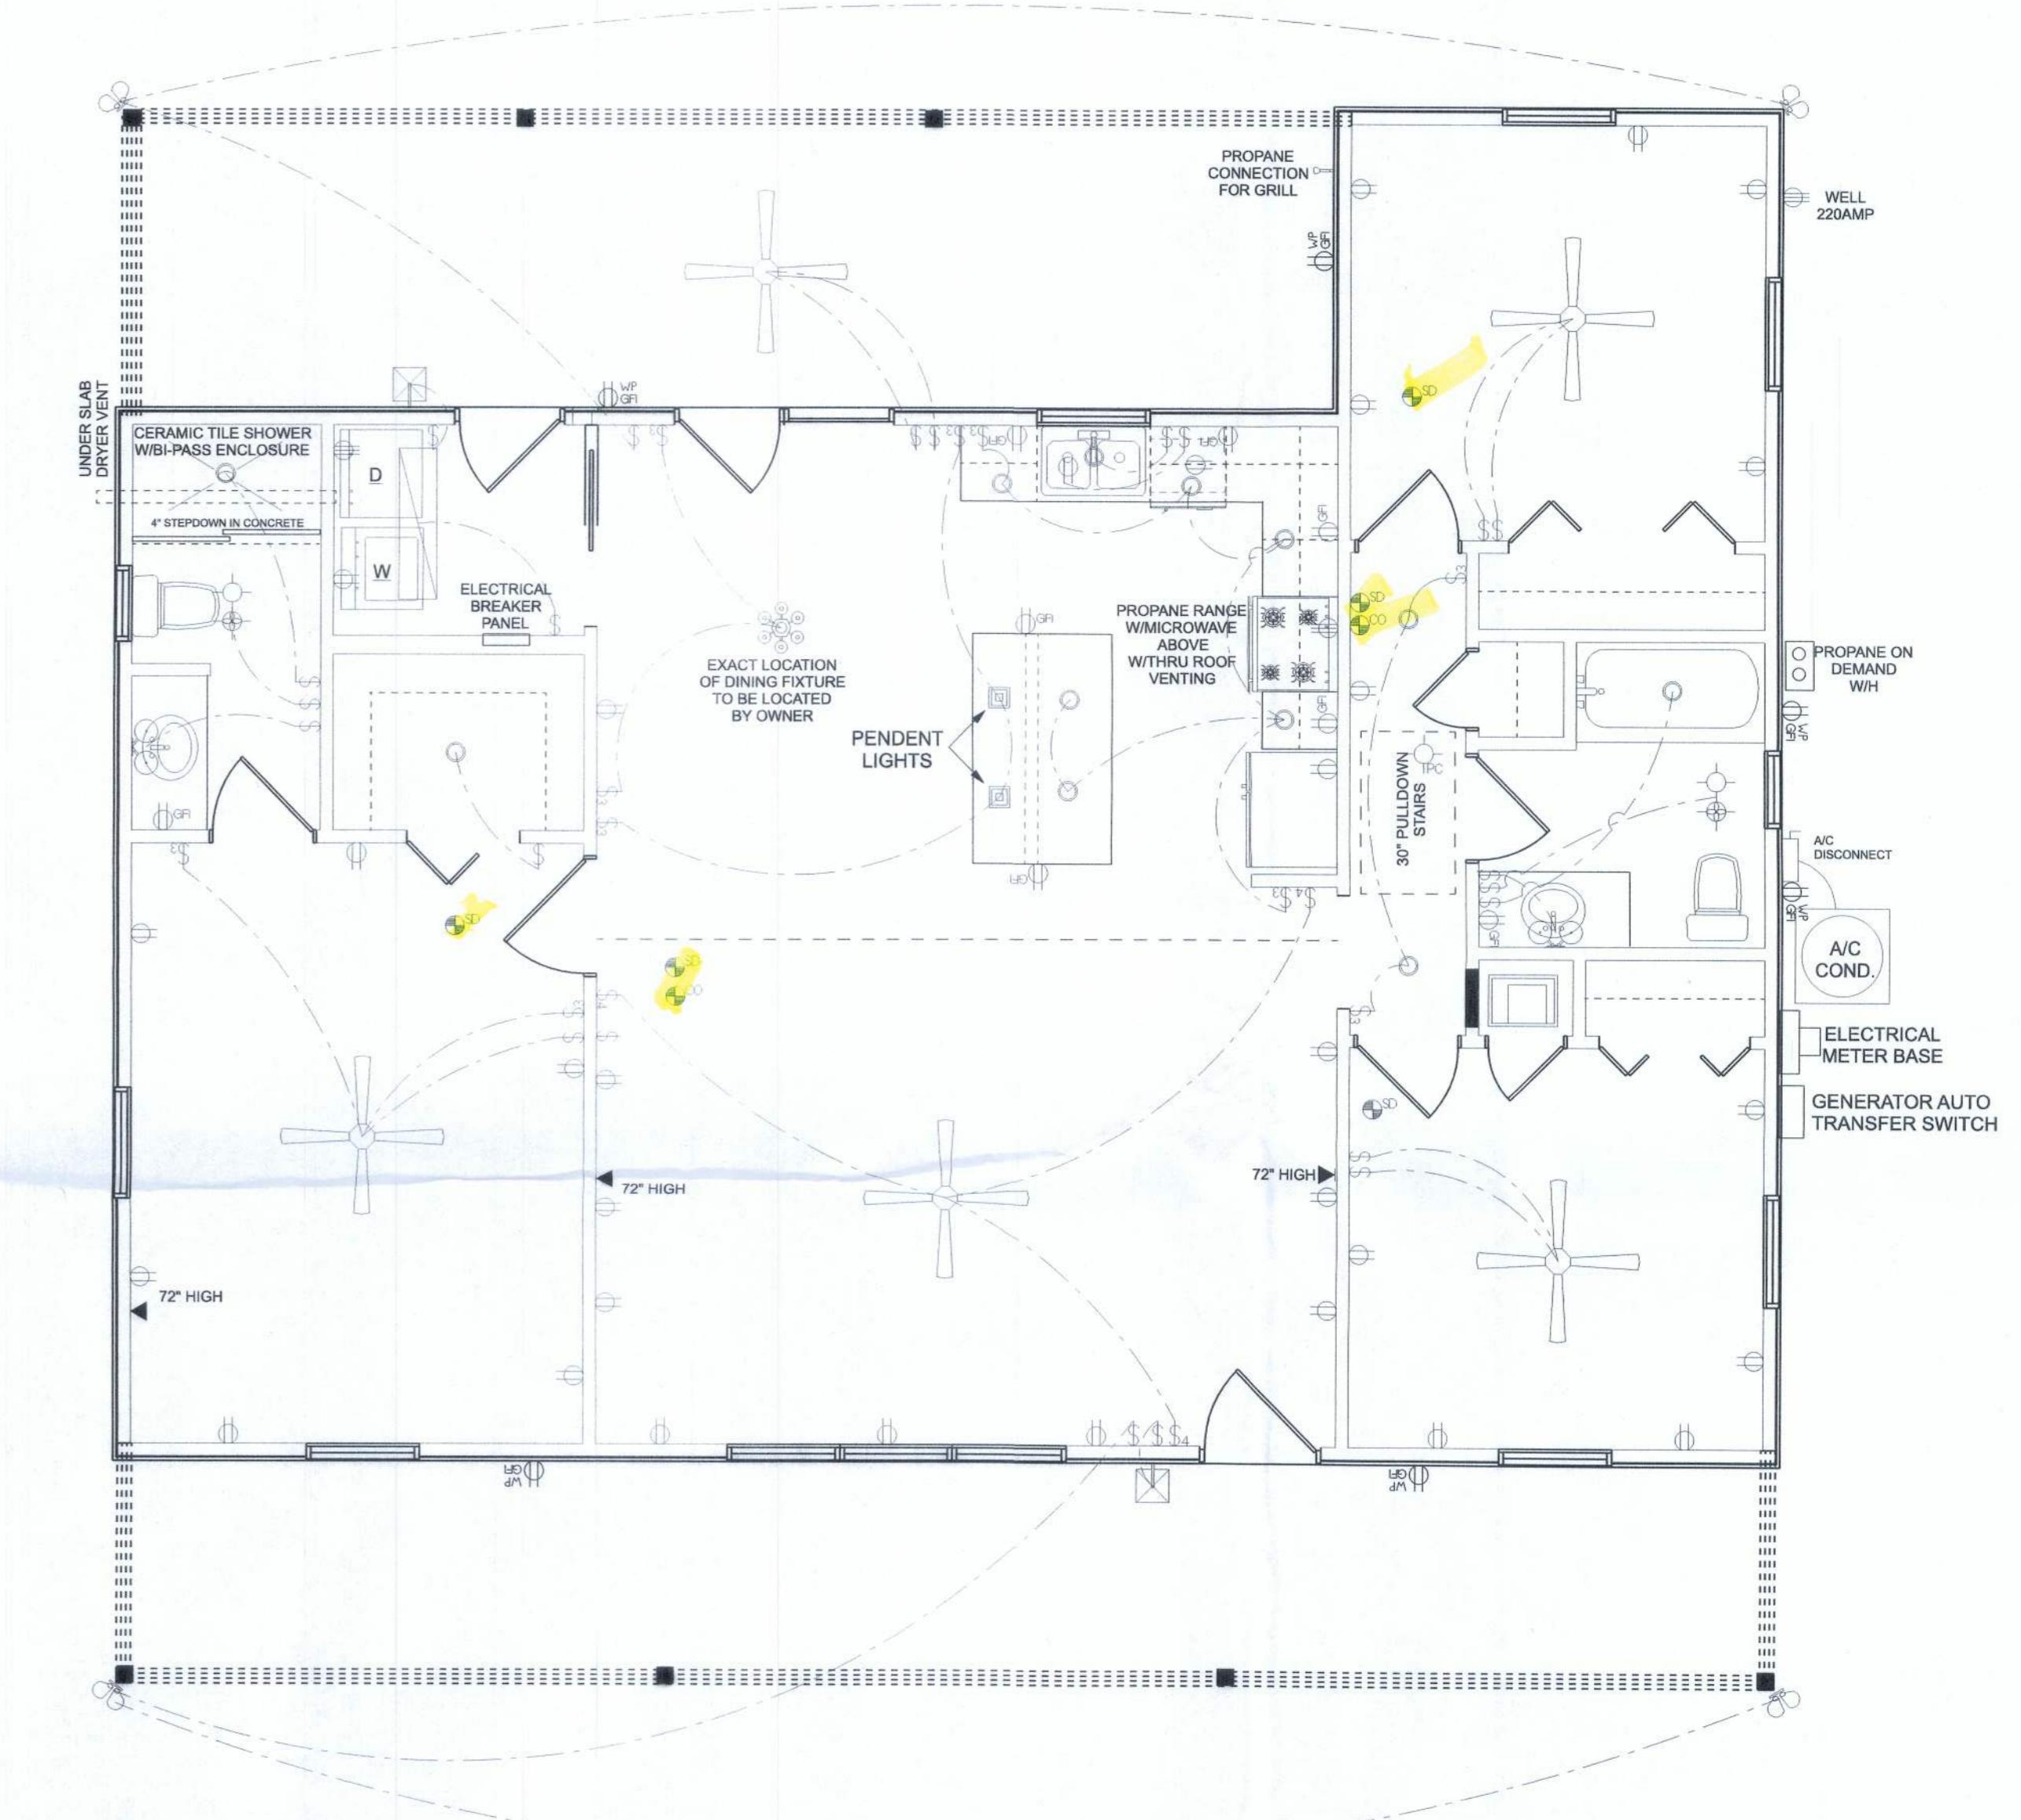

ELECTRICAL PLAN  
SCALE: 1/4" = 1'-0"

IRKINGER  
CONSTRUCTION  
GROUP

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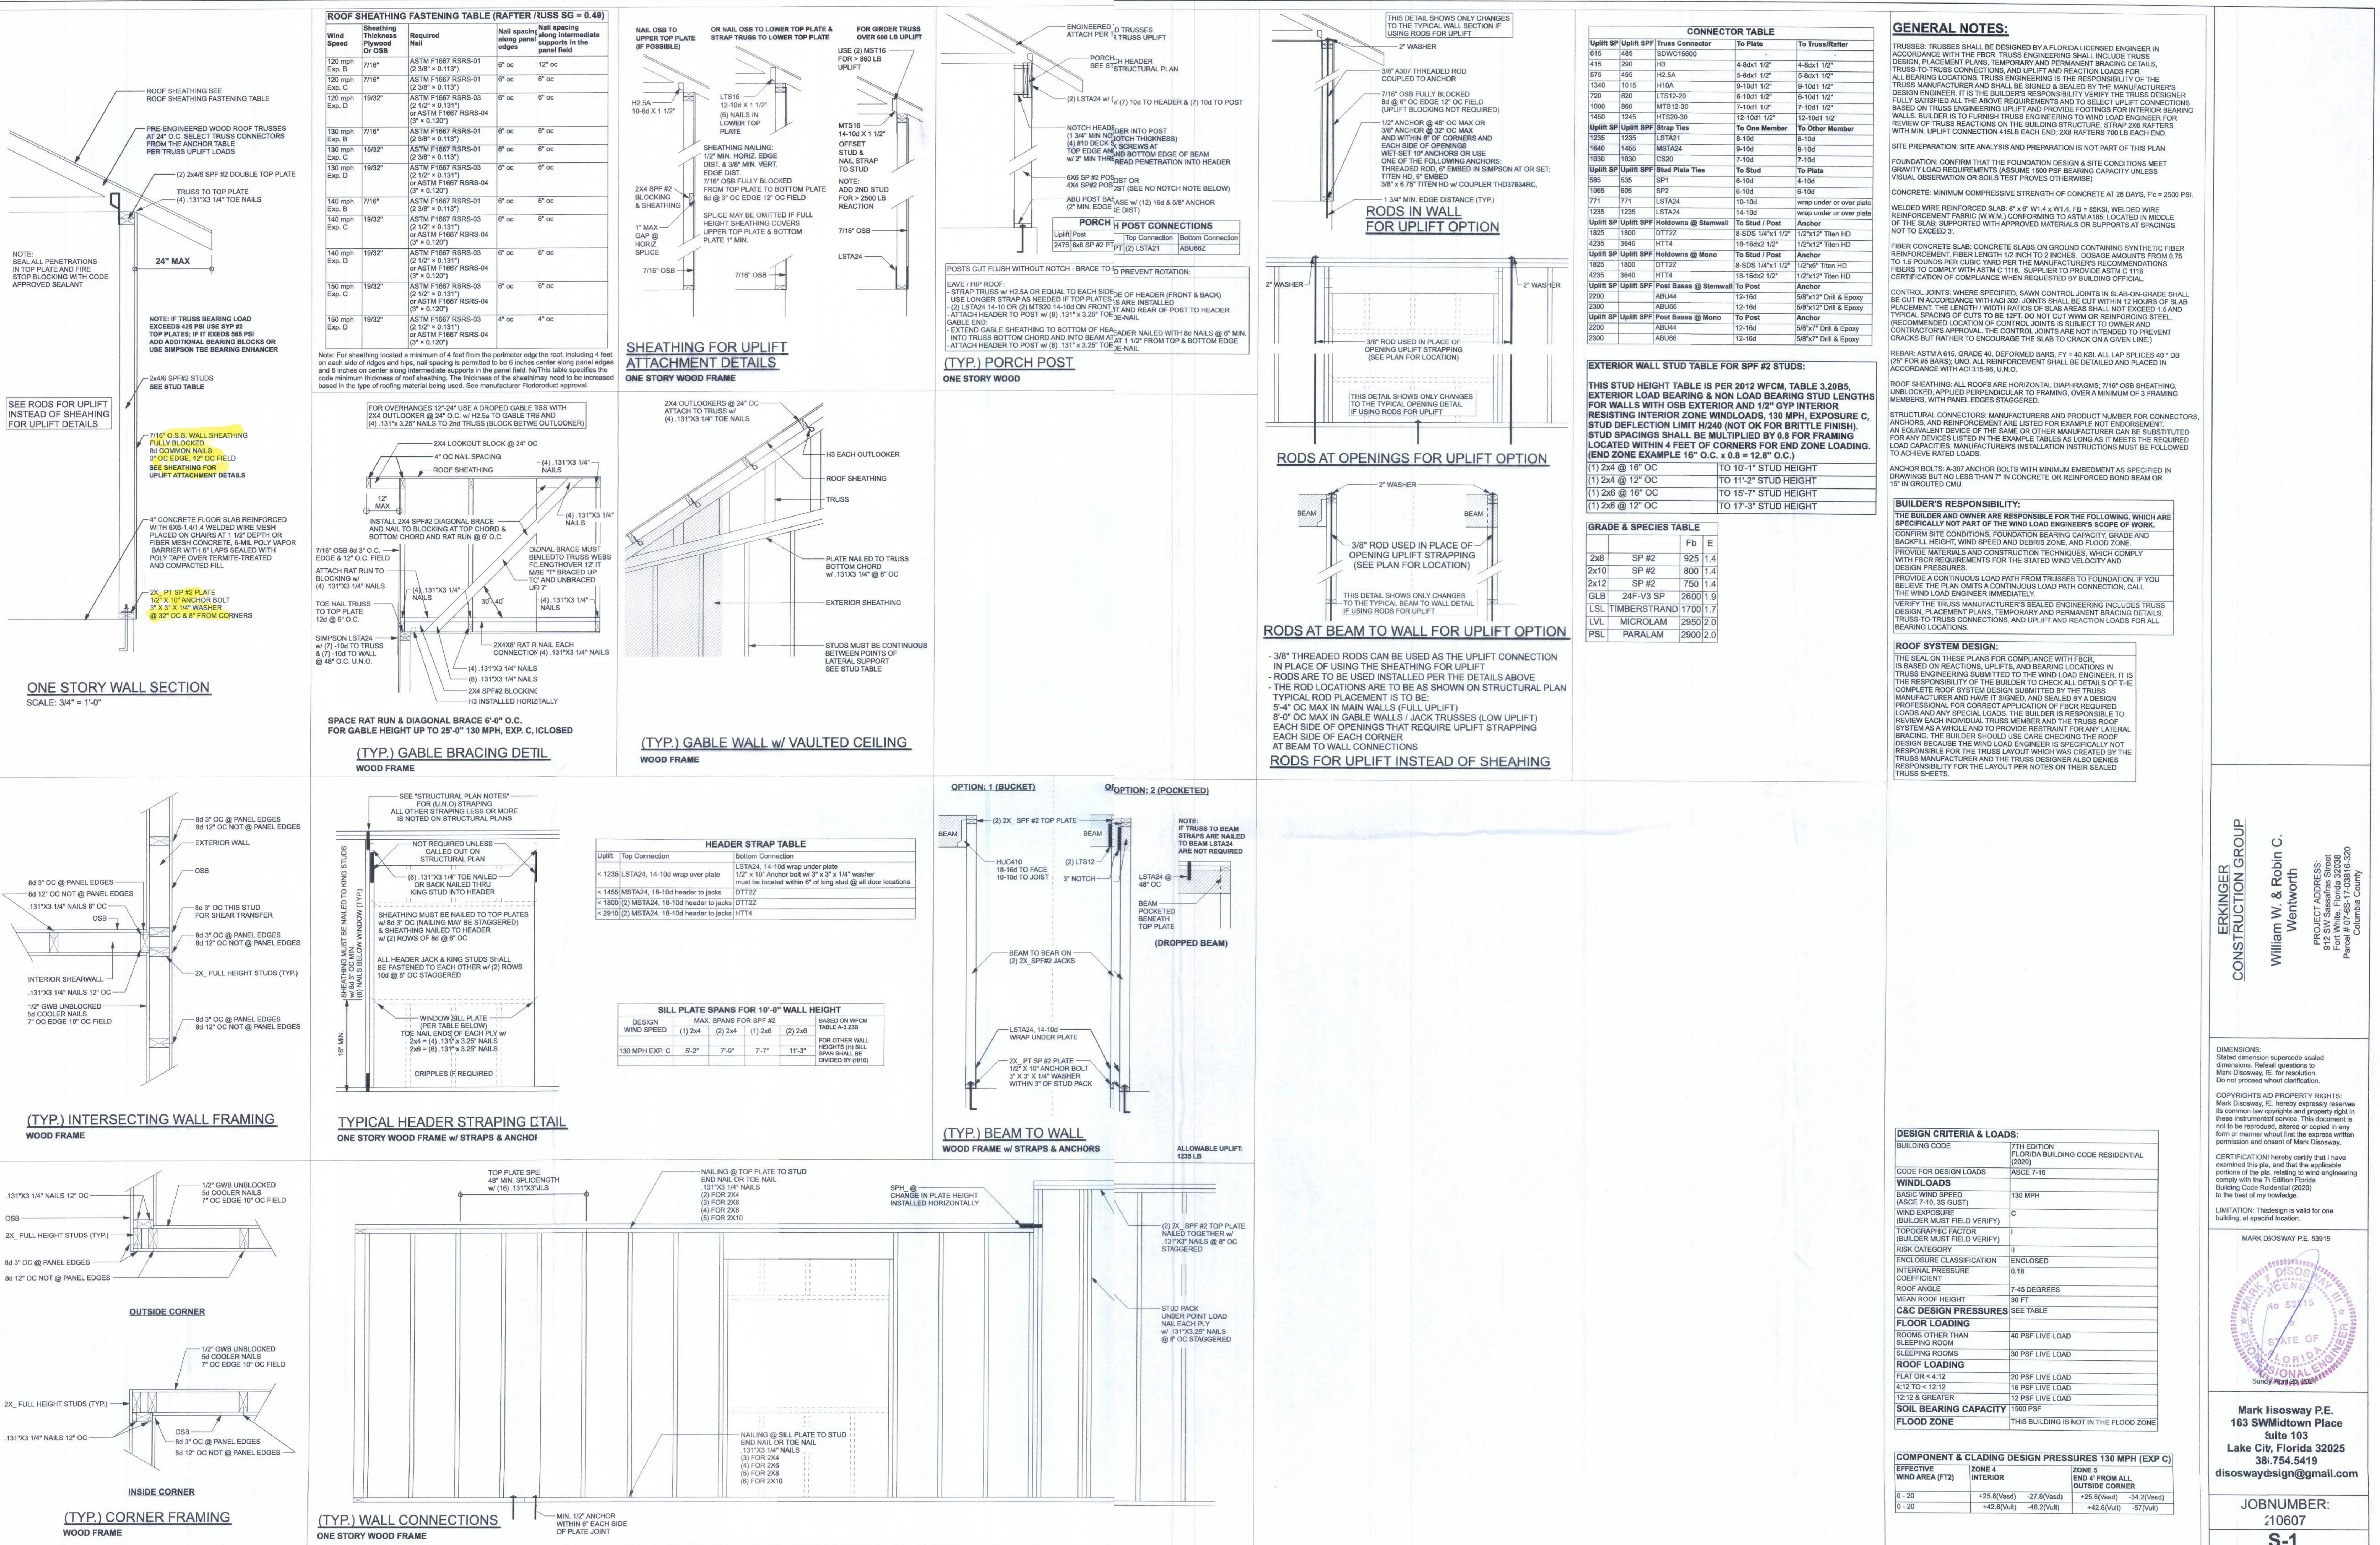
ADDRESS:  
9123W Sassafras Street  
Fort White, Florida 32038  
Columbia County

PARCEL #:  
07-65-17-03816-320

PRINTED DATE:  
Sunday, April 25, 2021

DRAWN BY:  
Matthew A Erkinger Sr.

DRAWING NUMBER



ERKINGER CONSTRUCTION GROUP  
William W. & Robin C.  
Wentworth

PROJECT ADDRESS:  
912 SW Sassafras Street  
Fort White, Florida 32038  
Columbia County



STRUCTURAL PLAN  
SCALE: 1/4" = 1'-0"

STRUCTURAL PLAN NOTES

SN-1 ALL LOAD BEARING FRAME WALL & PORCH HEADERS SHALL BE A MINIMUM OF (2) 2x6 SP #2 (U.N.O.)


SN-2 ALL LOAD BEARING FRAME WALL HEADERS SHALL HAVE (1) JACK STUD & (1) KING STUD EACH SIDE (U.N.O.)

ALL HEADERS w/ UPLIFT TO BE STRAPPED DOWN @ EACH SIDE WITH (1) LSTA24, 14-10g @ TOP & BOTTOM OF WALL WRAP UNDERSIDE BOTTOM PLATE & OVER TOP PLATE 1/2" X 10" ANCHOR BOLTS w/ 3" X 1/4" WASHER MUST BE LOCATED WITHIN 6" OF KING STUD @ ALL DOOR LOCATIONS (U.N.O.) (OR SEE ROD HOLD DOWN OPTIONS)

SN-4 USE ONE JACK STUD GIRDERS SUPPORT PER 2500 LB LOAD

DIMENSIONS ON STRUCTURAL SHEETS ARE NOT EXACT. REFER TO ARCHITECTURAL FLOOR PLAN FOR ACTUAL DIMENSIONS


PERMANENT TRUSS BRACING IS TO BE INSTALLED AT LOCATIONS AS SHOWN ON THE SEALED TRUSS DRAWINGS. LATERAL BRACING IS TO BE RESTRAINED PER BCSI-03, BCSI-B1, BCSI-B2, & BCSI-B3. BCSI-B1, BCSI-B2, & BCSI-B3 ARE FURNISHED BY THE TRUSS SUPPLIER, WITH THE SEALED TRUSS PACKAGE

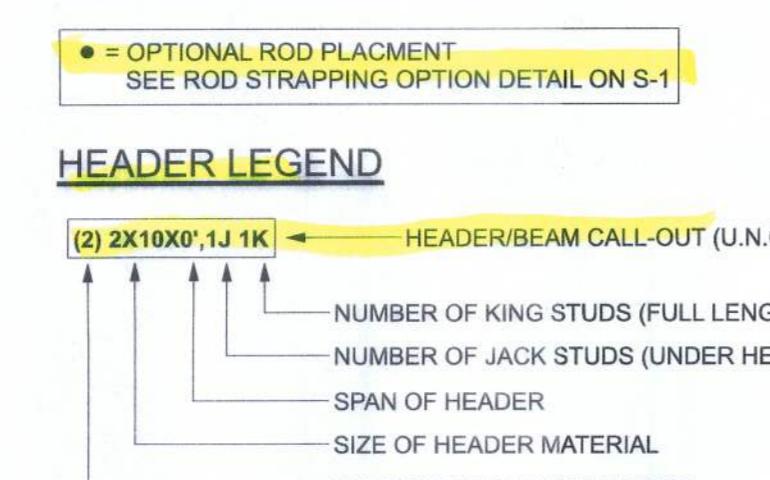


	TRANSVERSE	LONGITUDINAL
ACTUAL	19404 LBF	21186 LBF
REQUIRED	14443 LBF	10749 LBF

CONNECTIONS, WALL, & HEADER DESIGN IS BASED ON REACTIONS & UPLIFTS FROM TRUSS ENGINEERING FURNISHED BY BUILDER, SEMINOLE TRUSSES, INC	
JOB # B531724 04-09-2021	


MASONRY NOTES							
CONSTRUCTION AND MATERIALS FOR THIS PROJECT SHALL CONFORM TO ALL REQUIREMENTS OF "SPECIFICATION FOR MASONRY STRUCTURES" (ACI 530/ASCE 6/TMS 602).							
THE CONTRACTOR AND MASON MUST IMMEDIATELY, BEFORE PROCEEDING, NOTIFY THE ENGINEER OF ANY CONFLICTS BETWEEN THE 530-1-02 AND THESE DESIGN DRAWINGS. ANY EXCEPTIONS TO ACI 530-1-02 MUST BE APPROVED BY THE ENGINEER IN WRITING.							
(ACI530-1-02 8.2 Section Specific Requirements)							
1.4A Compressive strength 8" block test walls Fm = 1500 psi							
2.1 Mortar ASTM C 115, Type N, U.H.							
2.2 Grout ASTM C 476, admix, require approval							
2.3 CMU standard ASTM C 90-02, Nominal weight, Hollow, medium surface finish, 8" x 8" x 16" running bond and 12" x 12" or 16" x 16" column blocks							
2.3 Clay brick standard ASTM C 216-02, Grade SW, Type FBS, 5.5" x 7.75" x 11.5"							
2.4 Reinforcing bars, #3 - #11 ASTM 615, Grade 40, Fy = 40 ksi, Lap splices min. 12 bar diam. or 30D							
2.4F Coating for corrosion protection Anchors, shear, metal ties completely embedded in mortar or grout, ASTM A525, Class G60, 0.60 oz/in <sup>2</sup> or 304SS							
3.3.E.2 Pipes, conduits, and accessories Any not shown on the project drawings require engineering approval.							
3.3.E.7 Movement joints Contractor assumes responsibility for type and location of movement joints if not detailed on project drawings.							

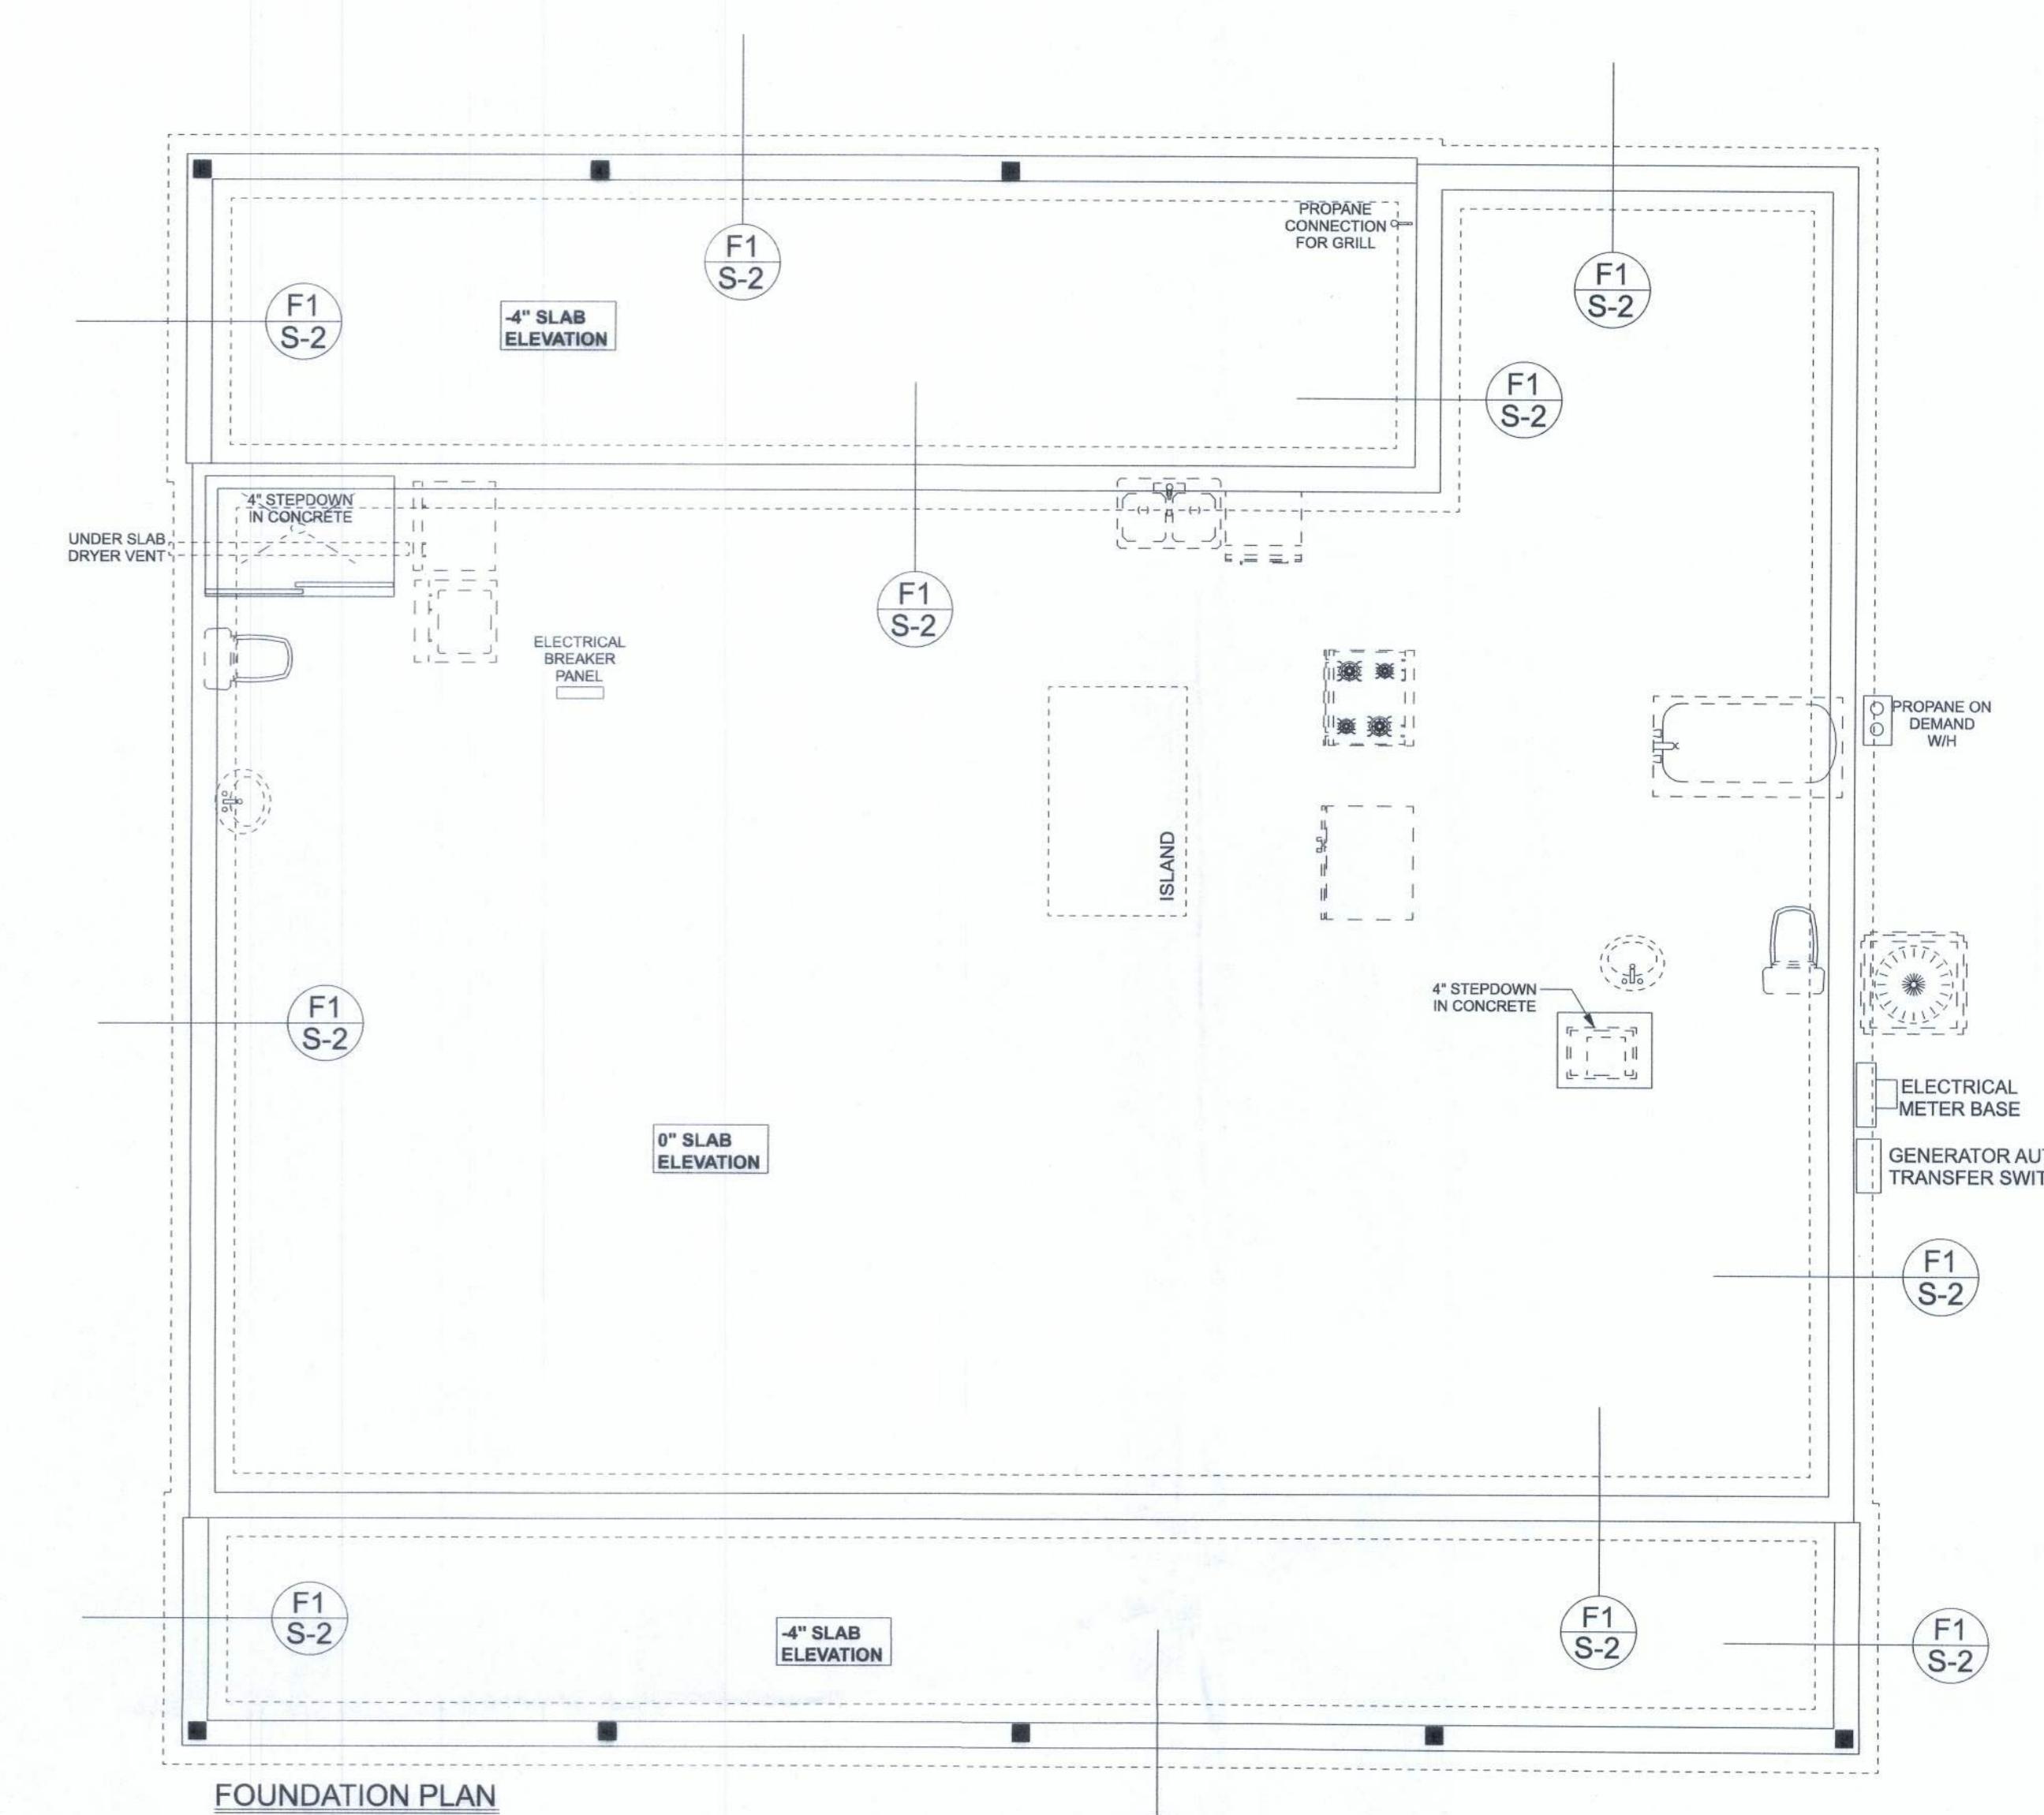

FOUNDATION NOTES							
FN - 1 DIMENSIONS ON FOUNDATION & STRUCTURAL SHEETS ARE NOT EXACT. REFER TO ARCHITECTURAL PLANS FOR ACTUAL DIMENSIONS, RECESSES IN SLAB, STEPDOWN, ETC. DESIGNER IS RESPONSIBLE FOR MARKING DRAWINGS. CONTRACTOR IS NOT RESPONSIBLE FOR DIMENSION ERRORS ON THIS PLAN.							
FN - 2 CONTRACTOR SHALL VERIFY NEED FOR INTERIOR BEARING WRAPS AND PROVIDE DETAILS IN TRUSS PLAN (BY THE SUPPLIER) BEFORE FINALIZING FOUNDATION PLAN.							
FN - 3 THE SLAB SHALL BE 4" CONCRETE SLAB REINFORCED w/ 6X6-1/4" WELDED WIRE MESH PLACED ON CHAIRS @ 6" OC. 1/2" MIN. TOP SLAB THICKNESS. 6-MIL POLY VAPOR BARRIER w/ 6" LAPS SEALED w/ POLY TAPE OVER TERMITE-TREATED & COMPAKTED FILL.							

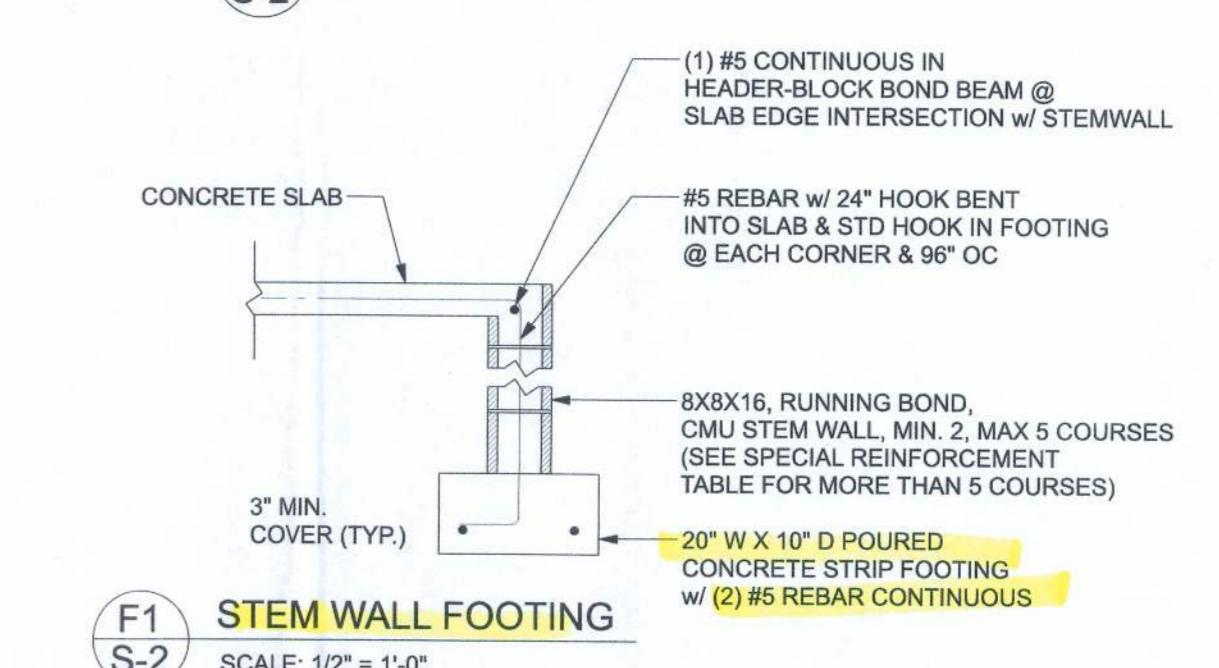

STEM WALL FOOTING  
SCALE: 1/2" = 1'-0"

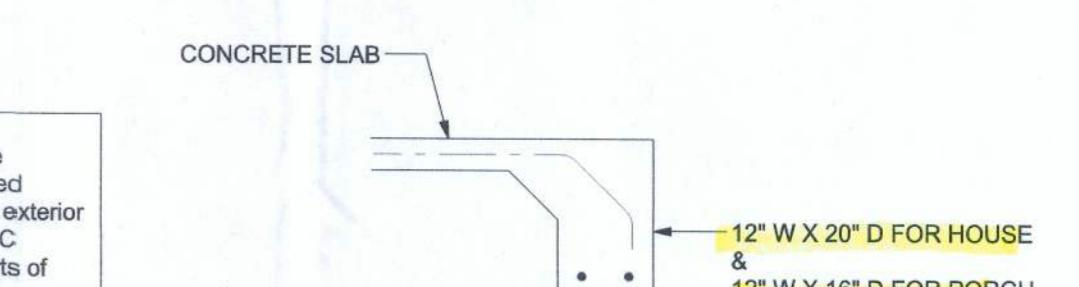

OPTIONAL MONOLITHIC FOOTING  
SCALE: 1/2" = 1'-0"

BOTTOM OF EXTERIOR FOOTINGS SHALL BE A MINIMUM OF 12" BELOW UNDISTURBED SOIL OR ENGINEERED FILL PER FBC 2017-RES. SECTION R403.14

ERKINGER CONSTRUCTION GROUP

William W. & Robin C. Wentworth

PROJECT ADDRESS:  
912 SW Sassafras Street  
Port St. Lucie, FL 34983  
Parco # B17-2300  
Columbia County

DIMENSIONS: Stated dimensions supersede scaled dimensions. Refer all questions to Mark Disosway P.E. Do not process without clarification.

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CERTIFICATION: I hereby certify that I have examined the above drawings and the applicable portions of the plan, relating to wind engineering, comply with the Florida Building Code-Residential (2020) to the best of my knowledge.

LIMITATION: This design is valid for one building, as specified on the plan.

MARIOOSWAY P.E. S391



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JO# NUMBER:  
210607  
S-2  
#F 2 SHEETS