



ATC SITE NAME: FIVE POINTS ATC SITE NUMBER: 2543

VERIZON SITE NAME: ATC FIVE POINTS

VERIZON SITE NUMBER:131297

SITE ADDRESS: 3501 N US HWY 441

LAKE CITY, FL 32055

VERIZON ANTENNA AMENDMENT DRAWINGS



LOCATION MAP

Scott Fletcher/

Digitally signed by Scott Fletcher Date: 2021.09.24 13:13:25 -04'00'

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COMPLIANCE CODE	PROJECT SU	MMARY	PROJECT DESCRIPTION		SHEET INDEX				╛
ALL WORK SHALL BE PERFORMED AND MATERIALS INSTALLED IN ACCORDANCE WITH THE CURRENT EDITIONS OF THE	SITE ADDRE		THE PROPOSED PROJECT INCLUDES MODIFYING GROUND BASED AND TOWER MOUNTED EQUIPMENT AS INDICATED PER BELOW:	SHEET NO:	DESCRIPTION:	REV:	DATE:	BY:	
FOLLOWING CODES AS ADOPTED BY THE LOCAL GOVERNMENT AUTHORITIES. NOTHING IN THESE PLANS IS	3501 N US HWY 441		REMOVE (9) ANTENNA(s) AND (2) 1-5/8" COAX CABLE(s)	G-001	TITLE SHEET	1	09/24/21	тс	1
TO BE CONSTRUED TO PERMIT WORK NOT CONFORMING TO THESE CODES.	LAKE CITY, FL COUNTY: COLI		INSTALL (9) ANTENNA(s), (6) RRH(s), (3) DIPLEXER(s) AND (2) OVP(s)	G-002	GENERAL NOTES	0	09/21/21	тс	7
2020 FLORIDA BUILDING CODE, 7TH EDITION	GEOGRAPHIC COO		EXISTING (10) 1-5/8" COAX CABLE(s), AND (2) 1-5/8" HYBRID CABLE(s)	C-101	DETAILED SITE PLAN	0	09/21/21	тс	1
2. ANSI/TIA-222-H 3. 6TH EDITION FLORIDA FIRE PREVENTION CODE (NFPA 70)	LATITUDE: 30.23		TO REMAIN GROUND WORK:	C-102	GROUND EQUIPMENT LAYOUT	0	09/21/21	TC	1
4. 2014 NATIONAL ELECTRICAL CODE	LONGITUDE: -82.6		REMOVE (2) 6101 CABINET(S), (1) ATS(S), (1) 30KW GENERATOR(S), (1)	C-201	TOWER ELEVATION	0	09/21/21	TC	1
 BASIC WIND SPEED: 129 MPH (3-SECOND GUST) CITY/COUNTY ORDINANCES 	GROUND ELEVATION	N: 148' AMSL	PPC(S), AND BATTERIES.	C-401	ANTENNA INFORMATION & SCHEDULE	0	09/21/21	TC	
			INSTALL (1) CONSOLIDATED EQUIPMENT AND POWER CABINET(S), (1) 50KW GENERATOR(S), (1) 200A ILC(S), (1) POWERPLANT, (5) STRINGS	C-501	CONSTRUCTION DETAILS	0	09/21/21	TC	1
			AT 48V(S) AND (2) STRINGS AT 24V FOR CDMA OF DEKA 170ET./BRS		CONSTRUCTION DETAILS	0	09/21/21	TC	1
				E-101	CONDUIT LAYOUT	0	09/21/21	TC	1
	PROJECT 1	ГЕАМ	PROJECT NOTES	E-501	GROUNDING DETAILS	0	09/21/21	TC	1
	TOWER OWNER:	APPLICANT:	THE FACILITY IS UNMANNED. A TECHNICIAN WILL VISIT THE SITE APPROXIMATELY ONCE A	E-601	ONE-LINE DIAGRAM	0	09/21/21	TC	
	AMERICAN TOWER	VERIZON WIRELESS	MONTH FOR ROUTINE INSPECTION AND MAINTENANCE. 3. THE PROJECT WILL NOT RESULT IN ANY SIGNIFICANT LAND	E-602	PANEL SCHEDULE AND ELECTRICAL DETAILS	0	09/21/21	TC	
	10 PRESIDENTIAL WAY WOBURN, MA 01801		DISTURBANCE OR EFFECT OF STORM WATER DRAINAGE. 4. NO SANITARY SEWER. POTABLE WATER OR TRASH DISPOSAL	R-601	SUPPLEMENTAL				
UTILITY COMPANIES	ENGINEER:		IS REQUIRED. 5. HANDICAP ACCESS IS NOT REQUIRED.	R-602	SUPPLEMENTAL				7
POWER COMPANY: FLORIDA POWER LIGHT PHONE: (800) 226-3545	ATC TOWER SERVICES, LLC		HANDICAF ACCESS IS NOT REQUIRED. THE PROJECT DEPICTED IN THESE PLANS QUALIFIES AS AN ELIGIBLE FACILITIES REQUEST ENTITLED TO EXPEDITED.	R-603	SUPPLEMENTAL				1
TELEPHONE COMPANY: BELLSOUTH	3500 REGENCY PKWY STE 100 CARY, NC 27518		REVIEW UNDER 47 U.S.C. § 1455(A) AS A MODIFICATION OF AN EXISTING WIRELESS TOWER THAT INVOLVES THE	R-604	SUPPLEMENTAL				1
PHONE: (800) 252-0803	PROPERTY OWNER:		COLLOCATION, REMOVAL, AND/OR REPLACEMENT OF						
6000	DAVID H GOOLSBY JR		TRANSMISSION EQUIPMENT THAT IS NOT A SUBSTANTIAL CHANGE UNDER CFR § 1.61000 (B)(7).						1
211	9198 SW CR 249 JASPER. FL 32052		PROJECT LOCATION DIRECTIONS						1
	,								
			FROM I-10 TAKE EXIT #44 SOUTHEAST CORNER OF THE						
Know what's below.			TEXACO TRUCK STOP AT SOUTHEAST CORNER OF I-10 AND HWY 441.						1
Call before you dig.									7



ATC TOWER SERVICES, LLC

3500 REGENCY PARKWAY SUITE 100 CARY, NC 27518 PHONE: (919) 468-0112 COA: 9053

THE USE AND PUBLICATION OF THESE DRAWINGS SHALL BE RESTRICTED TO THE ORIGINAL SITE FOR WHICH THEY ARE PREPARED. ANY USE OR DISCLOSURE OTHER THAN THAT WHICH RELATES TO AMERICAN TOWER OR THE SPECIFIED CARRIER IS STRICTLY PROHIBITED. NEITHER THE ARCHITECT NOR THE ENGINEER WILL BE PROVIDING ON-SITE CONSTRUCTION REVIEW OF THIS PROJECT. CONTRACTOR(S) MUST VERIFY ALL DIMENSIONS AND ADVISE AMERICAN TOWER OR THE SPECIFIED CARRIER OF ANY DISCREPANCIES. ANY PRIOR ISSUANCE OF THIS DRAWING IS SUPERSEDED BY THE LATEST VERSION.

REV.	DESCRIPTION	BY	DATE
△_	FOR CONSTRUCTION	TC_	09/21/21
1	SUPPLEMENTAL UPDT	TC_	09/24/21
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VERIZON SITE NAME:

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DATE DRAWN:	09/21/21				
ATC JOB NO:	13686745_D1				
CUSTOMER ID:	ATC FIVE POINTS				
CUSTOMER #:	131297				

TITLE SHEET

G-001

GENERAL CONSTRUCTION NOTES:

- OWNER FURNISHED MATERIALS, VERIZON "THE COMPANY" WILL PROVIDE AND THE CONTRACTOR WILL INSTALL
- A. BTS EQUIPMENT FRAME (PLATFORM) AND ICEBRIDGE SHELTER (GROUND BUILD/CO-LOCATE ONLY)
- AC/TELCO INTERFACE BOX (PPC)
- ICE BRIDGE (CABLE TRAY WITH COVER) (GROUND BUILD/CO-LOCATE ONLY, GC TO FURNISH AND INSTALL FOR ROOFTOP INSTALLATION)
- D. TOWERS, MONOPOLES
- TOWER LIGHTING
- GENERATORS & LIQUID PROPANE TANK
- ANTENNA STANDARD BRACKETS, FRAMES AND PIPES FOR MOUNTING
- ANTENNAS (INSTALLED BY OTHERS)
- TRANSMISSION LINE
- TRANSMISSION LINE JUMPERS
- TRANSMISSION LINE CONNECTORS WITH WEATHERPROOFING KITS
- TRANSMISSION LINE GROUND KITS
- HANGERS
- HOISTING GRIPS
- O. BTS EQUIPMENT
- THE CONTRACTOR IS RESPONSIBLE TO PROVIDE ALL OTHER MATERIALS FOR THE COMPLETE INSTALLATION OF THE SITE INCLUDING, BUT NOT LIMITED TO, SUCH MATERIALS AS FENCING, STRUCTURAL STEEL SUPPORTING SUB-FRAME FOR PLATFORM, ROOFING LABOR AND MATERIALS GROUNDING RINGS GROUNDING WIRES COPPER-CLAD OR XIT CHEMICAL GROUND ROD(S), BUSS BARS, TRANSFORMERS AND DISCONNECT SWITCHES WHERE APPLICABLE, TEMPORARY ELECTRICAL POWER, CONDUIT, LANDSCAPING COMPOUND STONE, CRANES, CORE DRILLING, SLEEPERS AND RUBBER MATTING, REBAR, CONCRETE CAISSONS, PADS AND/OR AUGER MOUNTS, MISCELLANEOUS FASTENERS, CABLE TRAYS, NON-STANDARD ANTENNA FRAMES AND ALL OTHER MATERIAL AND LABOR REQUIRED TO COMPLETE THE JOB ACCORDING TO THE DRAWINGS AND SPECIFICATIONS. IT IS THE POSITION OF VERIZON TO APPLY FOR PERMITTING AND CONTRACTOR RESPONSIBLE FOR PICKUP AND PAYMENT OF REQUIRED
- ALL WORK SHALL CONFORM TO ALL CURRENT APPLICABLE FEDERAL, STATE, AND LOCAL CODES, INCLUDING ANSI/EIA/TIA-222, AND COMPLY WITH ATC CONSTRUCTION
- CONTRACTOR SHALL CONTACT LOCAL 811 FOR IDENTIFICATION OF UNDERGROUND
- CONTRACTOR SHALL BE RESPONSIBLE FOR COORDINATING ALL REQUIRED INSPECTIONS.
- ALL DIMENSIONS TO, OF, AND ON EXISTING BUILDINGS, DRAINAGE STRUCTURES, AND SITE IMPROVEMENTS SHALL BE VERIFIED IN FIELD BY CONTRACTOR WITH ALL DISCREPANCIES REPORTED TO THE ENGINEER.
- DO NOT CHANGE SIZE OR SPACING OF STRUCTURAL ELEMENTS
- DETAILS SHOWN ARE TYPICAL: SIMILAR DETAILS APPLY TO SIMILAR CONDITIONS UNLESS
- THESE DRAWINGS DO NOT INCLUDE NECESSARY COMPONENTS FOR CONSTRUCTION SAFETY WHICH SHALL BE THE SOLE RESPONSIBILITY OF THE CONTRACTOR
- CONTRACTOR SHALL BRACE STRUCTURES UNTIL ALL STRUCTURAL ELEMENTS NEEDED FOR STABILITY ARE INSTALLED. THESE ELEMENTS ARE AS FOLLOWS: LATERAL BRACING,
- CONTRACTOR SHALL DETERMINE EXACT LOCATION OF EXISTING UTILITIES. GROUNDS DRAINS, DRAIN PIPES, VENTS, ETC, BEFORE COMMENCING WORK
- INCORRECTLY FABRICATED, DAMAGED, OR OTHERWISE MISFITTING OR NONCONFORMING MATERIALS OR CONDITIONS SHALL BE REPORTED TO THE VERIZON REP PRIOR TO REMEDIAL OR CORRECTIVE ACTION, ANY SUCH REMEDIAL ACTION SHALL REQUIRE WRITTEN APPROVAL BY THE VERIZON REP PRIOR TO PROCEEDING.
- EACH CONTRACTOR SHALL COOPERATE WITH THE VERIZON REP, AND COORDINATE HIS WORK WITH THE WORK OF OTHERS.
- CONTRACTOR SHALL REPAIR ANY DAMAGE CAUSED BY CONSTRUCTION OF THIS PROJECT TO MATCH EXISTING PRE-CONSTRUCTION CONDITIONS TO THE SATISFACTION
- ALL CABLE/CONDUIT ENTRY/EXIT PORTS SHALL BE WEATHERPROOFED DURING 15. INSTALLATION LISING A SILICONE SEALANT
- WHERE EXISTING CONDITIONS DO NOT MATCH THOSE SHOWN IN THIS PLAN SET. CONTRACTOR SHALL NOTIFY THE VERIZON REP AND ENGINEER OF RECORD
- CONTRACTOR SHALL ENSURE ALL SUBCONTRACTORS ARE PROVIDED WITH A COMPLETE AND CURRENT SET OF DRAWINGS AND SPECIFICATIONS FOR THIS PROJECT
- CONTRACTOR SHALL REMOVE ALL RUBBISH AND DEBRIS FROM THE SITE AT THE END OF
- CONTRACTOR SHALL COORDINATE WORK SCHEDULE WITH AMERICAN TOWER CORPORATION (ATC) AND TAKE PRECAUTIONS TO MINIMIZE IMPACT AND DISRUPTION OF OTHER OCCUPANTS OF THE FACILITY.
- CONTRACTOR SHALL FURNISH VERIZON AND AMERICAN TOWER CORPORATION (ATC) ITH A PDF MARKED UP AS-BUILT SET OF DRAWINGS UPON COMPLETION OF WORK
- PRIOR TO SUBMISSION OF BID. CONTRACTOR SHALL COORDINATE WITH VERIZON, REP. TO DETERMINE WHAT, IF ANY, ITEMS WILL BE PROVIDED. ALL ITEMS NOT PROVIDED SHALL BE PROVIDED AND INSTALLED BY THE CONTRACTOR. CONTRACTOR WILL INSTALL

- 22. PRIOR TO SUBMISSION OF BID. CONTRACTOR SHALL COORDINATE WITH VERIZON REP TO DETERMINE IF ANY PERMITS WILL BE OBTAINED BY CONTRACTOR. ALL REQUIRED PERMITS NOT OBTAINED BY VERIZON MUST BE OBTAINED, AND PAID FOR, BY THE
- 23. CONTRACTOR SHALL INSTALL ALL SITE SIGNAGE IN ACCORDANCE WITH VERIZON SPECIFICATIONS AND REQUIREMENTS.
- 24. CONTRACTOR SHALL SUBMIT ALL SHOP DRAWINGS TO VERIZON FOR REVIEW AND
- ALL EQUIPMENT SHALL BE INSTALLED ACCORDING TO MANUFACTURER'S SPECIFICATIONS AND LOCATED ACCORDING TO VERIZON SPECIFICATIONS, AND AS SHOWN IN THESE PLANS
- 26. THE CONTRACTOR SHALL SUPERVISE AND DIRECT THE PROJECT DESCRIBED HEREIN THE CONTRACTOR SHALL BE SOLELY RESPONSIBLE FOR ALL THE CONSTRUCTION MEANS, METHODS, TECHNIQUES, SEQUENCES AND PROCEDURES AND FOR COORDINATING ALL PORTIONS OF THE WORK UNDER THE CONTRACT.
- CONTRACTOR SHALL NOTIFY VERIZON REP A MINIMUM OF 48 HOURS IN ADVANCE OF POURING CONCRETE OR BACKFILLING ANY UNDERGROUND UTILITIES, FOUNDATIONS OR SEALING ANY WALL, FLOOR OR ROOF PENETRATIONS FOR ENGINEERING REVIEW AND
- CONTRACTOR SHALL BE RESPONSIBLE FOR SITE SAFETY INCLUDING COMPLIANCE WITH ALL APPLICABLE OSHA STANDARDS AND RECOMMENDATIONS AND SHALL PROVIDE ALL NECESSARY SAFETY DEVICES INCLUDING PPE AND PPM AND CONSTRUCTION DEVICES SUCH AS WELDING AND FIRE PREVENTION, TEMPORARY SHORING, SCAFFOLDING, TRENCH BOXES/SLOPING, BARRIERS, ETC.
- THE CONTRACTOR SHALL PROTECT AT HIS OWN EXPENSE ALL EXISTING FACILITIES AND SUCH OF HIS NEW WORK LIABLE TO INJURY DURING THE CONSTRUCTION PERIOD. ANY DAMAGE CAUSED BY NEGLECT ON THE PART OF THIS CONTRACTOR OR HIS REPRESENTATIVES, OR BY THE ELEMENTS DUE TO NEGLECT ON THE PART OF THIS CONTRACTOR OR HIS REPRESENTATIVES, EITHER TO THE EXISTING WORK, OR TO HIS WORK OR THE WORK OF ANY OTHER CONTRACTOR, SHALL BE REPAIRED AT HIS EXPENSE TO THE OWNER'S SATISFACTION.
- ALL WORK SHALL BE INSTALLED IN A FIRST CLASS, NEAT AND WORKMANLIKE MANNER BY MECHANICS SKILLED IN THE TRADE INVOLVED. THE QUALITY OF WORKMANSHIP SHALL BE SUBJECT TO THE APPROVAL OF THE VERIZON REP. ANY WORK FOUND BY THE VERIZON REP TO BE OF INFERIOR QUALITY AND/OR WORKMANSHIP SHALL BE REPLACED AND/OR REWORKED AT CONTRACTOR EXPENSE UNTIL APPROVAL IS
- 31. IN ORDER TO ESTABLISH STANDARDS OF QUALITY AND PERFORMANCE, ALL TYPES OF MATERIALS LISTED HEREINAFTER BY MANUFACTURER'S NAMES AND/OR
 MANUFACTURER'S CATALOG NUMBER SHALL BE PROVIDED BY THESE MANUFACTURERS
- VERIZON FURNISHED EQUIPMENT SHALL BE PICKED-UP AT THE VERIZON WAREHOUSE NO LATER THAN 48HR AFTER BEING NOTIFIED INSURED, STORED, UNCRATE, PROTE AND INSTALLED BY THE CONTRACTOR WITH ALL APPURTENANCES REQUIRED TO PLACE THE EQUIPMENT IN OPERATION, READY FOR USE. THE CONTRACTOR SHALL BE RESPONSIBLE FOR THE EQUIPMENT AFTER PICKING IT UP.
- VERIZON OR HIS ARCHITECT/ENGINEER RESERVES THE RIGHT TO REJECT ANY 33. EQUIPMENT OR MATERIALS WHICH, IN HIS OWN OPINION ARE NOT IN COMPLIANCE WITH THE CONTRACT DOCUMENTS, EITHER BEFORE OR AFTER INSTALLATION AND THE EQUIPMENT SHALL BE REPLACED WITH EQUIPMENT CONFORMING TO THE REQUIREMENTS OF THE CONTRACT DOCUMENTS BY THE CONTRACTOR AT NO COST TO VERIZON OR THEIR ARCHITECT/ENGINEER

SPECIAL CONSTRUCTION ANTENNA INSTALLATION NOTES:

- WORK INCLUDED:
 - ANTENNA AND COAXIAL CABLES ARE FURNISHED BY VERIZON UNDER A SEPARATE CONTRACT. THE CONTRACTOR SHALL ASSIST ANTENNA INSTALLATION CONTRACTOR IN TERMS OF COORDINATION AND SITE ACCESS ERECTION SUBCONTRACTOR SHALL BE RESPONSIBLE FOR THE PROTECTION OF
 - B. INSTALL ANTENNA AS INDICATE ON DRAWINGS AND VERIZON SPECIFICATIONS
 - C. INSTALL GALVANIZED STEEL ANTENNA MOUNTS AS INDICATED ON DRAWINGS
 - D. INSTALL FURNISHED GALVANIZED STEEL OR ALUMINUM WAVEGUIDE
 - CONTRACTOR SHALL PROVIDE FOUR (4) SETS OF SWEEP TESTS USING ANRITZU-PACKARD 8713B RF SCALAR NETWORK ANALYZER, SUBMIT FREQUENCY DOMAIN REFLECTOMETER(FDR) TESTS RESULTS TO THE PROJECT MANAGER. SWEEP TESTS SHALL BE AS PER ATTACHED RFS "MINIMUM FIELD TESTING RECOMMENDED FOR ANTENNA AND HELIAX COAXIAL CABLE SYSTEMS" DATED 10/5/93 TESTING SHALL BE PERFORMED BY AN INDEPENDENT TESTING SERVICE AND BE BOUND AND SUBMITTED WITHIN ONE WEEK OF WORK COMPLETION
 - INSTALL COAXIAL CABLES AND TERMINATING BETWEEN ANTENNAS AND EQUIPMENT PER MANUFACTURER'S RECOMMENDATIONS, WEATHERPROOF ALL CONNECTIONS BETWEEN THE ANTENNA AND EQUIPMENT PER MANUFACTURER'S REQUIREMENTS. TERMINATE ALL COAXIAL CABLE THREE (3) FEET IN EXCESS OF ENTRY PORT LOCATION UNLESS OTHERWISE STATED.
 - G ANTENNA AND COAXIAL CABLE GROUNDING:
- ALL EXTERIOR #6 GREED GROUND WIRE "DAISY CHAIN" CONNECTIONS ARE TO BE WEATHER SEALED WITH RFS CONNECTORS/SPLICE WEATHERPROOFING KIT #221213 OR
- ALL COAXIAL CABLE GROUNDING KITS ARE TO BE INSTALLED ON STRAIGHT RUNS OF

ALL DISCREPANCIES FROM WHAT IS SHOWN ON THESE CONSTRUCTION DRAWINGS SHALL BE COMMUNICATED TO ATC ENGINEERING IMMEDIATELY FOR CORRECTION OR RE-DESIGN FAILURE TO COMMUNICATE DIRECTLY WITH ATC ENGINEERING OR ANY CHANGES FROM THE DESIGN CONDUCTED WITHOUT PRIOR APPROVAL FROM ATC ENGINEERING SHALL BE THE SOLE RESPONSIBILITY OF THE GENERAL CONTRACTOR.



ATC TOWER SERVICES, LLC

3500 REGENCY PARKWAY SUITE 100 **CARY, NC 27518** PHONE: (919) 468-0112 COA: 9053

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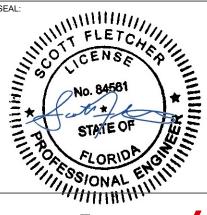
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VERIZON SITE NAME:

ATC FIVE POINTS

SITE ADDRESS 3501 N US HWY 441 LAKE CITY, FL 32055





DATE DRAWN: 09/21/21 ATC JOB NO: 13686745 D1 CUSTOMER ID: ATC FIVE POINTS CUSTOMER #: 131297

GENERAL NOTES


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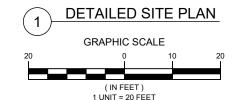
G-002

SITE PLAN NOTES:

- THIS SITE PLAN REPRESENTS THE BEST PRESENT KNOWLEDGE AVAILABLE TO THE ENGINEER AT THE TIME OF THIS DESIGN. THE CONTRACTOR SHALL VISIT THE SITE PRIOR TO CONSTRUCTION AND VERIFY ALL EXISTING CONDITIONS RELATED TO THE SCOPE OF WORK FOR THIS PROJECT.
- ICE BRIDGE, CABLE LADDER, COAX PORT, AND COAX CABLE ARE SHOWN FOR REFERENCE ONLY, CONTRACTOR SHALL CONFIRM THE EXACT LOCATION OF ALL PROPOSED AND EXISTING EQUIPMENT AND STRUCTURES DEPICTED ON THIS PLAN. BEFORE UTILIZING EXISTING CABLE SUPPORTS, COAX PORTS, INSTALLING NEW PORTS OR ANY OTHER EQUIPMENT, CONTRACTOR SHALL VERIFY ALL ASPECTS OF THE COMPONENTS MEET THE ATC SPECIFICATIONS.
- THIS PROJECT INCLUDES NO INSTALL OR MODIFICATION AT GRADE.

LEGEND ⊗ GROUNDING TEST WELL ATS AUTOMATIC TRANSFER SWITCH **BOLLARD** CSC CELL SITE CABINET D DISCONNECT ELECTRICAL **FIBER** GEN GENERATOR GENERATOR RECEPTACAL HH, V HAND HOLE, VAULT IB ICE BRIDGE KENTROX BOX LC LIGHTING CONTROL M METER PB PULL BOX PP POWER POLE TELCO. TRN TRANSFORMER CHAINLINK FENCE



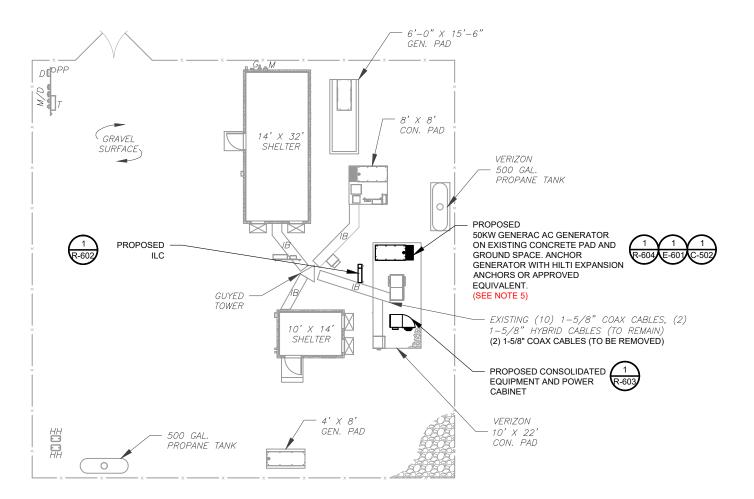





ATC TOWER SERVICES, LLC

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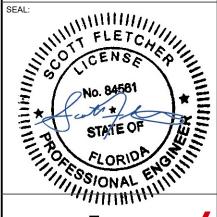
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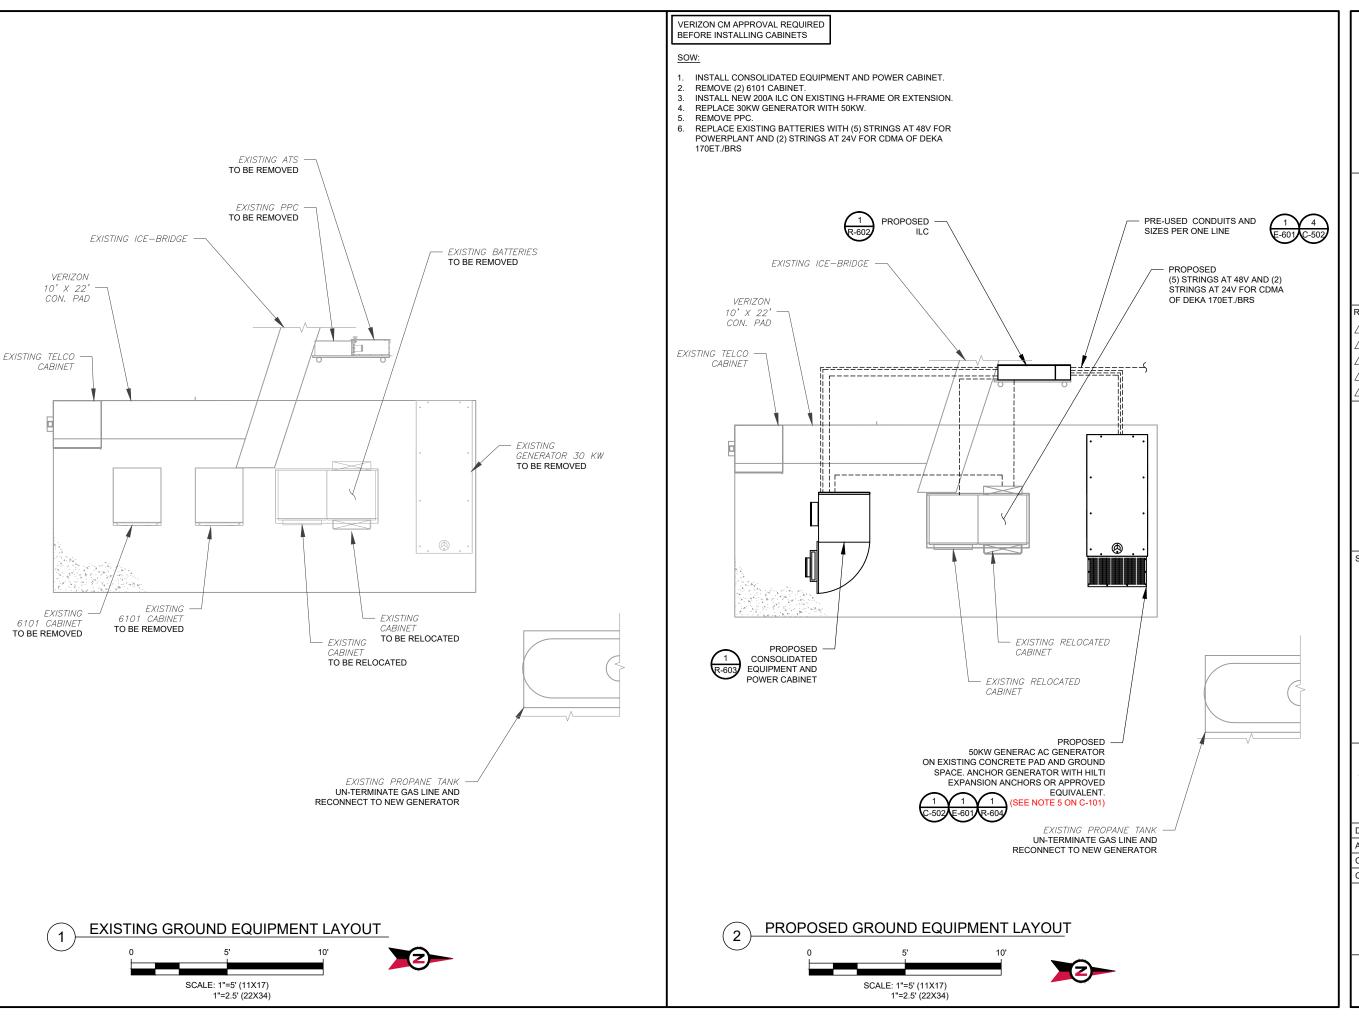


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П	ATC JOB NO:	13686745_D1
П	CUSTOMER ID:	ATC FIVE POINTS
П	CUSTOMER #:	131297

DETAILED SITE PLAN

SHEET NUMBER:

C-101





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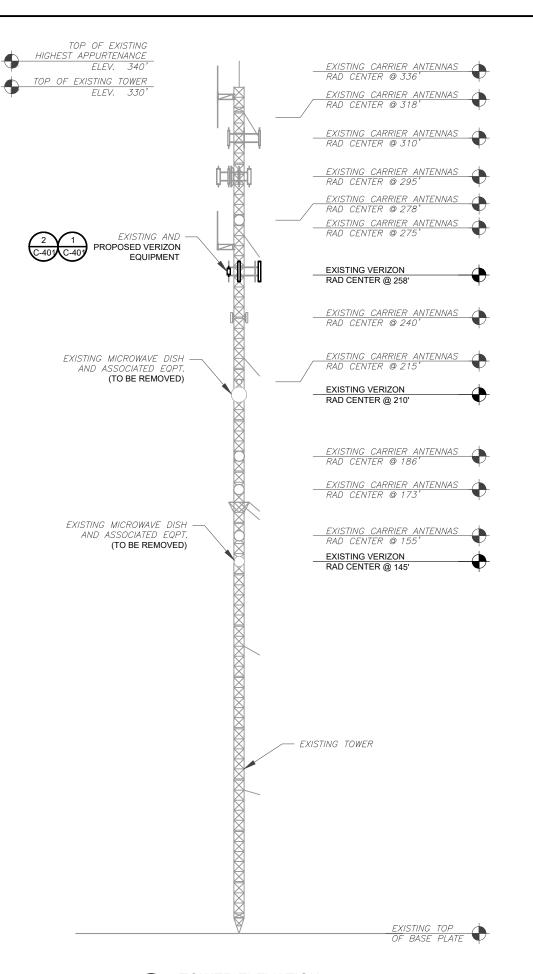


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GROUND EQUIPMENT LAYOUT

SHEET NUMBER:

C-102



PER MOUNT ANALYSIS COMPLETED BY TECTONIC, D.P.C., DATED 05/20/21, THE EXISTING MOUNT CAN ADEQUATELY SUPPORT THE PROPOSED LOADING

- TOWER NOTE:

 1. IT IS THE CONTRACTOR'S RESPONSIBILITY TO CONFIRM WITH THE PROJECT MANAGER THAT THEY HAVE THE MOST RECENT VERSION OF THE STRUCTURAL ANALYSIS BEFORE COMMENCING WORK. EXISTING AND PROPOSED TOWER APPURTENANCES, MOUNTS, AND ANTENNAS ARE SHOWN BASED ON THE STRUCTURAL ANALYSIS.
- 2. WHERE APPLICABLE, ALL NEW ANTENNAS, EQUIPMENT, MOUNTS, CABLING, ETC. SHALL BE PAINTED/SOCKED TO MATCH EXISTING EQUIPMENT IN ACCORDANCE WITH FAA, JURISDICTION, AND/OR OTHER LOCAL REQUIREMENTS.
- TOWER ELEVATIONS ARE MEASURED FROM TOP OF BASE PLATE TO MATCH STRUCTURAL ANALYSIS. ELEVATIONS DO NOT REFLECT TRUE ABOVE GROUND LEVEL (A.G.L.)

AMERICAN TOWER®

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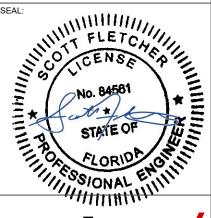
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TOWER ELEVATION


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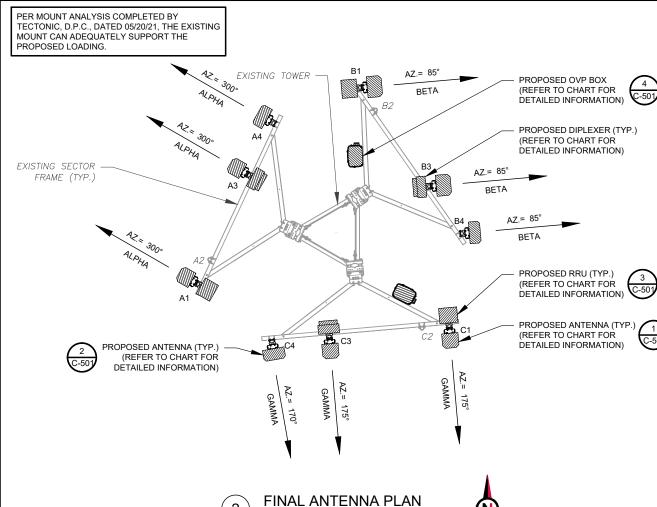
REVISION

C-201

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TOWER ELEVATION SCALE: N.T.S.



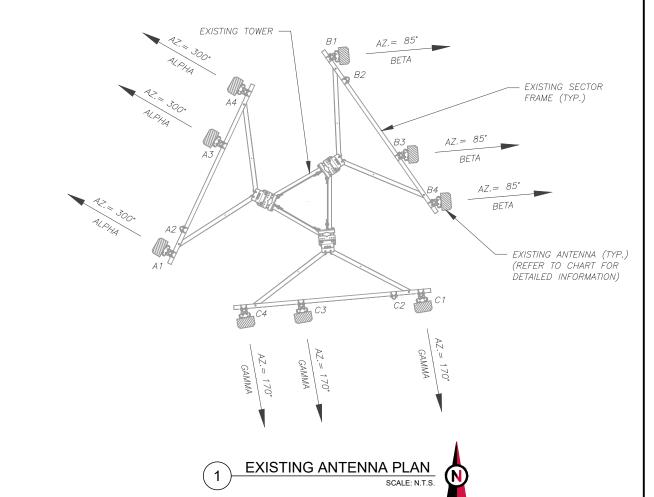

				·	EXISTING ANTENNA SCHEDULI	E		·		NOTES						FINAL ANTENNA SCHEDULE			·	
L	CATION				ANTENNA SUMMARY			NON ANTENNA SUMMAR	RY	NOTES	LO	LOCATION			ANTENNA SUMMARY			- I	NON ANTENNA SUMMARY	
SECTOR	RAD	AZ	POS	ANTENNA	BAND	MECH-ELEC TILT (DEG)	STATUS	ADDL TOWER MOUNTED EQUIPMENT	STATUS	CONFIRM WITH VERIZON REP FOR APPLICABLE	SECTOR	RAD	AZ	POS	AN TEN NA	BAND	MECH-ELEC TILT (DEG)	STATUS	ADDL TOWER MOUNTED EQUIPMENT	STATUS
			A1	X7-865	700 LTE	-	RMV	7:		UPDATES/REVISIONS AND			- 8	A1	MX06FIT865-02	700/850/1900/AWS/AWS3 LTE & 850		ADD	8843 REV 2	ADD
			A2	V9 <u>2</u> 17		602	N	22		MOST RECENT RFDS FOR NSN				A2			23007	<u>~</u>	8	
ALPHA		300	А3	X7CAP-865	850 CDMA	18	RMV	•	143	CONFIGURATION (CONFIG). GC	ALPHA	1	300	A3	MX06FIT865-02	700/850/1900/AWS/AWS3 LTE & 850 CDMA/5G	(€)	ADD	RADIO 4449 - B138B5 TD-850B-L TE78-43	ADD
			A4	X7CAP-865	850 CDMA	-	RMV		1 -	TO CAP ALL UNUSED PORTS.		1	- 1	A4	AIR 6449 B77	L-SUB6 5G		ADD	- 1	
			B1	X7-865	700 LTE		RMV		2	CONFIRM SPACING OF				B1	MX06FR O860-02	700/850/1900/AWS/AWS3 LTE & 850		ADD	8843 REV 2	ADD
0.0000000000000000000000000000000000000	0.000000000		B2	10±0	-			2		PROPOSED EQUIP DOES NOT	STANDARD COLOR	100,000,000		B2	2■	-			-	
BETA	258.0	85	В3	X7CAP-865	850 CD MA	-	RMV	8		CAUSE TOWER CONFLICTS NOR IMPEDE TOWER CLIMBING	BETA	258.0	85	B3	MX06FR O860-02	700/B50/1900/AWS/AWS3 LTE & 850 CDMA/5G	. 64	ADD	RADIO 4449 - B138B5 TD-850B-LTE78-43	ADD
			B4	X7CAP-865	850 CDMA	- 4	RMV	2	120	PEGS.				B4	AIR 6449 B77	L-SUB6 5G	-	ADD		-
			C1	X7-865	700 LTE	24	RMV	2	1 18					C1	MX06FIT865-02	700/850/1900/AWS/AWS3 LTE & 850	183	ADD	8843 REV 2	ADD
			C2	-	-				160				178	C2		-		-	-	
SAMMA		170	СЗ	X7CAP-865	850 CD MA	1	RMV	50 50 50 50 50 50 50 50 50 50 50 50 50 5		STATUS ABBREVIATIONS	GAMMA		170	C3	MX06FIT865-02	700/850/1900/AWS/AWS3 LTE & 850 CDMA/5G		ADD	RADIO 4449 - B138B5 TD-850B-LTE78-43	ADD ADD
			C4	X7CAP-865	850 CDMA		RMV	¥.		RMV: TO BE REMOVED		1	170	C4	AIR 6449 B77	L-SUB6 5G	- 6	ADD	•	145

CABLE LENGTHS FOR JUMPERS

JUNCTION BOX TO RRU: 15'

RRU TO ANTENNA: 10'

REL: TO BE RELOCATED

RMN: TO REMAIN

ADD: TO BE ADDED

SCALE: N.T.S.

AMERICAN TOWER®
ATC TOWER SERVICES, LLC

3500 REGENCY PARKWAY SUITE 100 CARY, NC 27518 PHONE: (919) 468-0112 COA: 9053

THE USE AND PUBLICATION OF THESE DRAWINGS SHALL BE RESTRICTED TO THE ORIGINAL SITE FOR WHICH THEY ARE PREPARED. ANY USE OR DISCLOSURE OTHER THAN THAT WHICH RELATES TO AMERICAN TOWER OR THE SPECIFIED CARRIER IS STRICTLY PROHIBITED. NEITHER THE ARCHITECT NOR THE ENGINEER WILL BE PROVIDING ON-SITE CONSTRUCTION REVIEW OF THIS PROJECT. CONTRACTOR(S) MUST VERIFY ALL DIMENSIONS AND ADVISE AMERICAN TOWER OR THE SPECIFIED CARRIER OF ANY DISCREPANCIES. ANY PRIOR ISSUANCE OF THIS DRAWING IS SUPERSEDED BY THE LATEST VERSION.

l	REV.	DESCRIPTION	BY	DATE
l	\triangle_{-}	FOR CONSTRUCTION	TC	09/21/21
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l	$\overline{\Lambda}$			
l				
l				

ATC SITE NUMBER: 2543

ATC SITE NAME: FIVE POINTS

VERIZON SITE NAME:

ATC FIVE POINTS

SITE ADDRESS: 3501 N US HWY 441 LAKE CITY, FL 32055

SEAL:

TELETCHER

TO CENSE

NO. 84581

STATE OF

STATE O

verizon[/]


DATE DRAWN:	09/21/21
ATC JOB NO:	13686745_D1
CUSTOMER ID:	ATC FIVE POINTS
CUSTOMER #:	131297

ANTENNA INFORMATION & SCHEDULE


SHEET NUMBER:

C-401


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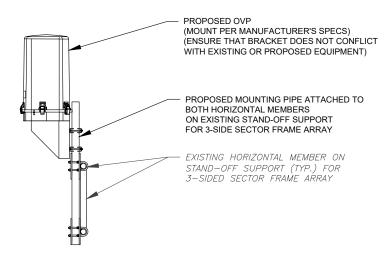
PROPOSED ANTENNA MOUNTING DETAIL - TYPICAL

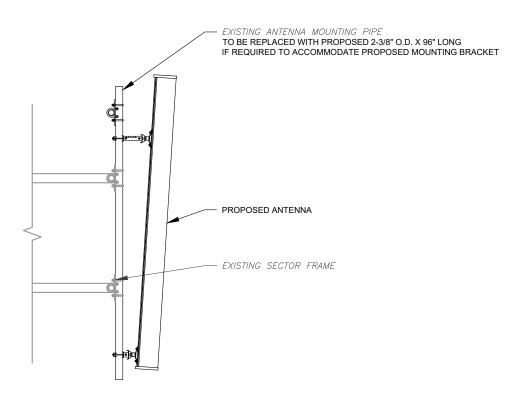

PROPOSED RRU MOUNTING DETAIL - TYPICAL

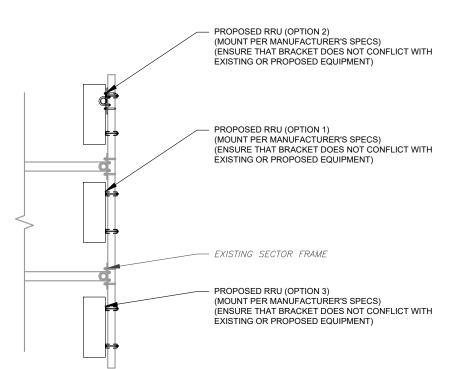

PROPOSED 5G ANTENNA MOUNTING DETAIL - TYPICAL SCALE: N.T.S.

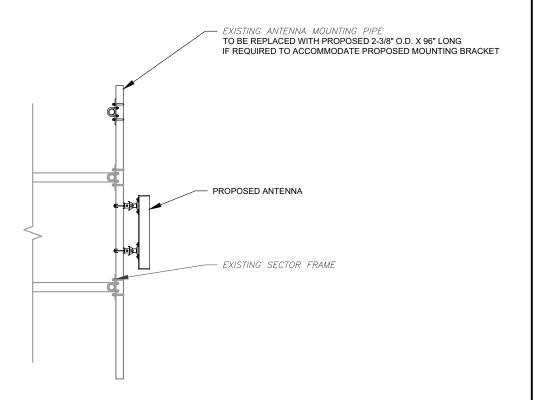

PROPOSED OVP MOUNTING SCALE: N.T.S.



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REV.	DESCRIPTION	BY	DATE
\triangle _	FOR CONSTRUCTION	TC_	09/21/21
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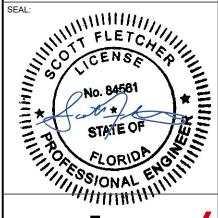
ATC SITE NUMBER: 2543

ATC SITE NAME: **FIVE POINTS**

VERIZON SITE NAME:

ATC FIVE POINTS

SITE ADDRESS: 3501 N US HWY 441 LAKE CITY, FL 32055






DATE DRAWN:	09/21/21
ATC JOB NO:	13686745_D1
CUSTOMER ID:	ATC FIVE POINTS
CUSTOMER #:	131297
	ATC JOB NO: CUSTOMER ID:

CONSTRUCTION **DETAILS**

SHEET NUMBER:


C-501

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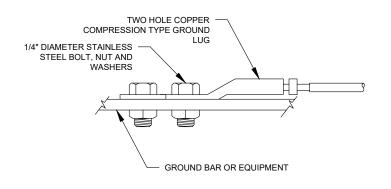


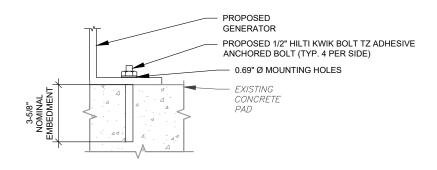INSTALL HILTI KWIK BOLT TZ ANCHORS STRICTLY PER INSTALLATION INSTRUCTIONS INCLUDED WITH PRODUCT OR FOUND ONLINE AT WWW.US.HILTI.COM. PROPER INSTALLATION IS CRITICAL FOR FULL PERFORMANCE.

GENERATOR ATTACHMENT DETAIL

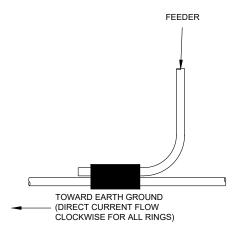


GENERATOR CONDUCTOR CONNECTION



NOTE:

ALL MECHANICAL EXTERNAL TERMINATION SURFACES SHALL BE TREATED WITH T&B KOPR-SHIELD CP8 ANIT-OXIDATION


TWO HOLE LUG CONNECTION DETAIL

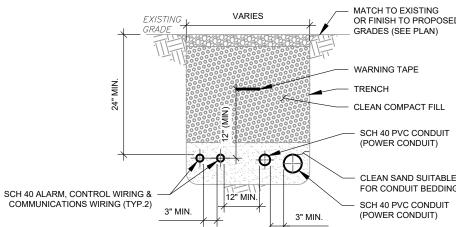


TRENCH NOTES:

- IF FREE OF ORGANIC OR OTHER DELETERIOUS MATERIAL, EXCAVATED MATERIAL MAY BE USED FOR BACKFILL.
- IF NOT, PROVIDE CLEAN, COMPACTIBLE MATERIAL, COMPACT IN 8" LIFTS. REMOVE ANY LARGE ROCKS PRIOR TO BACKFILLING. CONTRACTOR TO VERIFY LOCATION OF EXISTING U/G UTILITIES PRIOR TO DIGGING
- IF CURRENT AS-BUILT DRAWINGS ARE NOT AVAILABLE CONTRACTOR SHALL HAND DIG U/G TRENCHING.
- CONFIRM SPACING AND DEPTH WITH NEC OR LOCAL CODE REQUIREMENTS
- AC POWER CONDUITS MUST BE 3" MINIMUM FROM OTHER AC CONDUITS AND 12'



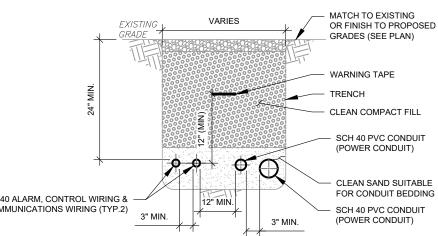

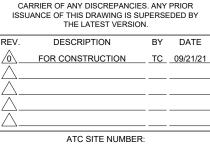

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ATC TOWER SERVICES, LLC

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SUITE 100

CARY, NC 27518

PHONE: (919) 468-0112 COA: 9053

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CONSTRUCTION REVIEW OF THIS PROJECT. CONTRACTOR(S) MUST VERIFY ALL DIMENSIONS

AND ADVISE AMERICAN TOWER OR THE SPECIFIED

2543

ATC SITE NAME: **FIVE POINTS**

VERIZON SITE NAME:

ATC FIVE POINTS

SITE ADDRESS: 3501 N US HWY 441 LAKE CITY, FL 32055

SEAL:

THE TOWNS AND THE PROPERTY OF THE PROPE



DATE DRAWN:	09/21/21
ATC JOB NO:	13686745_D1
CUSTOMER ID:	ATC FIVE POINTS
CUSTOMER #:	131297
	ATC JOB NO: CUSTOMER ID:

CONSTRUCTION **DETAILS**

SHEET NUMBER:


C-502

LABEL LIST:

- 1. (2)-2" CONDUITS FOR RECTIFIERS IN CONSOLIDATED EQUIPMENT AND POWER CABINET
- 2. (1)-3/4" CONDUIT FOR GENERATOR AND ILC ALARM FORM ILC TO CONSOLIDATED EQUIPMENT
- 3. (1)-1" CONDUIT FOR GENERATOR HEATER & BATTERY CHARGER FROM ILC TO GENERATOR
- 4. (1)-1" CONDUIT FOR ALARM AND CONTROL WIRING FROM ILC TO GENERATOR
- 5. (1)- 2½" CONDUIT FOR POWER FROM ILC TO GENERATOR
- 6. (1)-2" CONDUIT FOR POWER FROM SERVICE DISCONNECT/CIRCUIT BREAKER TO ILC
- 7. (1)-2" CONDUIT FOR BATTERY CABINET FROM CONSOLIDATED EQUIPMENT AND POWER CABINET TO BATTERY CABINET
- 8. (1)-1" CONDUIT FOR BATTERY CABINET FROM ILC TO BATTERY CABINET. CONTRACTOR TO REUSE CONDUIT AND CONDUIT AND CONDUCTORS IF SUFFICIENTLY SIZED.
- 9. (1)-1½" CONDUIT FOR EXISTING BTS CABINET FROM ILC TO BTS CABINET. CONTRACTOR TO REUSE CONDUIT AND CONDUIT AND CONDUCTORS IF SUFFICIENTLY SIZED.

NOTES

- 1. POWER AND TELCO CONDUITS RECEIVING CONDUCTORS BY OTHERS TO HAVE PULL ROPES.
- 2. ALL TELCO CONDUITS ARE TO BE STUBBED IN D-MARC LOCATION.
- 3. ALL POWER CONDUITS ARE TO BE TERMINATED AT THE METER CENTER.
- 4. THE CONTRACTOR SHALL LOCATE ALL EXISTING UTILITIES PRIOR TO TRENCHING. ANY DAMAGE CAUSED TO THE EXISTING UTILITIES SHALL BE REPAIRED AT THE CONTRACTORS EXPENSE.
- 5. ALL CONDUITS SHALL BE INSTALLED PRIOR TO FINISH GRADING, GEOFABRIC, AND STONE
- 6. CONTRACTOR SHALL INSTALL SWEEPS AT ALL CONDUIT DIRECTION CHANGES UNLESS NOTED OTHERWISE
- RUN CONDUITS FROM ILC TO GENERATOR UNDERGROUND AND STUB UP CONDUITS MINIMUM 6"
 HIGH INSIDE GENERATOR BASE AND TERMINATE WITH MALE ADAPTER AND THREADED BUSHING.
- 8. WHEN ALL RRUS ARE GROUND MOUNTED, OMIT OVPS AND RUN FIBER/POWER FROM CONSOLIDATED EQUIPMENT AND POWER CABINET DIRECTLY TO RRUS.

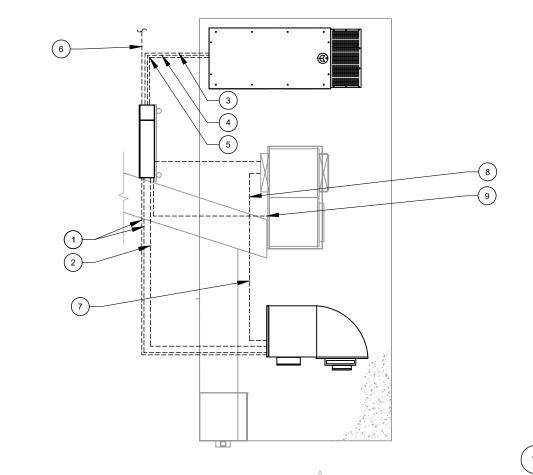


POWER ROUTING PLAN

GROUNDING KEYED NOTES:

GROUNDING ELECTRODE CONDUCTOR PER NEC

2 EXISTING GROUND RING

GROUNDING ELECTRODE WITH EXISTING TEST WELL

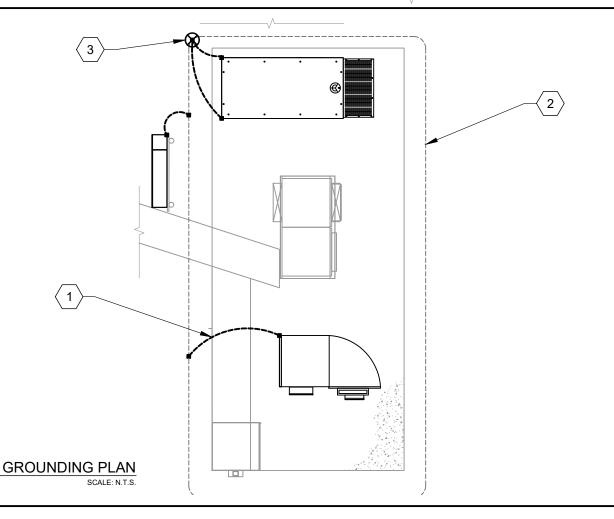



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ATC SITE NUMBER: 2543

ATC SITE NAME: FIVE POINTS

VERIZON SITE NAME:

ATC FIVE POINTS

SITE ADDRESS: 3501 N US HWY 441 LAKE CITY, FL 32055

SEAL:



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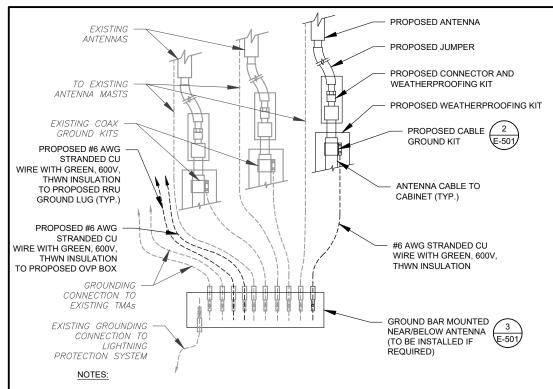
DATE DRAWN:	09/21/21
ATC JOB NO:	13686745_D1
CUSTOMER ID:	ATC FIVE POINTS
CUSTOMER #:	131297

CONDUIT LAYOUT

E-101

REVISION

0



1. THIS DETAIL IS INTENDED TO SHOW THE GENERAL GROUNDING REQUIREMENTS. SLIGHT ADJUSTMENTS MAY BE REQUIRED BASED ON EXISTING SITE CONDITIONS. THE CONTRACTOR SHALL MAKE FIELD ADJUSTMENTS AS NEEDED AND INFORM THE CONSTRUCTION MANAGER OF ANY CONFLICTS.

SITE GROUNDING SHALL COMPLY WITH VERIZON GROUNDING STANDARDS, LATEST EDITION, AND COMPLY WITH VERIZON GROUNDING CHECKLIST, LATEST VERSION. WHEN NATIONAL AND LOCAL GROUNDING CODES ARE MORE STRINGENT THEY SHALL GOVERN.

TYPICAL ANTENNA GROUNDING DIAGRAM

TO EQUIPMENT

GROUND KIT NOTES: 1. DO NOT INSTALL CABLE GROUND KIT AT A BEND AND ALWAYS DIRECT GROUND WIRE DOWN TO GROUND BAR.

TO ANTENNA

0

2. CONTRACTOR SHALL PROVIDE WEATHERPROOFING KIT (ANDREW PART NUMBER 221213) AND INSTALL/TAPE PER MANUFACTURER'S SPECIFICATIONS.

ANTENNA CABLE 2 1/2"Ø MAX

GROUNDING KIT PER CABLE

TO GROUND BAR


MANUFACTURER'S RECOMMENDATIONS (ANDREW OR APPROVED EQUAL)

#6 AWG STRANDED COPPER GROUND


WIRE (GROUNDED TO GROUND BAR)

CABLE GROUND KIT CONNECTION DETAIL



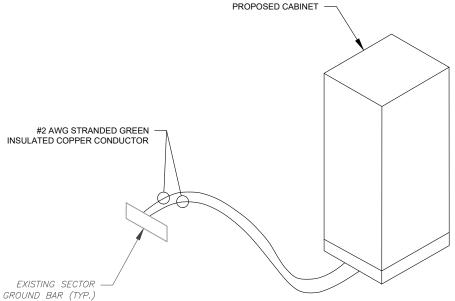



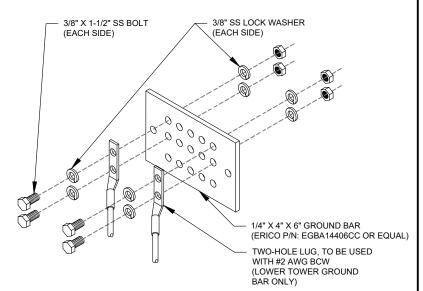

GROUND BAR NOTES:

- GROUND BAR KITS COME WITH ALL HARDWARE, NUTS, BOLTS, WASHERS, ETC. EXCEPT THE STRUCTURAL MOUNTING MEMBER(S).
- 2. GROUND BAR TO BE BONDED DIRECTLY TO TOWER.





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DESCRIPTION	BY	DATE
FOR CONSTRUCTION	TC	09/21/21

ATC SITE NUMBER: 2543

ATC SITE NAME: **FIVE POINTS**

VERIZON SITE NAME:

ATC FIVE POINTS

SITE ADDRESS: 3501 N US HWY 441 LAKE CITY, FL 32055

STATE OF SONAL ENGINE Thursday.

This item has been electronically signed and sealer by Mustapha Raha, PE on the date shown using a cally signed and sealed digital signature.

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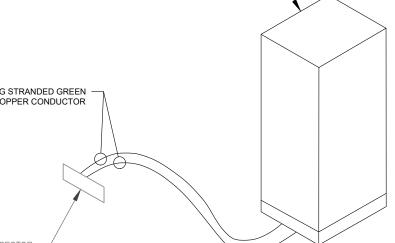



DATE DRAWN: | 09/21/21 ATC JOB NO: 13686745 D1 CUSTOMER ID: ATC FIVE POINTS CUSTOMER #: 131297

GROUNDING DETAILS

SHEET NUMBER:

E-501



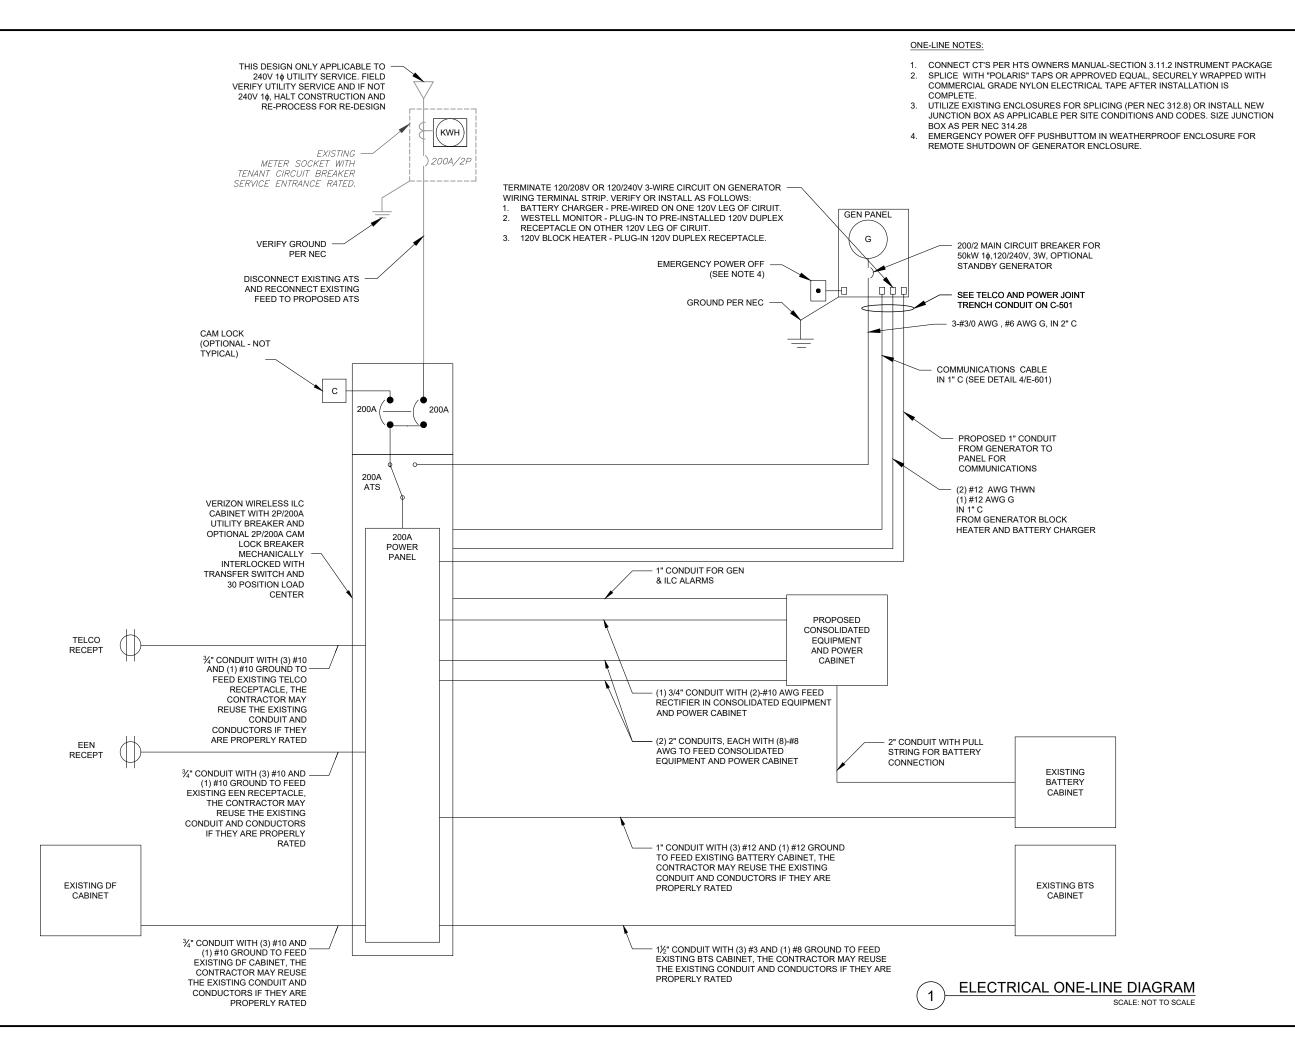



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l	1	ATC JOB NO:	13686745_D1
ı	-	CUSTOMER ID:	ATC FIVE POINTS
l	1	CUSTOMER #:	131297
ı	- 1		

ONE-LINE DIAGRAM

SHEET NUMBER:

REVISION

E-601

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PANEL TYPE: LIGHTING & APPLIANCE SYSTEM: 120/240V, 1Ø, 3W, 42 CKT LOCATION: VZW LEASE EQUIPMENT AREA DESIGNATION: VERIZON MOUNTING: SURFACE MAIN BREAKER (MB): 200A PROPOSED ENCLOSURE: NEMA 3R MAIN BUS RATING: 200A PANEL NOTES: MIN. A.I.C. RATING: NA


CONNECT	ED			FE	EDER OR	BRANC	H CIRCL	JIT				F	EEDER C	RBRAN	NCH CIRC	TIU			CONN	NECTE							
OAD (kV	(A)	BRIEF DESCRIPTION	BRE	AKER		CIRCUIT		POLE	CIRC.		DIR C. POLE		CIRC. POLE		CIRC. POLE		CIRC. POLE		DIR C. POLE		CIRCUIT		BREAKER		BRIEF DESCRIPTION	LOAD (kV	
Α	В		AMPS	POLES	WIRE	GND	COND.	NO.	NOTES		NOTES	NO.	COND.	GND	WIRE	POLES	AMPS		Α	В							
.14	.14	RECTIFIER	30	2	3-#10	#10	1/2"	3	1		1	4	1/2"	#10	3-#10	2	30	RECTIFIER	1.14	1.1							
.14	.14	RECTIFIER	30	2	3-#10	#10	1/2"	5 7	1		1	6 8	1/2"	#10	3-#10	2	30	RECTIFIER	1.14	1.1							
1.14	.14	RECTIFIER	30	2	3-#10	#10	1/2"	9	1		1	10 12	1/2"	#10	3-#10	2	30	RECTIFIER	1.14	1.1							
.14	.14	RECTIFIER	30	2	3-#10	#10	1/2"	13 15	1			14 16						SPARE SPARE	0.00	0.0							
00 4.	.00	BTS	100	2	3-#1	#8	2"	17 19	1		3	18 20	1/2"	#12 #12	2-#12 2-#12	1	20 20	DF CABINET TELCO RECEPT	1.80	0.1							
01 0	.01	SURGE	60	2	3-#6	#10	1"	17 19	1		3	22 24	1/2"	#12 #12	2-#12 2-#12	1	20	EEN RECEPT GEN BATTERY CHARGER	0.18	1.9							
.00							4	25			3	26	1/2"	#12	2-#12	1	20	GEN BLOCK HEATER	1.92								
0.00	.00). 			27 29				28 30							0.00	0.0							
3.6	3.6		1						A 15.9	B 14.1	TO 1	and and an artist of the same			DAD (kV)				7.3	5.							

CIRCUIT NOTES

- 1) PAINEL SCHEDULE BASED ON INFO PROVIDED TO A E; IF PAINEL HAS DIFFERENT EXISTING LOADS THAIN SHOWN, STOP WORK AND CONTACT EOR
- 2) EXISTING CIRCUIT, UNKNOWN LOAD, MAX DEMAND ASSUMED FOR LOAD CAPACITY ASSESSMENT.
- 3) EXISTING CIRCUIT, KNOWN LOAD FOR LOAD CAPACITY ASSESSMENT
- 4) PROPOSED CIRCUIT, KNOWN LOAD FOR LOAD CAPACITY ASSESSMENT


PANEL SCHEDULE

15.9 14.1

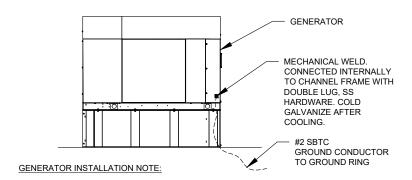

INSTALL GENERATOR AND TRANSFER SWITCH WITH ALL SUPPLIED ACCESSORIES PER MANUFACTURER'S INSTALLATION INSTRUCTIONS AND SPECIFICATIONS. THIS INCLUDES, BUT IS NOT LIMITED TO, ACCESSORIES FOR THE EXHAUST SYSTEM, FUEL SYSTEM, ENCLOSURE INTEGRITY (CAPS, PLUGS, COVERS, ETC.), ELECTRICAL CONNECTIONS, AND GROUNDING CONNECTIONS.



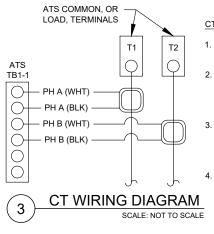

29.9 DEMAND LOAD (kVA)

T NOTES:

. CT'S FURNISHED BY GENERAC WITH LEAD WIRE OPTION, PART NUMBER 0F7784B, 200:1 AMP RATIO.

DERATING FACTOR (80%)

DEMANDLOAD SIZING:

156 AMPS

- OF/784B, 200:1 AMP RATIO.
 WIRING SHOWN FOR SINGLE PHASE
 TENANT LOAD ON PHASES A-B.
 ADJUST ACCORDINGLY FOR
 INDIVIDUAL SITES THAT ARE
 BALANCING THREE PHASE SERVICES.
- . 1-PHASE: MOUNT ONE CT WITH WHITE DOT FACING AWAY FROM, AND OTHER CT WITH WHITE DOT FACING TOWARDS, THE ATS TERMINAL CONNECTIONS
- 3-PHASE: MOUNT ALL CT'S WITH WHITE DOTS ALL FACING AWAY FROM THE ATS TERMINAL CONNECTIONS

AMERICAN TOWER®

ATC TOWER SERVICES, LLC 3500 REGENCY PARKWAY SUITE 100

CARY, NC 27518 PHONE: (919) 468-0112 COA: 9053

THE USE AND PUBLICATION OF THESE DRAWINGS SHALL BE RESTRICTED TO THE ORIGINAL SITE FOR WHICH THEY ARE PREPARED. ANY USE OR DISCLOSURE OTHER THAN THAT WHICH RELATES TO AMERICAN TOWER OR THE SPECIFIED CARRIER IS STRICTLY PROHIBITED. NEITHER THE ARCHITECT NOR THE ENGINEER WILL BE PROVIDING ON-SITE CONSTRUCTION REVIEW OF THIS PROJECT. CONTRACTOR(S) MUST VERIFY ALL DIMENSIONS AND ADVISE AMERICAN TOWER OR THE SPECIFIED CARRIER OF ANY DISCREPANCIES. ANY PRIOR ISSUANCE OF THIS DRAWING IS SUPERSEDED BY THE LATEST VERSION.

REV.	DESCRIPTION	BY	DATE
\triangle_{-}	FOR CONSTRUCTION	_TC_	09/21/21
\triangle			
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$\overline{\wedge}$			

ATC SITE NUMBER: 2543

ATC SITE NAME: FIVE POINTS

VERIZON SITE NAME:

ATC FIVE POINTS

SITE ADDRESS: 3501 N US HWY 441 LAKE CITY, FL 32055

No. 87740

STATE OF

ORIDA

ONAL ENGINEERING

This item has been electronically signed and sealed by Mustapha Raha, PE on the date shown using a digital signature.

Printed copies of this are not considered signed and sealed and the signature must be verified on any



09/21/21
13686745_D1
: ATC FIVE POINTS
131297
: ATC FIVE POINTS

PANEL SCHEDULE AND ELECTRICAL DETAILS

SHEET NUMBER:

E-602





Tectonic Engineering Consultants, Geologists, & Land Surveyors, D.P.C. 1279 Route 300 Newburgh, NY 12550 (845)567-6656 TecVZWOrders@tectonicengineering.com

Antenna Mount Analysis Report and PMI Requirements

Mount Analysis

SMART Tool Project #: 10057858 Tectonic Project #: 10880.129

May 20, 2021

Site ID: 131297-VZW / ATC FIVE POINTS Site Information

Site Name: ATC FIVE POINTS Carrier Name: Verizon Wireless Address: 3501 N US Hwy 441

Lake City, Florida 32055, Columbia County

Latitude: 30.238208° Longitude: -82.636822°

330-Ft Guyed Structure Information Tower Type:

Mount Type: 13.00-Ft T-Arm

FUZE ID # 16275915

Analysis Results

T-Arm: 67.5% Pass

***Contractor PMI Requirements:

Included at the end of this MA report Available & Submitted via portal at https://pmi.vzwsmart.com Contractor - Please Review Specific Site PMI Requirements Upon Award Requirements also Noted on Mount Modification Drawings Requirements may also be Noted on A & E drawings

Report Prepared By: David Powers/ Veronica Elson

Veronic Veronica Elson a Elson 17:21:25 -04'00

Mount Structural Analysis Report (3) 13.00-Ft T-Arms

May 20, 2021 Site ID: 131297-VZW / ATC FIVE POINTS Page | 4

- 6. All services are performed, results obtained, and recommendations made in accordance with generally accepted engineering principles and practices. Tectonic is not responsible for the conclusion, opinions, and recommendations made by others based on the information supplied.
- 7. Structural Steel Grades have been assumed as follows, if applicable, unless otherwise noted in this analysis:

 Channel, Solid Round, Angle, Plate ASTM A36 (Gr. 36) ASTM 500 (Gr. B-46) HSS (Rectangular) Pipe ASTM A53 (Gr. B-35) Threaded Rod F1554 (Gr. 36) ASTM A325 Bolts

Discrepancies between in-field conditions and the assumptions listed above may render this analysis invalid unless explicitly approved by Tectonic.

Analysis Results:

Component	Utilization %	Pass/Fail
Face Horizontal	23.1 %	Pass
Mount Pipe	67.5 %	Pass
Standoff	17.5 %	Pass
Standoff Pipe	47.3 %	Pass
Tower Beam	22.9 %	Pass
Kicker	8.3 %	Pass
Tie Back	12.4 %	Pass
ower Connection	11.2 %	Pass

Structure Rating – (Controlling Utilization of all Components)	67.5%

Recommendation:

The existing mounts are **SUFFICIENT** for the final loading configuration and do not require modifications.

ANSI/ASSP rigging plan review services compliant with the requirements of ANSI/TIA 322 are available for a Construction Class IV site or other, if required. Separate review fees will apply.

Attachments:

- 1. Mount Photos
- 2. Mount Mapping Report (for reference only)
- 3. Analysis Calculations
- 4. Contractor Required Post Installation Inspection (PMI) Report Deliverables
- 5. Antenna Placement Diagrams

SUPPLEMENTAL

SHEET NUMBER:

REVISION: 0

NOTE: THIS SHEET WAS CREATED BY OTHERS AND PROVIDED AT THE REQUEST OF THE CUSTOMER WITHOUT EDIT. PLEASE REFERENCE THE MOUNT ANALYSIS REPORT FOR COMPLETE MOUNT ANALYSIS CALCULATIONS AND DETAILS. SUPPLEMENTAL PAGES INCLUDED IN THE CONSTRUCTION DRAWINGS ARE FOR REFERENCE ONLY. GENERAL CONTRACTOR IS TO R-601 VERYIFY THEY HAVE THE MOST RECENT MOUNT ANALYSIS PRIOR TO CONTRUCTION.

INDUSTRIAL SPARK-IGNITED GENERATOR SET

EPA Certified Stationary Emergency

GENERAC INDUSTRIAL

Standby Power Rating 50 kW, 63 kVA, 60 Hz

Prime Power Rating* 45 kW, 56 kVA, 60 Hz





*EFA Certified Prime ratings are not available in the USS or its Territories



Image used for illustration purposes only

Codes and Standards

Generac products are designed to the following standards:





UL2200, UL508, UL489



CSA 22.2





BS5514 and DIN 6271

SAE J1349



NFPA 37, 70, 99, 110



NEC700, 701, 702, 708



ISO 3046, 7637, 8528, 9001



NEMA ICS10, MG1, 250, ICS6, AB1



ANSI C62.41



IBC 2009, CBC 2010, IBC 2012, ASCE 7-05, ASCE 7-10, ICC-ES AC-156 (2012)

Powering Ahead

Generac ensures superior quality by designing and manufacturing most of its generator components, such as alternators, enclosures, control systems and communications software. Generac also makes its own spark-ignited engines, and you'll find them on every Generac gaseous-fueled generator. We engineer and manufacture them from the block up - all at our facilities throughout Wisconsin. Applying natural gas and LP-fueled engines to generators requires advanced engineering expertise to ensure reliability, durability and necessary performance. By designing specifically for these dry, hotter-burning fuels, the engines last longer and require less maintenance. Building our own engines also means we control every step of the supply chain and delivery process, so you benefit from singlesource responsibility.


Plus, Generac Industrial Power's distribution network provides all parts and service so you don't have to deal with third-party suppliers. It all leads to a positive owner experience and higher confidence level. Generac spark-ignited engines give you more options in commercial and industrial generator applications as well as extended run time from utility-supplied natural gas.

SG050 | 5.4L | 50 kW

INDUSTRIAL SPARK-IGNITED GENERATOR SET

EPA Certified Stationary Emergency

DIMENSIONS AND WEIGHTS*

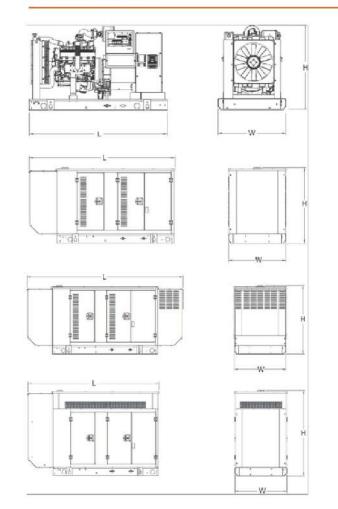

OPEN SET (Includes Exhaust Flex)

LxWxH-in (mm)	76.0 (1,930.0) x 37.4 (950.0) x 46.3 (1,176.0)
Weight - Ibs (ico)	2.258 (1.023)

GENERAC INDUSTRIAL

STANDARD ENCLOSURE

LxWxH-in (mm)	94.8 (2,408.9) x 38.0 (985.1) x 49.5 (1,258.1)	
Weight - Ibs (kg)	Steel: 2,697 (1,223) Aluminum: 1,754 (795)	


LEVEL 1 ACOUSTIC ENCLOSURE

LxWxH-in (mm)	112.5 (2,857.1) × 38.0 (965.1) x 49.5 (1,258.1)
Weight - Ibs (kg)	Steel: 2,776 (1,259) Aluminum: 2,508 (1,138)

LEVEL 2 ACOUSTIC ENCLOSURE

LxWxH-in (mm)	94.8 (2,407.0) x 38.0 (965.1) x 69.1 (1,755.0)
Weight - lbs (kg)	Steel: 2,928 (1,328) Aluminum: 2,574 (1,168)

* All measurements are approximate and for estimation purposes only.

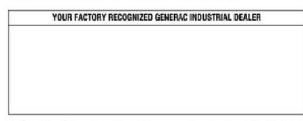

Specification characteristics may change without notice. Please contact a Generae Power Systems Industrial Dealer for detailed installation drawings.

Generac Power Systems, Inc. | P.O. Box 8 | Waukesha, W 53189

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Part No. 0K4284 Rev. D 11/16/17

SUPPLEMENTAL

SHEET NUMBER:

R-602

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NOTICE

DISCONNECT FOR UTILITY POWER TO GENERATOR IS LOCATED INSIDE THIS ENCLOSURE CAUTION: TWO
SOURCES OF SUPPLY.
STANDBY
GENERATOR
LOCATED OUTDOOR.



SHOCK HAZARD EXISTS IF
GROUNDING ELECTRODE CONDUCTOR
OR BONDING JUMPER CONNECTION IN
THIS EQUIPMENT IS REMOVED WHILE
ALTERNATE SOURCE(S) IS ENERGIZED

1 REQUIRED SIGNS
SCALE: N.T.S

SUPPLEMENTAL

SHEET NUMBER

2

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R-603



THIS UNIT MAY START
AUTOMATICALLY. FOLLOW
OPERATING PROCEDURES TO
DISABLE AUTO-START FUNCTION ON
ALL AVAILABLE A.T.S. BEFORE
SERVICING

ACCESS BY AUTHORIZED PERSONNEL ONLY

1 REQUIRED SIGNS
SCALE: N.T.S.

SUPPLEMENTAL

SHEET NUMBER

0

R-604