

VENTILATION REQUIRED:
ENCLOSED ATTICS AND ENCLOSED RAFTERS
SPACES FORMED WHERE THE CEILINGS ARE
APPLIED DIRECTLY TO THE UNDERSIDE OF
RAFTERS SHALL HAVE CROSS
VENTILATION FOR EACH SEPARATE SPACE
BY VENTILATION FOR EACH SEPARATE SPACE
BY VENTILATING OPENINGS PROTECTED
AGAINST THE ENTRANCE OF RAIN OR SNOW.
VENTILATING OPENINGS STALL BE PROVIDED
WITH CORROSION-RESITANT WIRE MESH,
WITH 1/8" MIN. TO 1/4" MAX. OPENINGS.

DRAWING: **ELEVATIONS**

11


SCALE: 1/8" = 1'-0" DRAWN BY: STEVEN PHILLIPS DATE: 7-10-12 FLOOR SIZE: 76'x30' MODEL NUMBER: MTF-2530-EZ-476-1 PLAN NUMBER:




ENERGY HOMES

18025 COUNTY ROAD 41 P.O. BOX 269 ADDISON, AL 35540

PHONE:(256)747-1544 FAX:(256)255-3358

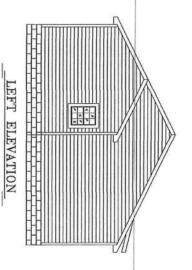

RIGHT ELEVATION

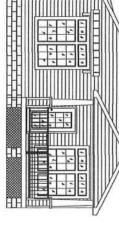

APPROVED BY

ATTIC VENTILATION REQUIREMENTS:

1. NOT LESS THAN 1 TO 150.

2. VENTILATION REDURED: 1850.54 Sq.In.

3. TYPE OF VENTILATION PROVIDED.

ROOF: CONTINUOUS VENTED RIDGE CAP(11.46 Sq.In/L.F.)

EAVES: CONTINUOUS VENTED VINYL SOFHI (14.34 Sq.In/L.F.)

4. VENTILATION PROVIDED:

ROOF: (44.0 L.F.) 504.24 Sq.In.

YOUR LIFE SHEET NO.: YOUR HOME YOUR STYLE

ENERGY HOMES a division of SEhomes, Inc.

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DRAWING:	
ELEVATIONS	;

MINIMUM AREA
THE NET FREE VENTILATION
SHALL NOT BE LESS THAN 1 TO 150
OF THE AREA OF THE SPACE
VENTILATED, EXCEPT THAT THE
AREA MAY BE ITO 300, PROVIDED
AT LEAST 55% AND NOT MORE THAN
85% OF THE REQUIRED VENTILATIONS
AREA 15 PROVIDED BY VENTILATORS
LOCATED IN THE UPPER PORTION OF
THE SPACET OB EVENTILATED AT
LEAST 3-FEET ABOVE EAVE OR CORNICE
VENTS WITH THE BALANCE OF THE
REQUIRED VENTILATION PROVIDED BY
EAVE OR CORNICE VENTS, AS AN
ALTERNATIVE, THE NET FREE CROSSVENTILATION AREA MAY BE REDUCED
TO 1 TO 300 WHEN A VAPOR BARRIER
HAVING A TRANSMISSION RATE NOT
EXCEEDING 1 PERM 15 INSTALLED ON
THE WAPM STORE OF CHI TIME

SCALE:


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DATE: 7-10-12 FLOOR SIZE: 76'x30' MODEL NUMBER: MTF-2530-EZ-476-1 PLAN NUMBER:

VENTILATION REQUIRED:
ENCLOSED ATTICS AND ENCLOSED RAFTERS
SPACES FORMED WHERE THE CEILINGS ARE
APPLIED DIRECTLY TO THE UNDERSIDE OF
ROOF RAFTERS SHALL HAVE CROSS
VENTILATION FOR EACH SEPARATE SPACE
BY VENTILATING OPENINGS PROTECTED
AGAINST THE ENTRANCE OF RAIN OR SNOW.
VENTILATING OPENINGS SHALL BE PROVIDED
WITH LOTROSION-RESITANT WIRE MESH,
WITH 19T MIN. TO 1/4" MAX. OPENINGS.

ATTIC VENTILATION:



STEVEN PHILLIPS

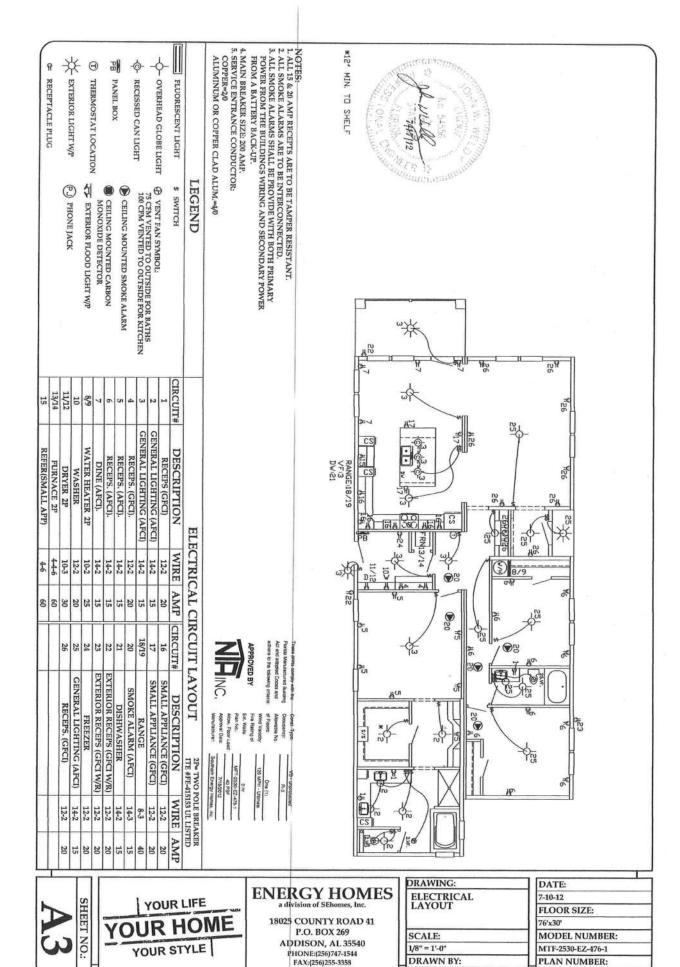 ALUMINUM CONDUCTORS SHALL NOT BE USED.
 DISTRIBUTION EQUIPMENT SHALL BE LOCATED A MINIMUM OF 24' ABOVE THE FLOOR LEVEL 3. RECEPTACLE OUTLETS LOCATED IN COMPARTMENTS ACCESSIBLE FROM OUTDOORS SHALL BE

4. EACH BASIN WITHIN A BATHROOM SHALL BE PROVIDED WITCOUNTERTOP AREA. THIS OUTLET SHALL BE ON A SEPARATE PROVIDED WITH A GFCI PROTECTED OUTLET E ON A SEPARATE 20 AMP. CIRCUIT.

5. LICHTING FIXTURES INSTALLED OVER A BATHTUB OR SHOWER SHALL BE OF THE ENCLOSED AND GASKETED TYPE, LISTED FOR WET AREA USE.

6. EVERY APPLIANCE SHALL BE ACCESSIBLE FOR INSPECTION, SERVICE REPAIR OR REPLACEMENT WITHOUT REMOVAL OF PERMANENT CONSTRUCTION.

7. NONMETALLIC BOXES, ARE USED WITH NONMETALLIC CABLE ONLY.

8. NONMETALLIC CABLE IN STORAGE AREAS AND/OR LESS THAN 15" ABOVE THE FLOOR SHALL

9. ELECTRICAL CABLES SHALL BE SECURED IN PLACE AT INTERVALS NOT EXCEEDING 41/2 FT. AND WITHIN 12" FROM EVERY CABINET BOX OR FITT BE PROTECTED FROM DAMAGE

10. ELECTRICAL CABLES LESS THAN 1 1/4" FROM ANY SURFACE OF WOOD FRAMING MEMBERS IT PASSES THROUGH SHALL BE PROTECTED WITH A STEEL DEVICE OF 16 ga. THICKNESS IN IN WALL STUDS 3 1/2" AND LARGER OR USE A CABLE STACKER ON WALL STUDS LESS THAN 3 1/2".

11. METALLIC FACE PLATES SHALL BE EFFECTIVELY GROUNDED.

12. APPLIANCES CONNECTED BY METAL-CLAD CABLE OR FLYBRIE CONDUIT SHALL HAVE AT LEAST 12. APPLIANCES CONNECTED BY METAL-CLAD CABLE OR FLYBRIE CONDUIT SHALL HAVE AT LEAST 3 OF REFE CABLE OR CONDUIT TO PERMIT MOVING THE APPLIANCE

13. TYPE "NA" OR TYPE "SE" CABLE SHALL NOT BE USED TO CONNECT A RANGE OR DRYER DIRECTLY

BUT CAN BE USED TO A JUNCTION BOX OR RECEPTACLE OR RANGE OR DRYER.

14. SWITCHES SHALL BE ADEQUATELY RATED FOR LOAD CONNECT.

15. AT LEAST 6" OF FREE CONDUCTOR, MEASURED PROM THE MACE OF THE OUTLET BOX, SHALL BE LECTRICAL AND NON-ELECTRICAL METAL PARTS SHALL BE THROUGH A CONNECTION TO THE CROUNCING BUS IN THE MAIN DISTRIBUTION PANEL.

15. THE GREEN COLORED WIRE IN THE SUPPLY CORD OR FEEDER WIRING SHALL BE CONNECTED TO THE GROUNDING BUS IN THE MAIN DISTRIBUTION PANEL.

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20. OUTDOOR ELECTRICAL FUTURES AND EQUIPMENT SHALL BE LISTED FOR OUTDOOR USE. OUTDOOR ELECTRICAL FUTURES AND EQUIPMENT SHALL BE LISTED FOR OUTDOOR USE. OUTDOOR ELECTRICAL FUTURES AND EQUIPMENT SHALL BE LISTED FOR OUTDOOR SUE THE AT LEAST THAT IS WEATHER FRONT DOOR SUD ON THE GROUNDING BUT IN THE MAIN DISTRIBUTION PANEL.

21. ARRANGEMENTS SHALL HE OFF A GASKETED TYPE AND GREE PROTECTED. WET INCENTIAL END BY PAINTING.

22. AT LEAST TWO (2) EXTERIOR RECEPTACLES, APPROVED FOR SUCH USE, SHALL BE INSTALLED ON THE EXTERIOR OF THE HOMEACCESSILE AT CRADE EVEL. ONE (1) ON THE READY DORGHES ON STIE.

23. ALL BECTIFICATE SHALL BE INSTALLED WITHIN THE PERMITTER OF ALL BE INSTALLED WITHIN THE PERMIT ROY ALL BUT THIS THE THIS EXCEPTACLE SHALL BE PROVIDED AND INSTALLED BY OTHERS ON STIE.

24. ACH STRAP OR YOKE CONTAINING ONE OR MORE HER FROM HUSBED THE DEPLICATION THAT THE SHALL BE ROY DOWNED THE THE DEPLICATION OF THE HOME OF THE

26. EXTERIOR GFCI RECEPTACLES SHALL BE SUPPLIED BY AN ADJACENT LIGHTING CIRCUIT.
27. NO WIRING IS TO BE INSTALLED IN THE RETURN ARE PLENUMS.
28. ELECTRICAL TYPE HEATING ELEMENTS ARE TO BE SUBDIVIDED WITHIN THE UNIT SUCH THAT EACH SUBDIVIDED LOAD DOES NOT EXCEED \$6 ADDS.
29. BOXES USED AT LUMINAIRES OUTLETS IN CELLINGS SHALL BE DESIGNED FOR THAT PURPOSE AND REQUIRED TO SUPPORT A MIN. OF 50 Lbs., BOXES USED AT LUMINAIRE OUTLETS IN A WALL SHALL BE DESIGNED FOR THAT PURPOSE AND MARKED ON INTERIOR TO INDICATE THE MAX. WEIGHT THAT IS PERMITTED IF OTHER THAN 50 Lbs., A WALL MOUNTED LUMINAIRE WEIGHING NOT MORE THAN 6 Lbs., MAT BE SUPPORTED ON OTHER BOXES OR PLASTER RINGS.
30. OPENINGS AROUND ELECTRICAL PENETRATIONS THROUGH FIRE RESISTANT WALLS, PARTITIONS, 50. OPENINGS AROUND ELECTRICAL PENETRATIONS THROUGH FIRE RESISTANT WALLS, PARTITIONS, 50. OPENINGS AROUND ELECTRICAL PENETRATIONS THROUGH FIRE RESISTANT WALLS, PARTITIONS, 50. OPENINGS AROUND ELECTRICAL PENETRATIONS THROUGH FIRE RESISTANT WALLS, PARTITIONS, 50. OPENINGS AROUND ELECTRICAL PENETRATIONS THROUGH FIRE RESISTANT WALLS, PARTITIONS, 50. OPENINGS AROUND ELECTRICAL PENETRATIONS.

THE FIRE RESISTANCE RATING.

31. SERVICE EQUIPMENT SHALL BE SUITABLE FOR THE SHORT CIRCUIT (FAULT) CURRENT AVAILABLE AT ITS SUPPLY TERMINALS.

32. ALL RECEPTACLES TO BE OF THE GROUNDING TYPE.

33. ALL WIRING TO BE PER 2008 NEC W/TYPE "NM" ROMEX (CU) W/GROUND.

44. MAIN PANEL TO BE MARKED "SUITABLE FOR USE AS SERVICE EQUIPMENT" AND BE EQUIPPED WITH BREAKER/PUSE TYPE OVER CURRENT PROTECTION. 30" WIDEX 35" DEEP CLEAR WORKING BY A MAIN PANEL TO BE MARKED "SUITABLE FOR USE ALS SERVICE BY DEEP CLEAR WORKING SPACE SHALL BE PROVIDED IN PROMT OF THE ELECTRICAL PANEL.

55. PROPER THERMAL OVERLOAD PROTECTION TO BE PROVIDED FOR ALL MOTORS.

56. DISCONNECTING MEANS TO BE LOCATED WITHIN SIGHT FOR ALL MOTORS.

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57. WEATHERPROOF PROTECTION REQUIRED FOR ALL OUTDOOR LIGHT'S, RECEPTACLES AND DISCONNECTS.

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S8. PROPER WORKING CLEARANCE TO BE PROVIDED AND MAINTAINED AROUND ABOUT ALL ELECTRICAL EQUIPMENT.
39. ALL FLOURESCENT AND INCANDESCENT FIXTURES REQUIRE THERMAL PROTECTION AND

AND PROPER CLEARANCE FROM INSULATION

40. COMBINATION FAN/LIGHT AND ALL RECESSED INCANDESCENT FIXTURES TO BE WITH THERMAL PROTECTION

41. EXIT LIGHTS (IF ELECTRIC) MUST BE FED FROM AN APPROVED EMERGENCY SERVICE CONNECTED ATEAD OF BUT NOT WITHIN MAIN SERVICE DISCONNECTING MEANS ENCLOSURE. 42. ALL EQUIPMENT TO BE LISTED AND INSTALLED IN ACCORDANCE WITH 1T'S LISTING. 45. PROVIDE GFCI RECEPTACLE AND SWITCHED LIGHT FIXTURE AT CRAWL SPACE ACCESS FOR SERVICE OF ALL MECHANICAL SYSTEMS.

44. ALL FAMILY ROOMS, DINING ROOMS, LIVING ROOMS, PARLORS, LIBRARIES, DENS, BEDROOMS, SUNROOMS, RECREATION ROOMS, CLOSET, HALLWAYS OR SIMILAR AREA SHALL BE PROTECTED BY A LISTED ARCARULT CIRCULTI NITERINFER DEVICE OF THE COMBINATION TYPE.

45. REQUIRED RECEPTACLE OUTLETS SHALL NOT BE LOCATED ON ISLANDS OR PENINSULAS WHERE THE OVERHANG OF THE COUNTERTOP EXCEEDS 6 INCHES.

46. ALL 15 & 20 AMP RECEPTACLES SHALL BE LISTED AS TAMPER RESISTANT (TR).
47. A WALL SWITCH-CONTROLLED DUPLEX RECEPTACLE FOR ILLINATION SHALL BE SPLIT OR AN PLACEMENT REQUIREMENTS ADDITIONAL RECEPTACLE SHALL BE ADDED TO MEET THE GENERAL WALL SPACE RECEPTACLE

48. A MIN. OF ONE (1) COMMUNICATIONS OUTLET SHALL BE PROVIDED IN EACH DWELLING UNIT SEE PLAN FOR LOCATION.

ON-SITE ELECTRICAL CONNECTIONS

A QUALIFIED ELECTRICIAN DA ALL WORK AND CONNECTIONS OF THE ELECTRICAL SYSTEM. BECAUSE OF THE IMPOTANCE OF PROPER ELECTRICAL CONNECTIONS IT IS ADVISABLE TO HAVE

EACH UNIT WILL HAVE ELETRICAL CROSSOVERS LOCATED NEAR THE MARRIAGE LINE OF THE FLOOR. CONNECTIONS ARE TO BE MADE IN JUNCTION BOXES. CIRCUITS WILL BE IDENTIFIED FOR RANGE, DRYER, FURNACE, ETC., CONNECT LIKE CIRCUITS TOGETHER USING APPROPRIATE CONNECTORS. CONNECT BLACK TO BLACK, RED TO RED & WHITE TO WHITE ETC..

SOME HOMES MAY USE A "SNAP TOGETHER" QUICK CONNECT DEVICE AS SHOWN BELOW, FOLLOW INSTRUCTIONS AS SHOWN.

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SECTION AVG COPPER VIRE HOLES

1. LOCATE ELECTRICAL CROSSOVER(S) BY RED "X"
ON BOTTOM BOARD AT MARRIAGE LINE. REMOVE
TARE AND PULL OUT AMP CONNECTOR(S).
2. ORIENT THE SPLICES SO THE MATING ENDS ALIGN

WITH EACH OTHER.
3. SLIDE THE SPLICES INTO EACH OTHER UNTIL THE LOCKING LATCH ENGAGES THE LOCKING TAB. ONCE COUPLED, THE SPLICES "CANNOT" BE UNCOUPLED AND REUSED, THEY MUST BE REPLACED WITH A

4. COUPLED SPLICES CAN BE MOUNTED TO STUDS OR JOIST WITH 4d COMMON NAILS. CAUTION: "DO NOT USE OVERSIZE NAILS OR DRIVE NAIL HEADS INTO NEW DEVICE

5. AFTER ALL ELECTRICAL CROSSOVERS ARE LOCKED TOGETHER, PLACE ANY EXCESS "NM" CABLE BACK
INTO THE FLOOR CAVITY. PLACE BOTTOM BOARD
PATCH OVER ALL "NM" CABLES AND AMP CONNECTORS.
SECURE ALL AROUND WITH APPROVED BOTTOM BOARD

ELECTRICAL GENERAL NOTES

STEVEN PHILLIPS

DRAWING:

SHEET NO .:

YOUR LIFE YOUR HOME YOUR STYLE


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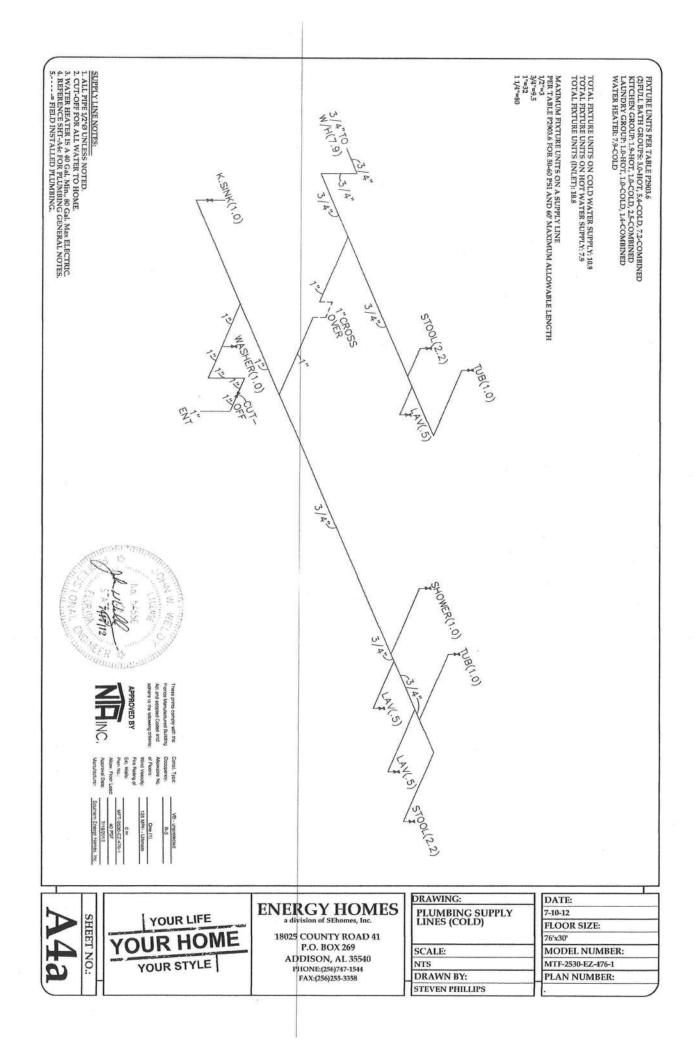



18025 COUNTY ROAD 41 P.O. BOX 269 ADDISON, AL 35540 FHONE:(256)747-1544 FAX:(256)255-3358

RAWING:	
PLUMBING DRAIN LINES	

SCALE: NTS DRAWN BY: STEVEN PHILLIPS

	- 1
DATE:	
7-10-12	
FLOOR SIZE:	
76'x30'	
MODEL NUMBER:	
MTF-2530-EZ-476-1	
PLAN NUMBER:	

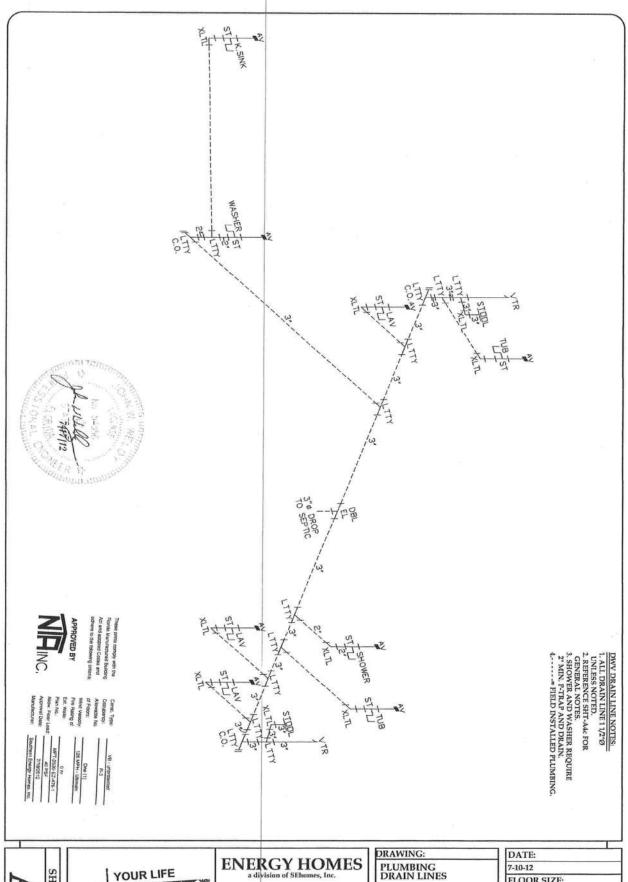

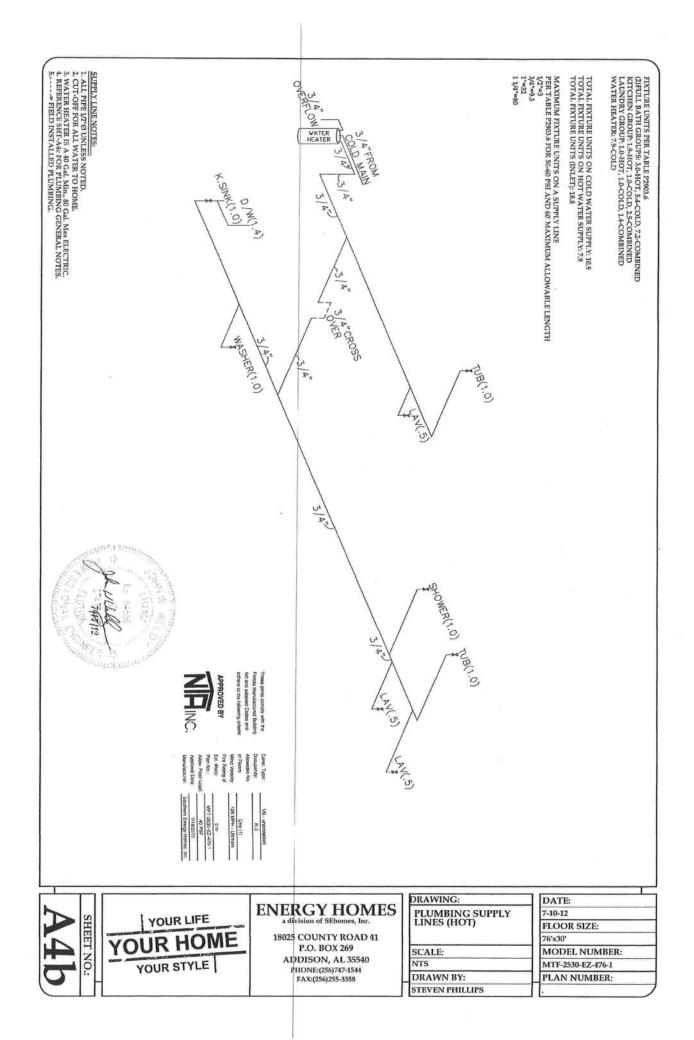

12. CLEAN OUTS SHALL BE THE SAME NOMINAL SIZE AS THE PIPE THEY ARE CONNECTED TO UP
12. CLEAN OUTS SHALL BE THE SAME NOMINAL SIZE, THE MINIMUM SIZE
10.4" (102 mm), FOR PIPES LARGER THAN 4" (102 mm) NOMINAL SIZE, THE MINIMUM SIZE
OF THE CLEAN OUTS ON 6" (133 mm) ANS SMALLER PIPES SHALL BE PROVIDED WITH A CLEARANCE OF
NOT LESS THAN 18" (457 mm) FOR RODDING. CLEAN OUTS ON 8" (203 mm) AND LARGER PIPES
SHALL GBE PROVIDED WITH A CLEARANCE OF NOT LESS THAN 8" (914 mm) FOR RODDING.
14. WATER CLOSET FLOOR PLANGE SECUREMENT TO THE FLOOR SHALL BE MADE USING CORROSION
RESISTANT SCREWS AND THE TOLLET SHALL BE SECURED TO THE FLANGE USING BOLTS MADE OF
OF BRASS OR OTHER CORROSION RESISTANT MATERIAL.
15. THE WALLS OF SHOWER COMPARTMENT SHALL BE CONSTRUCTED OF SMOOTH, NON-CORROSIVE
AND NONABSORBENT WATERPROOF MATERIALS TO HEIGHT NOT LESS THAN 6 FRET ABOVE
BATHROOM FLOOR LEVEL, SUCH WALLS SHALL FORM A WATER TIGHT JOINT WITH EACH OTHER
AND WITH THE BATHTUB, RECEPTOR OR SHOWER FLOOR.

16. CLOTHES WASHING MACHINE STANDPIPE SHALL EXTEND NOT LESS THAN 18 INCHES OR MORE
THAN 42 INCHES ABOVE ITS "P TRAP.

17. EACH PLUMBING FXTURE AND STANDPIPE SHALL EXTEND NOT LESS THAN 18 INCHES OR MORE
17. EACH PLUMBING FXTURE AND STANDPIPE RECEPTOR SHALL BE LOCATED AND INSTALLED IN A
MANURER TO BE ACCESSIBLE FOR USAGE, CLEANING, REPAIR AND REPLACEMENT.

18. FRATTRESS SHALL BE SEFT LEVEL, AND IN TRUE ALGOMENT WATH ADJACIENT WALLS AND WHERE
19. WALL HUNG FIXTURES SHALL BE RIGIDLY ATTACHED TO THE EIPING CONNECTION.

20. FLUSH TANNES SHALL BE SECURELY FASTENED TO THE EIPING CONNECTION.

MATERIALS. 21. BATHTUB RIMS AT WALL SHALL BE SUPPORTED ON METAL HANGERS OR ON WOOD BLOCKING ATTACHED TO THE WALL UNLESS OTHERWISE RECOMMENDED BY THE MANUFACTURER OF THE TUB. 22. PIPING SHALL BE INSTALLED WITHOUT UNDUE STRAIN AND STRESS WITH PROVISION FOR EXPANSION, CONTRACTION AND STRUCTURAL SETILEMENT.
23. ABS OR FVC PIPING SHALL BE SUPPORTED AT 4 FOOT INTERVALS UNLESS OTHERWISE STATED IN THE APPLICABLE MATERIAL STANDARDS OR BY THE PIPING MANUFACTURER.
24. THE OUTLETS OF FAUCETS, SPOUTS AND SIMILAR DEVICES SHALL BE SPACED AT LEAST 1 INCH ABOVE THE FLOOD LEVEL OF THE FIXURE.
25. FLUSH TANKS SHALL BE EQUIPPED WITH AN APPROVED OR LISTED ANTI SIPHON BALL COCK INSTALLED AND MAINTAINED WITH ITS OUTLET OR CRITICAL LEVEL MARK NOT LESS THAN 1 INCH ARROY THE HILL OPENING OF THE OUTLET OR CRITICAL LEVEL MARK NOT LESS THAN 1 INCH ABOVE THE FULL OPENING OF THE OVERFLOW PIPE.

26. PIPE JOINT COMPOUNDS SHALL BE APPLIED TO MALE THAN ONE THAN ONE FIXTURE SHALL HAVE A
27. LINE VALVES WHICH CONTROL THE WATER FLOW TO MORE THAN ONE FIXTURE SHALL HAVE A
27. LINE VALVES WHICH COUNTROL THE WATER FLOW TO MORE THAN ONE FIXTURE SHALL HAVE A
27. LINE VALVES HALL CETEND THROUGH THEER FEASHING AND TERMINATE VERTICALLY NOT LESS
28. VENT PIPES SHALL EXTEND THROUGH THEER FEASHING AND TERMINATE VERTICALLY NOT LESS
THAN 6 INCHES (MIN.) ABOVE THE ROOF AT THE HIGHEST POINT. 30. ALL HOMES EQUIPPED WITH HOSE BIBS SHALL BE SUPPLIED WITH APPROPRIATE BACK FLOW
PREVENTION DEVICES ON EACH HOSE BIB. APPROPRIATE BACK FLOW PREVENTION DEVICES
SHALL INCLUDE THREADED DEVICES WHICH CONNECT THE OUTLET AS WELL AS INLINE DEVICES. APPROVED BY
31. DIELECTRIC FITTINGS OR OTHER APPROPRIATE MATERIALS SHALL BE USED WHEN DISSIMILAR 29. VENT CAPS, IF APPROVED, SHALL BE OF THE REMOVABLE TYPE WITHOUT REMOVING THE FLASHING FROM THE ROOF. WALLS, FLOORS OR ROOFS.

WALLS, FLOORS OR ROOFS.

6. PLASTIC PRIPM SHALL NOT BE EXPOSED TO HEAT IN EXCESS OF MANUFACTURERS

RECOMMENDATION OR RADIATION FROM HEAT PRODUCING APPLIANCES.

7. TWO LAVATORIES CONNECTED WITH CONTINUOUS WASTE CONNECTED TO ONE "P" TRAP SHALL

HAVE THEIR WASTE OUTLETS NOT MORE THAN 30 INCHES APART.

8. EACH "P" TRAP SHALL HAVE WATER SEAL OF NOT LESS THAN 2 INCHES AND NOT MORE 1. ALL PLUMBING MATERIALS, DEVICES, FIXTURES, FITTING, EQUIPMENT, APPLIANCES AND ACCESSORIES INSTALLED SHALL BE LISTED OR CERTIFED BY AN APPROVED LISTING AGENCY (NSF. LAPMO, GFT, ETC...) OR SHALL BE SPECHFCALLY APPROVED.

2. ALL VALVES, PIPES AND FITTINGS SHALL BE INSTALLED IN CORRECT RELATIONSHIP TO THE 92. EACH HOME SHALL HAVE A 3 INCH MAIN VENT EXTENDING THROUGH AND TERMINATING 6 INCHES (MIN.) ABOVE THE ROOF AT THE HIGHEST POINT. 11. TRAPS SHALL BE ACCESSIBLE FOR REPAIR AND INSPECTION AND SHALL BE DESIGNED AND 10. TRAP ARMS SHALL BE GRADED 1/4 INCH PER FOOT TOWARDS VENT AND SHALL NOT HAVE ENTRANCE OF RODENTS. FIRE BLOCKING SHALL BE PROVIDED AT OPENINGS AROUND VENTS, PIPES AND DUCTS AT CEILING AND FLOOR LEVEL, WITH AN APPROVED MATERIAL TO RESIST THE FREE PASSACE OF FLAME AND PRODUCTS OF COMBUSTION. INSTALLED SO THE U BEND IS REMOVABLE A SLOPE GREATER THAN ITS DIAMETER A INCHES AND SHALL BE SET TRUE TO ITS SEAL.

NET TAIL PIECES SHALL NOT EXCEED 24 INCHES IN LENGTH. i, PLUMBING, PIPING AND ELECTRICAL WIRING SHALL NOT PASS THROUGH THE SAME HOLES IN I. ALL EXTERIOR OPENINGS AROUND PIPING AND EQUIPMENT SHALL BE SEALED TO RESIST THE WATER, MUD AND/OR ROAD DAMAGE SHALL BE ADEQUATELY PROTECTED FROM DETERIORATION . ALL PIPING, PIPE THREADS, HANGERS AND SUPPORTS WHICH ARE EXPOSED TO THE WEATHER, adhers to the following criteria: 44. ALL LAVATORIES MUST HAVE WASTE OUTLETS NOT LESS THAN 1 1/4 INCHES IN DIA.
45. ALL TUBS MUST HAVE WASTE OUTLETS NOT LESS THAN 1 1/2 INCHES IN DIA.
46. ALL SHOWER COMPARTMENTS WILL HAVE AT LEAST 900 SQ, INCHES OF FLOOR AREA AND
BE OF SUPPRICIESY 15ZET O INSCRIBE A CIRCLE WITH A DIAMETER NOT LESS THAN 397
AT, SINKS WILL HAVE WASTE OUTLETS NOT LESS THAN 1 1/2 INCHES IN DIAMETER.
A STRAINER OR A CROSS BAR SHALL BE PROVIDED IN DRAIN. A STRAINER OR A CROSS BAS SHALL BE PROVIDED AS TO RESTRICT THE CLEAR OPENING OF THE SINK WASTE OUTLET.
46. DOMESTIC FOOD-WASTER GRINDERS WILL BE CONNECTED TO DRAINS NOT LESS THAN
11/2 INCHES IN DAMETER.
47. DISH WASHING MACHINES HALL DISCHARGE INTO THE DRAINAGE SYSTEM THROUGH AN
APPROVED AIR CAP PITTING.
48. DISH WASHER SUPPLY TO A CLOTHES WASHER SHALL BE PROTECTED TO DRAINS NOT LESS THAN
11/2 INCHES IN DAMETER.
49. DISH WASHER WILL DISCHARGE INTO THE DRAINAGE SYSTEM THROUGH AN
APPROVED AIR CAP PITTING.
49. THE WASTE RUPLL DISCHARGE INTO THE DRAINAGE SYSTEM THROUGH AN
APPROVED AIR CAP POR BACK FLOW PREVENTER. THE WASTE FROM THE CLOTHES
WASHER WILL DISCHARGE THROUGH AN AIR BREAK.
49. DISH WASHER WILL DISCHARGE INFO OR PREVENTER.
49. DISH WASHER WILL DISCHARGE INFO OR PREVENTER.
49. LIVER WASTE RUPL DO NOT EXCEED 189° F.
50. LIVER WILL DE USED ONLY WHEN WATER TEMPERATURE DOES NOT EXCEED 189° F.
51. WATER HAMMER, THE FLOW VELOCITY OF THE WATER DISTRIBUTION SYSTEM SHALL BE
CONTROLLED TO REDUCE THE POSSIBILITY OF WATER HAMMER, ARRESTOR
SHALL BE INSTALLED WHERE QUICK-CLOSING VALVES ARE UTILIZED, UNLESS OTHERWUSE
APPROVED. WATER HAMMER ARRESTORS SHALL BE INSTALLED IN ACCORDANCE WITH THE
MANUEACTURER SUSTALLED WHERE QUICK-CLOSING VALVES ARE UTILIZED, UNLESS OTHERWUSE
APROVED. WATER HAMMER ARRESTORS SHALL BE INSTALLED BY THE APPROPRIATE
THE PRESSURE BALANCE THE THERMOSTATIC MIXING VALVE ARE BEQUIPPED
WALLE BE WEIGLA.
51. ALL STORM SHALL BE SET ALANCE THE THERMOSTATIC MIXING OR THE
COMBINATION PRESSURE BALANCE/THERMOSTATIC MIXING VALVE TYPE WITH HIGH LIMIT STOPS
SHALL BE SO R NOTCHES
54. IN CO COMPLY WITH ASSE 1080. THEY SHALL BE INSTALLED PER THEIR INSTALLATION
INSTRUCTIONS.

34. ALL SHOWERS AND CLOTHES WASHER STANDPIPES SHALL HAVE 2 INCH "P" TRAPS.

35. PLUMBING FIXTURES WILL BE OF WATER CONSERVING TYPES, PER CODE LISTINGS.

36. EXTERIOR LOAD BEARING WALL BE DEWETRATIONS FOR PLUMBING VENTS ARE REQUIRED TO BE REINFORCED WITH 24 GAUGE STEEL ANGLE OR EQUIVALENT.

37. WATER SUPPLY LINES TO BE. COPPER, POLYBUTYLENE OR CPCC.

38. WATER PERING TO BE SUPPORTED AT CAPPER/GALVALEDA FOOT O.C., CPVC-3 FOOT O.C.

39. A SHUT OFF VALVE IS TO BE LOCATED AT EACH FIXTURE.

40. FULL SIZED SHUT OFF VALVE TO BE LOCATED AT EACH FIXTURE.

41. WHEN A LAVATORY IS MOUNTED IN A COUNTER THE FRONT EDGE OF THE LAVATORY SHALL TO ASSOR PYC.

42. MAXIMUM TRAP TO VENT DISTANCE. AND REPAIR. THAT IDENTIFIES THE DEVICE IT SHUTS OFF PROTECTED BY SHIELD PLATES. THE PLATES (MIN. 1/16" STEEL) SHALL COVER THE AREA OF THE PRE WHERE THE MEMBER IS NOTCHED OR BORED AND SHALL EXTEND A MINIMUM 2 INCHES ABOVE THE BOTTOM PLATE AND BELOW THE TOP PLATE.

57. THE PUMP SHALL BE ACCESSIBLE ON ALL WHIRLPOOL BATHTURS.

58. THE PUMP SHALL BE ACCESSIBLE ON ALL WHIRLPOOL BATHTURS. 33. BRANCH TYPE VALVES SHALL COMPLY WITH ASSE 1051 OR STACK TYPE (IF USED) SHALL 56. IN CONCEALED LOCATIONS WHERE PIPING IS INSTALLED THROUGH HOLES OR NOTCHES LESS THAN 1 1/2 INCHES FROM NEAREST EDGE OF MEMBER, THE PIPE SHALL BE AT LEAST 12 INCHES IN ITS SMARTHST DIMENSION TOUTBOATDE ACCESS FOR INSPECTION VB - unprotected GONNECTIONS SHALL BE PROVIDED WITH A ACCESS DRAWING: DATE: **ENERGY HOMES** PLUMBING GENERAL NOTES 7-10-12 YOUR LIFE SHEET NO .:

18025 COUNTY ROAD 41 P.O. BOX 269

ADDISON, AL 35540

PHONE:(256)747-1544 FAX:(256)255-3358

SCALE:

DRAWN BY: TEVEN PHILLIPS

NTS

YOUR HOME

YOUR STYLE


FLOOR SIZE:

MODEL NUMBER:

MTF-2530-EZ-476-1

PLAN NUMBER:

76'x30'

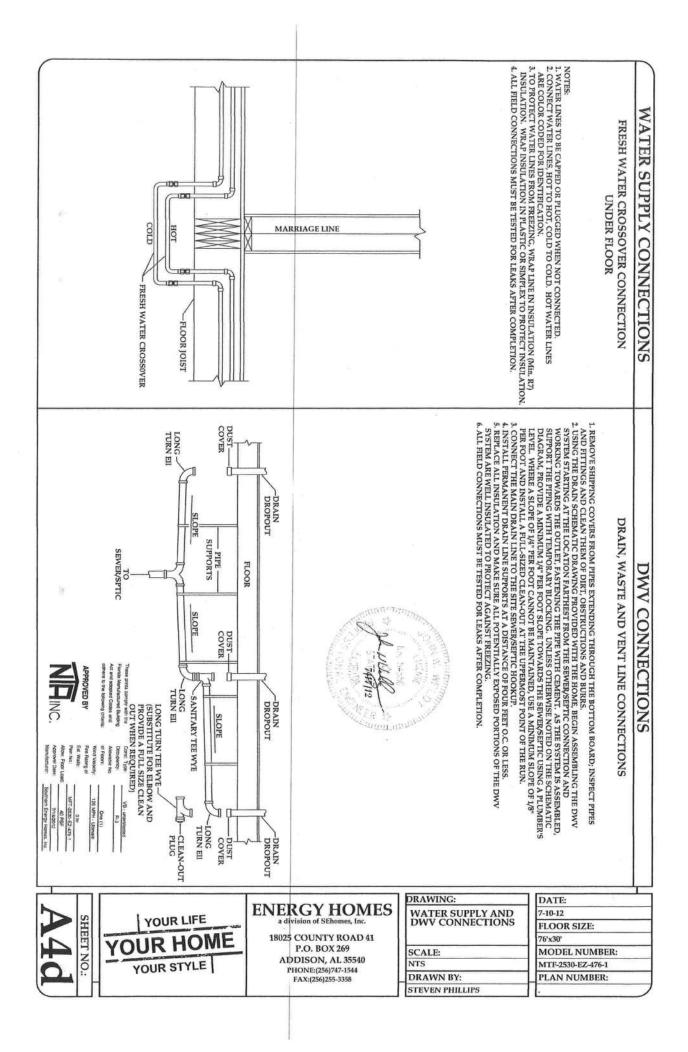

4. CROSS OVER DUCT 12" FLEX, INSULATED TO R-8 (FIELD INSTALLED)
5. FRIMARY RETURN PROVIDED BY METAL LOUVERED DOOR AT FURNACE.
6. ALL INTERIOR DOORS, EXCEPT CLOSETS AND SECONDARY BATHROOMS
WILL HAVE A 24"-34" RETURN AIR GRILL PROVIDED IN THEM. THIS
24"-34" GRILL MANUFACTURED BY CARPATHLA INDUSTRIES PROVIDES
25"-54" GRILL MANUFACTURED BY CARPATHLA INDUSTRIES PROVIDES
70 Sq. Im., OF FREE AIR WHICH WILL ACCOMMODATE A ROOM AREA UP TO
380 Sq. FL., MIX ROOM OR COMBINATION OF ROOMS GREATER THAN
380 Sq. FL. MILL HAVE AN INDICATION OF TRAG" ON THE SUBMITTED
BLOOR PLAN INDICATING ADDITIONAL RETURN AIR PROVISIONS SHALL
BEE BROWNERS. NOTES:

- ALL APPLIANCES ARE TO BE LISTED. REGISTER BOX (TYP).
3. ALL FLEX DUCT INSULATED R-8 (TYP). .016 METAL REGISTERS W/ALUM. RISER AND 3/4" FIBERGLASS APPROVED BY Southern Energy Homas, Inc. One (1) 26 MPH - Utimate 63'-4" 541-0 O DISTRIBUTION BOX CRO CS CROSS-OVER INSTALLATION 0* DUCT Ωĺ CROSS-OVERin in 8×40′-8 WALL 26'-0 BOX 5/5 0 Ð CS



3. USING THE PROVIDED FLEXIBLE DUCT, JOIN THE DISTRIBUTION BOXES IN EACH SECTION OF THE HOME AS SHOWN IN THE DETAIL ABOVE, CUTTING OFF ANY EXTRA DUCT LINGTH TO KEEP THE DUCT AS STRAIGHT AS POSSIBLE. THE DUCT MUST BE JOINED WITH THE PROVIDED CONNECTORS, AS TEACH CONNECTION POINT BETWEEN DUCTS AND DISTRIBUTION BOXES OR CONNECTORS, SECURE THE INNER LINER WITH A NYLON STRAP, APPLY MASTIC COMPLETELY OVER THE CONNECTION ARE, PULL THE DUCT INSULATION AND OUTER LINER OVER THE CONNECTION ARE, PULL THE DUCT INSULATION AND OUTER LINER OVER THE CONNECTION AREA AND SECURE THEM WITH A SECOND NYLON STRAP.

1. ONE SIDE OF THE CROSS-OVER DUCT HAS BEEN INSTALLED/ATTACHED TO A DIFFUSER/DISTRIBUTION BOX AT THE FACTORY. AN ADEQUATE LENGTH OF DUCT WILL BE LOCATED ON THE ATTACHED SIDE TO COMPLETE THE CROSS-OVER PROCESS.

2. ACCESS THE CROSS-OVER LOCATION THROUGH AN ACCESS PANEL IN THE CEILING AND REMOVE ANY TEMPORARY SHIPPING PROTECTION.

EXACT LOCATION OF DISTRIBUTION BOXES MAY VARY FROM THIS LOCATION

7. WHEN A FURNACE OR AIR-HANDLER IS INSTALLED IN THE UTILITY ROOM A FURNACE OR AIR-HANDLER IS INSTALLED IN THE UTILITY ROOM DOOR SHALL BE PROVIDED WITH A "FAG" SAITSFYING THE ETURN AIR REQUIREMENTS OF THE FURNACE/AIR-HANDLER.

8. DUCT INSULATION: ALL PORTIONS OF THE AIR DISTRIBUTION SYSTEMS SHALL BE INSTALLED IN ACCORDANCE WITH SECTION MISOI AND BE INSULATED TO AN INSTALLED R-3 WHEN THE SYSTEM COMPONENTS ARE LOCATED WITHIN THE BUILDING, BUT OUTSIDE THE OF CONDITIONED SPACE, AND R-8 WHEN LOCATED OUTSIDE OF THE BUILDING, WHEN LOCATED WITHIN A BUILDING ENVELOPE ASSEMBLY, AT-LEAST R-8 SHALL BE APPLIED BETWEEN THE DUCT AND THAT PORTION OF THE ASSEMBLY FURTHEST FROM CONDITIONED SPACE.

9. FURNACE TO BE A NORDYNE, ESEB-C20H.

10. PORTIONS OF THE FLOOR PLAN HAAVE BEEN REMOVED FOR CLARITY.

BE PROVIDED





ENERGY HOMES


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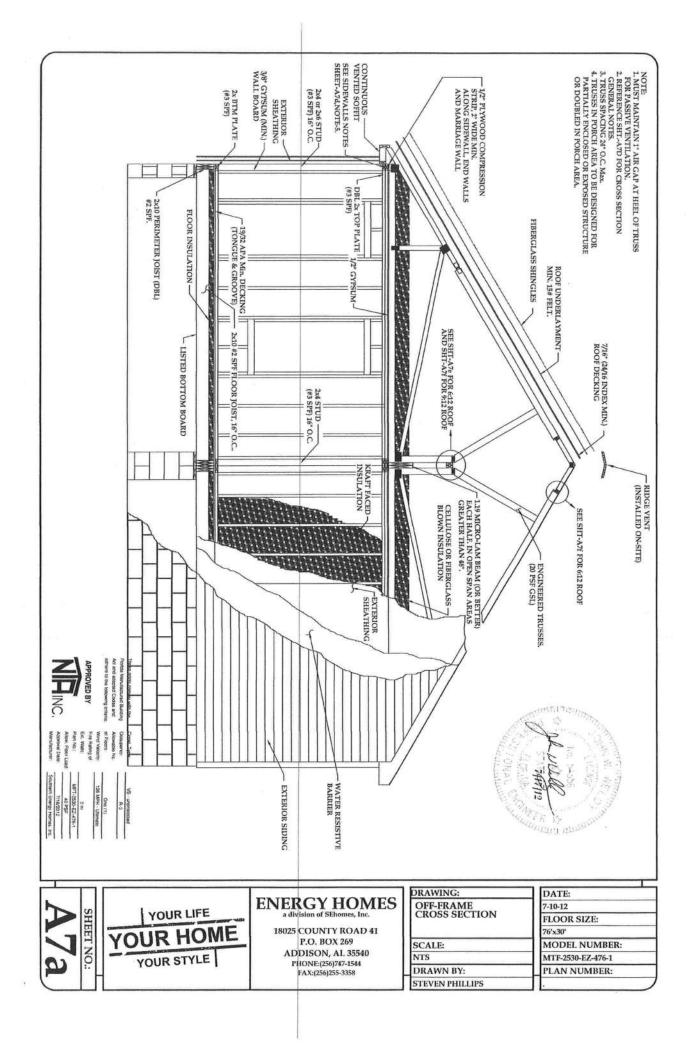
RAWING:	
HVAC LAYOUT	
SCALE;	π
l/8" = 1'-0"	
DRAWN BY:	
TEVEN PHILLIPS	


DATE:	
7-10-12	
FLOOR SIZE:	
76'x30'	
MODEL NUMBER:	
MTF-2530-EZ-476-1	77-77
PLAN NUMBER:	




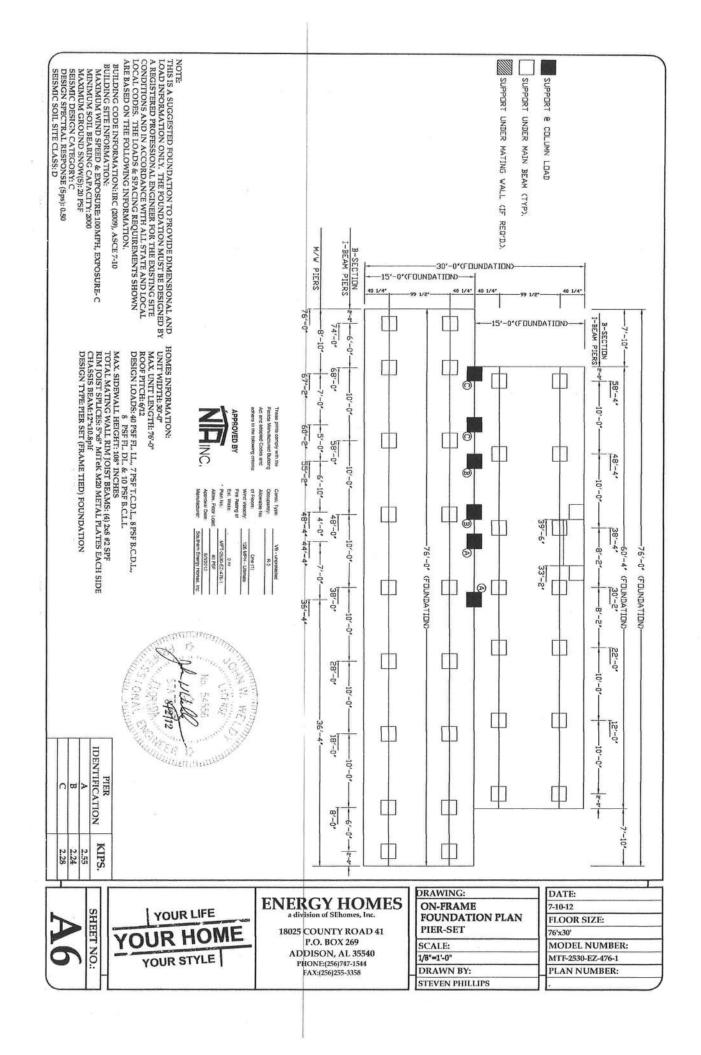

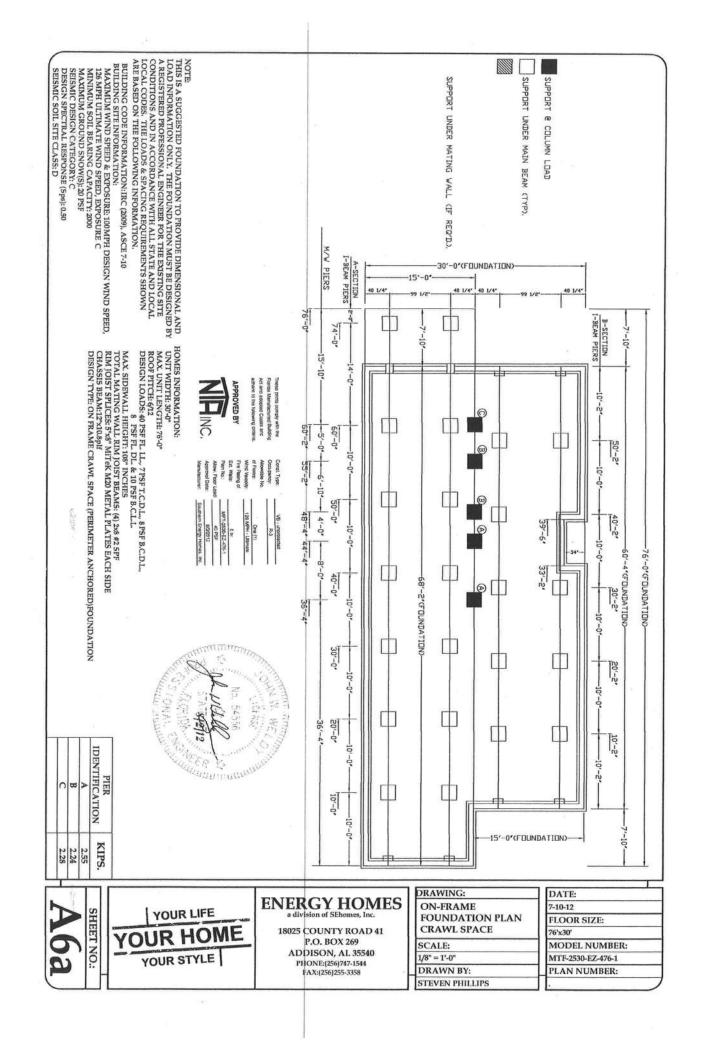

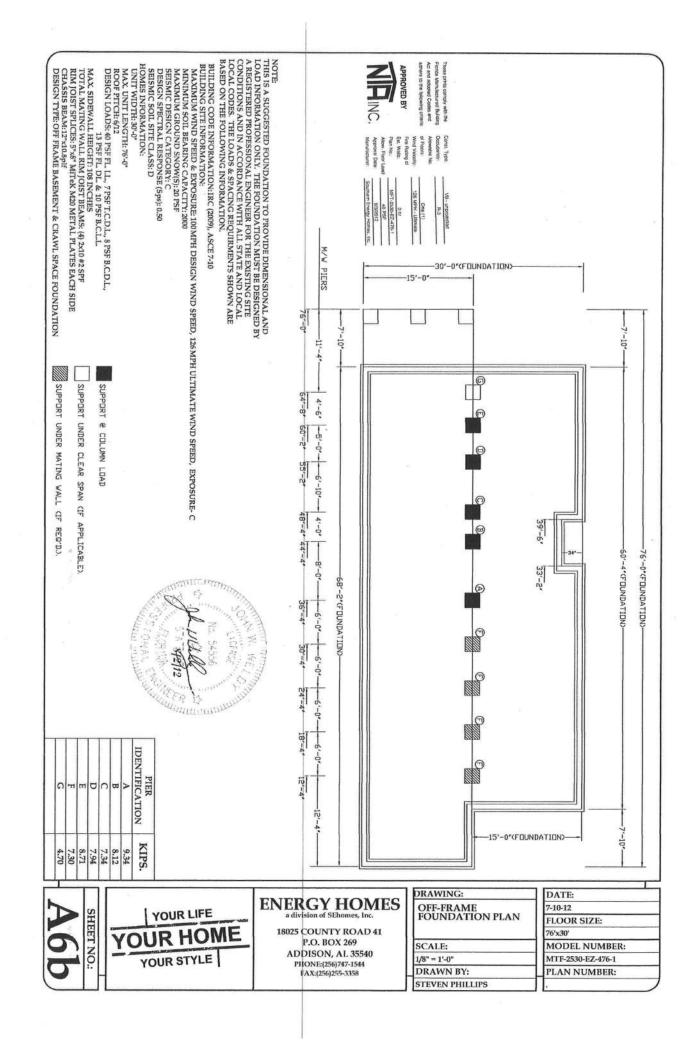

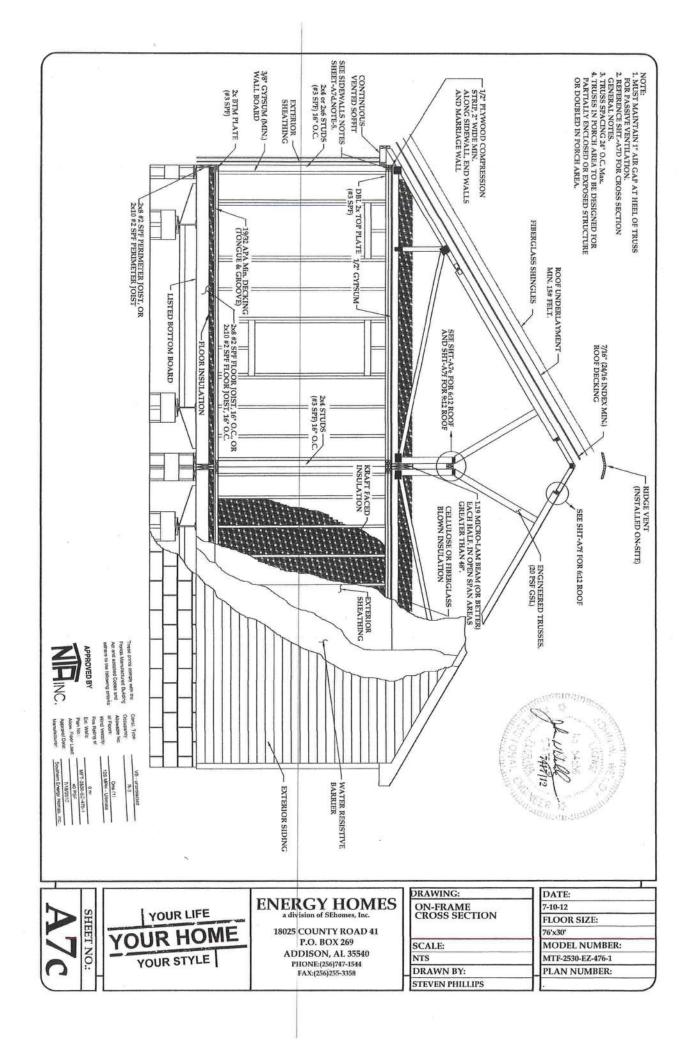

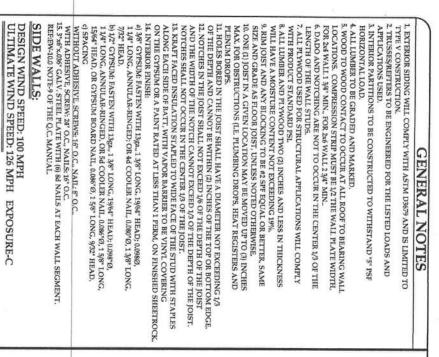





2x4 #3 SPF STUDS, 16" O.C. 108"-SIDEWALLS: 2x4 #3 SPF STUDS, 16" O.C.

96"-SIDEWALLS:



YOUR LIFE
YOUR HOME
YOUR STYLE

ENERGY HOMES

a division of SEhomes, Inc.

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DRAWING:
CROSS SECTION
GENERAL NOTES.
SCALE:
NTS

DRAWN BY:

STEVEN PHILLIPS

DATE: 7-10-12 FLOOR SIZE: 76'x30' MODEL NUMBER: MTF-2530-EZ-476-1 PLAN NUMBER:

