


ACTION SIGN & GRAPHICS

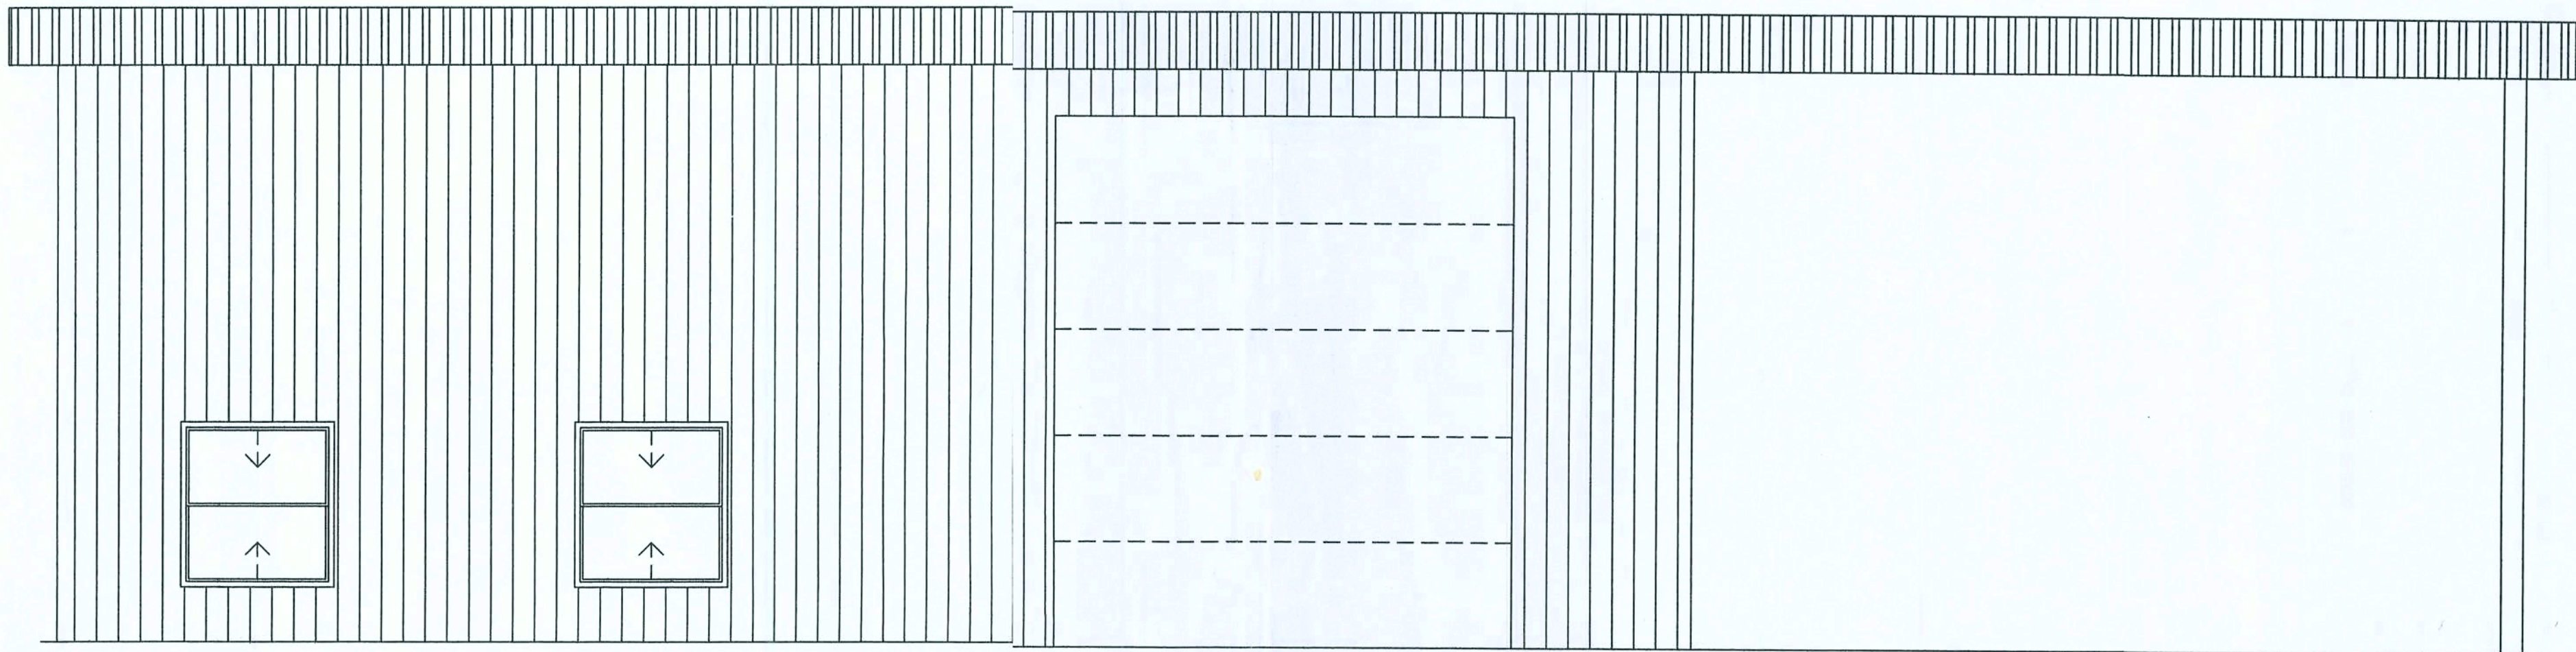

NEW OFFICE CONSTRUCTION COLUMBIA COUNTY, FL.

APPLICABLE CODES

2004 FLORIDA BUILDING CODE

OCCUPANCY CLASS

CLASS B BUSINESS & CLASS S-2 LOW HAZARD STORAGE

TYPE OF CONSTRUCTION

TYPE 5, UNPROTECTED

OCCUPANCY LOAD/EGRESS REQUIREMENTS

BUSINESS AREA 100 GROSS SQ. FT. / OCCUPANT x 938.5 SQ. FT. = 9 OCCUPANTS

STORAGE AREA 100 GROSS SQ. FT. / OCCUPANT x 1427 SQ. FT. = 14 OCCUPANTS

CONSTRUCTION DOCUMENTS

THE CUSTOMER IS RESPONSIBLE FOR DELIVERING THE REQUIRED SETS OF CONSTRUCTION DOCUMENTS TO THE PERMIT ISSUING AUTHORITIES, FOR THE ISSUANCE OF CONSTRUCTION PERMITS. THE CONTRACTOR SHALL REVIEW THE CONSTRUCTION DOCUMENTS AND VERIFY ALL DIMENSIONS. ANY DISCREPANCIES SHALL BE REPORTED TO YOUR SALES REPRESENTATIVE PRIOR TO THE COMMENCEMENT OF ANY WORK OR FABRICATION OF ANY MATERIALS.

DO NOT SCALE OFF THESE PLANS

AMPLE DIMENSIONS ARE SHOWN ON THE PLANS TO LOCATE ALL ITEMS. SIMPLE ARITHMETIC MAY BE USED TO DETERMINE THE LOCATIONS OF THOSE ITEMS NOT DIMENSIONED.






P.O. Box 187
130 West Howard Street
Live Oak FL, 32064
Phone: (386) 362-3678
Fax: (386) 362-6133

Gary Gill, PE
Auth. # 9461



INDEX

A-1.0	FLOOR PLAN
A-2.0	OFFICE FRAMING PLAN
A-3.0	REFLECTED CEILING PLAN
A-4.0	ELEVATIONS
A-5.0	LIFE SAFETY
E-1.0	ELECTRICAL PLAN
E-1.1	ELECTRICAL SCHEDULE & NOTES
M-1.0	MECHANICAL PLAN
P-1.0	SANITATION PLAN
P-2.0	PLUMBING PLAN
S-1.0	FOUNDATION PLAN
S-2.0	GENERAL NOTES

G. Gill
4/12/06

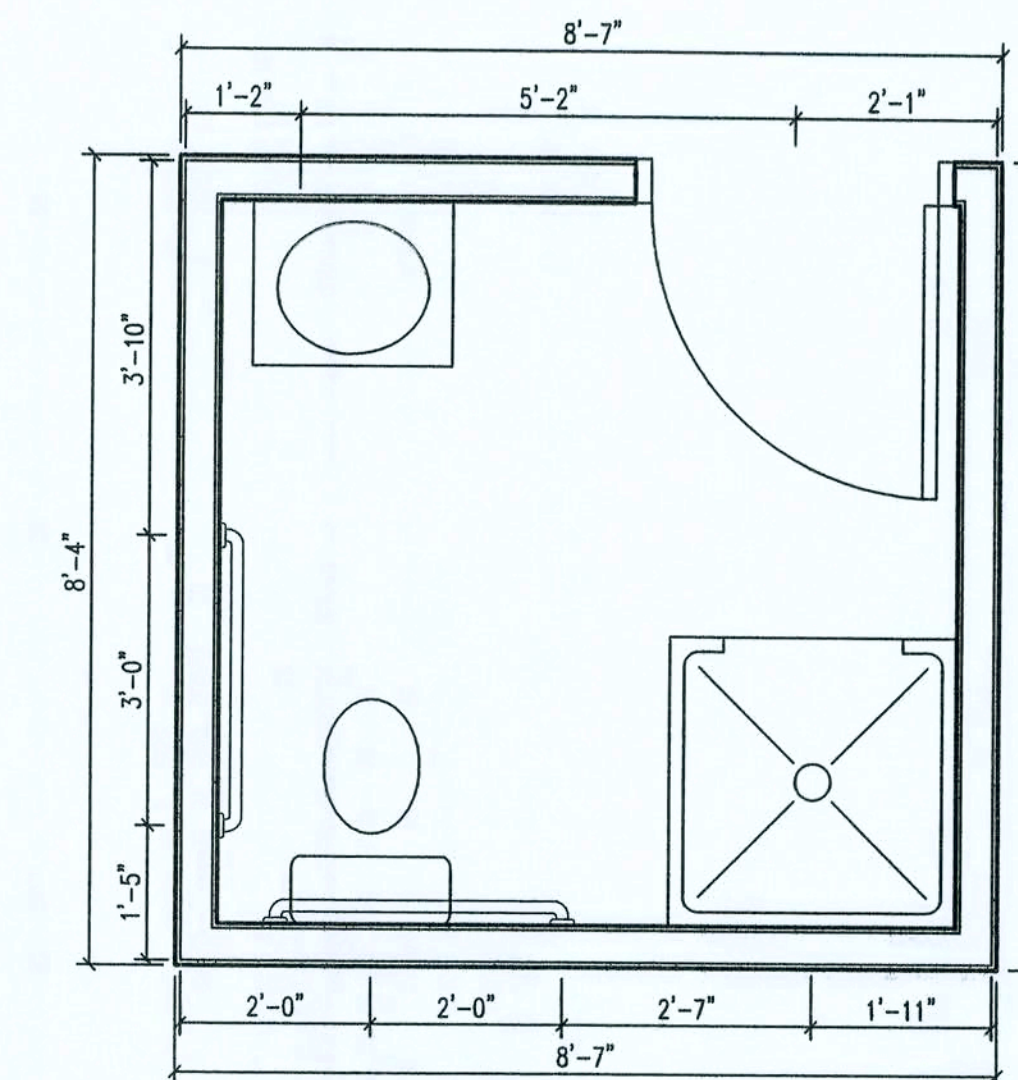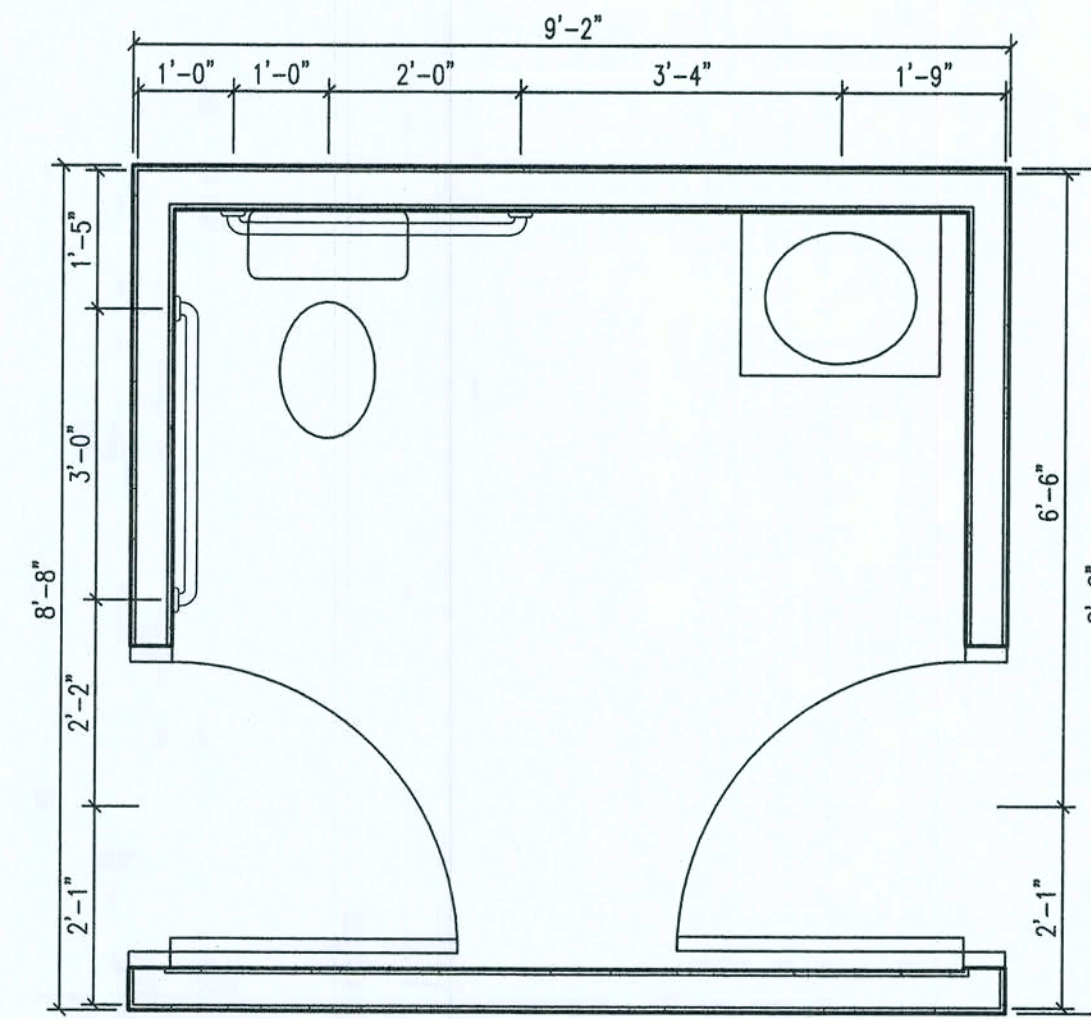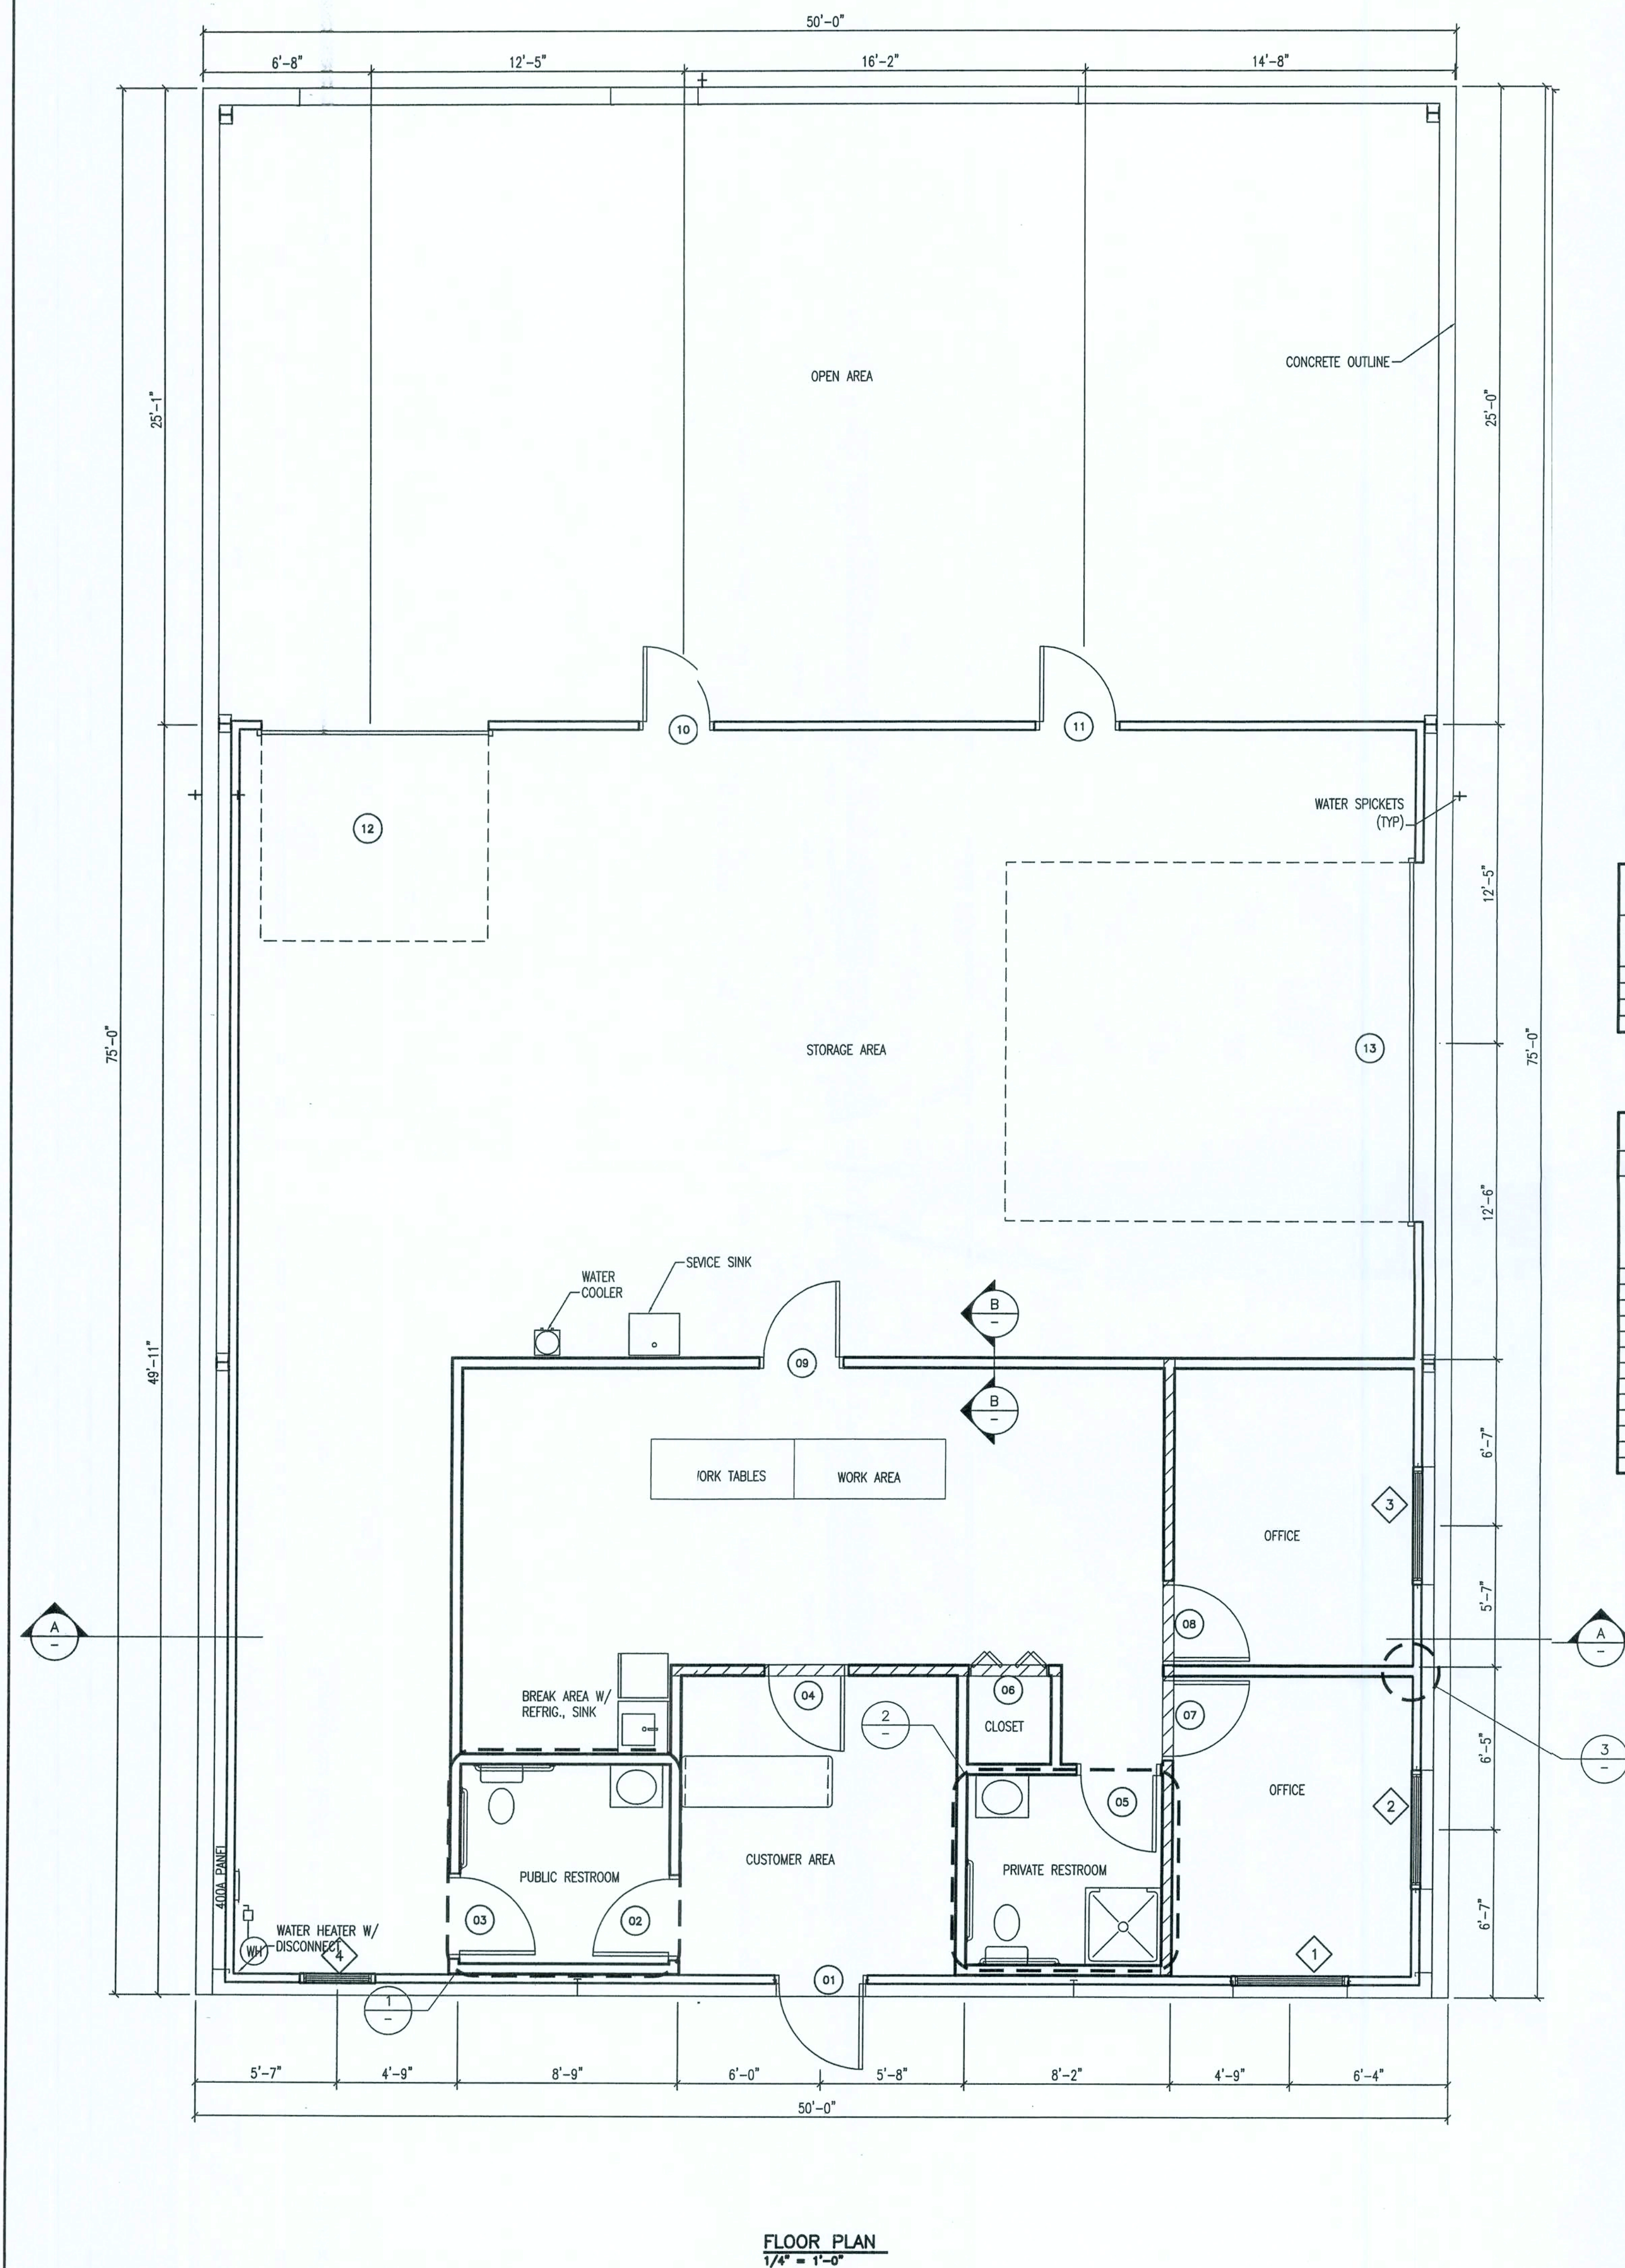

WINDOW SCHEDULE					
MARK	SIZE		TYPE	MATERIAL	NOTES
	WIDTH	HEIGHT			
1	4'-8"	5'-0"	--	--	--
2	4'-8"	5'-0"	--	--	--
3	4'-8"	5'-0"	--	--	--
4	3'-0"	6'-0"	--	--	--

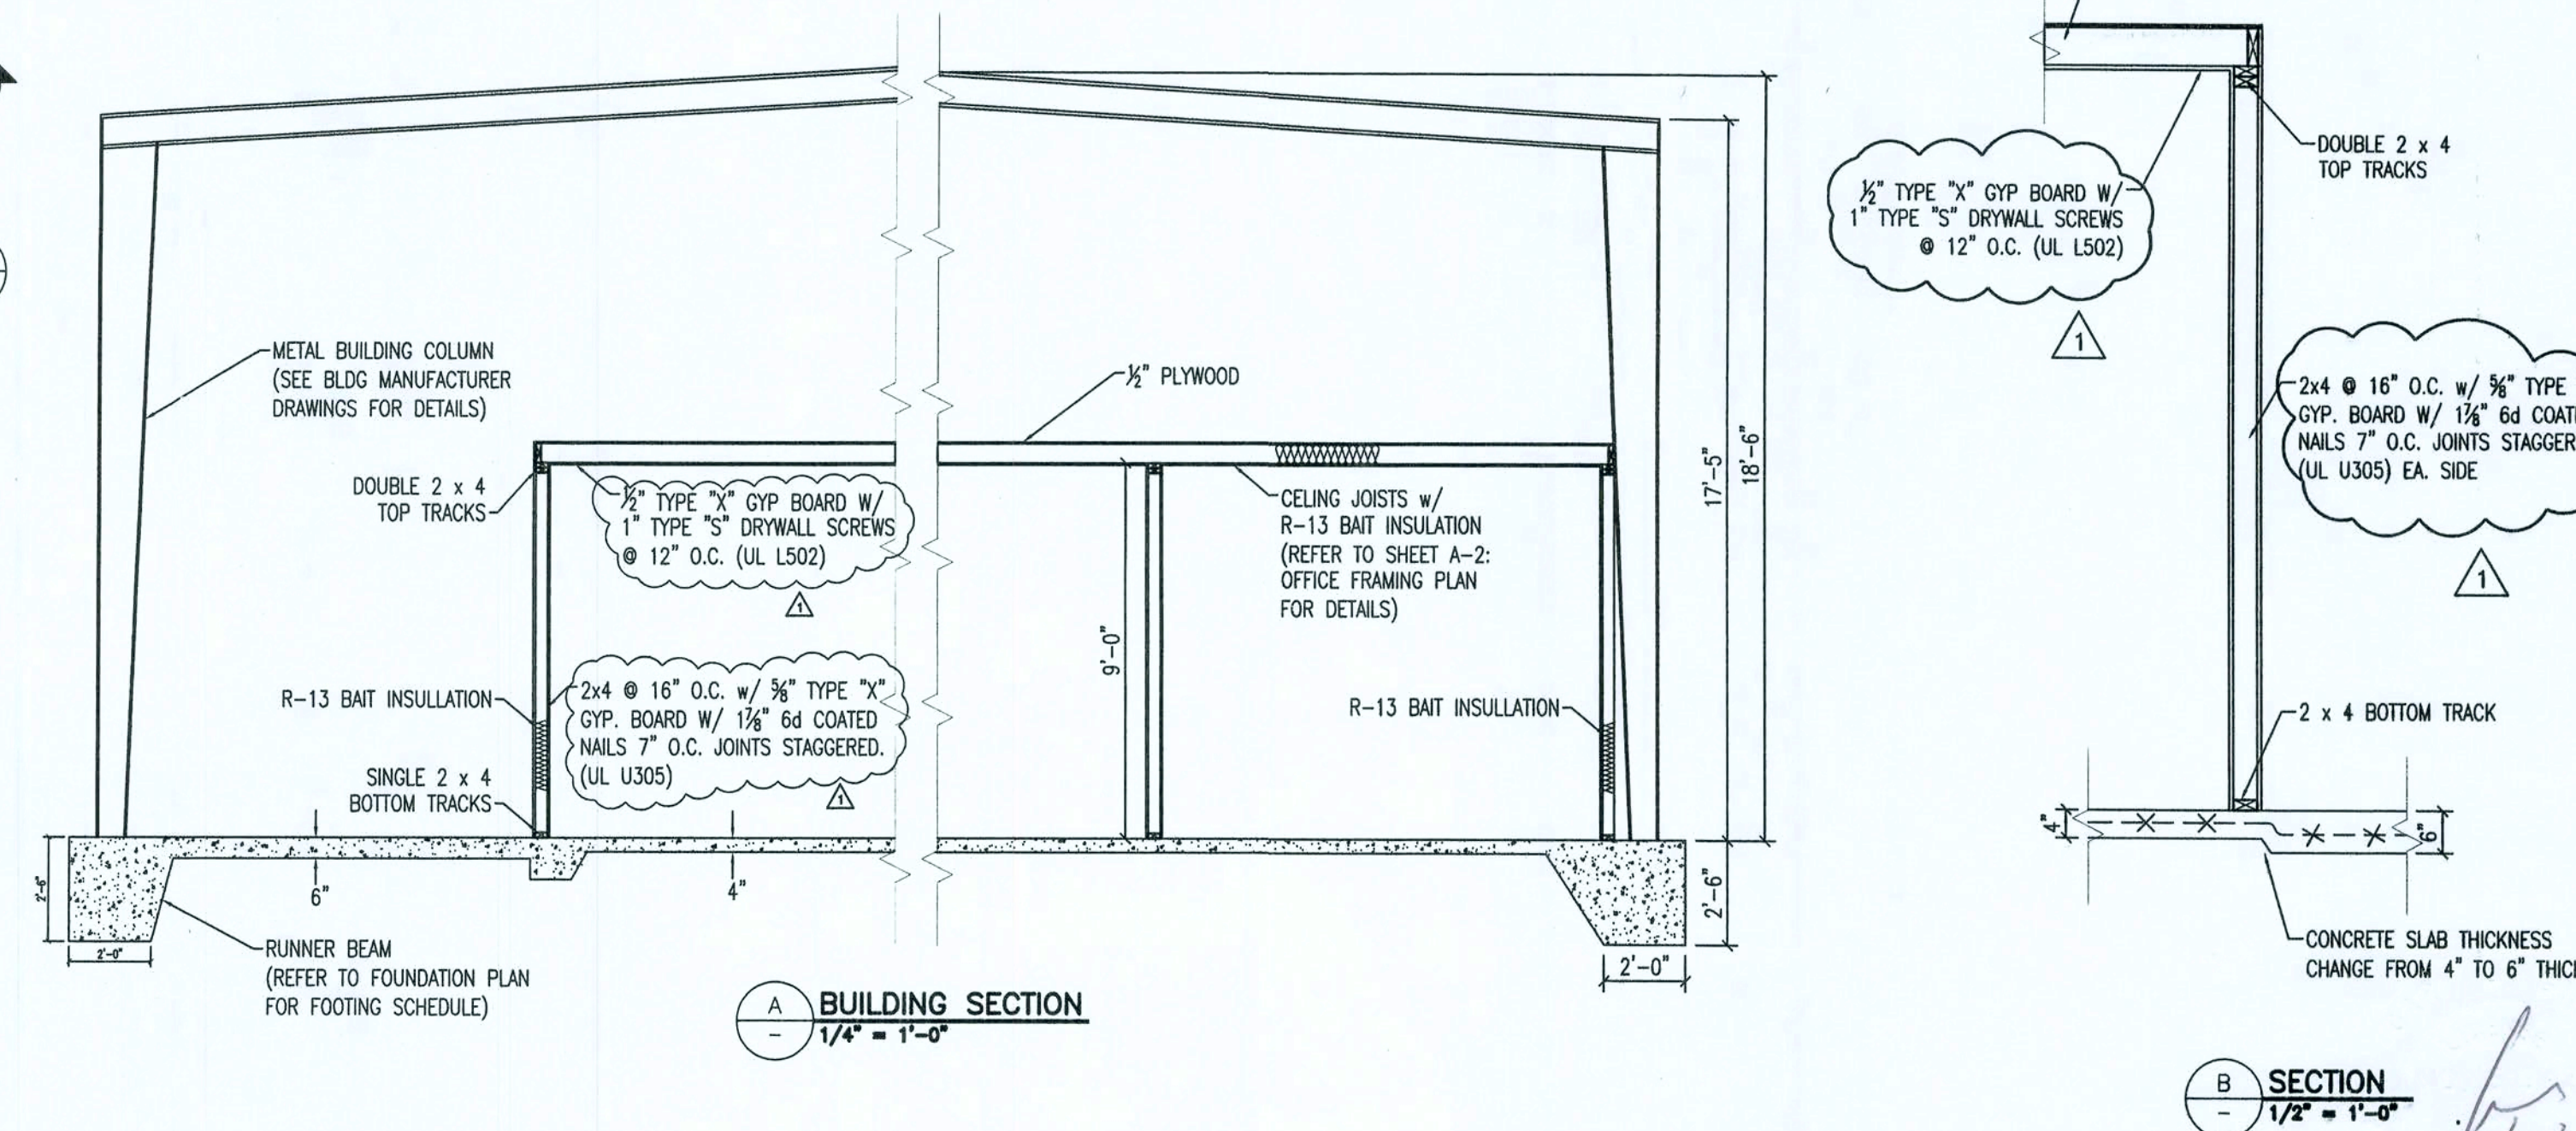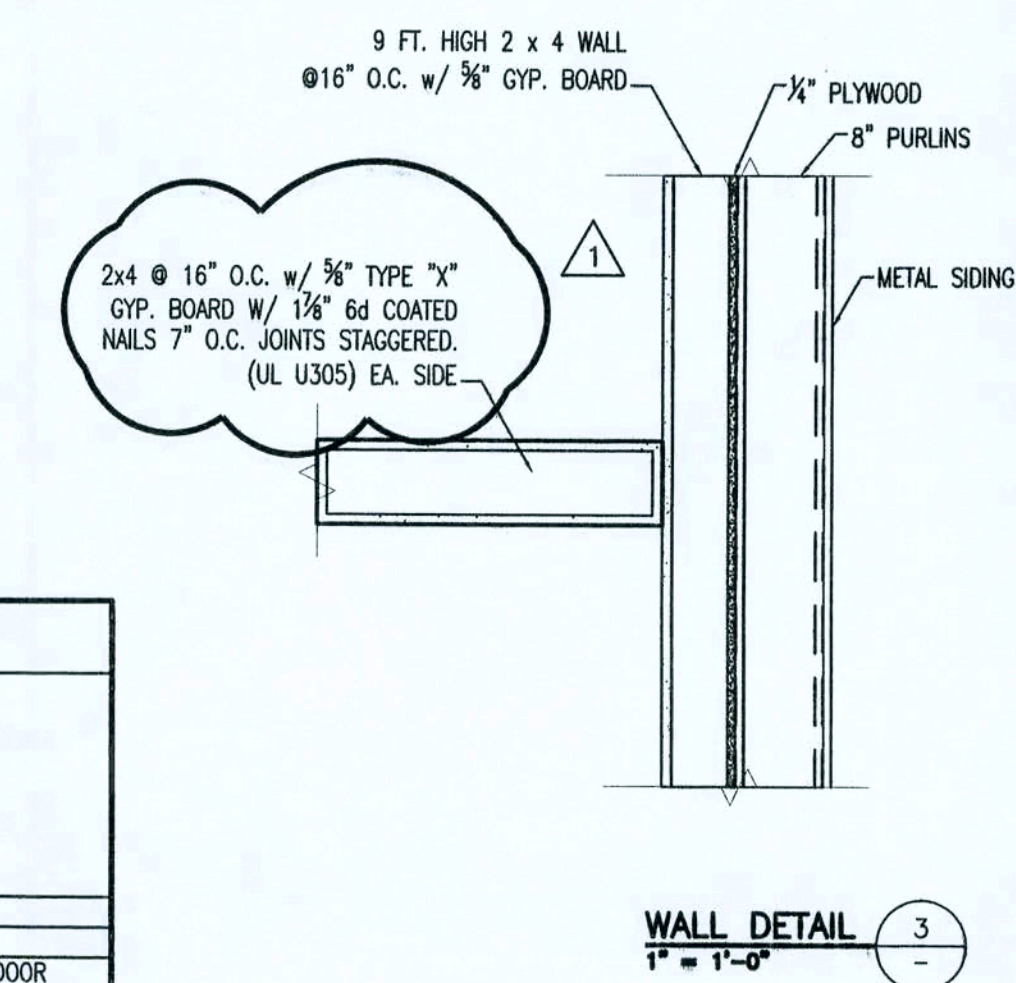[illegible]

REV #	DATE	REVISION NOTES
REV#		REVISION NOTES
-		-

P.O. Box 187
130 West Howard Street
Live Oak FL 32064
Phone: (386) 362-3678
Fax: (386) 362-6133
Garv Gill, PE




**ACTION SIGN & GRAPHICS
COMMERCIAL SITE
LAKE CITY FL**

FLOOR PLAN

PROJECT NUMBER	PF05-36
DRAWN BY	TK
CHECKED BY	GG


A-1.0

SHEET ##### ##

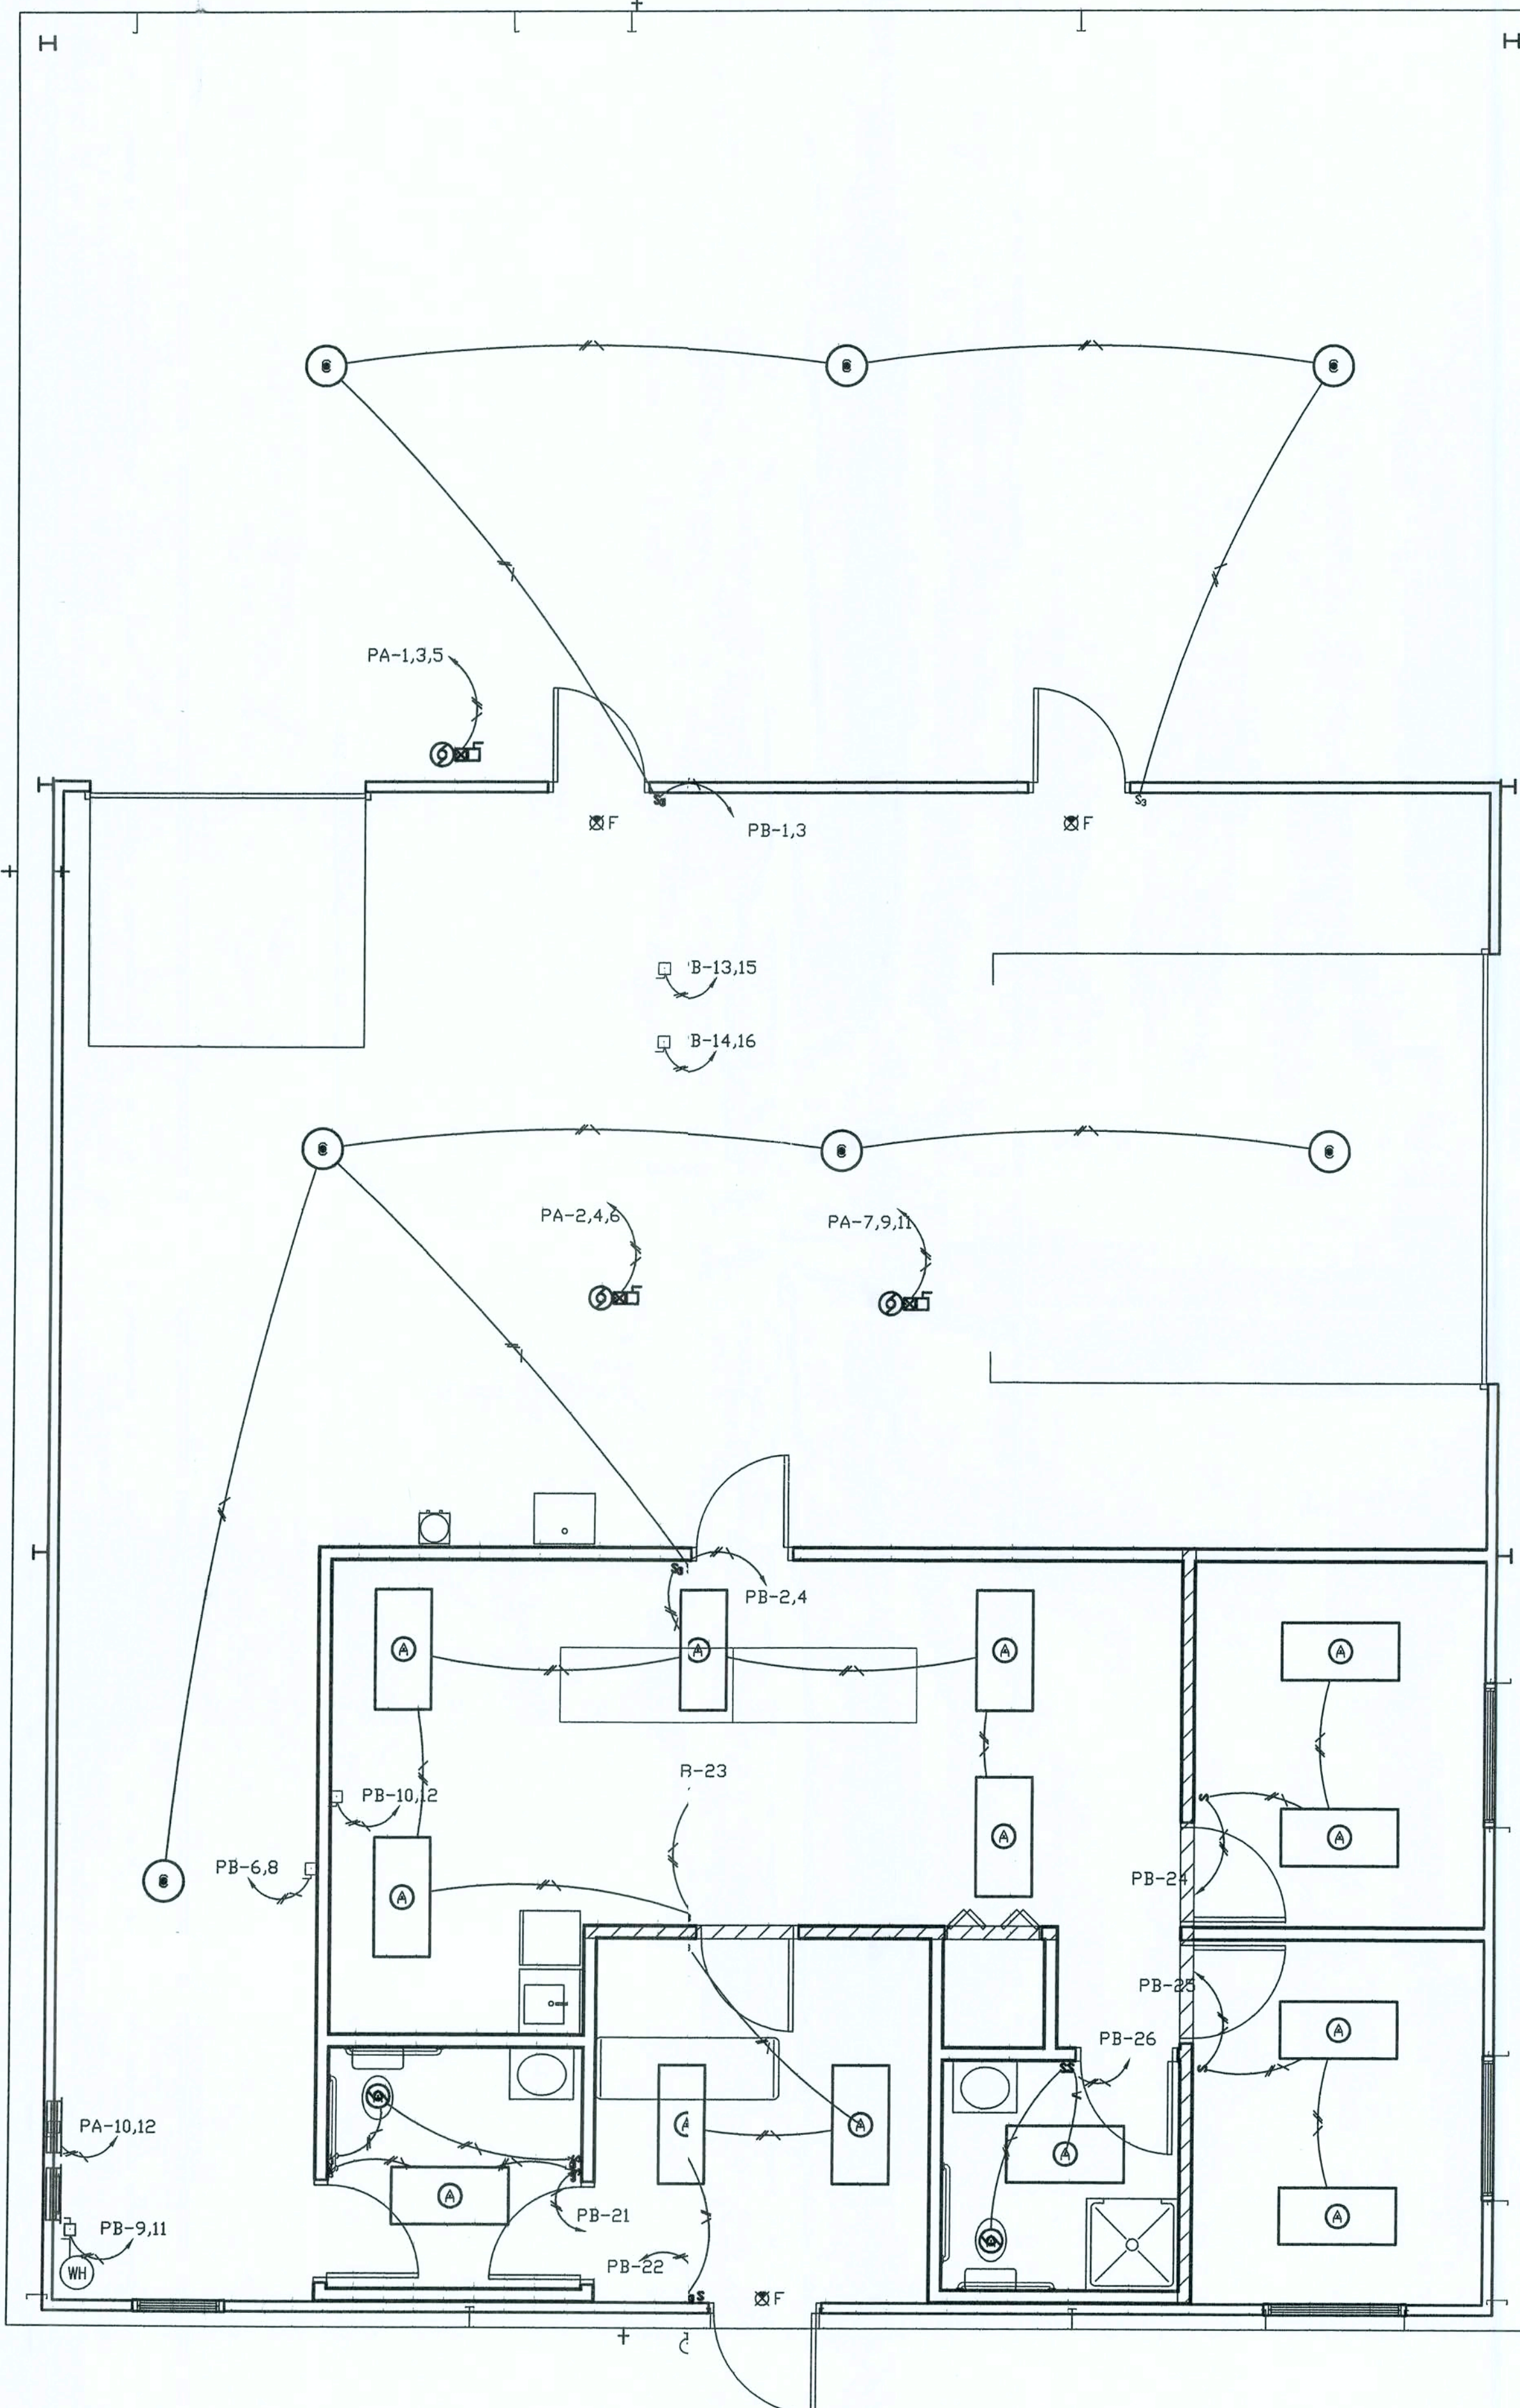


ELECTRICAL LEGEND		
SYMBOL	QUANTITY	DESCRIPTION
(1)	4	28" LOW BAY LUMINAIRE
S	10	SINGLE POLE SWITCH
S ₃	2	3-WAY SWITCH
(1)	15	48" FLUORESCENT LIGHT
(1)	1	EXTERIOR LIGHT

LIGHTING FIXTURE SCHEDULE						
QTY.	ID	MANUFACTURER	MODEL NO.	VOLTAGE	REQUIRED LAMPS	MOUNTING
1	C	Lithonia	IB 632L GEB10IS	120	6 T8	Ceiling
1	F	Lithonia	--	120	3 LED	Ceiling

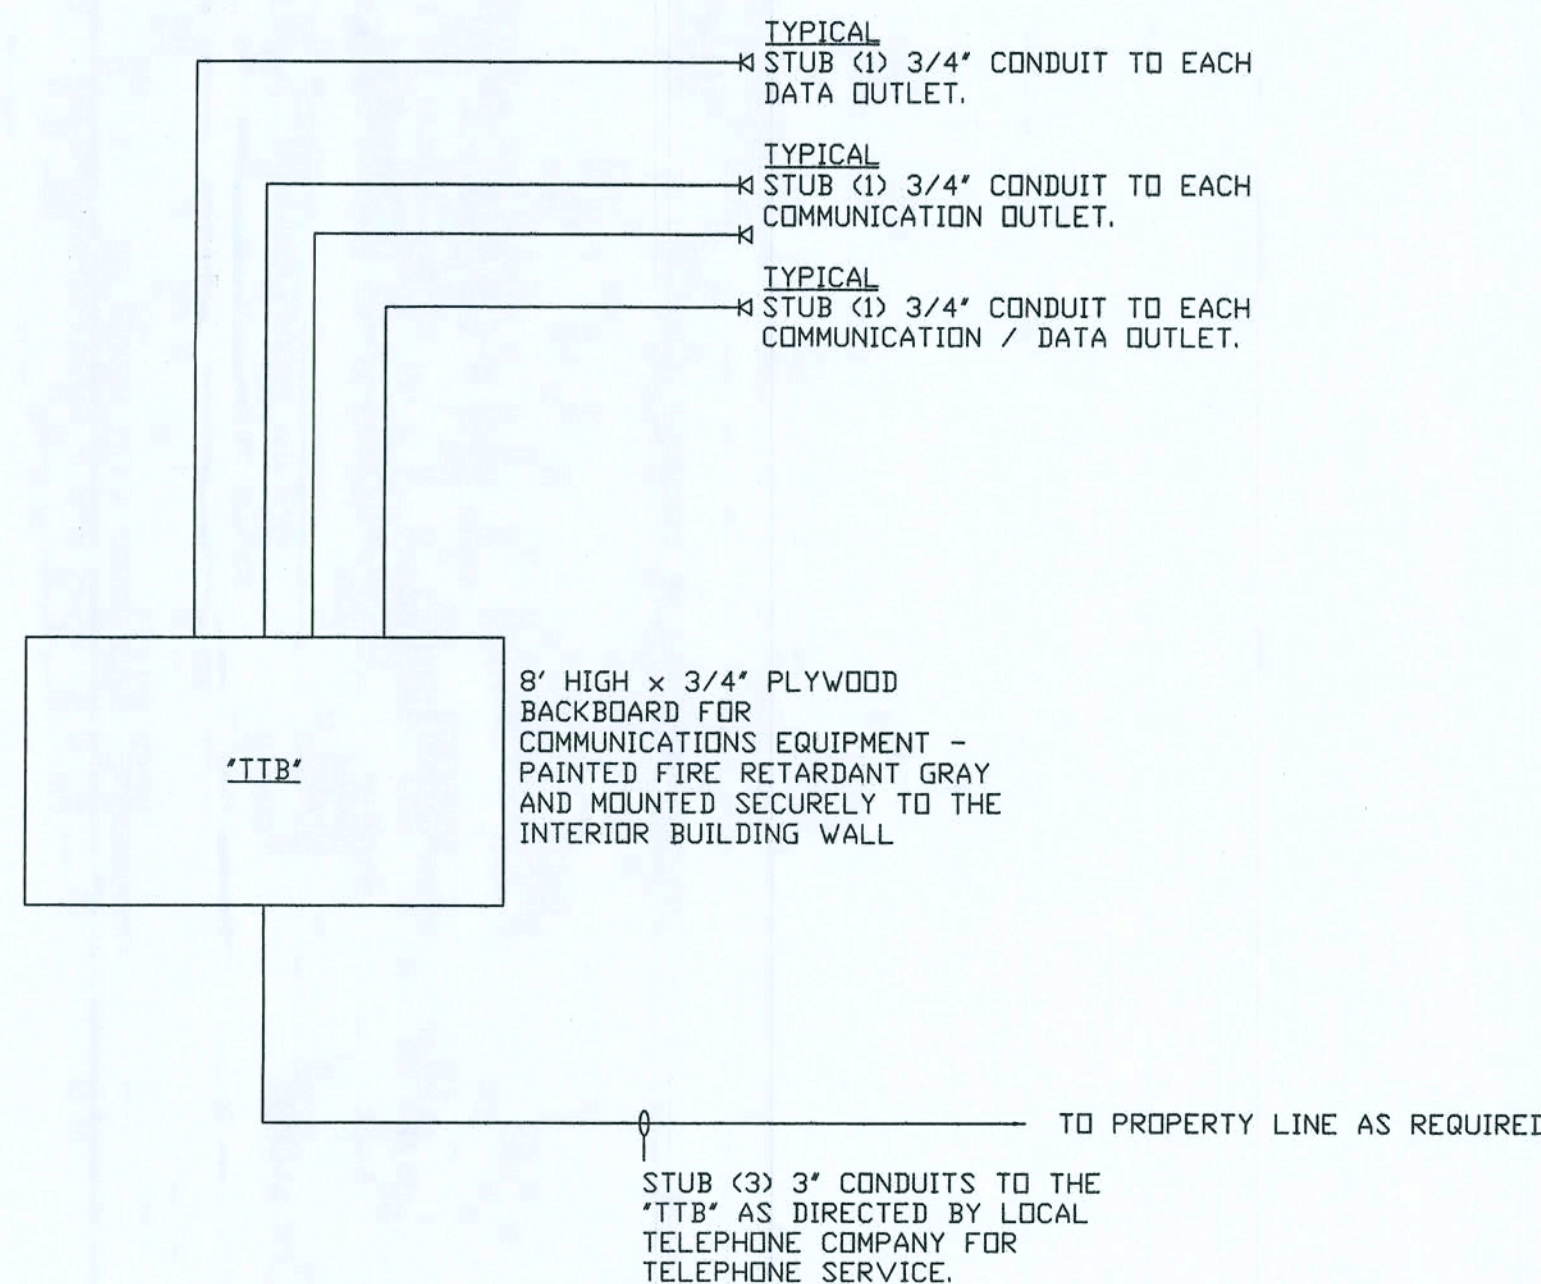

TYPICAL COMMUNICATIONS SYSTEM
RACEWAY RISER DIAGRAM

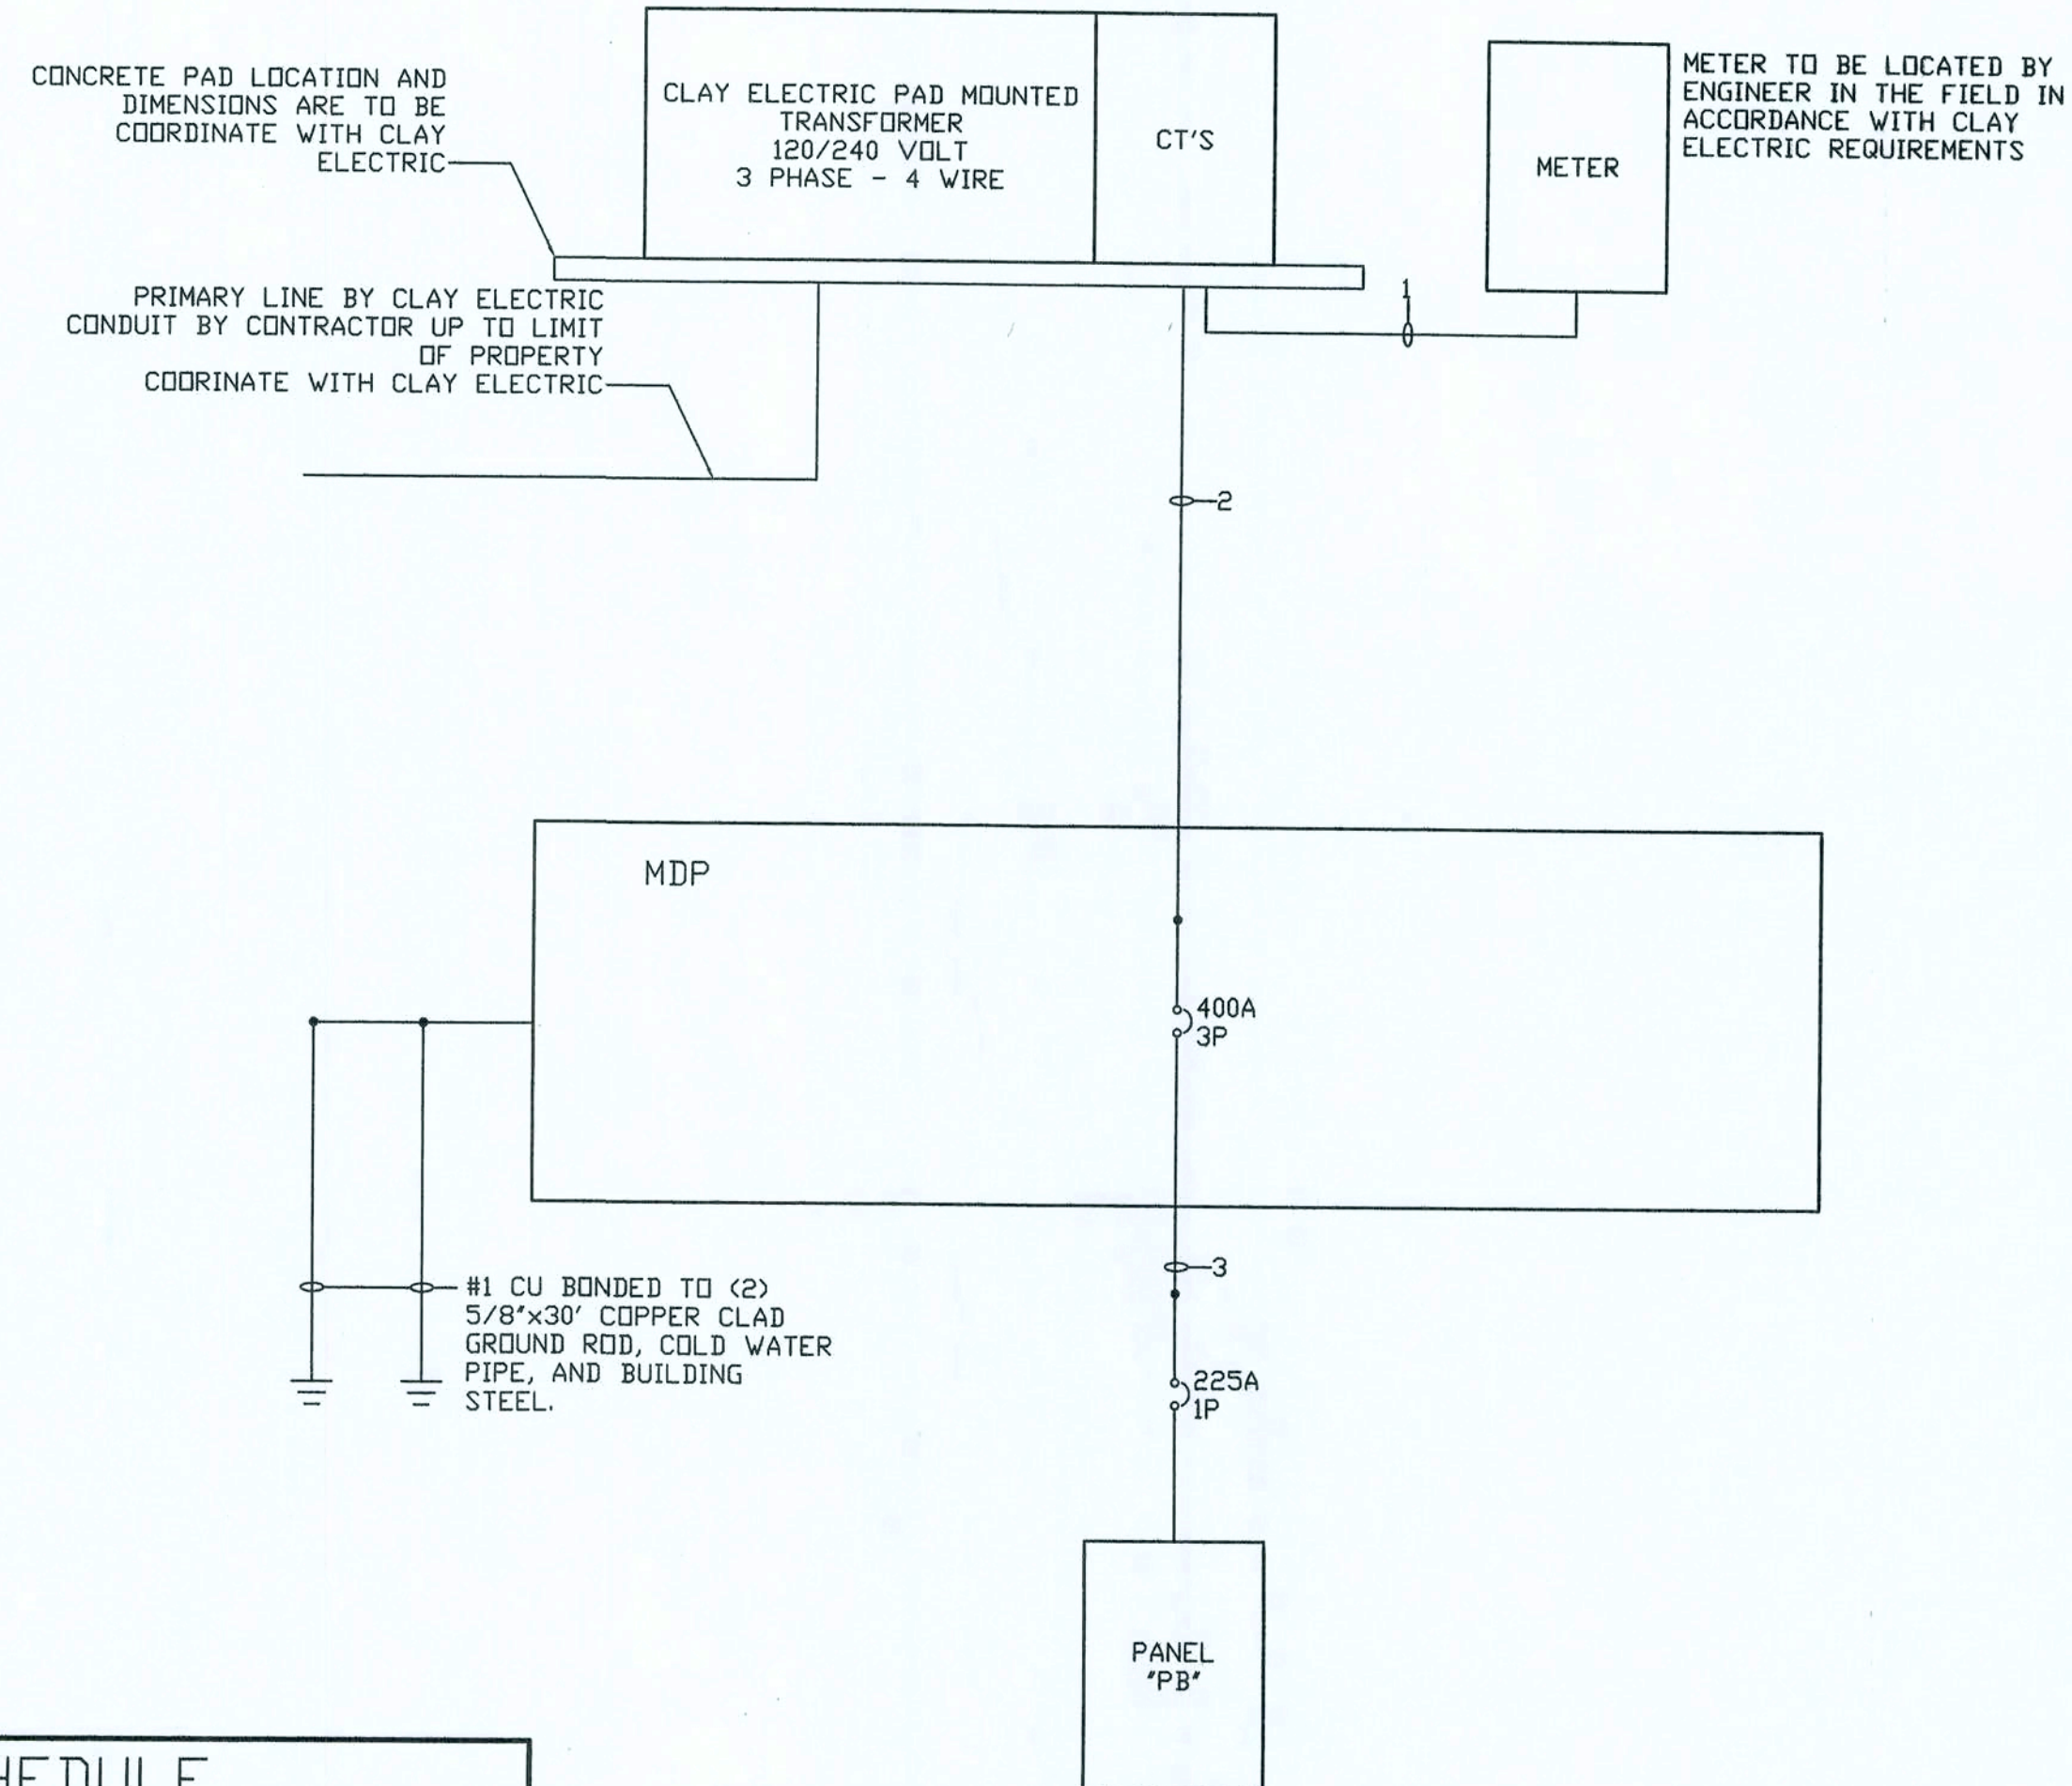

POWER RISER DIAGRAM - 120/240V, 3P, 4W

- POWER RISER NOTES:**
- A. CONTRACTOR SHALL CONTACT UTILITY COMPANY PERSONNEL AS NECESSARY FOR NEW SERVICE COORDINATION. CONTRACTOR SHALL OBTAIN UTILITY CO. REQUIREMENTS AND BE RESPONSIBLE FOR ALL WORK NECESSARY TO INSTALL NEW SECONDARY SERVICE AS INDICATED.
 - B. CONTRACTOR SHALL PROVIDE AND INSTALL ALL TAP LUGS IN SERVICE WIREWAY AND ANY ADDITIONAL EQUIPMENT REQUIRED FOR TERMINATION OF NEW SECONDARY SERVICE CONDUCTORS. CONTRACTOR SHALL VERIFY EXACT ROUTE OF SECONDARY CONDUCTORS IN FIELD TO LOCATION OF NEW DISCONNECTS AND PANELS. CONTRACTOR SHALL PERFORM ALL WORK NECESSARY FOR A COMPLETE AND OPERABLE SYSTEM.
 - C. PROVIDE INTEGRATED SERIES RATING OF 65,000 RMS SYM AMPS AT 240VAC AND ANY ADDITIONAL EQUIPMENT REQUIRED FOR TERMINATION OF NEW SECONDARY

WIRE LEGEND	
①	1 - 1.5" CONDUIT
②	(2 SETS) 4-#300MCM - 4" CONDUIT
③	4-#400MCM, 1- #4 BOND- 4" CONDUIT

REVISION NOTES

REV# DATE

REV# DATE

REVISION NOTES

REV# DATE

REV# DATE

P.O. Box 187

130 West Howard Street

Five Oak Fl

Phone: (386) 362-3678

Fax: (386) 362-6133

Auth. # 9461

ACTION SIGN & GRAPHICS

COMMERCIAL SITE

LAKE CITY, FL

ELECTRICAL PLAN

PROJECT NUMBER

PF05-365

DRAWN BY

T.K.

CHECKED BY

G.G.

E-1.0

SHEET ###

###








GENERAL NOTES:

- ALL RATINGS ARE AT ARI ENTERING CONDITIONS UNLESS OTHERWISE NOTED.
- PROVIDE VIBRATION ISOLATION FOR UNITS.
- EXTERNAL STATIC PRESSURE DOES NOT INCLUDE COIL OR FILTER PRESSURE DROP.
- CONTRACTOR MAY SUBSTITUTE MANUFACTURER FOR APPROVED EQUAL. IT SHALL BE THE CONTRACTOR'S RESPONSIBILITY TO VERIFY THAT CLEARANCE REQUIREMENTS ARE MET FOR ANY SUBSTITUTIONS.

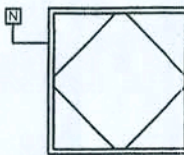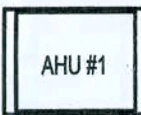

1. THE CONTRACTOR SHALL FURNISH ALL LABOR, MATERIALS, AND EQUIPMENT NECESSARY FOR THE INSTALLATION CODE AND ALL OPTION OF A COMPLETE SYSTEM IN WITH THESE DRAWINGS, THE APPLICABLE BUILDING CODE AND ALL OTHER APPLICABLE STATE, COUNTY AND LOCAL ORDINANCES AND THE LATEST ADDITION OF THE FOLLOWING PUBLICATIONS, ASHRAE, NFPA 90A, 90B, 91, AND ANSI 8-91 MECHANICAL REFRIGERATION.
2. THE CONTRACTOR SHALL PAY ALL COSTS OF PERMIT, INSPECTIONS, AND ALL OTHER COSTS INCIDENTAL TO THE COMPLETION AND TESTING OF THIS WORK.
3. THE CONTRACTOR SHALL BE RESPONSIBLE FOR THE SITE AND THOROUGHLY FAMILIARIZE HIMSELF WITH ALL EXISTING CONDITIONS, ALL EXECUTION AND BACKFILL AS REQUIRED FOR THIS PHASE OF CONSTRUCTION SHALL BE A PART OF THIS CONTRACT.
4. THE CONTRACTOR SHALL SUPPLY THE ENGINEER/ARCHITECT WITH AS-BUILT DRAWINGS UPON COMPLETION OF THIS PROJECT.
5. CONTRACTOR SHALL SUBMIT FOR APPROVAL FIVE (5) COPIES OF MANUFACTURER'S DRAWING FOR EACH PIECE OF EQUIPMENT AND CONTROLS INCLUDED IN CONTRACT.
6. ALL MATERIAL SHALL BE NEW OF GOOD QUALITY. ALL WORK SHALL BE PERFORMED IN A WORKMANLIKE MANNER BY SKILLED WORKMAN.
7. ALL AIR CONDITIONING DUCT SHALL BE OF 1-1/2" STANDARD DUTY FOIL REINFORCED FIBERGLASS WITH MANUFACTURER'S LOGO PRINTED ON THE VAPOR BARRIER, ALL FLEX TO BE R-8.
8. ALL EXHAUST DUCTS AND OUTSIDE AIR DUCTS SHALL BE GALVANIZED SHEET METAL WITH SEALED SEAMS AND JOINTS.
9. DUCT SIZES SHOWN ARE INSIDE DIMENSIONS.
10. ALL AIR DEVICES (DIFFUSERS, REGISTERS, AND GRILLS) SHALL BE ALL ALUMINUM CONSTRUCTION WITH EXPOSED SURFACE OFF WHITE BAKED ENAMEL FINISH OR AS SPECIFIED BY ENGINEER/ARCHITECT, DEVICES SHALL BE 14" SQUARE, 14" SQUARE, 14" SQUARE, AND 14" SQUARE DIFFUSERS.
11. THERMOSTAT SHALL BE COMBINATION COOLING/HEATING, WITH SYSTEM "COOL-AUTO-HEAT-OFF" AND FAN "ON-AUTO" SELECTOR SWITCHES. PROVIDE PROGRAMMABLE TYPE, CARRIER OR EQUAL.
12. REFRIGERANT LINES SHALL BE COPPER, TYPE "L" HAND DRAWN WITH WROUGHT COPPER SOLDER-JOINT TYPE. USE .375" SOLDER. REFRIGERANT LINES SHALL BE SIZED AS PER MANUFACTURER RECOMMENDATIONS. ARMAFLEX 3/4" INSULATION SHALL BE USED FOR SUCCTION LINES, FILTER/DRYER AND SIGHT GLASS SHALL BE PROVIDED AT LIQUID LINES.

14. ALL BRANCH TAKE-OFFS TO BE PROVIDED W/MANUAL VOLUME DAMPERS, ALL ELBOWS AND TEE'S MUST BE FURNISHED W/TURNING VANES. PROVIDE 45 DEGREES BRANCH TAKE-OFF AS PER BRANCH DUCT TAKE-OFF DETAIL.
15. PROVIDE NEW FILTERS FOR ALL AIR CONDITIONING EQUIPMENT BEFORE STARTING THEM. REPLACE THEM PRIOR TO ACCEPTANCE BY OWNER.
16. PROVIDE SMOKE DETECTORS WITH ACCESS DDORS IN ALL SUPPLY AIR DUCTS FOR FANS AND AHU'S SERVING A COMMON PLenum OF 2000 CFM OR ABOVE. ALL SMOKE DETECTORS SHALL BE BY ONE MANUFACTURER, COORDINATE VOLTAGE ETC. WITH ELECTRICAL CONTRACTOR AND FIRE ALARM SYSTEM BEFORE ORDERING.
17. PROVIDE TYPE 'B' FIRE DAMPERS IN ALL DUCTS OR OPENINGS PENETRATING FIRE RATED WALLS, MECHANICAL AND ELECTRICAL ROOMS, TENANT SEPARATION, PARTITIONS, FLOOR OR ROOF SLABS AND AT D/A INTAKES. PROVIDE RADIATION DAMPERS IN RATED CEILING FOR ALL CEILING OPENING, CEILING PENETRATIONS FOR FUSERS AND FOR ALL PENETRATIONS IN THE CEILING ASSEMBLY.
18. HVAC CONTRACTOR SHALL PROVIDE AN INDEPENDENT TEST REPORT FOR ALL MECHANICAL EQUIPMENT, AIR DEVICE, DAMPERS, AHU'S AND FANS. THE T&B SHALL BE IN ACCORDANCE WITH THE AIR BALANCE COUNCIL STANDARDS AND SHALL INCLUDE AIR QUANTITIES FOR ALL SUPPLY GRILLS, RETURN GRILLS, AIR EXHAUST GRILLS AND LEAVING AND ENTERING AIR TEMPERATURE FROM THE SUPPLY GRILLS AND RETURN GRILLS.
19. THERMOSTAT LOCATION SHALL BE APPROVED BY OWNER AND ENGINEER/ARCHITECT BY INSTALLATION.
20. ALL INSULATION WILL HAVE FIRE/SMOKE RATING LESS THAN 50/50.
21. MECHANICAL PLANS IN GENERAL, ARE DIAGRAMMATIC IN NATURE, AND ARE TO BE READ IN CONJUNCTION WITH ARCH., PLUMBING, ELECTRICAL AND HVAC CONTRACTORS. THEY SHALL BE CONSIDERED AS ONE SET OF DOCUMENTS. DUCT AND PIPING OFFSETS, BENDS AND TRANSITIONS WILL BE REQUIRED TO PROVIDE AND INSTALL A COMPLETE FUNCTIONAL SYSTEM AND SHALL BE PROVIDED BY THE CONTRACTOR AT NO ADDITIONAL COST TO THE OWNER.
22. MECHANICAL MAKE-UP ALLOWED IN RETURN AIR PLENUMS OR ABOVE CEILINGS USED AS RETURN AIR PLENUM. IF SPACE WITH RETURN AIR PLENUM HAS ANY DECK PARTITION, AIR TRANSFER DUCTS MUST BE INSTALLED.
23. REFER TO PLUMBING PLAN FOR CONDENSATE PIPING.
24. PROJECT IS A REMODEL OF AN EXISTING BUILDING, THE CONTRACTOR SHALL VISIT JOB SITE PRIOR TO CONSTRUCTION AND COORDINATE ALL FIELD CONDITIONS. ENGINEER AND/OR ARCHITECT SHALL BE NOTIFIED OF ANY DISCREPANCIES.
25. CONTRACTOR SHALL INSTALL ALL OUTDOOR EQUIPMENT TO WITHSTAND A SUSTAINED 140 MPH WIND WITH A GUST FACTOR OF 1.4. PROVIDE A LISTED PRE-ENGINEERED ASSEMBLY, OR CONTRACTOR SHALL BE RESPONSIBLE FOR THE CERTIFICATION OF ROOF MOUNTING.
26. PROVIDE ALL NECESSARY CONTACTS, RELAYS, ETC., FOR A COMPLETE OPERATING A/C SYSTEM.

SCHEDULE	
	A/C UNIT
	AIR HANDLER UNIT
	EXHAUST FAN
	AIR SUPPLY VENT
	AIR RETURN VENT
	SUPPLY DUCT
	RETURN DUCT




- | ITEM. | DESCRIPTION |
|-------|--|
| 1. | FSOR25 COMBINATION FIRE AND LEAKAGE RATED DAMPER
*OPERATOR/ACTUATOR LOCATION MAY VARY. DAMPER MAY BE SUPPLIED WITHOUT
OPERATOR/ACTUATOR INSTALLED. RUSKINS IS LISTED FIRE DAMPER OPERATORS
SPECIFIED ON DAMPER MARKING MAY BE FIELD INSTALLED. SEE OPERATOR/ACTUATOR
INSTALLATION INSTRUCTIONS FOR FIELD MOUNTING OF DAMPER OPERATORS. |
| 2. | RETAINING PLATE, 20 GA STEEL |
| 3. | DAMPER PLATE, 20 GA PLATE |
| 4. | SPUCE PLATE, 20 GA STEEL, TYP BOTH PLATES |
| 5. | STEEL, STUD, 25 GA MIN, 2 1/2" WIDE MIN |
| 6. | STEEL, RUNNER, 25 GA MIN, 1 1/2" WIDE MIN |
| 7. | #10 SHEET METAL SCREW |
| 8. | #12 DA STEEL POP RIVET, OR #10 X 1/2" SHEET METAL SCREW, OR 1/2" LONG WELDS |
| 9. | 4" DRAW BAR |



- FIGURE 3

- | ITEM. | DESCRIPTION |
|-------|---|
| 1. | FSDR25 COMBINATION FIRE AND LEAKAGE RATED DAMPER
*OPERATOR/ACTUATOR LOCATION MAY VARY. DAMPER MAY BE SUPPLIED WITHOUT OPERATOR/ACTUATOR INSTALLED. RISKINS UL LISTED FIRE DAMPER OPERATORS SPECIFIED ON DAMPER MARKING MAY BE FIELD INSTALLED. SEE OPERATOR/ACTUATOR INSTALLATION INSTRUCTIONS FOR FIELD MOUNTING OF DAMPER OPERATORS. |
| 2. | 4" DRAW BAND |
| 3. | DUCT |
| 4. | AUXILIARY OPERATING JACKSHAFT |
| 5. | OVER CENTER LOCK |
| 6. | DAMPER AND RETAINING PLATES (SEE NOTE 5) |
| 7. | RETAINING CLIP 1" X 1" X 1/8" 90 ANGLE (SEE NOTE 5) |

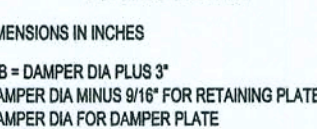

DAMPER INSTALLATION DIAGRAM

DESIGN CRITERIA

DESIGN PER 2004 FLORIDA BUILDING CODE, UNLESS OTHERWISE NOTED.

LIVE LOADS:		
ROOFS AND CANOPIES:	0 TO 200 SF	16PSF
	201 TO 600 SF	14PSF
	OVER 600 SF	12PSF
STAIRS		100PSF
FLOORS		50PSF
CORRIDORS		80PSF
LOBBIES		80PSF
BALCONIES		60PSF
PARTITION LOAD (DEAD LOAD)		20PSF
WIND LOADS:		
BASIC WIND SPEED: (ASCE 7)		
MEAN ROOF HEIGHT		
WIND IMPORTANCE FACTOR (CATEGORY II)		
WIND EXPOSURE		
ENCLOSURE CLASSIFICATION		
INTERNAL PRESSURE COEFFICIENT		
DIRECTIONALITY FACTOR (Kd)		
SHAPE FACTORS		

THIS BUILDING IS NOT LOCATED IN THE WIND BORNE DEBRIS REGION. IMPACT RESISTANT GLAZING IS NOT REQUIRED.

DESIGN WIND PRESSURES FOR COMPONENTS & CLADDING:		
WALLS & WALL OPENINGS		
TRIBUTARY AREA	INTERIOR ZONE	END ZONE
	(> 6.3 ft FROM BLDG. CORNER)	(< 6.3 ft FROM BLDG. CORNER)
10 sf	-23.81 / 21.7	-29.2 / 21.77
25 sf	-22.31 / 20.5	-26.55 / 20.5
(LINEARLY INTERPOLATE BETWEEN STATED VALUES)		
ROOFS & ROOF OPENINGS		
TRIBUTARY AREA	INTERIOR ZONE	END ZONE
	(> 6.3 ft FROM BLDG. CORNER)	(< 6.3 ft FROM BLDG. CORNER)
10 sf	-21.77 / 19.92	-25.46 / 19.92
25 sf	-20.30 / 19.19	-23.99 / 19.19
(LINEARLY INTERPOLATE BETWEEN STATED VALUES)		

CONCRETE (DESIGN PER CURRENT EDITION ACI 318)	
SLAB ON GRADE	F'C= 4000 PSI
FOOTINGS	F'C= 3000 PSI
ALL OTHER CONCRETE	F'C= 3000 PSI

ALL REINFORCING STEEL ASTM A615 GRADE 60

ALL WELDED WIRE FABRIC ASTM A185

CONCRETE MASONRY (DESIGN PER CURRENT EDITION ACI 530)	
COMPRESSIVE STRENGTH	F'M= 1500 PSI

STRUCTURAL STEEL (DESIGN PER CURRENT EDITION AISC), UNLESS OTHERWISE NOTED MATERIALS SHALL BE AS FOLLOWS:	
W-SHAPES	ASTM 992, Fy=50 KSI
OTHER SHAPES & PLATES	ASTM A36, Fy=36 KSI
HSS SQUARE & RECTANGULAR SHAPES	ASTM A500 GRADE B, Fy= 46 KSI
HSS ROUND SHAPES	ASTM A500 GRADE B, Fy= 42 KSI
STEEL PIPES	ASTM A53 GRADE B, Fy= 35 KSI
WELDING ELECTRODES	AWS A5.1 OR A5.5 SERIES E70
HIGH-STRENGTH BOLTS	3/4"Ø ASTM A325
ANCHOR RODS	GRADE 36 ASTM F1554
WELDED STUDS	ASTM A108
DEFORMED BARS	ASTM A496
PAINT & PROTECTION	SSPC PAINT 25

SOIL BEARING (DESIGN MAXIMUM)	REFER TO GEOTECHNICAL REPORT FOR ALLOWABLE BEARING PRESSURE
-------------------------------	---

GENERAL NOTES

CONCRETE

UNLESS OTHERWISE NOTED ON THE DRAWINGS, MINIMUM COVER FOR REINFORCING SHALL BE AS FOLLOWS:	
FOOTINGS	3"
PILE CAPS	SEE TYPICAL DETAIL
GRADE BEAMS	3"
COLUMNS AND PEDESTALS (OVER VERTICAL REINF)	2"
SLABS AND WALLS (EXPOSED TO EARTH, LIQUID OR WEATHER)	2"
SLABS AND WALLS (NOT EXPOSED TO EARTH, LIQUID OR WEATHER)	3/4"
CANOPY SLABS	1 1/2"
BEAMS (OVER MAIN REINFORCING)	1 1/2"
SLABS ON GRADE	2" FROM TOP

ALL REINFORCING SHALL BE HELD SECURELY IN POSITION WITH STANDARD ACCESSORIES IN CONFORMANCE WITH CRSI MANUAL OF STANDARD PRACTICE AND ACI 315 DURING THE PLACEMENT OF CONCRETE.

UNLESS OTHERWISE NOTED, SPLICES IN REINFORCING, WHERE PERMITTED, SHALL BE AS FOLLOWS:	
WELDED WIRE FABRIC	WIRE SPACING PLUS 6"
REINFORCING BARS	40 BAR DIAMETERS

ALL HOOKS IN REINFORCING BARS SHALL BE AN ACI STANDARD HOOK, UNLESS OTHERWISE NOTED.

FOUNDATIONS

IF FOOTING EVALUATIONS SHOWN OCCUR IN A DISTURBED, UNSTABLE, OR UNSUITABLE SOIL, THE ENGINEER SHALL BE NOTIFIED.

STEPS IN WALL FOOTINGS SHALL NOT EXCEED A SLOPE OF (1) VERTICAL TO TWO (2) HORIZONTAL

PROVIDE A MINIMUM OF TWO #4 BARS IN TOP OF CONTINUOUS WALL FOOTINGS AT DOOR AND OTHER OPENINGS, 4'-0" LONGER THAN THE OPENING.

NOTES:
1) ALL CONNECTORS LISTED ARE SIMPSON STRONG-TIE. UNLESS OTHERWISE NOTED, OTHER MANUFACTURERS MAY BE SUBSTITUTED. SCREW SIZE AND NUMBER SHALL BE IN ACCORDANCE WITH MANUFACTURER'S CATALOG.
2) TRUSS ENGINEER MAY PROVIDE ALTERNATE CONNECTIONS.

SUPPLEMENTARY NOTES

PROVIDE ALL TEMPORARY BRACING, SHORING, GUYING OR OTHER MEANS TO AVOID EXCESSIVE STRESSES AND TO HOLD STRUCTURAL ELEMENTS IN PLACE DURING CONSTRUCTION. THE STRUCTURE SHOULD NOT BE CONSIDERED STABLE UNTIL ALL STRUCTURAL ELEMENTS HAVE BEEN CONSTRUCTED.

VERIFY ALL DIMENSIONS WITH ARCHITECTURAL DRAWINGS.

SEE ARCHITECTURAL, MECHANICAL, ELECTRICAL AND PLUMBING DRAWINGS FOR EMBEDS, OPENINGS, SLEEVES, ETC. NOT SHOWN ON THE STRUCTURAL DRAWINGS.

ALL STRUCTURAL OPENINGS AROUND OR AFFECTED BY MECHANICAL, ELECTRICAL AND PLUMBING EQUIPMENT SHALL BE VERIFIED WITH EQUIPMENT PURCHASED BEFORE PROCEEDING WITH STRUCTURAL WORK AFFECTED.

EMBEDMENT FOR EXPANSION BOLTS SHALL BE 3 1/2"Ø MINIMUM FOR 3/4" BOLTS IN CONCRETE, 5 1/2" IN GRouted MASONRY. HILTI KWIK BOLT II OR EQUAL.

EPOXY GROUT SHALL BE POWER FAST CARTRIDGE SYSTEM BY RAWL, HY150 CARTRIDGE SYSTEM BY HILTI (HILTI RE500, IF HOLE IS CORED INSTEAD OF DRILLED) OR APPROVED EQUAL. UNLESS OTHERWISE NOTED, HOLE SHALL BE 12 BAR DIAMETERS MINIMUM. UNLESS OTHERWISE NOTED, HOLES SHALL BE 1/2" LARGER THAN REBAR SIZE, AND 1/2" LARGER THAN THREADED ROD SIZE. HOLE SHALL BE BRUSHED OUT WITH BOTTLE BRUSH AND THEN BLOWN OUT WITH 1/4" AIR USING A COMPRESSOR WITH A FUNCTIONAL OIL TRAP. INSTALLATION SHALL BE IN ACCORDANCE WITH MANUFACTURERS PRINTED INSTRUCTIONS.

ANY ENGINEERING DESIGN PROVIDED BY OTHERS AND SUBMITTED FOR REVIEW SHALL BEAR THE SEAL OF AN ENGINEER IN THE STATE OF THE PROJECT.

GENERAL CONTRACTOR MUST REVIEW AND APPROVE SHOP DRAWINGS PRIOR TO SUBMITTAL TO ARCHITECT / ENGINEER. SUBMITTALS WHICH DO NOT CONTAIN THE CONTRACTOR'S SHOP DRAWING STAMP OR HAVE BEEN MERELY "RUBBER STAMPED" SHALL BE RETURNED WITHOUT REVIEW.

CHANGES TO THE CONTRACT DOCUMENTS SHALL BE CLOUDED ON SHOP DRAWINGS OR REQUESTED IN WRITING. THE CONTRACTOR IS LIABLE FOR ANY DEVIATIONS UNLESS REVIEWED AND ACKNOWLEDGED BY THE ENGINEER. SHOP DRAWING SUBMITTALS SHALL ONLY BE CHECKED FOR CONFORMANCE WITH THE DESIGN CONCEPT AND THE INFORMATION SHOWN ON THE CONSTRUCTION DOCUMENTS.

SPECIFICATIONS

CONCRETE WORK SHALL CONFORM TO THE REQUIREMENTS OF ACI 301. "SPECIFICATIONS FOR STRUCTURAL CONCRETE FOR BUILDINGS" (LATEST EDITION), EXCEPT AS MODIFIED BY REQUIREMENTS OF THE CONTRACT DOCUMENTS.

MASONRY CONSTRUCTION AND MATERIALS SHALL CONFORM TO THE REQUIREMENTS OF "SPECIFICATIONS FOR STRUCTURAL STEEL BUILDINGS", AISC "SPECIFICATIONS FOR STRUCTURAL JOINTS USING ASTM A3325 OR A490 BOLTS", AISC "CODE OF STANDARD PRACTICE FOR STEEL BUILDINGS AND BRIDGES", AND AWS D1.1 "STRUCTURAL WELDING CODE", EXCEPT AS MODIFIED BY THE REQUIREMENTS OF THE CONTRACT DOCUMENTS.

A GEOTECHNICAL TESTING AND INSPECTION FIRM SHALL BE EMPLOYED TO PERFORM A SOIL SURVEY FOR SATISFACTORY SOIL MATERIALS, SAMPLING AND TESTING FOR QUALITY CONTROL AS PER THE RECOMMENDATIONS OF THE GEOTECHNICAL REPORT FOR THIS PROJECT. ALL EARTHWORK OPERATIONS SHALL BE PERFORMED TO THE SATISFACTION OF THE GEOTECHNICAL TESTING FIRM.

FOUNDATION HAVE BEEN DESIGNED WITH AN ALLOWABLE SOIL BEARING PRESSURE OF 1,500 P.S.F.

TERMITE PROTECTION NOTES:

SOIL CHEMICAL BARRIER METHOD:

1. A PERMANENT SIGN WHICH IDENTIFIES THE TERMITE TREATMENT PROVIDER AND NEED FOR REINSPECTION AND TREATMENT CONTRACT RENEWAL SHALL BE PROVIDED. THE SIGN SHALL BE POSTED NEAR THE WATER HEATER OR ELECTRIC PANEL. FBC 104.2.6

2. CONDENSATE AND ROOF DOWNSPOUTS SHALL DISCHARGE AT LEAST 1'-0" AWAY FROM BUILDING SIDE WALLS. FBC 1503.4.4

3. IRRIGATION/SPRINKLER SYSTEMS INCLUDING ALL RISERS AND SPRAY HEADS SHALL NOT BE INSTALLED WITHIN 1'-0" FROM BUILDING SIDE WALLS. FBC 1503.4.4

4. TO PROVIDE FOR INSPECTION FOR TERMITE INFESTATION, BETWEEN WALL COVERINGS AND FINAL EARTH GRADE SHALL NOT BE LESS THAN 6". EXCEPTION: PAINT AND DECORATIVE CEMENTIOUS FINISH LESS THAN 5/8" THICK ADHERED DIRECTLY TO THE FOUNDATION WALL. FBC 1403.1.6

5. INITIAL TREATMENT SHALL BE DONE AFTER ALL EXCAVATION AND BACKFILL IS COMPLETE. FBC 1816.1.1

6. SOIL DISTURBED AFTER THE INITIAL TREATMENT SHALL BE RETREATED INCLUDING SPACES BOXED OR FORMED. FBC 1816.1.2

7. BOXED AREAS IN CONCRETE FLOOR FOR SUBSEQUENT INSTALLATION OF TRAPS, ETC., SHALL BE MADE WITH PERMANENT METAL OR PLASTIC FORMS. PERMANENT FORMS MUST BE OF A SIZE AND DEPTH THAT WILL ELIMINATE THE DISTURBANCE OF SOIL AFTER THE INITIAL TREATMENT. FBC 1816.1.3

8. MINIMUM 6 MIL VAPOR RETARDER MUST BE INSTALLED TO PROTECT AGAINST RAINFALL DILUTION. IF RAINFALL OCCURS BEFORE VAPOR RETARDER PLACEMENT, RETREATMENT IS REQUIRED. FBC 1816.1.4

9. CONCRETE OVERPOUR AND MORTAR ALONG THE FOUNDATION PERIMETER MUST BE REMOVED BEFORE EXTERIOR SOIL TREATMENT. FBC 1816.1.5

10. SOIL TREATMENT MUST BE APPLIED UNDER ALL EXTERIOR CONCRETE OR GRADE WITHIN 1'-0" OF THE STRUCTURE SIDEWALLS. FBC 1816.1.6

11. AN EXTERIOR VERTICAL CHEMICAL BARRIER MUST BE INSTALLED AFTER CONSTRUCTION IS COMPLETE INCLUDING LANDSCAPING AND IRRIGATION. ANY SOIL DISTURBED AFTER THE VERTICAL BARRIER IS APPLIED, SHALL BE RETREATED. FBC 1816.1.6

12. ALL BUILDINGS ARE REQUIRED TO HAVE PER-CONSTRUCTION TREATMENT. FBC 1816.1.7

13. A CERTIFICATE OF COMPLIANCE MUST BE ISSUED TO THE BUILDING DEPARTMENT BY A LICENSED PEST CONTROL COMPANY BEFORE A CERTIFICATE OF OCCUPANCY WILL BE ISSUED. THE CERTIFICATE OF COMPLIANCE SHALL STATE: "THE BUILDING HAS RECEIVED A COMPLETE TREATMENT FOR THE PREVENTION OF SUBTERRANEAN TERMITES. THE TREATMENT IS IN ACCORDANCE WITH THE RULES AND LAWS OF THE FLORIDA DEPARTMENT OF AGRICULTURE AND CONSUMER SERVICES". FBC 1816.1.7


14. AFTER ALL WORK IS COMPLETED, LOOSE WOOD AND FILL MUST BE REMOVED FROM BELOW AND WITHIN 1'-0" OF THE BUILDING. THIS INCLUDES ALL GRADE STAKES, TUB TRAP BOXES, FORMS, SHORING OR OTHER CELLULOSE CONTAINING MATERIAL. FBC 2303.1.3

15. NO WOOD, VEGETATION, STUMPS, CARDBOARD, TRASH, ETC., SHALL BE BURIED WITHIN 15'-0" OF ANY BUILDING OR PROPOSED BUILDING. FBC 2303.1.4

REVISION NOTES

REV #	DATE				
0	03/15/06				

P.O. Box 187
130 West Howard Street
Live Oak FL 32064
Phone: (386) 362-3678
Fax: (386) 362-6133
Gary Gill, PE
Auth. # 9461



STRUCTURAL/CIVIL ENGINEERS

ACTION SIGN & GRAPHICS
NEW CONSTRUCTION
COLUMBIA COUNTY

GENERAL NOTES

PROJECT NUMBER
PF05-365


DRAWN BY
T.K.

CHECKED BY
G.G.

SHEET NUMBER
S-2.0

Handwritten signature and date: 4/19/06

ACTION SIGN & GRAPHICS

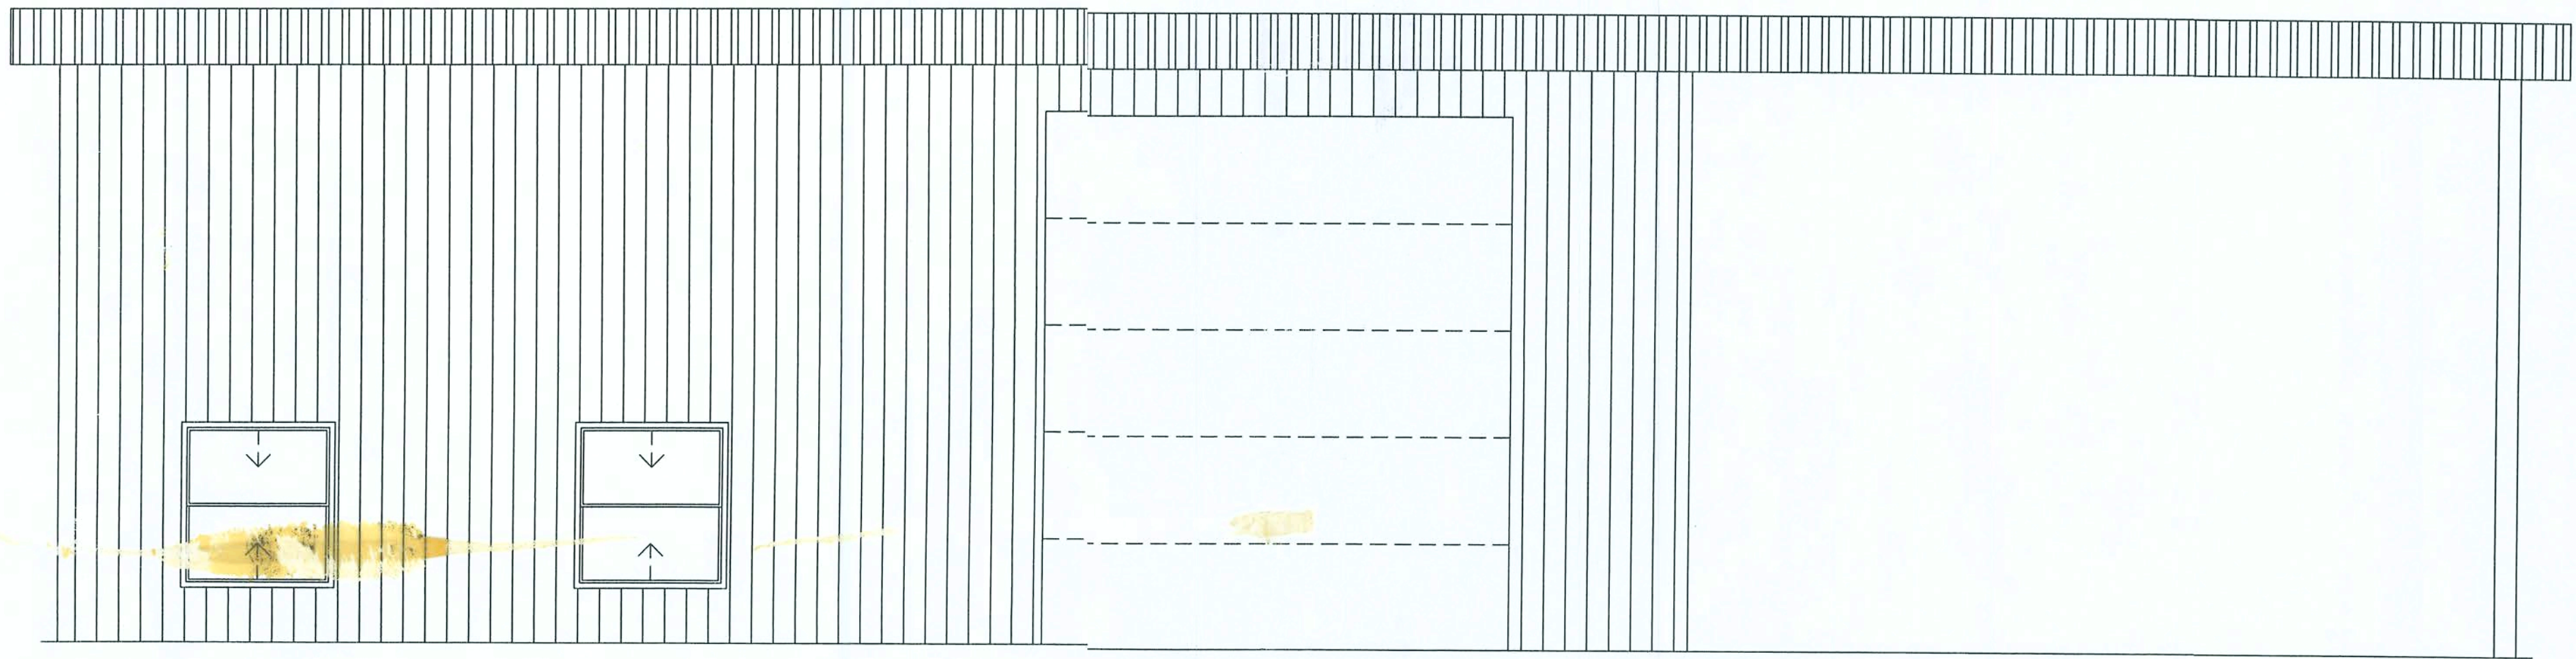

NEW OFFICE CONSTRUCTION COLUMBIA COUNTY, FL.

Office copy

APPLICABLE CODES

2004 FLORIDA BUILDING CODE

OCCUPANCY CLASS

CLASS B BUSINESS & CLASS S-2 LOW HAZARD STORAGE

TYPE OF CONSTRUCTION

TYPE 5, UNPROTECTED

OCCUPANCY LOAD/EGRESS REQUIREMENTS

BUSINESS AREA 100 GROSS SQ. FT / OCCUPANT x 938.5 SQ. FT = 9 OCCUPANTS

STORAGE AREA 100 GROSS SQ. FT / OCCUPANT x 1427 SQ. FT. = 14 OCCUPANTS

CONSTRUCTION DOCUMENTS

THE CUSTOMER IS RESPONSIBLE FOR DELIVERING THE REQUIRED SETS OF CONSTRUCTION DOCUMENTS TO THE PERMIT ISSUING AUTHORITIES, FOR THE SSUANCE OF CONSTRUCTION PERMITS. THE CONTRACTOR SHALL REVIEW THE CONSTRUCTION DOCUMENTS AND VERIFY ALL DIMENSIONS. ANY DISCREPANCIES SHALL BE REPORTED TO YOUR SALES REPRESENTATIVE PRIOR TO THE COMMENCEMENT OF ANY WORK OR FABRACATDN OF ANY MATERIALS.

DO NOT SCALE OFF THESE PLANS

AMPLE DIMENSIONS ARE SHOWN ON THE PLANS TO LOCATE AL ITEMS. SIMPLE ARITHMETIC MAY BE USED TO DETERMINE THE LOCATIONS OF THOSE ITEM; NOT DIMENSIONED.



GTC DESIGN GROUP, LLC.
STRUCTURAL/CIVIL ENGINEERS

P.O. Box 187
130 West Howard Street
Live Oak FL, 32064
Phone: (386) 362-3678
Fax: (386) 362-6133




Gary Gill, PE
Auth. # 9461

INDEX


A-1.0	FLOOR PLAN
A-2.0	OFFICE FRAMING PLAN
A-3.0	REFLECTED CEILING PLAN
A-4.0	ELEVATIONS
E-1.0	LIGHTING PLAN
M-1.0	MECHANICAL PLAN
P-1.0	SANITATION PLAN
P-2.0	PLUMBING PLAN
S-1.0	FOUNDATION PLAN
S-2.0	GENERAL NOTES

APPROVED
(Subject to Revisions)
Inspection Department
Live Oak City Fire Dept.
State Fire Inspector
License # 11251
By: *[Signature]* Date: 3/21/06


[Signature]
3/14/06

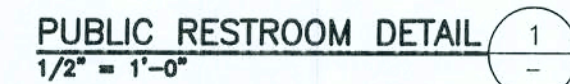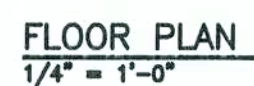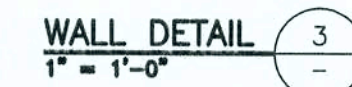[illegible]


FLOOR PLAN	
PROJECT NUMBER PF05-365	
DRAWN BY TK	
CHECKED BY GG	
A-1.0	
SHEET #####	#####

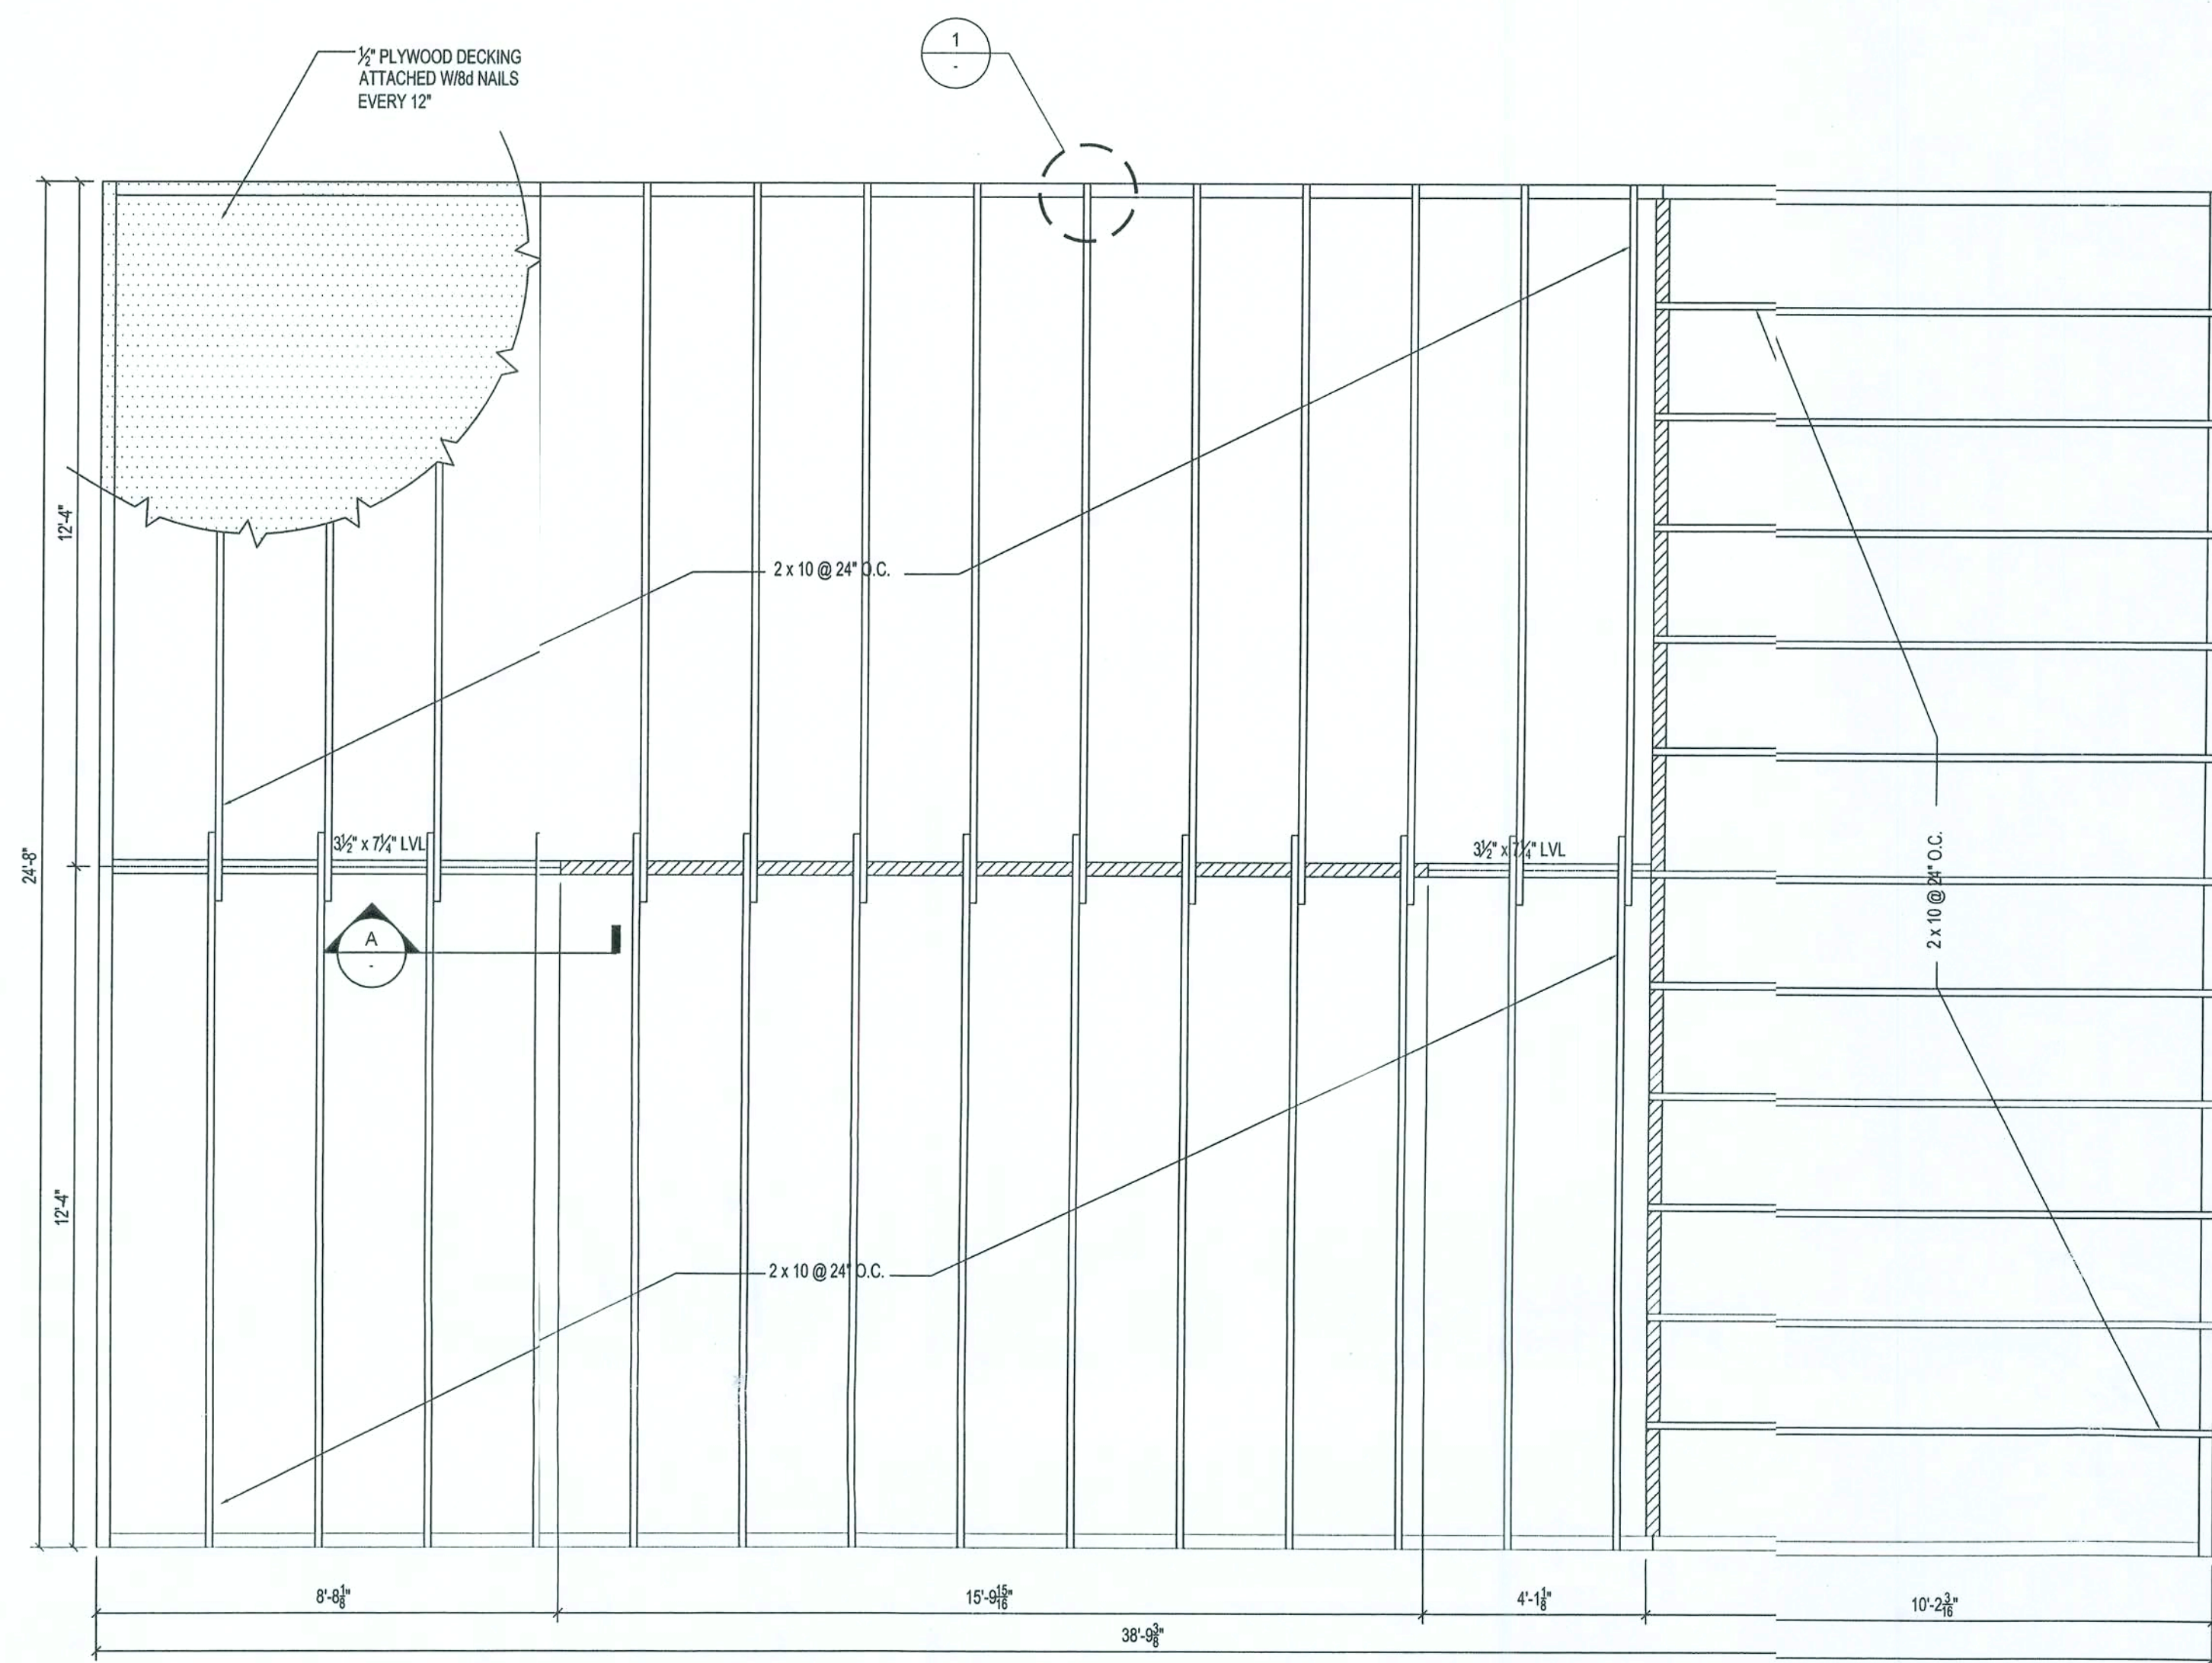

OFFICE FRAMING PLAN
3/8" = 1'-0"

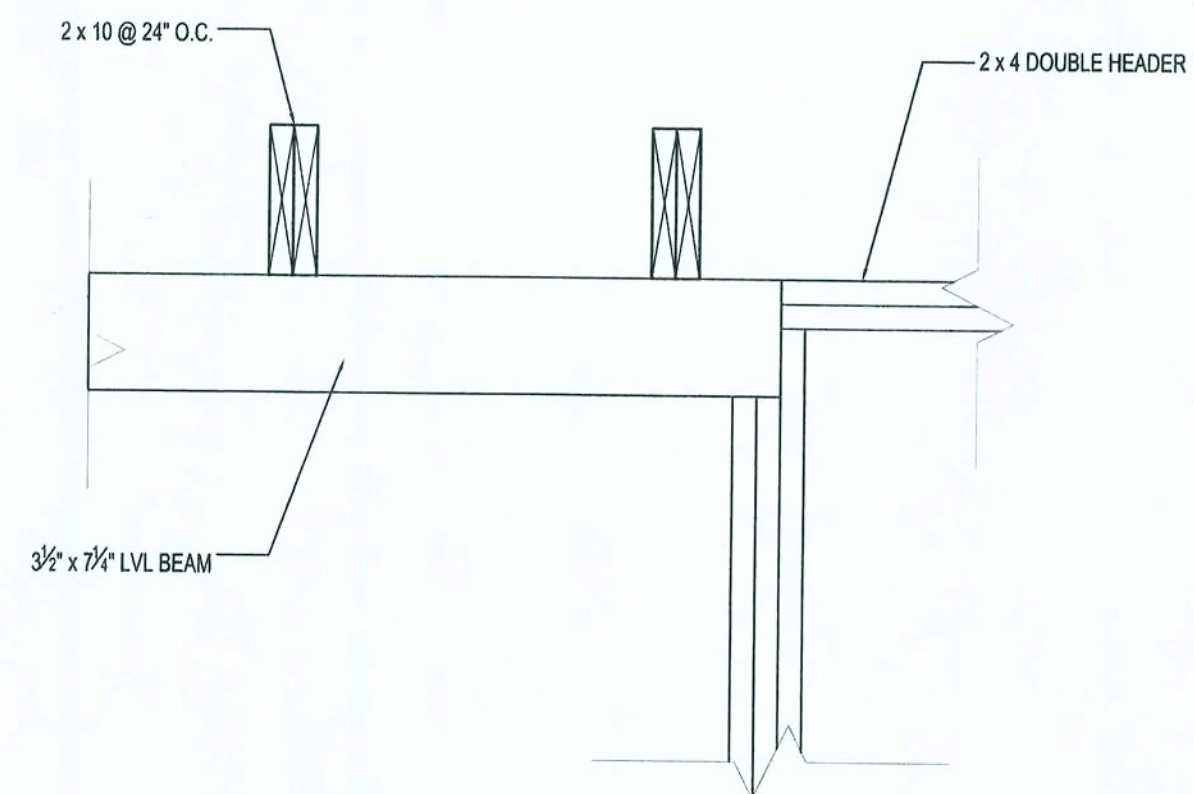

SECTION A
1" = 1'-0"

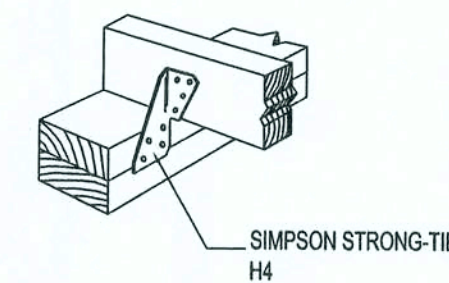

1
1" = 1'-0"

REVISION NOTES		REVISION NOTES	
REV #	DATE	REV #	DATE
1		1	
2		2	
3		3	
100		100	


P.O. Box 187
130 West Howard Street
Five Oaks, NC 27604
Phone: (866) 362-3678
Fax: (866) 362-6133
Gary Gill, PE
Auth. # 9461
STRUCTURAL/CIVIL ENGINEERS

ACTION SIGN & GRAPHICS
COMMERCIAL SITE
LAKE CITY, FL

OFFICE FRAMING PLAN

PROJECT NUMBER
PF05-365
DRAWN BY
T.K.
CHECKED BY
G.G.

A-2.0
SHEET ###

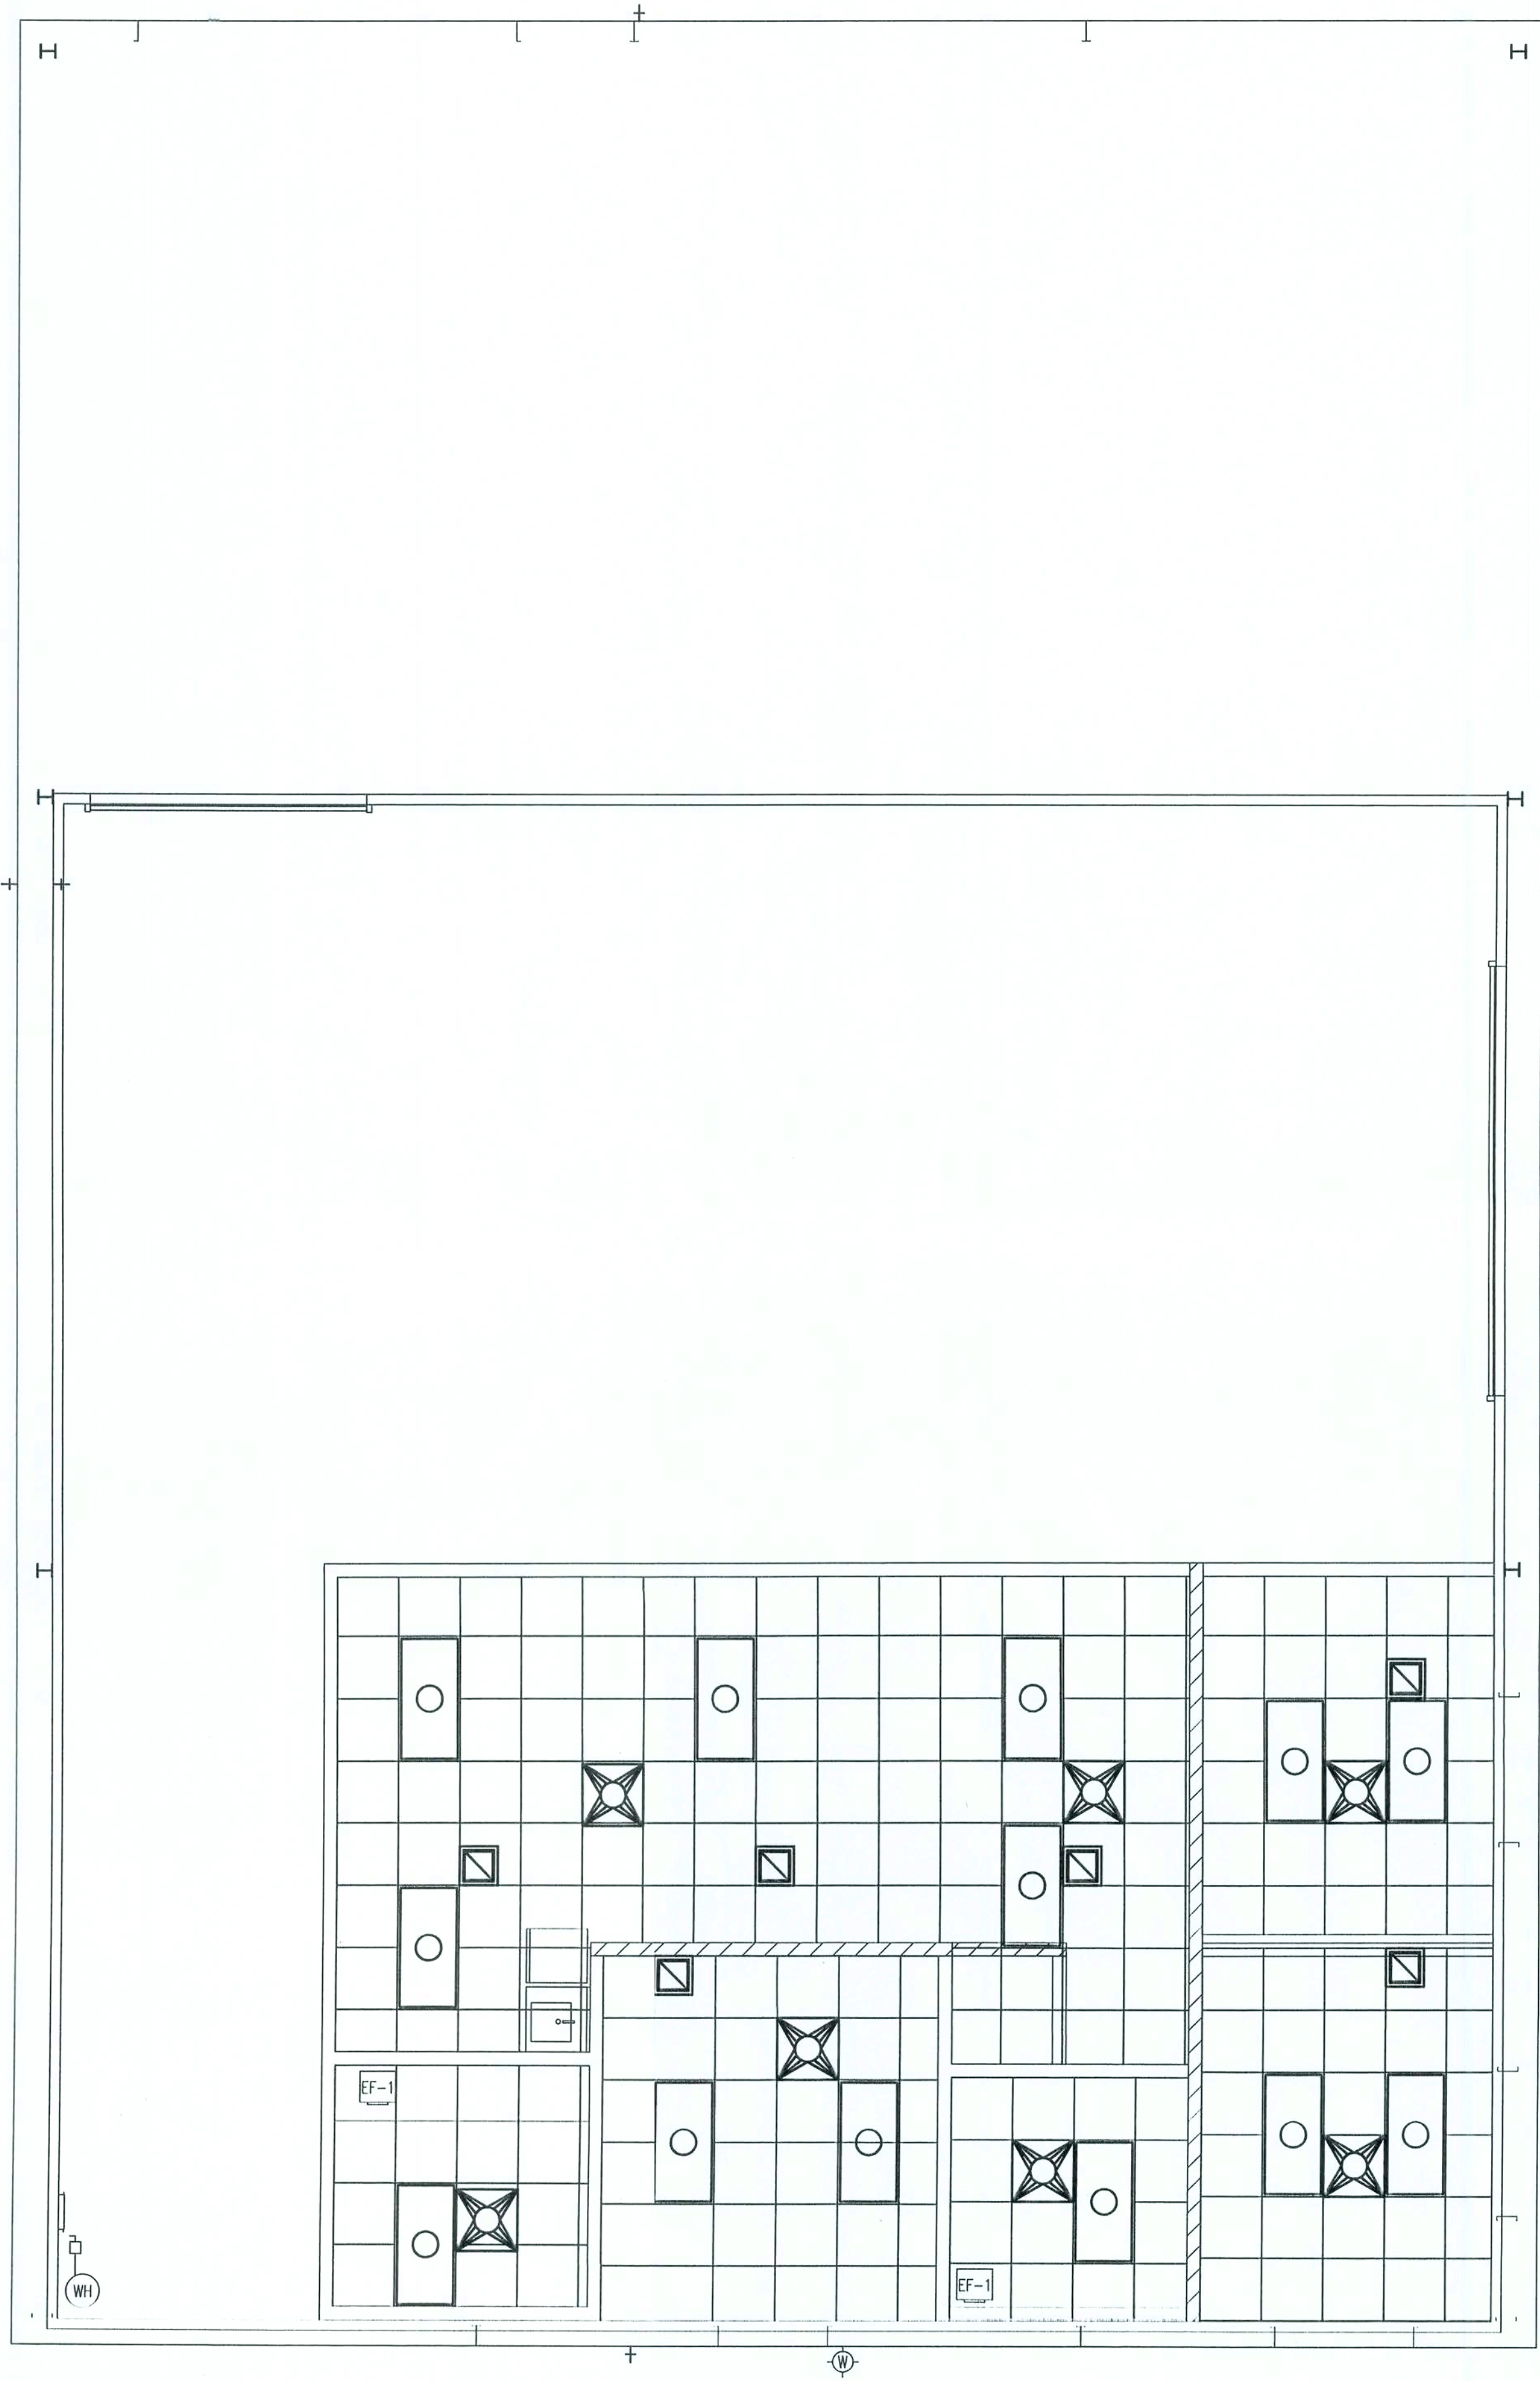

REFLECTED CEILING PLAN
1/4" = 1'-0"

LEGEND		
SYMBOL	QUANTITY	DESCRIPTION
	13	48" FLUORESCENT LIGHT
	7	AIR SUPPLY VENT
	6	AIR RETURN VENT
	2	EXHAUST FAN

PROJECT NUMBER
PF05-365

DRAWN BY
T.K.

CHECKED BY
G.G.


REFLECTED CEILING PLAN

A-3.0


ACTION SIGN & GRAPHICS
COMMERCIAL SITE
LAKE CITY, FL

P.O. Box 187
130 West Howard Street
Lake City, FL 32044
Phone: (386) 362-3678
Fax: (386) 362-6133
STRUCTURAL/CIVIL ENGINEER Gary Gill, P.E.
Auth. # 9461


REV #	DATE	REVISION NOTES
1		
2		
3		
4		
5		
6		
7		
8		
9		
10		

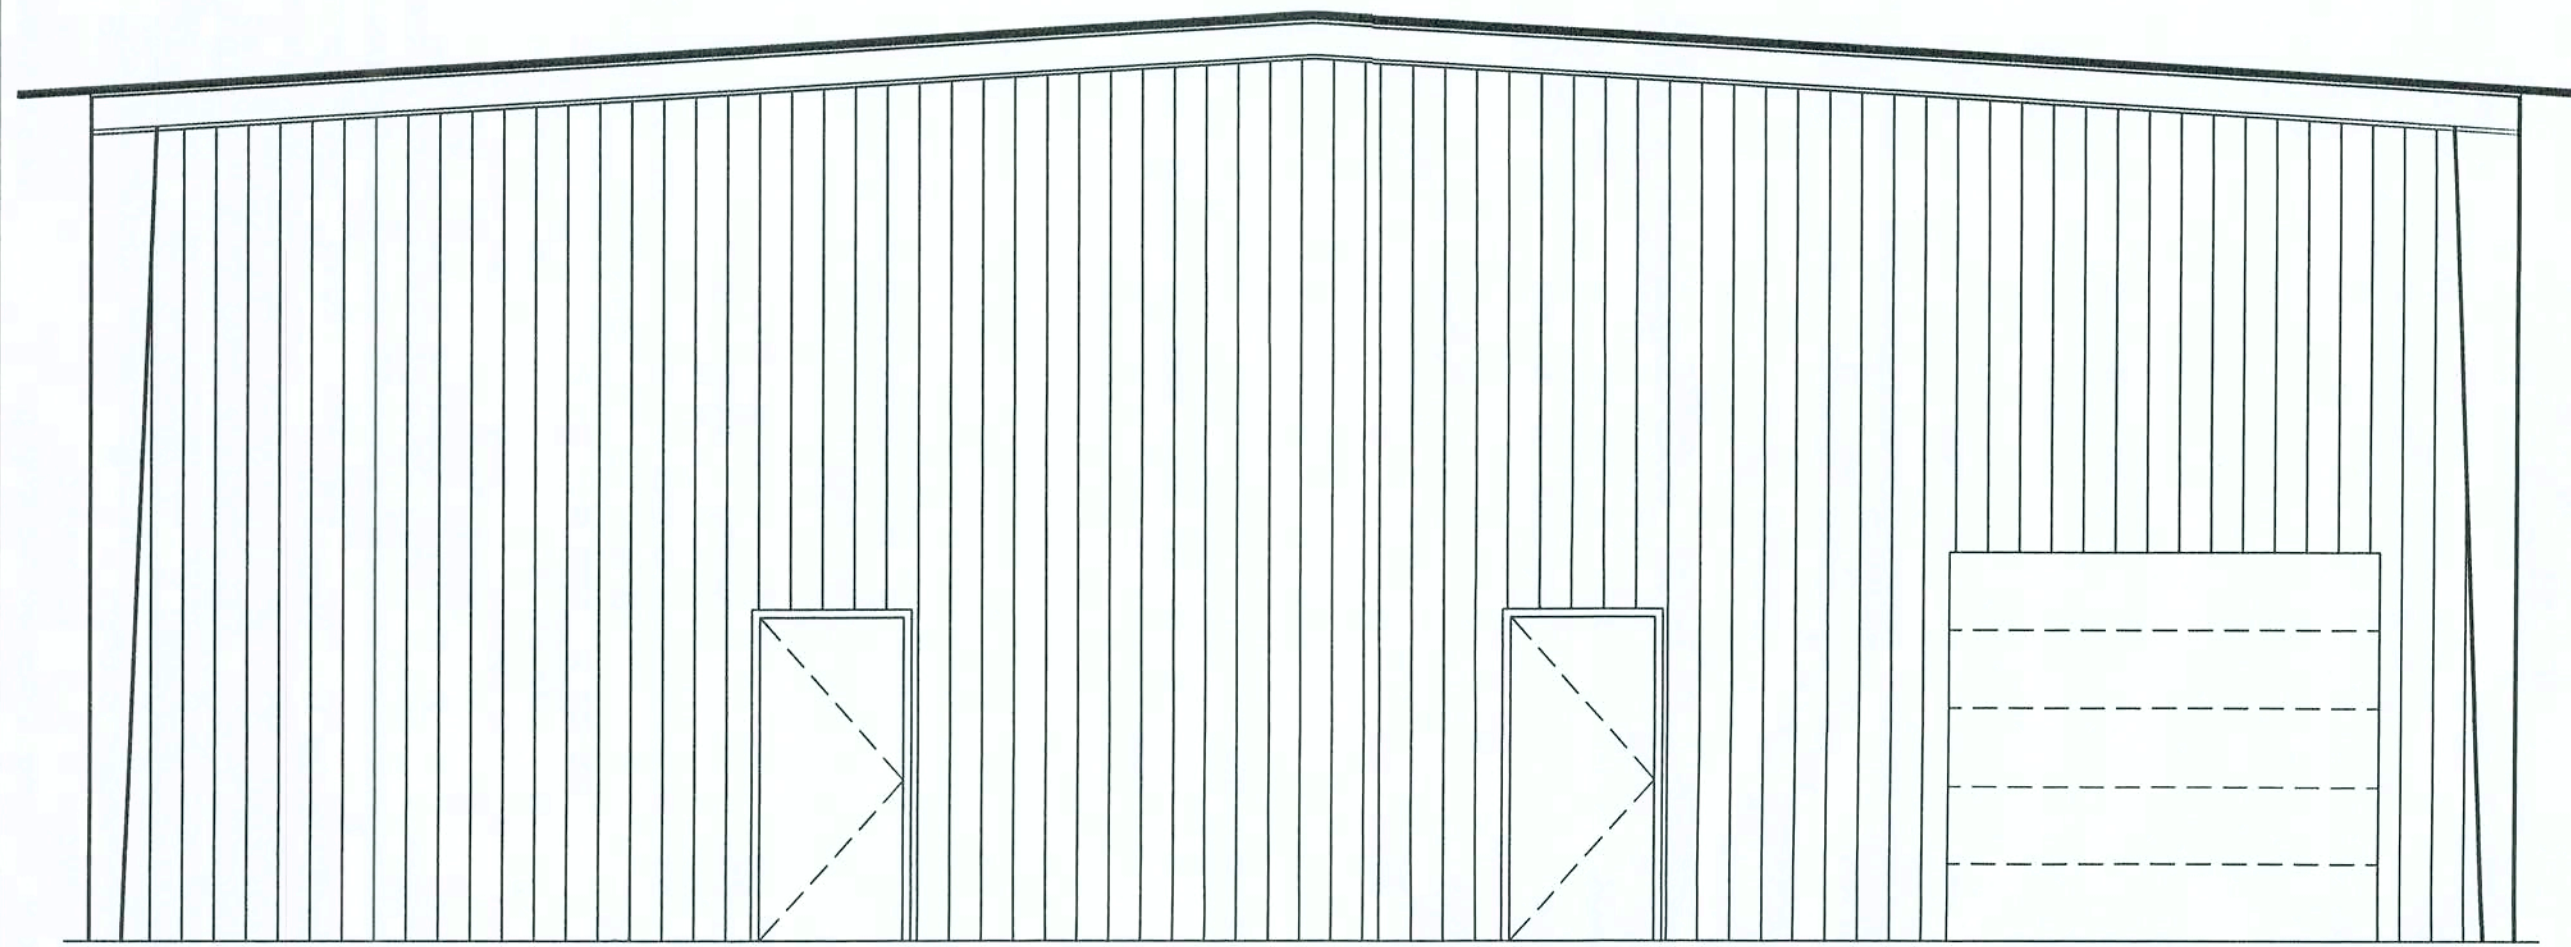


SOUTH ELEVATION
1/4" = 1'-0"

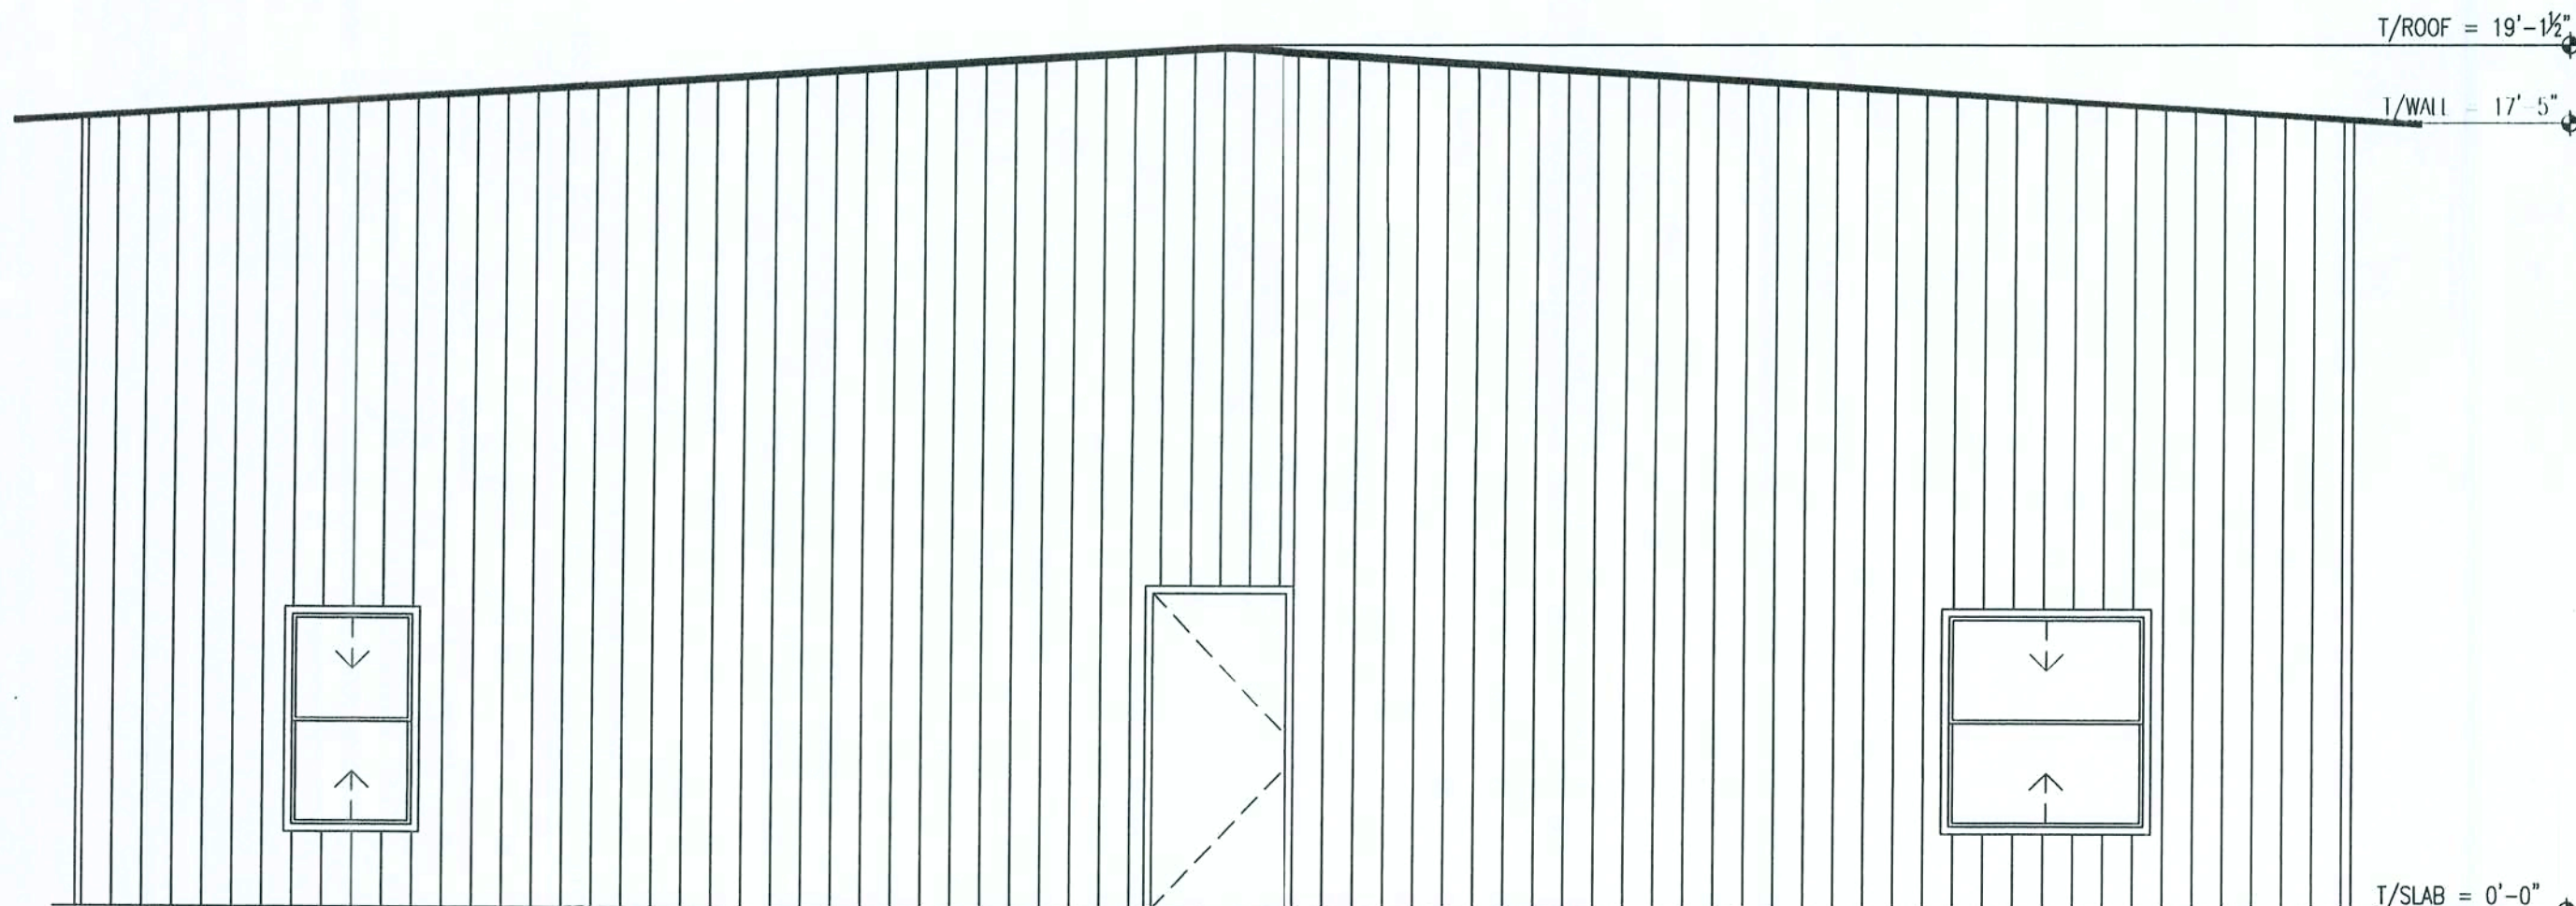


NORTH ELEVATION
1/4" = 1'-0"

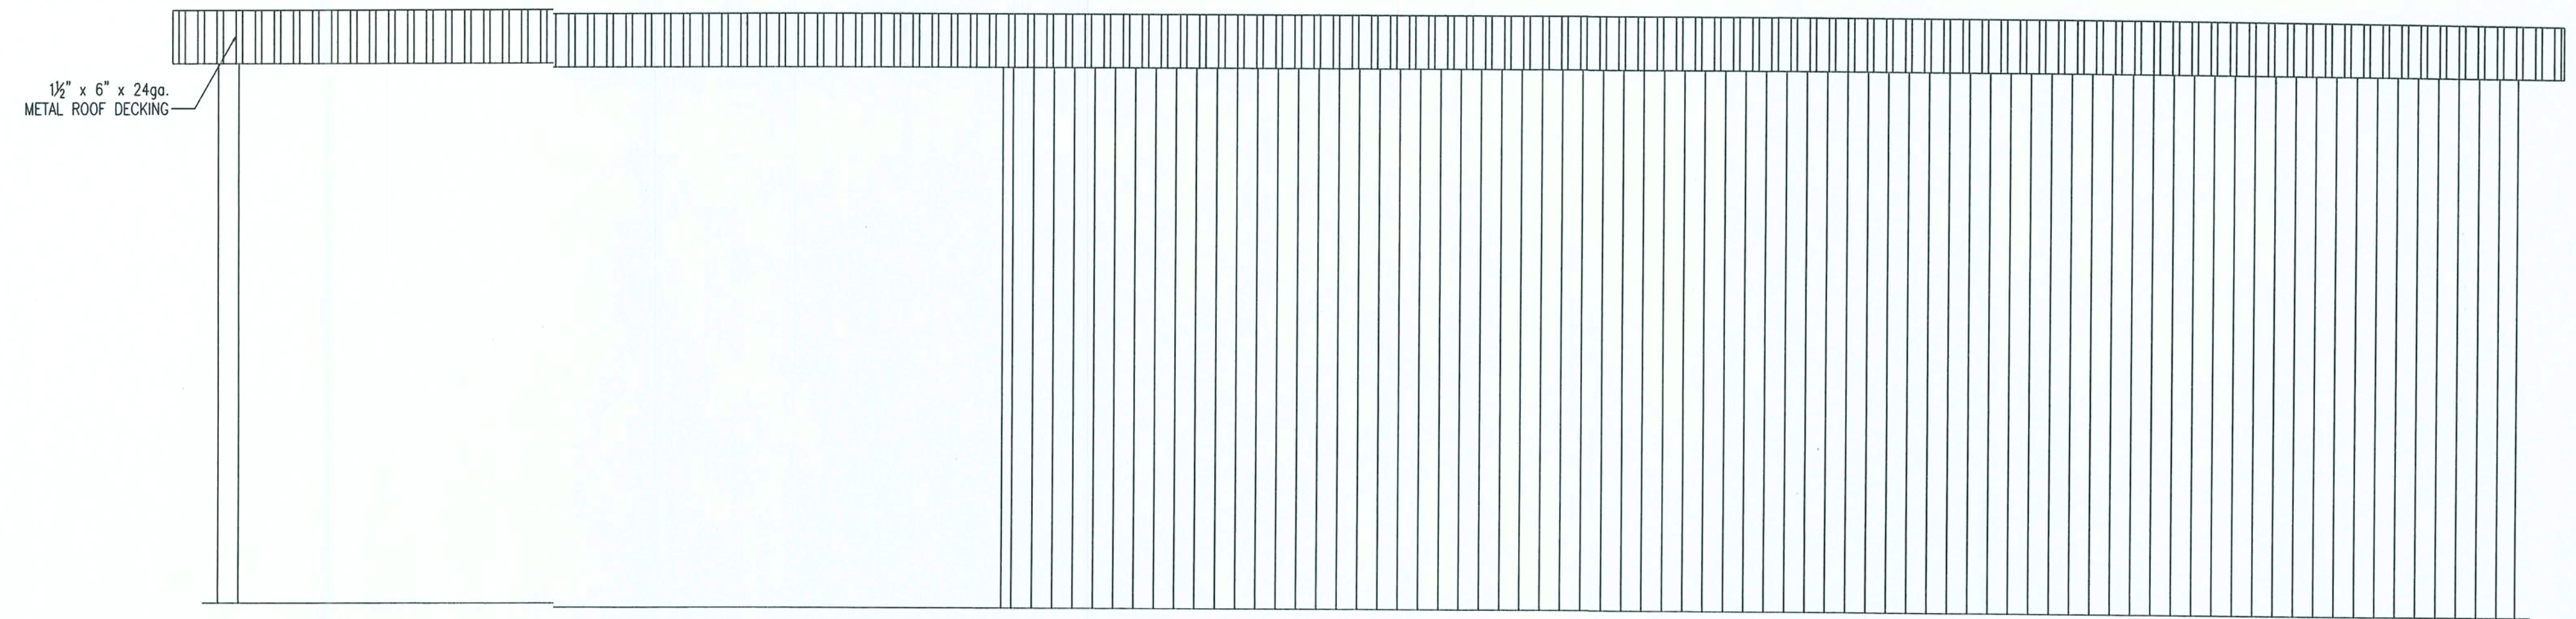

EAST ELEVATION
1/4" = 1'-0"

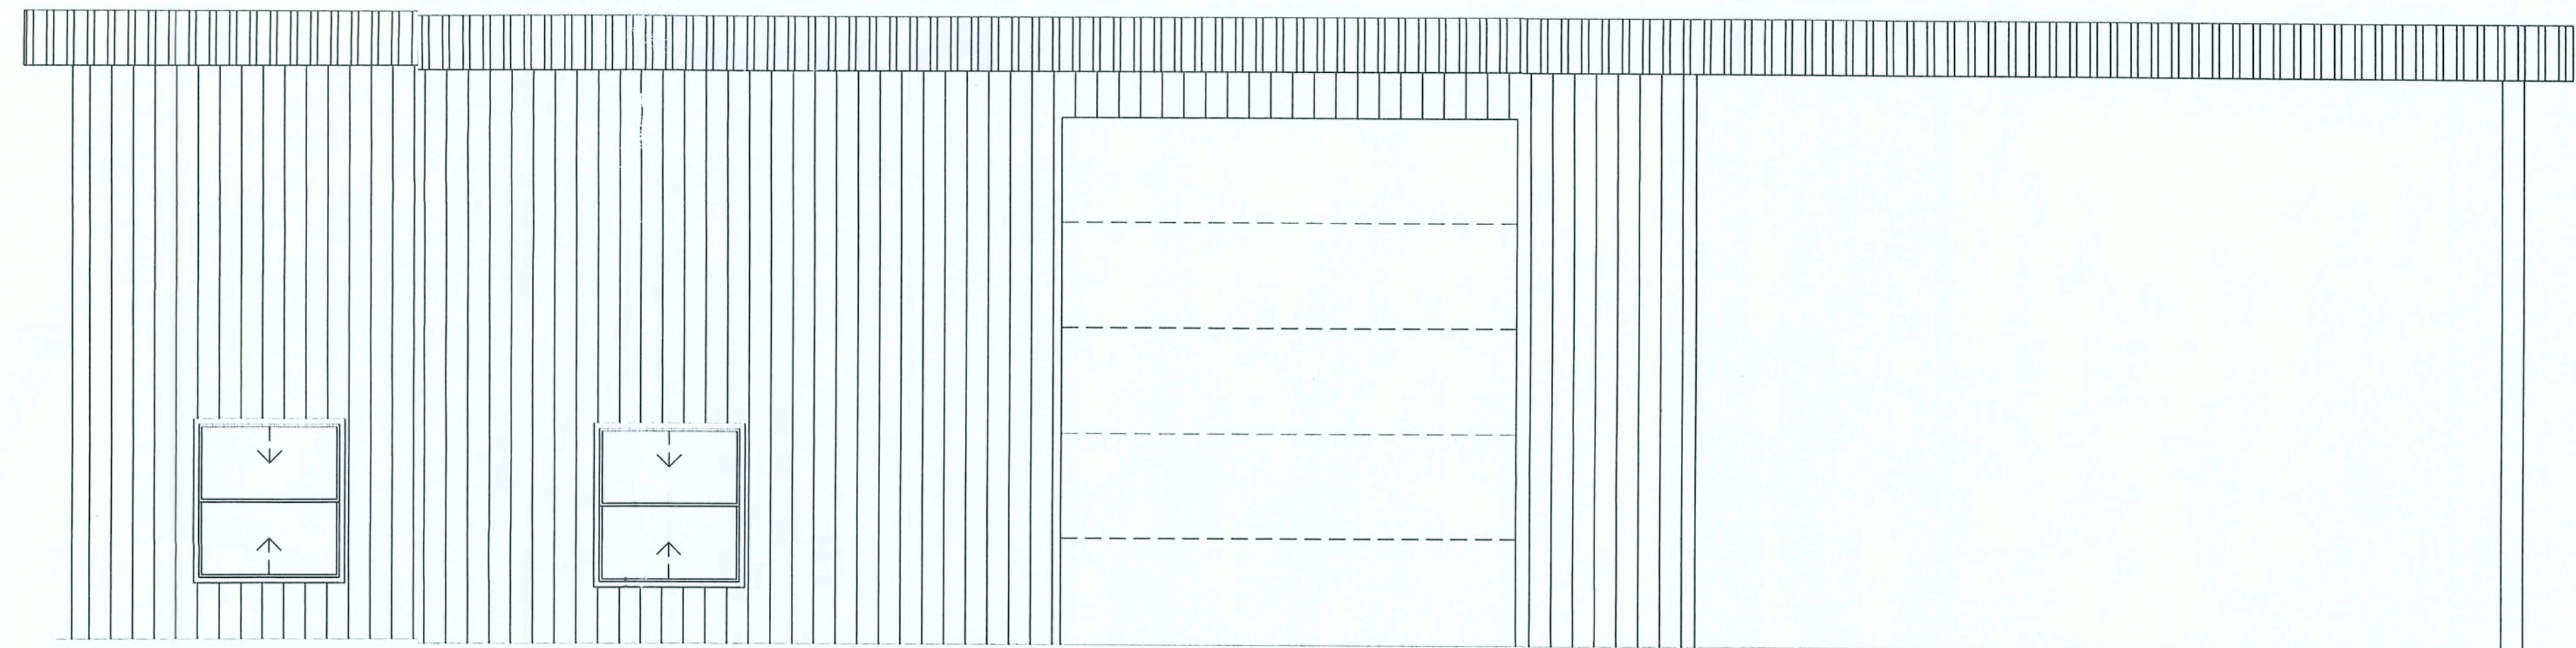


WEST ELEVATION
1/4" = 1'-0"

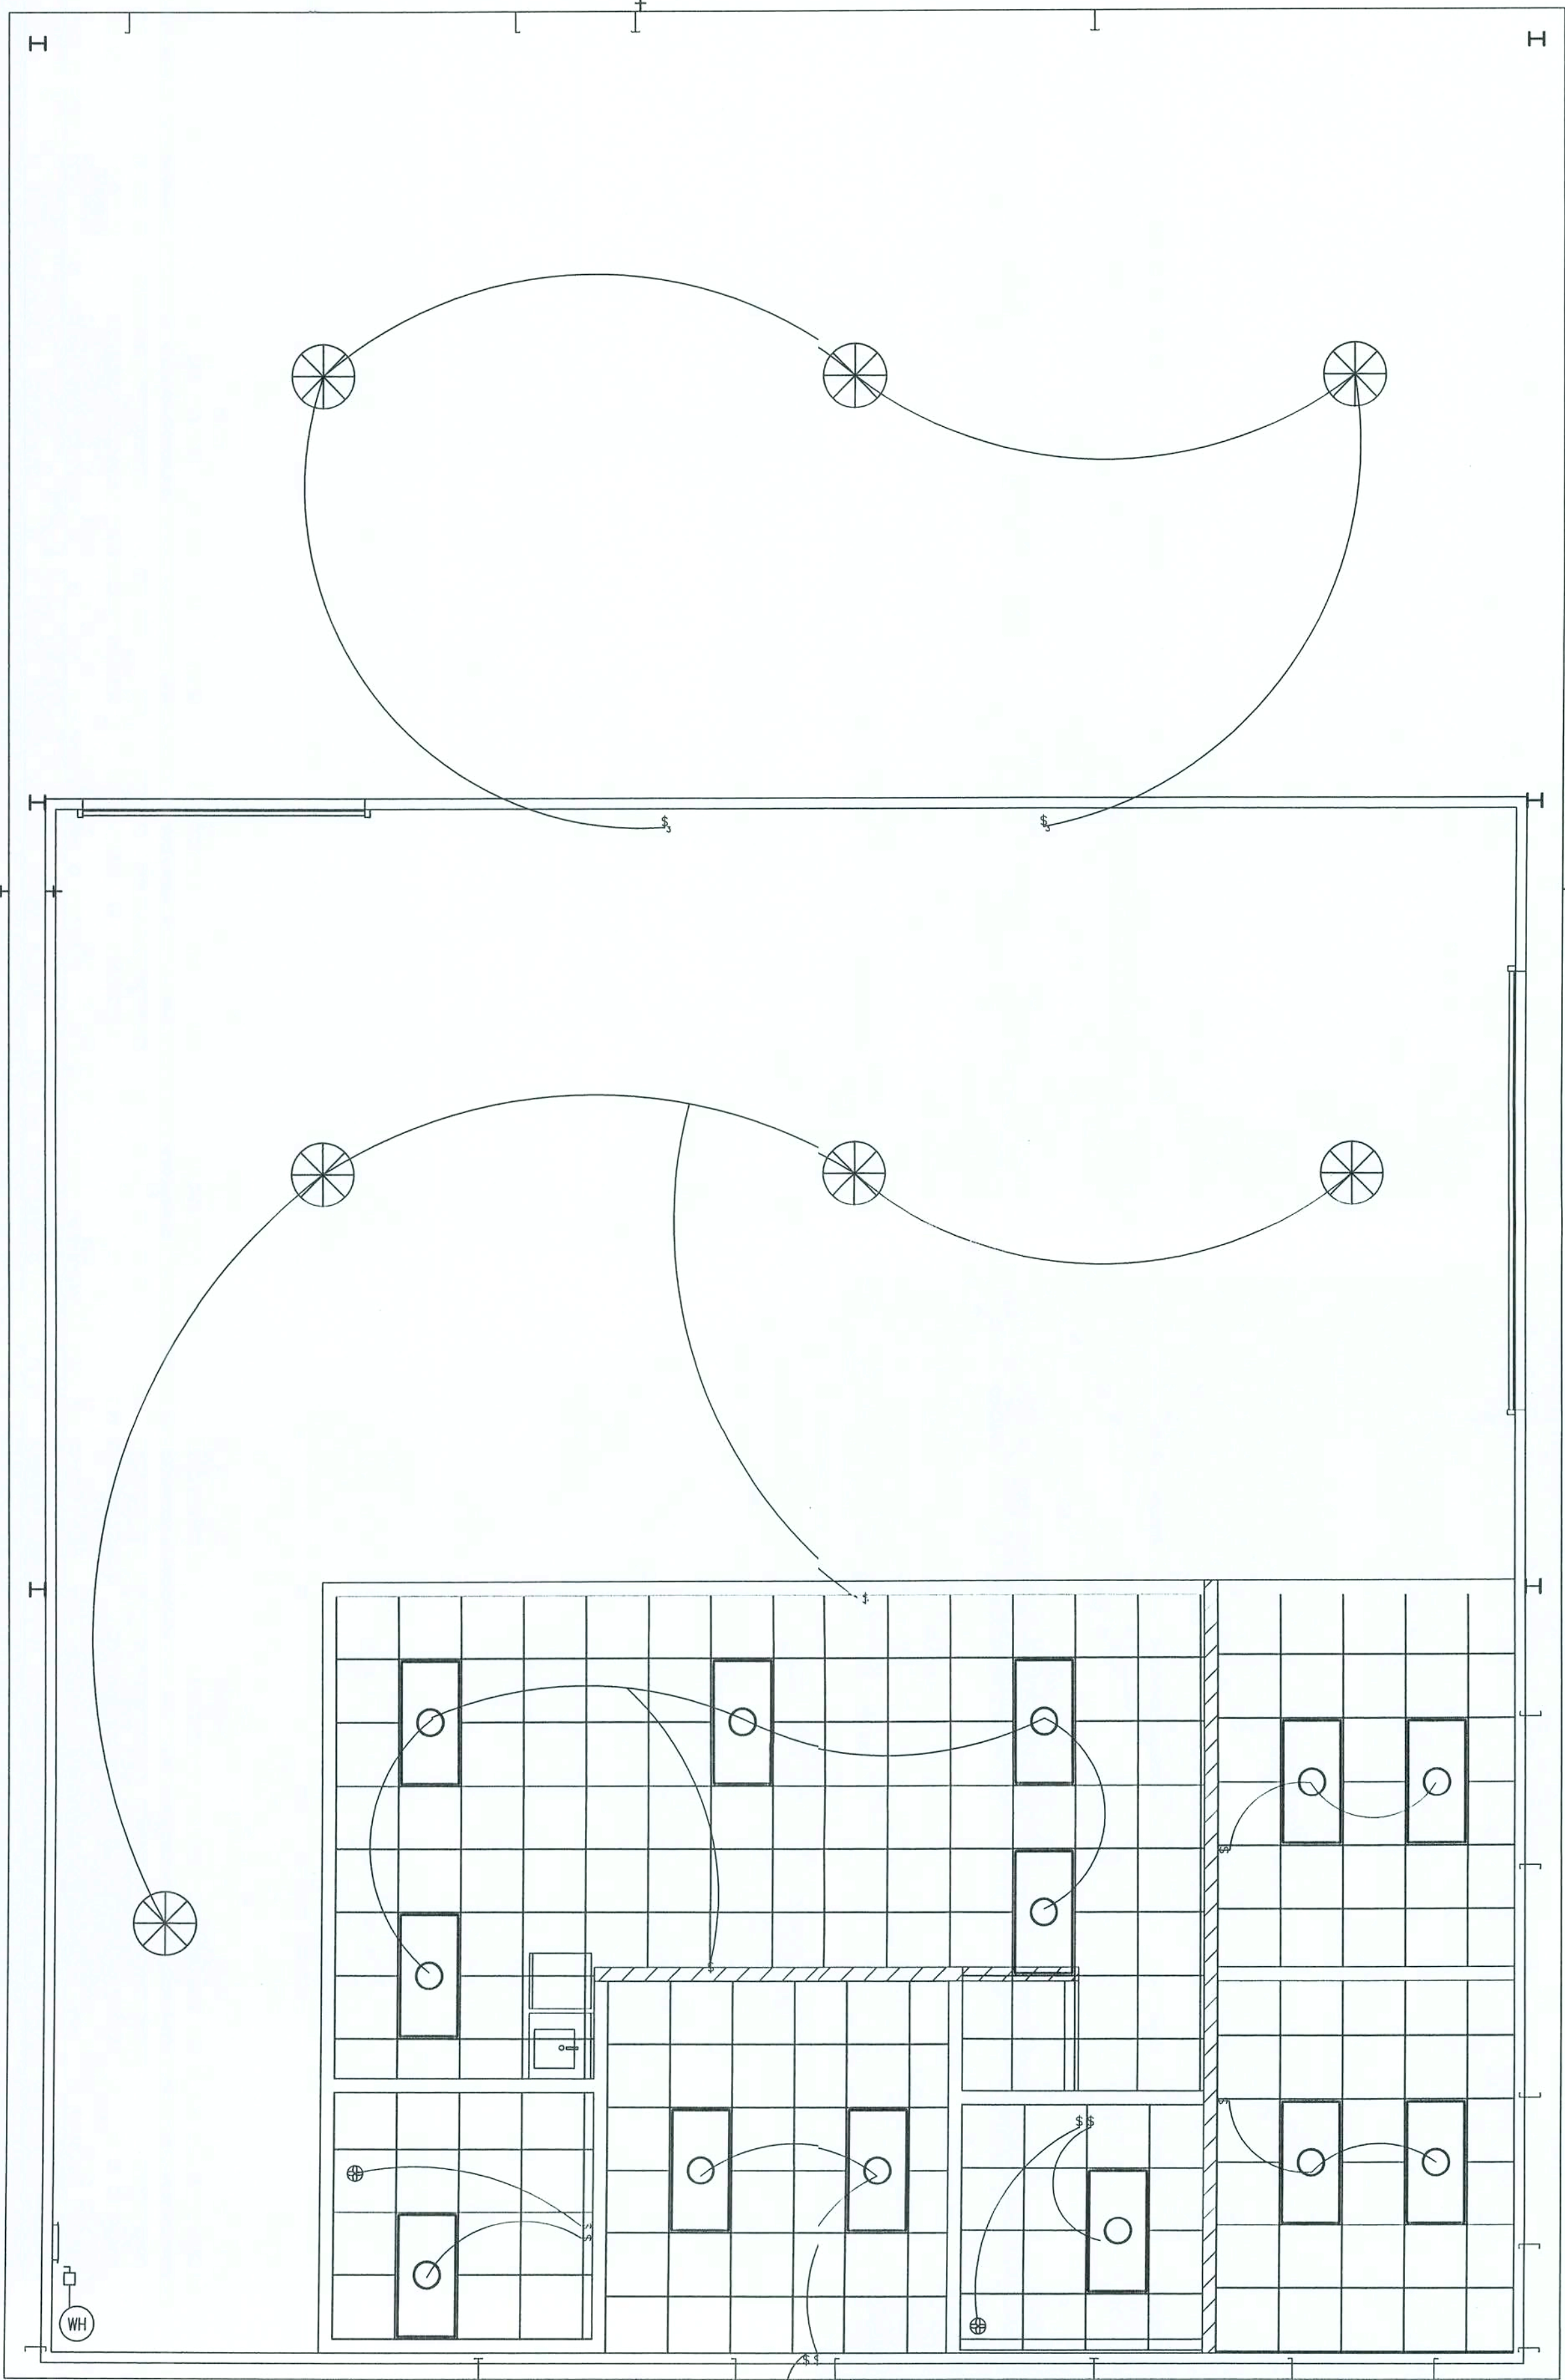

LIGHTING PLAN
1/4" = 1'-0"

ALL ELECTRICAL EQUIPMENT SHALL BE PROVIDED WITH A SERIES INTEGRATED RATING "S" 65,000 RMS AMPS AT 240 VAC.

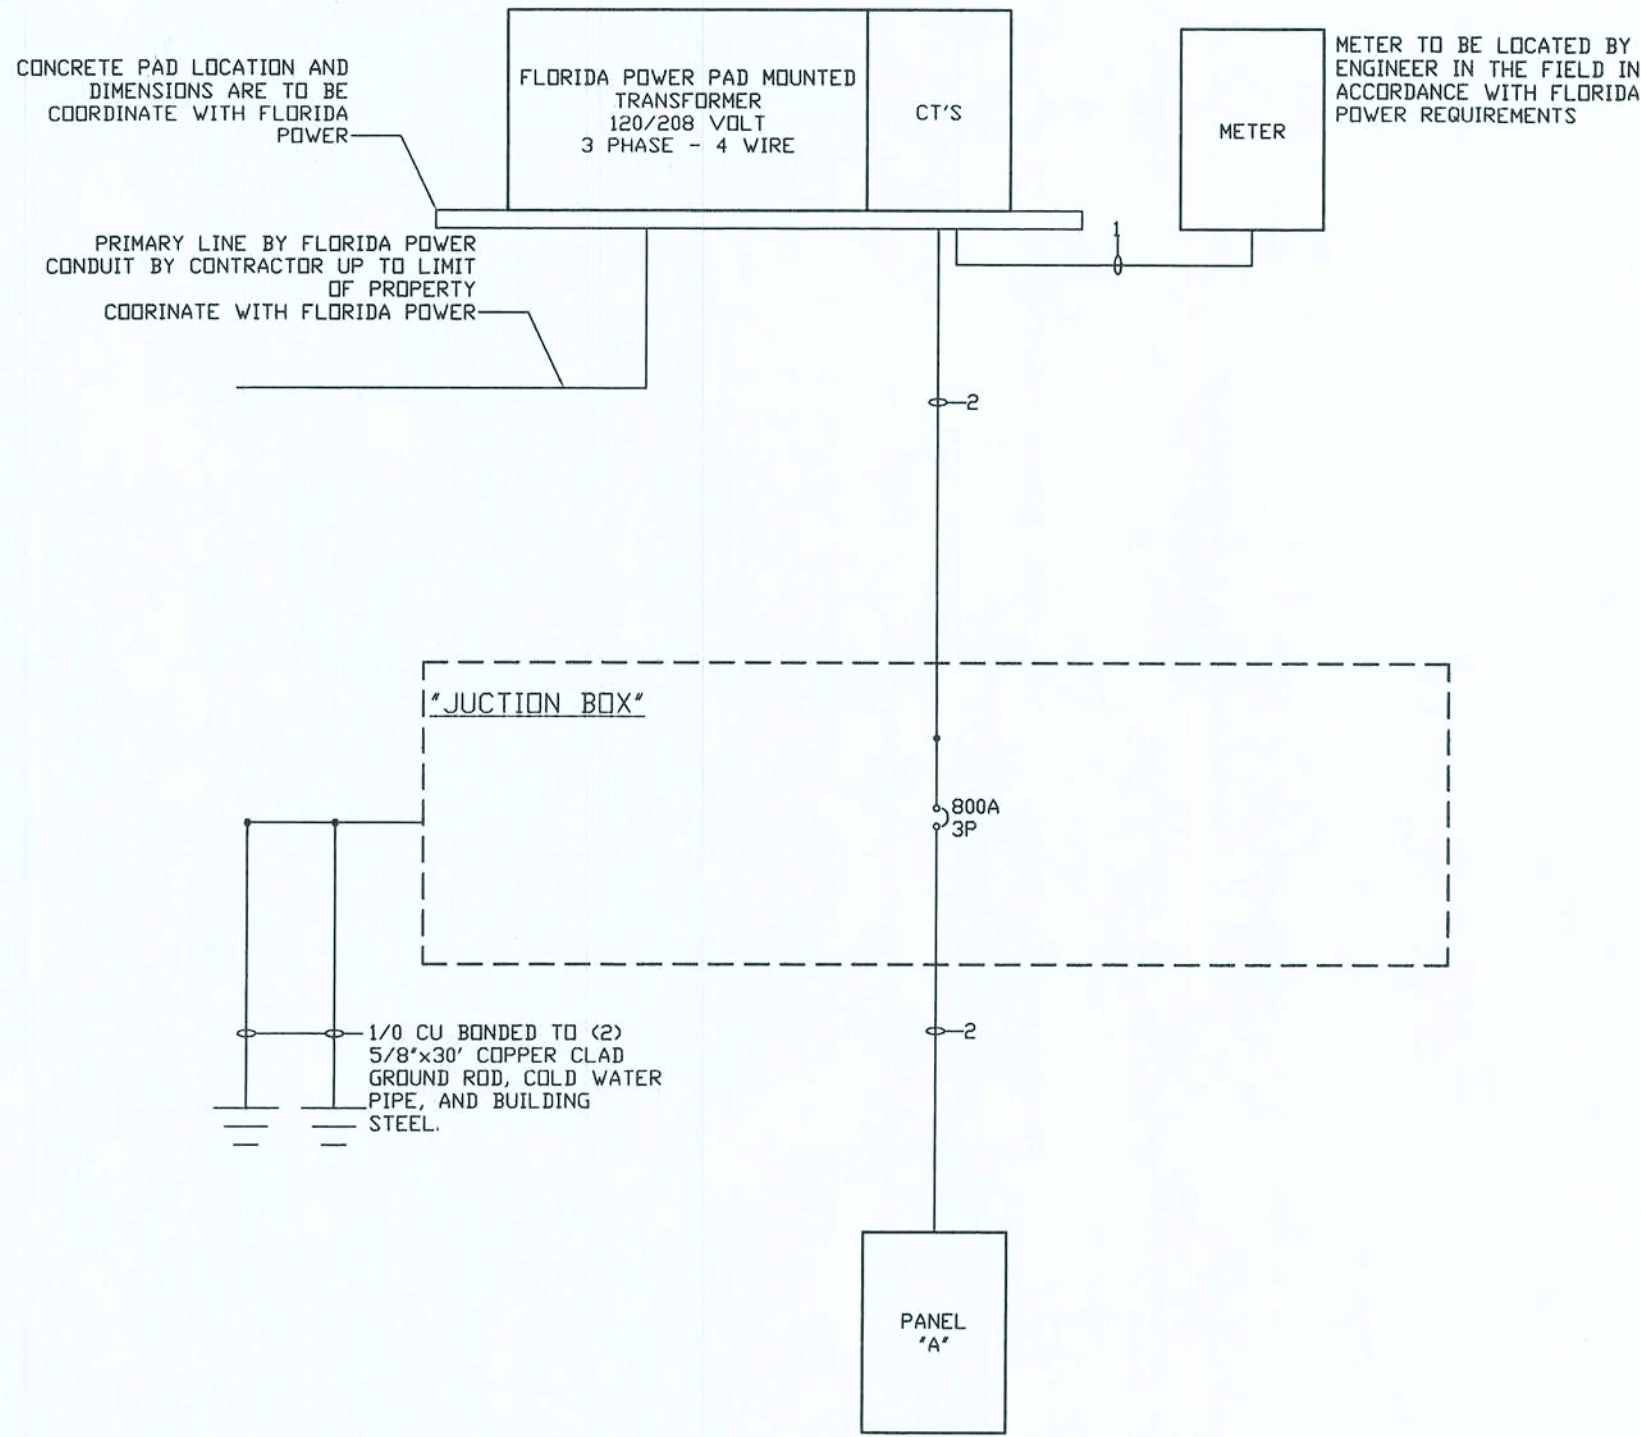

POWER RISER DIAGRAM - 120/208V, 3P, 4W

POWER RISER NOTES:

- CONTRACTOR SHALL CONTACT UTILITY COMPANY PERSONNEL AS NECESSARY FOR NEW SERVICE COORDINATION. CONTRACTOR SHALL OBTAIN UTILITY CO. REQUIREMENTS AND BE RESPONSIBLE FOR ALL WORK NECESSARY TO INSTALL NEW SECONDARY SERVICE AS INDICATED.
- CONTRACTOR SHALL PROVIDE AND INSTALL ALL TAP LUGS IN SERVICE WIRING AND ANY ADDITIONAL EQUIPMENT REQUIRED FOR TERMINATION OF NEW SECONDARY SERVICE CONDUCTORS. CONTRACTOR SHALL VERIFY EXACT ROUTE OF SECONDARY CONDUCTORS IN FIELD TO LOCATION OF NEW DISCONNECTS AND PANELS. CONTRACTOR SHALL PERFORM ALL WORK NECESSARY FOR A COMPLETE AND OPERABLE SYSTEM.
- PROVIDE INTEGRATED SERIES RATING OF 65,000 RMS AMP/AT 240VAC AND ANY ADDITIONAL EQUIPMENT REQUIRED FOR TERMINATION OF NEW SECONDARY

WIRE LEGEND	
①	1 - 15' CONDUIT
②	(2 SETS) 4-#900MCM - 4' CONDUIT

ELECTRICAL LEGEND		
SYMBOL	QUANTITY	DESCRIPTION
	4	28"Ø LOW BAY LUMINAIRE
	10	SINGLE POLE SWITCH
	2	3-WAY SWITCH
	15	48" FLUORESCENT LIGHT
	1	EXTERIOR LIGHT

PANEL - "MDF"														
VOLTAGE: 208/120 VOLTS, 3 PHASE, 4 WIRE					MAIN: 800A MLD					NOTES: "H" INDICATES HACR BREAKER "L" INDICATES NON-CURRENT AC LOADS - SIZES BASED ON LARGEST LOADS "G" INDICATES GFCI BREAKER "A" INDICATES ASSUMED LOADS				
BUS RATING: 1400 AMPS					MOUNTING: SEE PLANS									
LOAD SERVED	LOADS (WATT)				CKT BRKR	PHASE	CT	CT	CKT BRKR	LOADS (WATT)				LOAD SERVED
	LGTS	RECS	MOTOR	HEAT	AMP/P	A	B	C	AMP/P	LGTS	RECS	MOTOR	HEAT	
AHU			12480		60/3	1	*	-	2	720				LIGHTING
			12480			3	*	-	4	720				
			12480			5	-	*	6	20/2	3486			LIGHTING
ACU			6240		30/3	7	*	-	8	3486				
			6240			9	-	*	10	20/2	720			LIGHTING
			6240			11	-	*	12	720				
SPARE						13	*	-	14	20/2	4150			LIGHTING
SPARE						15	-	*	16	4150				
SPARE						17	-	*	18	20/2	4150			LIGHTING
SPARE						19	-	-	20	4150				
SPARE						21	-	-	22					SPARE
SPARE						23	-	-	24					SPARE
SPARE						25	-	-	26					SPARE
SPARE						27	-	-	28					SPARE
SPARE						29	-	-	30					SPARE
SPARE						31	-	-	32					SPARE
SPARE						33	-	-	34					SPARE
SPARE						35	-	-	36					SPARE
SPARE						37	-	-	38					SPARE
SPARE						39	-	-	40					SPARE
SPARE						41	-	-	42					SPARE
	LGTS	RECS	MOTOR	HEAT						LGTS	RECS	MOTOR	HEAT	
	-	-	-	-						26452	-	-	-	
SUB TOTALS										SUB TOTALS				
PHASE LOADING														
PHASE - A	8356	18300	18720	-						22.3	36.6	56.1	-	CONNECTED KW TOTALS
PHASE - B	5590	18300	18720	-						1.25	26.6	-	-	DEMAND
PHASE - C	8356	-	18720	-						27.9	26.6	56.1	-	ADJUSTED KW TOTALS
PHASE TOTAL		A	B	C									115	TOTAL CONNECTED KW
		22302	36604	56160									110.6	TOTAL ADJUSTED KW
													208	THREE PHASE VOLTAGE
													642	TOTAL PANEL AMPERAGE

GENERAL ELECTRICAL NOTES:

THE ELECTRICAL INSTALLATION SHALL COMPLY WITH THE NEC & ALL STATE & LOCAL CODES.

WHETHER FURNISHED BY THE ELECTRICAL CONTRACTOR OR BY OTHERS, THE ELECTRICAL CONTRACTOR SHALL PROVIDE CONNECTION OF ELECTRICAL EQUIPMENT MENTIONED IN THIS SECTION OR NOTED ON THE DRAWINGS.

ALL WIRING DEVICES SHALL BE IVORY WITH SMOOTH IVORY PLASTIC PLATES, UNLESS OTHERWISE NOTED. PLATES FOR UNFINISHED AREAS SHALL BE SHEET STEEL OR CAST METAL.

ALL WIRING INCLUDING LOW VOLTAGE AND COMMUNICATION TO BE IN CONDUIT.

ELECTRICAL CONTRACTOR SHALL FURNISH ALL JUNCTION BOXES, CONDUIT, WIRE, & CONNECTIONS TO WIRE ALL EQUIPMENT, DEVICES AND LIGHTING.

THE CONTRACTOR SHALL CONTRACT OWN VENDOR TO WIRE AND CABLE TELEPHONE COMMUNICATIONS, AND DATA SERVICES CONNECTIONS AT ALL PANELBOARDS, CIRCUIT BREAKERS, POWER OUTLETS, CONVENIENCE OUTLETS, AND SWITCHES SHALL BE MADE FOR A COMPLETE AND OPERABLE SYSTEM.

THE ELECTRICAL CONTRACTOR SHALL PROVIDE POWER WIRING AND UNIT DISCONNECT SWITCHES FOR ALL HVAC EQUIPMENT UNLESS OTHERWISE STATED ON PLANS.

THE ELECTRICAL CONTRACTOR SHALL FURNISH AND INSTALL HVAC CONTROL WIRING. FINAL CONTROL CONNECTIONS SHALL BE BY THE HVAC CONTRACTOR. THE ELECTRICAL CONTRACTOR SHALL VERIFY VOLTAGE, PHASE, AND CURRENT CHARACTERISTICS OF ALL HVAC EQUIPMENT BEFORE INSTALLATION OF ANY CONDUIT WIRE, DISCONNECTS, ETC.

LOCATE ALL OUTLETS AS INDICATED ON PLANS WITH MOUNTING HEIGHTS AS SHOWN. COORDINATE INSTALLATION WITH OTHER EQUIPMENT. SECURE OUTLETS TO STRUCTURE. ALL CONDUCTORS SHALL BE CONTINUOUS FROM OUTLET TO OUTLET. AVOID UNNECESSARILY SPLICING.

ALL ELECTRICAL EQUIPMENT UNDER THIS CONTRACT SHALL BE LISTED AND CONFORM TO THE APPLICABLE REQUIREMENTS OF THE LATEST EDITION OF THE FOLLOWING PUBLICATIONS:

- UNDERWRITER'S LABORATORIES, INC. - UL
- NATIONAL FIRE PROTECTION ASSOCIATION - NFPA
- NATIONAL ELECTRICAL MANUFACTURER'S ASSOC. - NEMA
- NATIONAL ELECTRICAL CODE - NEC

SHEET METAL BOXES SHALL BE STANDARD TYPE WITH KNOCKOUT MADE OF HOT DIPPED GALVANIZED STEEL AS MANUFACTURED BY STEEL CITY, RACD, OR EQUAL.

ALL CIRCUITS TO BE 2 #12, #12 GND UNLESS NOTED.

PANELBOARDS SHALL CONSIST OF COMPLETE DEAD FRONT ASSEMBLIES INCLUDING BACK, CAN, BUS BAR, TRIMS AND DOORS. SHEET METAL CABINET SWITCHING AND OVER CURRENT DEVICES. CIRCUIT BREAKERS SHALL BE MOLDED CASE, THERMAL-MAGNETIC QUICK-MAKE, AND QUICK BREAK TYPE WITH TRIP-FREE HANDLE. MULTI-POLE TYPE WITH INTERNAL COMMON TRIP BAR. CIRCUIT BREAKER SHALL BE SWITCH RATED AND BOLT ON TYPE. SQUARE "D" TYPE NQDB OR EQUAL BE G.E., SIEMENS, & SQUARE "D".

PROPERLY IDENTIFY ALL SWITCH AND DEVICES WITH A PLASTIC NAMEPLATE.

USE ONLY APPROVED LUBRICANT FOR WIRE PULLING PURPOSES.

SUPPORT OF ALL LIGHT FIXTURES SHALL BE THE RESPONSIBILITY OF THE ELECTRICAL CONTRACTOR. LIGHT FIXTURES SHALL BE SUPPORTED FROM THE BUILDING STRUCTURE. LAY-IN LIGHT FIXTURES SUPPORTED ENTIRELY BY CEILING GRID SYSTEM SHALL HAVE "HURRICANE" CLIPS FASTENED TO CEILING GRID.

SAFETY SWITCHES AND DISCONNECTS SHALL BE INSTALLED WHERE INDICATED ON PLANS OR WHERE OTHERWISE REQUIRED BY CODE ENFORCING AUTHORITIES. THEY SHALL BE INSTALLED WITH ADEQUATE HAND ACCESS TO AND CLEARANCE FOR OPERATION AND FUSE REPLACEMENT. EACH SWITCH SHALL HAVE ENGRAVED PLASTIC NAMEPLATES INSTALLED THEREON.

DISCONNECT SWITCHES: HEAVY DUTY, ENCLOSED SAFETY SWITCHES, QUICK-MAKE, AND QUICK-BREAK TYPE WITH INTERLOCKED COVER AND TYPE ENCLOSE REQUIRED FOR THE LOCATION. FUSED TYPE SHALL BE EQUIPPED WITH REJECTION TYPE FUSES. SQUARE "D" G.E., ITE, CUTLER HAMMER.

ALL EXHAUST FANS SHALL HAVE DISCONNECT SWITCHES.

ALL REMOTE EQUIPMENT ON ROOF OR GROUNDS SHALL HAVE A DISCONNECT SWITCH AT EACH PIECE OF EQUIPMENT.

ALL CONDUITS SHALL BE A MINIMUM OF 1/2" DIAMETER UNLESS OTHERWISE NOTED. ALL HOMERUN CONDUITS SHALL BE A MINIMUM OF 3/4" DIAMETER UNLESS OTHERWISE NOTED. ALL CONDUITS IN SLABS OR UNDERGROUND SHALL BE A MINIMUM OF 3/4" DIAMETER SCHEDULE 40 PVC UNLESS OTHERWISE NOTED.

WIRING DEVICES: ALL DEVICES SHALL BE SPECIFICATION GRADE OF THE SAME MANUFACTURER.

WALL SWITCHES SHALL BE SINGLE POLE 20 AMP 120/277 VOLT, DUPLEX RECEPTACLES SHALL BE 2 WIRE 3 POLE GROUNDED 120 VOLT 20 AMP. RECEPTACLES MOUNTED IN FIRE OR SMOKE RATED WALLS SHALL BE MINIMUM 25" APART.

ALL CONDUITS TO BE 90 DEGREE WHERE PENETRATING FIRE OR SMOKE RATED WALLS SO THEY CAN BE PROPERLY CAULKED.

ALL EXTERIOR RECEPTACLES, JUNCTION BOXES, LIGHTS, AND OTHER DEVICES SHALL BE LISTED FOR OUTDOOR APPLICATION AND SHALL HAVE WEATHER PROOF COVERS.

CIRCUIT NUMBERS ARE FOR IDENTIFICATION ONLY. THE CONTRACTOR WILL BE RESPONSIBLE FOR CORRECTLY PHASING THE CIRCUITS IN THE PANELS. HOMERUNS OF SIMILAR SINGLE PHASE CIRCUITS MAY BE COMBINED IN ONE CONDUIT WITH A COMMON NEUTRAL. ONLY THREE SINGLE PHASE CIRCUITS MAY BE COMBINED IN ANY ONE CONDUIT.

ON COMPLETION OF THE BUILDING, THE CONTRACTOR SHALL BALANCE THE PANEL. PHASE NUMBER OF WIRES MAY NOT BE INDICATED FOR ALL CIRCUITS. ONLY THOSE WHERE CLARIFICATION IS NECESSARY.

THE ELECTRICAL CONTRACTOR SHALL PROVIDE ALL WIRES NECESSARY FOR PROPER FUNCTION OF THE SYSTEM WHETHER INDICATED ON PLANS OR NOT.

CONTRACTOR SHALL SECURE ALL PERMITS.

ELECTRICAL DRAWINGS ARE CONSIDERED DIAGRAMMATIC AND INDICATE GENERAL ARRANGEMENT ONLY. REFER TO ARCHITECTURAL DRAWINGS FOR DIMENSIONS AND EXACT LOCATION.

ALL SINGLE-PHASE BRANCH CIRCUITS, 120 VOLT LIGHTING, RECEPTACLES, & MOTORS SHALL CONSIST OF PHASE, NEUTRAL & GROUND CONDUCTOR.

ALL EQUIPMENT GROUND WIRES SHALL BE COPPER AND SIZED AS PER NEC ARTICLE 250.

CONTRACTOR SHALL MATCH EXISTING BUILDING STANDARD FIRE ALARM SYSTEM AND EQUIPMENT AS REQUIRED AND EXTEND NEW FIRE ALARM CIRCUITS FROM THE EXISTING FIRE ALARM CONTROL PANEL TO THE NEW FIRE ALARM DEVICES SHOWN AND CONNECT AS REQUIRED FOR A COMPLETE AND OPERABLE SYSTEM. CONTRACTOR SHALL PROVIDE RE-CERTIFICATION OF THE FIRE ALARM SYSTEM AS REQUIRED AND IN ACCORDANCE WITH NFPA-72 AND THE LOCAL AUTHORITY HAVING JURISDICTION.

ACTION SIGN & GRAPHICS
COMMERCIAL SITE
LAKE CITY, FL

LIGHTING PLAN








PROJECT NUMBER
PF05-365
DRAWN BY
T.K.
CHECKED BY
G.G.


E-1.0

SHEET ###

AIR COOLED HEAT PUMP SCHEDULE															ELECTRIC HEAT DATA				
CONDENSING UNIT																			
CU LABEL(S)	MANUFACTURER & MODEL NO.	TOTAL CAPACITY COOLING	SENSIBLE CAPACITY COOLING	COIL MODEL NO.	COMP. RLA	FAN FLA	VOLTAGE	MOP	SEER / EER	WEIGHT	TOTAL BTU	D/A CFM	E.S.P. BLOWER SPEED	FAN HP	VOLTAGE				
AHU #1	YORK - MHC	48,000	39,500	2BBLA008	19.2	1.4	240-1-60	35	10.30 / 14.30	42 LBS	12,000	430	0	HIGH	2.4 HP 240-1-60				
GENERAL NOTES: - ALL RATINGS ARE AT ARI ENTERING CONDITIONS UNLESS OTHERWISE NOTED. - PROVIDE VIBRATION ISOLATION FOR UNITS. - EXTERNAL STATIC PRESSURE DOES NOT INCLUDE COIL OR FILTER PRESSURE DROP. - CONTRACTOR MAY SUBSTITUTE MANUFACTURER FOR APPROVED EQUAL. IT SHALL BE THE CONTRACTOR'S RESPONSIBILITY TO VERIFY THAT CLEARANCE REQUIREMENTS ARE MET FOR ANY SUBSTITUTIONS.										ABBREVIATION LEGEND D/A - PROTECTION HP - RATIO FLA - RATIO MOP - RATIO SEER - RATIO					SPECIFIC NOTES: D SIZE AND RUN OF REFRIGERANT PIPING AS PER MANUFACTURERS PUBLISHED RECOMMENDATIONS. D INSULATE REFRIGERANT SUCTION LINE WITH 3/4" ARMAFLEX OR EQUAL. D INSTALL FILTER DRYER AND STRAINER IN REFRIGERANT LIQUID LINE. HORSE POWER/E.S.P. EXTERNAL STATIC PRESSURE PROVIDE FIELD INSTALLED ACCESSORIES, AND 3 MINUTE TIME DELAY SWITCH. RUNNING LOAD AMPS SEER - ENERGY EFFICIENCY D PROVIDE 5 YEAR WARRANTY ON COMPRESSOR AND 1 YEAR WARRANTY ON ALL PARTS AND LABOR. FULL LOAD AMPS SEER - SEASONAL ENERGY EFFICIENCY RATIO SHALL BE PROVIDED WITH 24 VOLT CONTROL.				

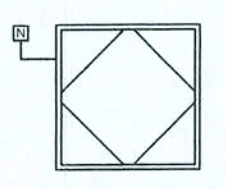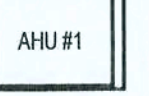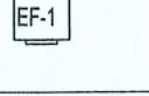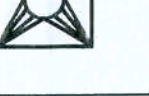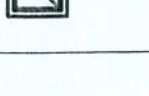GENERAL MECHANICAL NOTES	
1. THE CONTRACTOR SHALL FURNISH ALL LABOR, MATERIALS, AND EQUIPMENT NECESSARY FOR THE INSTALLATION CODE AND ALL OPTION OF A COMPLETE SYSTEM IN WITH THESE DRAWINGS, THE APPLICABLE BUILDING CODE AND ALL OTHER APPLICABLE STATE, COUNTY AND LOCAL ORDINANCES AND THE LATEST ADDITION OF THE FOLLOWING PUBLICATIONS, ASHREA, NFPA 90A, 90B, 91, AND ANSI B-91 MECHANICAL REFRIGERATION.	14. ALL BRANCH TAKE-OFFS TO BE PROVIDED W/MANUAL VOLUME DAMPERS. ALL ELBOWS AND TEE'S MUST BE FURNISHED W/TURNING VANES. PROVIDE 45 DEGREES BRANCH TAKE-OFF AS PER BRANCH DUCT TAKE-OFF DETAIL.
2. THE CONTRACTOR SHALL PAY ALL COSTS OF PERMIT, INSPECTIONS, AND ALL OTHER COSTS INCIDENTAL TO THE COMPLETION AND TESTING OF THIS WORK.	15. PROVIDE NEW FILTERS FOR ALL AIR CONDITIONING EQUIPMENT BEFORE STARTING THEM. REPLACE THEM PRIOR TO ACCEPTANCE BY OWNER.
3. THE PLUMBING CONTRACTOR SHALL VISIT THE SITE AND THOROUGHLY FAMILIARIZE HIMSELF WITH ALL EXISTING CONDITIONS. ALL EXECUTION AND BACKFILL AS REQUIRED FOR THIS PHASE OF CONSTRUCTION SHALL BE A PART OF THIS CONTRACT.	16. PROVIDE SMOKE DETECTORS WITH ACCESS DOORS IN ALL SUPPLY AIR DUCTS FOR FANS AND AHU'S SERVING A COMMON PLENUM OF 2000 CFM OR ABOVE. ALL SMOKE DETECTORS SHALL BE BY ONE MANUFACTURER, COORDINATE VOLTAGE ETC. WITH ELECTRICAL CONTRACTOR AND FIRE ALARM SYSTEM BEFORE ORDERING.
4. THE CONTRACTOR SHALL SUPPLY THE ENGINEER/ARCHITECT WITH AS-BUILT DRAWINGS UPON COMPLETION OF THIS PROJECT.	17. PROVIDE TYPE 'B' FIRE DAMPERS IN ALL DUCTS OR OPENINGS PENETRATING FIRE RATED WALLS, MECHANICAL AND ELECTRICAL ROOMS, TENANT SEPARATION, PARTITIONS, FLOOR OR ROOF SLABS AND AT D/A INTAKES. PROVIDE RADIATION DAMPERS IN RATED CEILING FOR ALL CEILING OPENING, CEILING FANS, DIFFUSERS OR GRILLES RATED FOR USE IN THE CEILING ASSEMBLY.
5. CONTRACTOR SHALL SUBMIT FOR APPROVAL FIVE (5) COPIES OF MANUFACTURER'S DRAWING FOR EACH PIECE OF EQUIPMENT AND CONTROLS INCLUDED IN CONTRACT.	18. HVAC CONTRACTOR SHALL PROVIDE AN INDEPENDENT TEST AND BALANCE REPORT FOR ALL MECHANICAL EQUIPMENT, AIR DEVICE, DAMPERS, AHU'S AND FANS. THE T&B SHALL BE IN ACCORDANCE WITH THE AIR BALANCE COUNCIL STANDARDS AND SHALL INCLUDE AIR QUANTITIES FOR ALL SUPPLY GRILLS, RETURN GRILLS, AND EXHAUST GRILLS AND LEAVING AND ENTERING AIR TEMPERATURE FROM THE SUPPLY GRILLS AND EVAPORATORS.
6. ALL MATERIAL SHALL BE NEW OF GOOD QUALITY. ALL WORK SHALL BE PERFORMED IN A WORKMANLIKE MANNER BY SKILLED WORKMAN.	19. THERMOSTAT LOCATION SHALL BE APPROVED BY OWNER AND ENGINEER/ARCHITECT BY INSTALLATION.
7. ALL AIR CONDITIONING DUCT SHALL BE OF 1-1/2" STANDARD DUTY FOIL REINFORCED FIBERGLASS WITH MANUFACTURER'S LOGO PRINTED ON THE VAPOR BARRIER. ALL FLEX TO BE R-8.	20. ALL INSULATION WILL HAVE FIRE/SMOKE RATING LESS THAN 50/50.
8. ALL EXHAUST DUCTS AND OUTSIDE AIR DUCTS SHALL BE GALVANIZED SHEET METAL WITH SEALED SEAMS AND JOINTS.	21. MECHANIC PLANS IN GENERAL, ARE DIAGRAMMATIC IN NATURE, AND ARE TO BE READ IN CONJUNCTION WITH ARCH, PLUMBING, ELECTRICAL, AND STRUCTURAL PLANS AND SHALL BE CONSIDERED AS ONE SET OF DOCUMENTS. DUCT AND PIPING OFFSETS, BENDS AND TRANSITIONS WILL BE REQUIRED TO PROVIDE AND INSTALL A COMPLETE FUNCTIONAL SYSTEM AND SHALL BE PROVIDED BY THE CONTRACTOR AT NO ADDITIONAL COST TO THE OWNER.
9. DUCT SIZES SHOWN ARE INSIDE DIMENSIONS.	22. NO COMBUSTIBLE MATERIALS ARE ALLOWED IN RETURN AIR PLENUMS OR ABOVE CEILINGS USED AS RETURN AIR PLENUM. IF SPACE WITH RETURN AIR PLENUM HAS ANY DECK PARTITION, AIR TRANSFER DUCTS MUST BE INSTALLED.
10. ALL AIR DEVICES (DIFFUSERS, REGISTERS, AND GRILLS) SHALL BE ALL ALUMINUM CONSTRUCTION WITH EXPOSED SURFACE OFF WHITE BAKED ENAMEL FINISH OR AS SPECIFIED BY ENGINEER/ARCHITECT. DEVICES SHALL BE TITUS, METALAIR, AND AIRGUIDE. PROVIDE OPPOSED BLADE DAMPERS AT ALL DIFFUSERS AND REGISTERS.	23. REFER TO PLUMBING PLAN FOR CONDENSATE PIPING.
11. THERMOSTAT SHALL BE COMBINATION COOLING/HEATING, WITH SYSTEM "COOL-AUTO-HEAT-OFF" AND FAN "ON-AUTO" SELECTOR SWITCHES. PROVIDE PROGRAMMABLE TYPE, CARRIER OR EQUAL.	24. IF PROJECT IS A REMODEL OF AN EXISTING BUILDING, THE CONTRACTOR SHALL VISIT JOB SITE PRIOR TO CONSTRUCTION AND COORDINATE ALL FIELD CONDITIONS. ENGINEER AND/OR ARCHITECT SHALL BE NOTIFIED OF ANY DISCREPANCIES.
12. REFRIGERANT LINES SHALL BE COPPER, TYPE "L" HARD DRAWN WITH WROUGHT COPPER SOLDER-JOINT TYPE FITTINGS, USE 95/5 SOLDER. REFRIGERANT LINES SHALL BE SIZED AS PER MANUFACTURER RECOMMENDATIONS.	25. CONTRACTOR SHALL INSTALL ALL OUTDOOR EQUIPMENT TO WITHSTAND A SUSTAINED 140 MPH WIND WITH A GUST FACTOR OF 30%. PROVIDE A LISTED PRE-ENGINEERED ASSEMBLY, OR CONTRACTOR SHALL BE RESPONSIBLE FOR THE CERTIFICATION OF ROOF MOUNTING.
13. ARMAFLEX 3/4" INSULATION SHALL BE USED FOR SUCTION LINES, FILTER/DRYER AND SIGHT GLASS SHALL BE PROVIDED AT LIQUID LINES.	26. PROVIDE ALL NECESSARY CONTACTS, RELAYS, ETC., FOR A COMPLETE OPERATING A/C SYSTEM.

SCHEDULE	
	A/C UNIT
	AIR HANDLER UNIT
	EXHAUST FAN
	AIR SUPPLY VENT
	AIR RETURN VENT
	SUPPLY DUCT
	RETURN DUCT

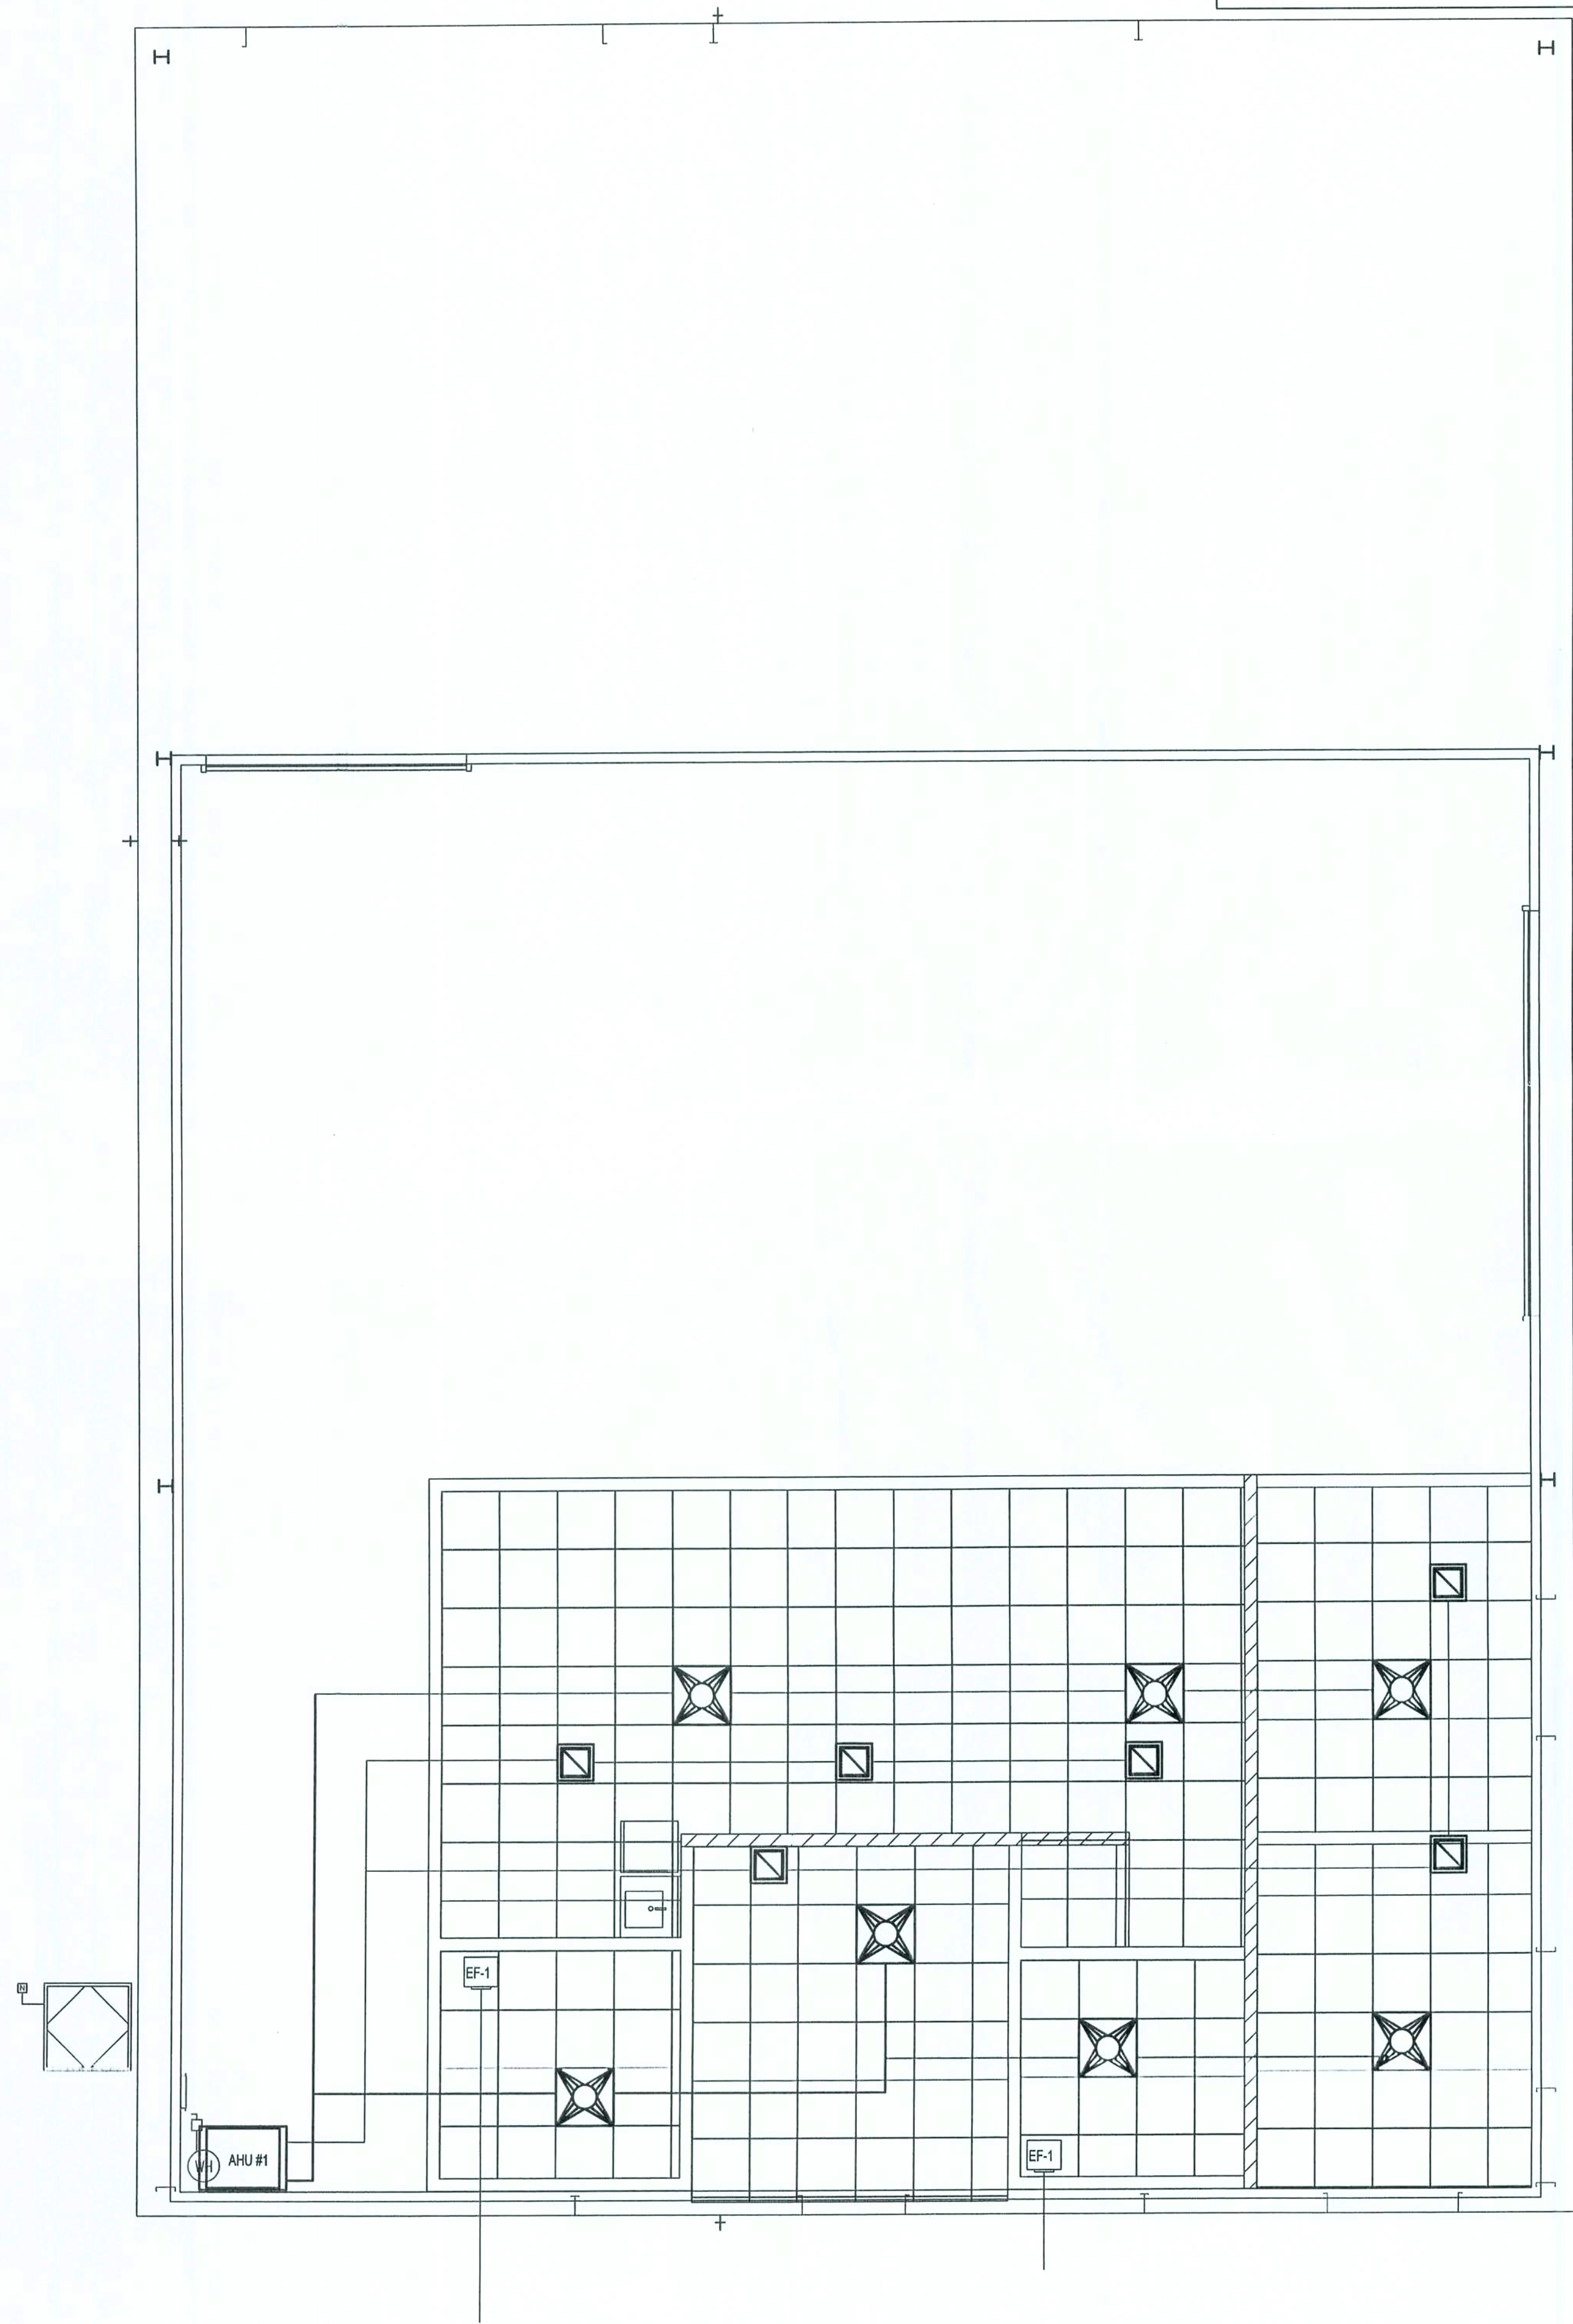

MECHANICAL PLAN
1/4" = 1'-0"

15-Mar-06

REV #

DATE

REVISION

REVISION NOTES


REV #

DATE

REVISION

REVISION NOTES



P.O. Box 187
130 West Howard Street
Live Oak FL 32064
Phone: (386) 362-3678
Fax: (386) 362-6133
GARY GILL, P.E.
Auth. # 9461


STRUCTURAL/CIVIL ENGINEERS

ACTION SIGN & GRAPHICS
COMMERCIAL SITE
LAKE CITY, FL

MECHANICAL PLAN

PROJECT NUMBER
PF05-365
DRAWN BY
T.K.
CHECKED BY
G.G.
M-1.0
SHEET ###

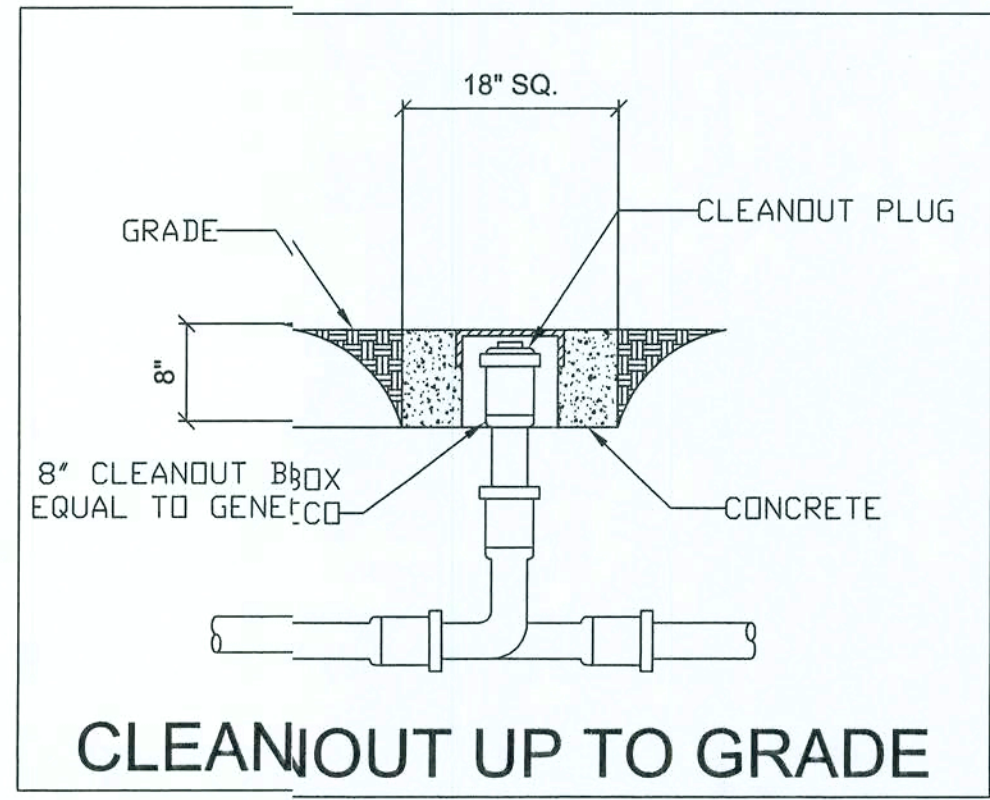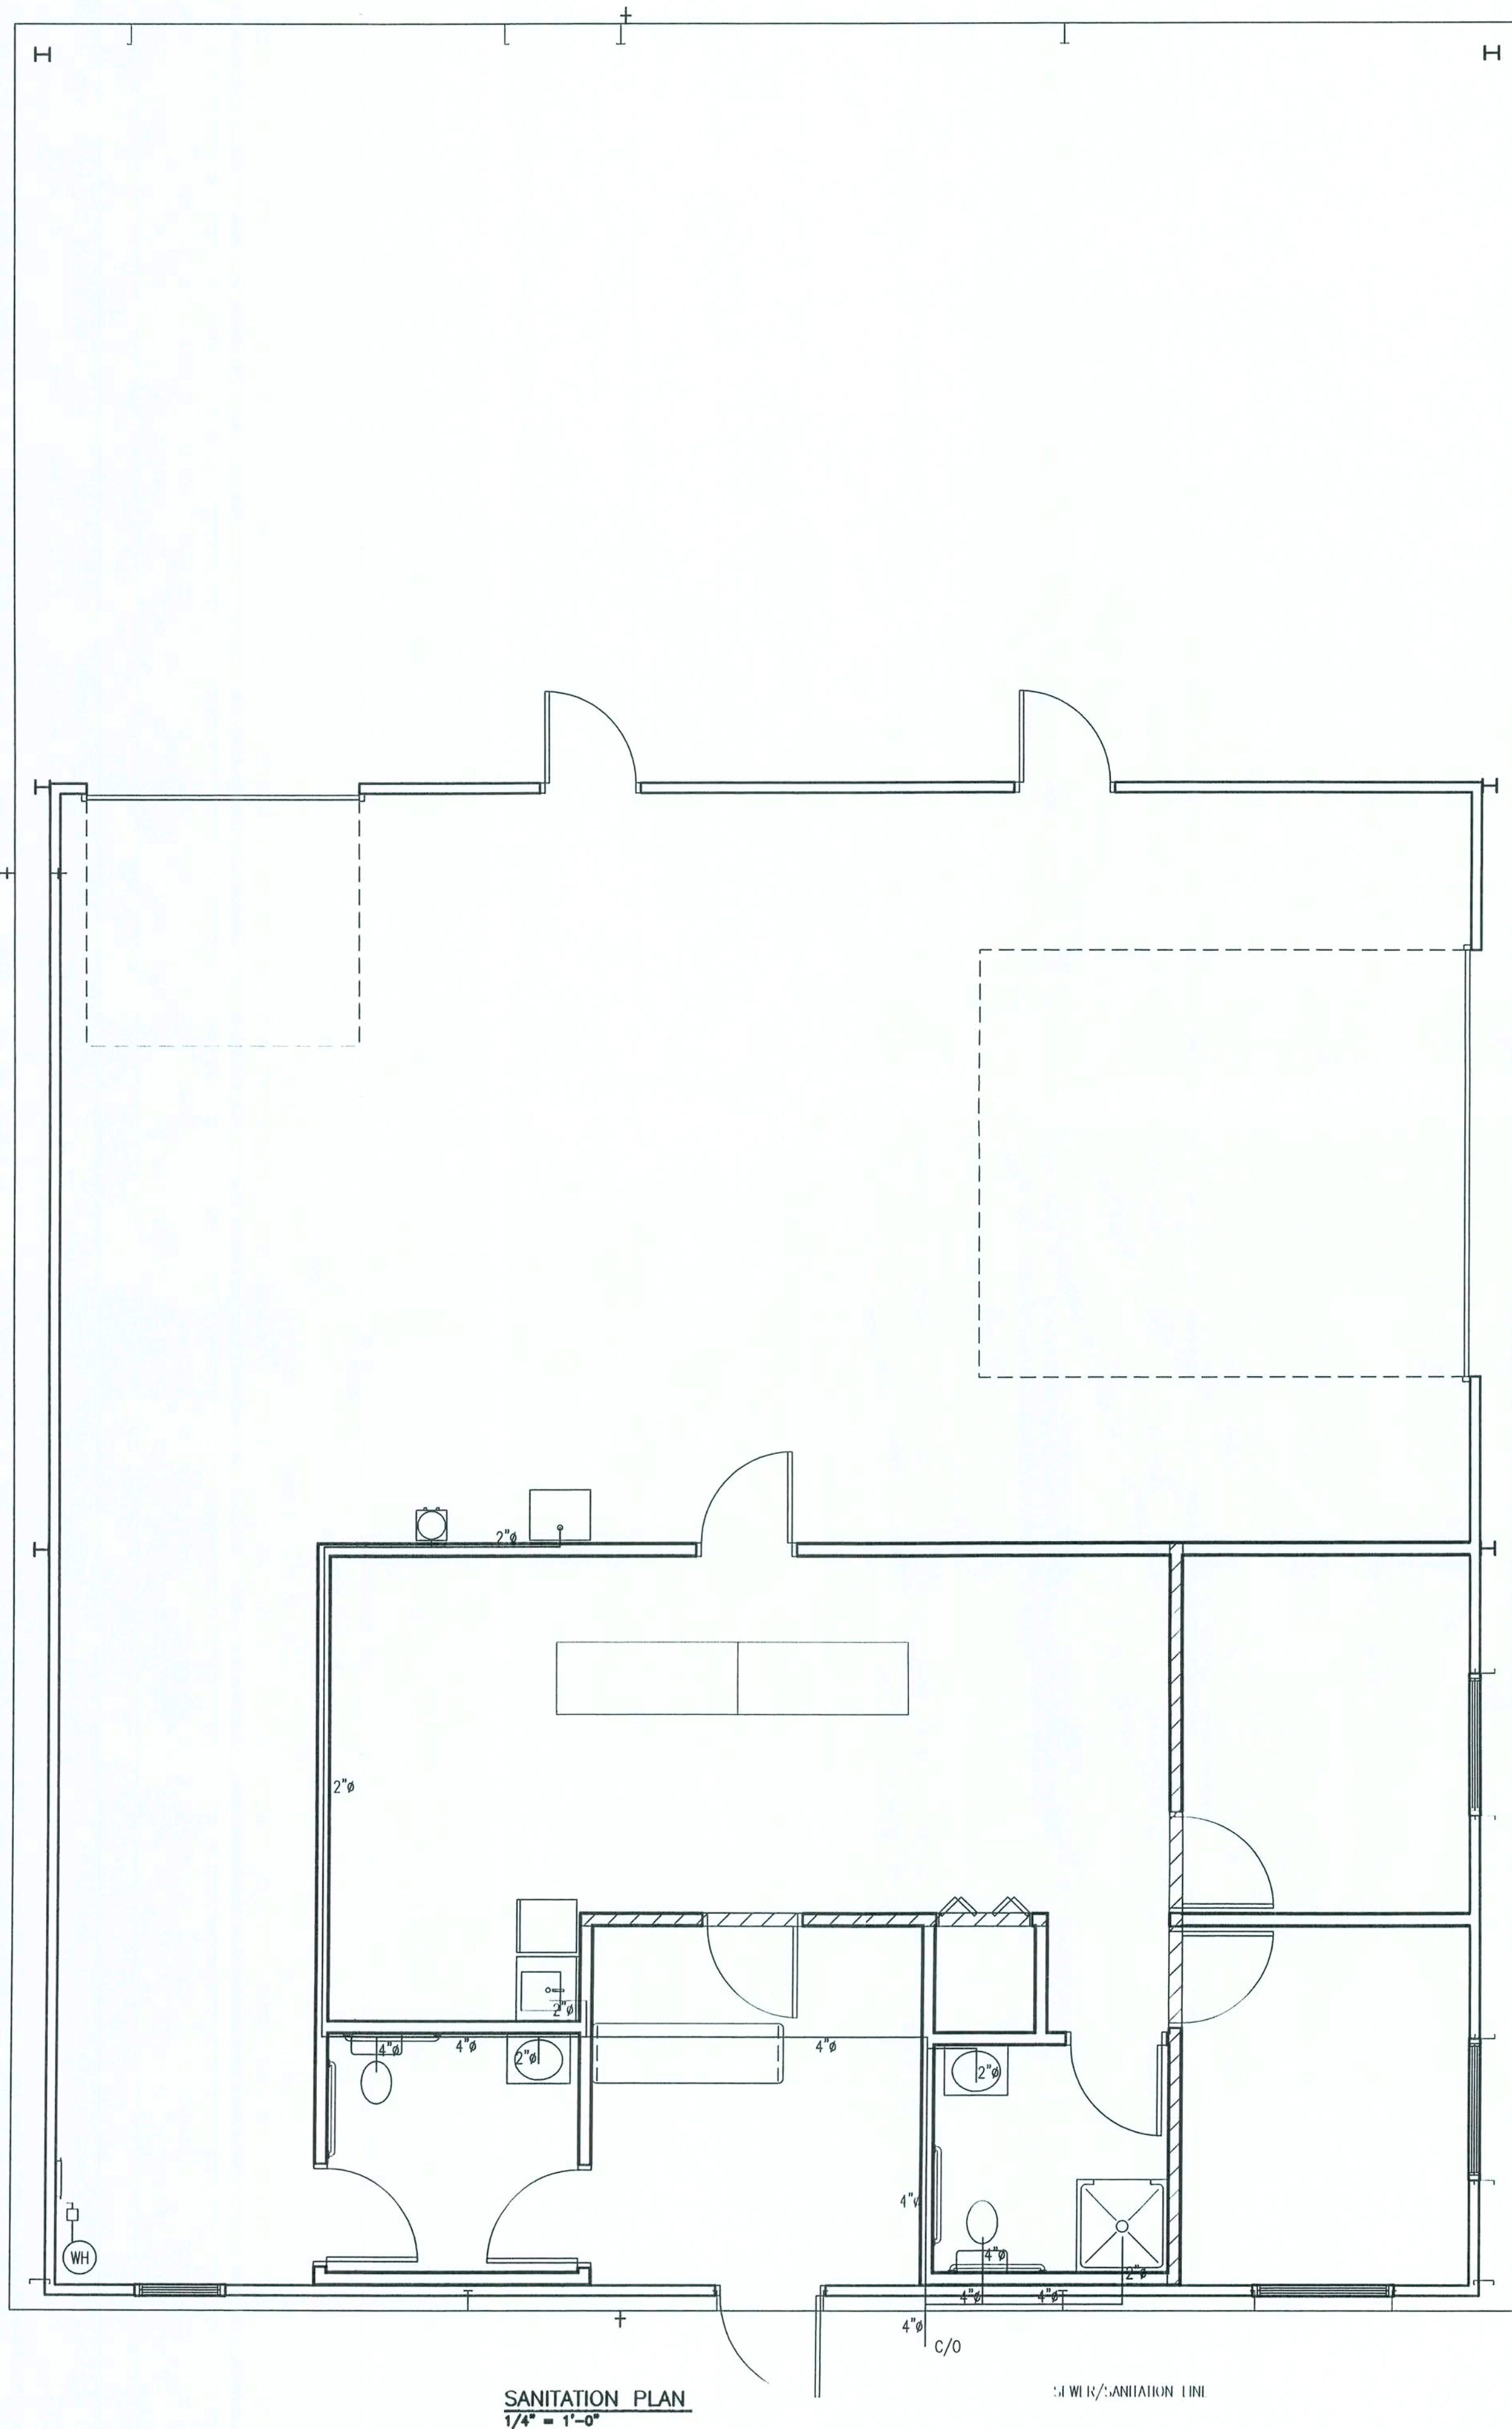


FIXTURES:

F1 = LAVATORY
F2 = WATER CLOSET
F3 = WATER COOLER
F4 = SINK
F5 = SHOWER

NOTES:

1. SOIL PIPING, VENTS, AND STACK TO BE SCH. 40 PVC.
2. ALL AAV (AIR ADMITTANCE VENT) VALVES TO BE ACCESSIBLE IN CABINETS OR BY ACCESS GRILLE FOR MAINTENANCE.
3. ALL WORK TO BE INSPECTED AND TESTED IN ACCORDANCE WITH LOCAL CODES.

— = WASTE
- - - = VENT

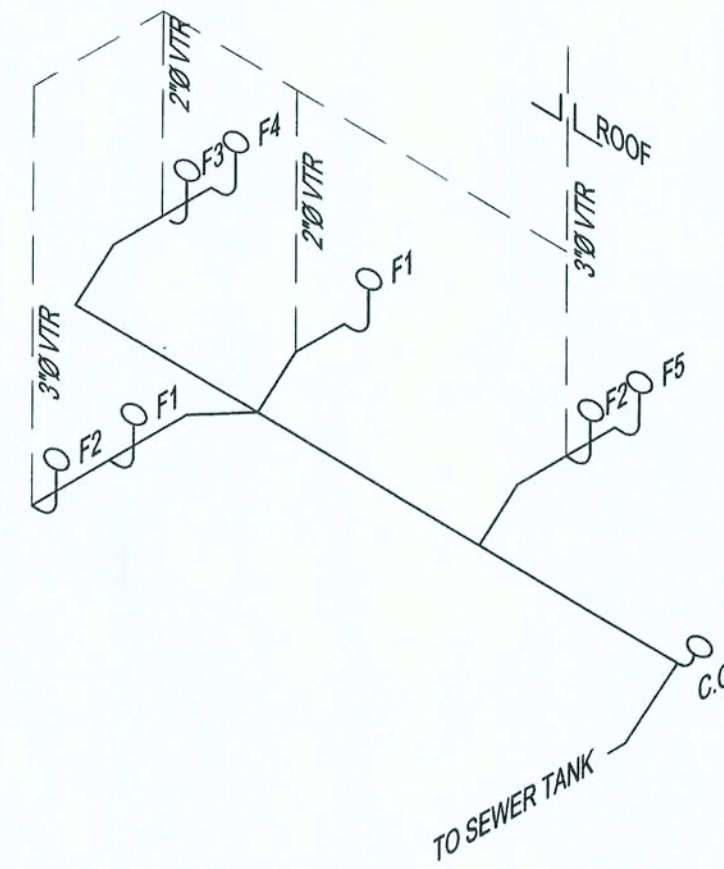

PLUMBING RISER DIAGRAM
SCALE: N.T.S.

1. DRAWINGS ARE DIAGRAMMATIC AND SHALL NOT BE SCALED. REFER TO ARCHITECTURAL PLANS AND ELEVATIONS FOR EXACT LOCATION OF ALL PLUMBING FIXTURES, EQUIPMENT, ETC. PLUMBING CONTRACTOR SHALL FURNISH AND INSTALL ALL ITEMS REQUIRED FOR A COMPLETE AND ACCEPTABLE WORKING INSTALLATION.
2. ALL WORK AND MATERIAL SHALL COMPLY WITH THE NATIONAL, STATE, AND ALL LOCAL CODES AND ORDINANCES HAVING JURISDICTION.
3. THE PLUMBING CONTRACTOR SHALL VISIT THE SITE AND THOROUGHLY FAMILIARIZE HIMSELF WITH ALL EXISTING CONDITIONS. ALL EXECUTION AND BACKFILL AS REQUIRED FOR THIS PHASE OF CONSTRUCTION SHALL BE A PART OF THIS CONTRACT.
4. ALL MATERIAL SHALL BE NEW.
5. ALL WORK SHALL BE PERFORMED BY A LICENSED PLUMBING CONTRACTOR IN A FIRST CLASS WORKMANLIKE MANNER. THE COMPLETED SYSTEM SHALL BE FULLY OPERATIVE AND ACCEPTED BY ENGINEER/ARCHITECT.
6. ALL REQUIRED INSURANCE SHALL BE PROVIDED FOR PROTECTION AGAINST PUBLIC LIABILITY OR PROPERTY DAMAGE FOR THE DURATION OF THE WORK.
7. THE PLUMBING CONTRACTOR SHALL SECURE AND PAY ALL PERMIT FEES, INSPECTIONS, AND TESTS.
8. ALL WORK SHALL BE COORDINATED WITH OTHER TRADES TO AVOID INTERFERENCE WITH THE PROGRESS OF CONSTRUCTION.
9. THE PLUMBING CONTRACTOR SHALL GUARANTEE ALL MATERIAL AND WORKMANSHIP FREE FROM DEFECTS FOR A PERIOD OF NOT LESS THAN (1) ONE YEAR FROM DATE OF ACCEPTANCE. CORRECTION OF ANY DEFECTS SHALL BE COMPLETED WITHOUT ADDITIONAL CHARGES AND SHALL INCLUDE REPLACEMENT OR REPAIR OF ANY OTHER PHASE IN THE INSTALLATION WHICH MAY HAVE BEEN DAMAGED THEREBY.
10. VERIFY LOCATION, SIZE AND DEPTHS OF ALL EXISTING UTILITIES PRIOR TO START OF CONSTRUCTION. ADVISE ENGINEER/ARCHITECT OF ANY DISCREPANCIES.
11. ALL FIXTURES SHALL BE PROVIDED WITH READILY ACCESSIBLE STOPS.
12. WATER PIPING SHALL BE CPVC.
13. SOIL, WASTE, AND VENT PIPING SHALL BE PVC SCHEDULE 40 DMV. WASTE AND VENT PIPING ABOVE SLAB SHALL BE PVC.
14. AIR CONDITIONING CONDENSATE DRAIN PIPING SHALL BE PVC SCHEDULE 40. INSULATE ALL CONDENSATE PIPING EXCEPT EXTERNAL PIPING. ALL PIPING TO BE INSTALLED PER LOCAL CODE.
15. FURNISH AND INSTALL APPROVED AIR CHAMBERS AT EACH PLUMBING FIXTURE AND PDI APPROVED SHOCK ARRESTERS ON MAIN LINE AND RISERS.
16. PROVIDE CHROME PLATED COMBINATION COVERED PLATE AND CLEANOUT PLUG FOR ALL WALL CLEANOUTS, JOSAM #58890.
17. INSULATE LINES AS FOLLOWS:
a. WATER SUPPLY AND RETURNS: 1" THICK ARMAFLEX
b. CONDENSATE DRAIN: 1/2" THICK ARMAFLEX

WATER HEATER
SHALL BE Takagi T-M1, TANKLESS, WITH MAX 225KBTU, WITH 1/2" WATER CONNECTION AND 3/4" GAS CONNECTION. WATER FLOW RATE OF 9.6 GPM.

WC
SHALL BE AN AMERICAN STANDARD MODEL NEW CADET II AQUAMETER 2174.139 ELONGATED TANK 1.6 GPF, VITREOUS CHINA, SIPHON ACTION BOWL, CLOSE-COUPLED TANK, SPEED CONNECT TANK/BOWL COUPLING SYSTEM TOILET AND AN OLSONITE #95 OPEN SEAT LESS COVER.

HC WC
SHALL BE AN AMERICAN STANDARD MODEL NEW CADET II AQUAMETER 2216.143 ELONGATED 18" HIGH, 1.6 GPF, VITREOUS CHINA, SIPHON ACTION BOWL, CLOSE-COUPLED TANK, SPEED CONNECT TANK/BOWL COUPLING SYSTEM TOILET AND AN OLSONITE #95 OPEN SEAT LESS COVER.

KITCHEN SINK
SHALL BE ELKAY LUSTERTONE MODEL DLH-2222-10-C SINGLE BOWL STAINLESS STEEL SELF-RIMMING SINK WITH LK2432 HI-ARC FAUCET TO INCLUDE AN OMNI PRESSURE COMPENSATING 2.0 GPM FLOW RESTRICTOR.

LAV
SHALL BE AN AMERICAN STANDARD MODEL RONDALYN 0491.019 VITREOUS CHINA SELF-RIMMING STYLE CLASSIC ROUND SHAPE, PROVIDE A 5401.152H HERITAGE CENTER SET FAUCET TO INCLUDE AN OMNI PRESSURE COMPENSATING 0.5 GPM FLOW RESTRICTOR

HC LAV
SHALL BE AN AMERICAN STANDARD MODEL RONDALYN 0491.019 VITREOUS CHINA SELF-RIMMING STYLE CLASSIC ROUND SHAPE, PROVIDE A 5401.172H HERITAGE CENTER SET FAUCET WITH 4" WRIST BLADE HANDLES TO INCLUDE AN OMNI PRESSURE COMPENSATING 0.5 GPM FLOW RESTRICTOR AQUASEAL VALVE AND CHROME FINISH, GRIP DRAIN, OFFSET PERFORATED WHEELCHAIR LAVATORY DRAIN ASSEMBLY WITH 1-1/2" TAILPIECE, MCGUIRE #155WC.

EWC
SHALL BE AN OASIS MODEL PLF8WMEE, 8.0 GPM, 4.8 FLA AT 120 VOLT WITH A 1/5 HP COMPRESSOR

HOSE BIBB

SHALL BE A JOSAM 71000-95 SERIES CAST BRONZE BOX TYPE NON-FREEZE VANDAL PROOF WALL HYDRANT WITH COVER AND CONTROL KEY.

- NOTES:
1. ALL PLUMBING FIXTURES SHALL BE AS SPECIFIED OR APPROVED EQUAL.
 2. PROVIDE ANGLE STOPS ON ALL WATER SERVICE LINES TO FIXTURE FOR INDIVIDUAL SHUT-OFF.
 3. ALL HANDICAP PLUMBING FIXTURES SHALL BE INSTALLED PER THE LATEST ADA REQUIREMENTS.

REV #	DATE	REVISION NOTES

P.O. Box 187
130 West Howard Street
Live Oak, FL 32064
Phone: (386) 362-3678
Fax: (386) 362-6133
Auth. # 9461




ACTION SIGN & GRAPHICS
COMMERCIAL SITE
LAKE CITY, FL

SANITATION PLAN


PROJECT NUMBER
PF05-365
DRAWN BY
T.K.
CHECKED BY
G.G.

P-1.0

SHEET ###

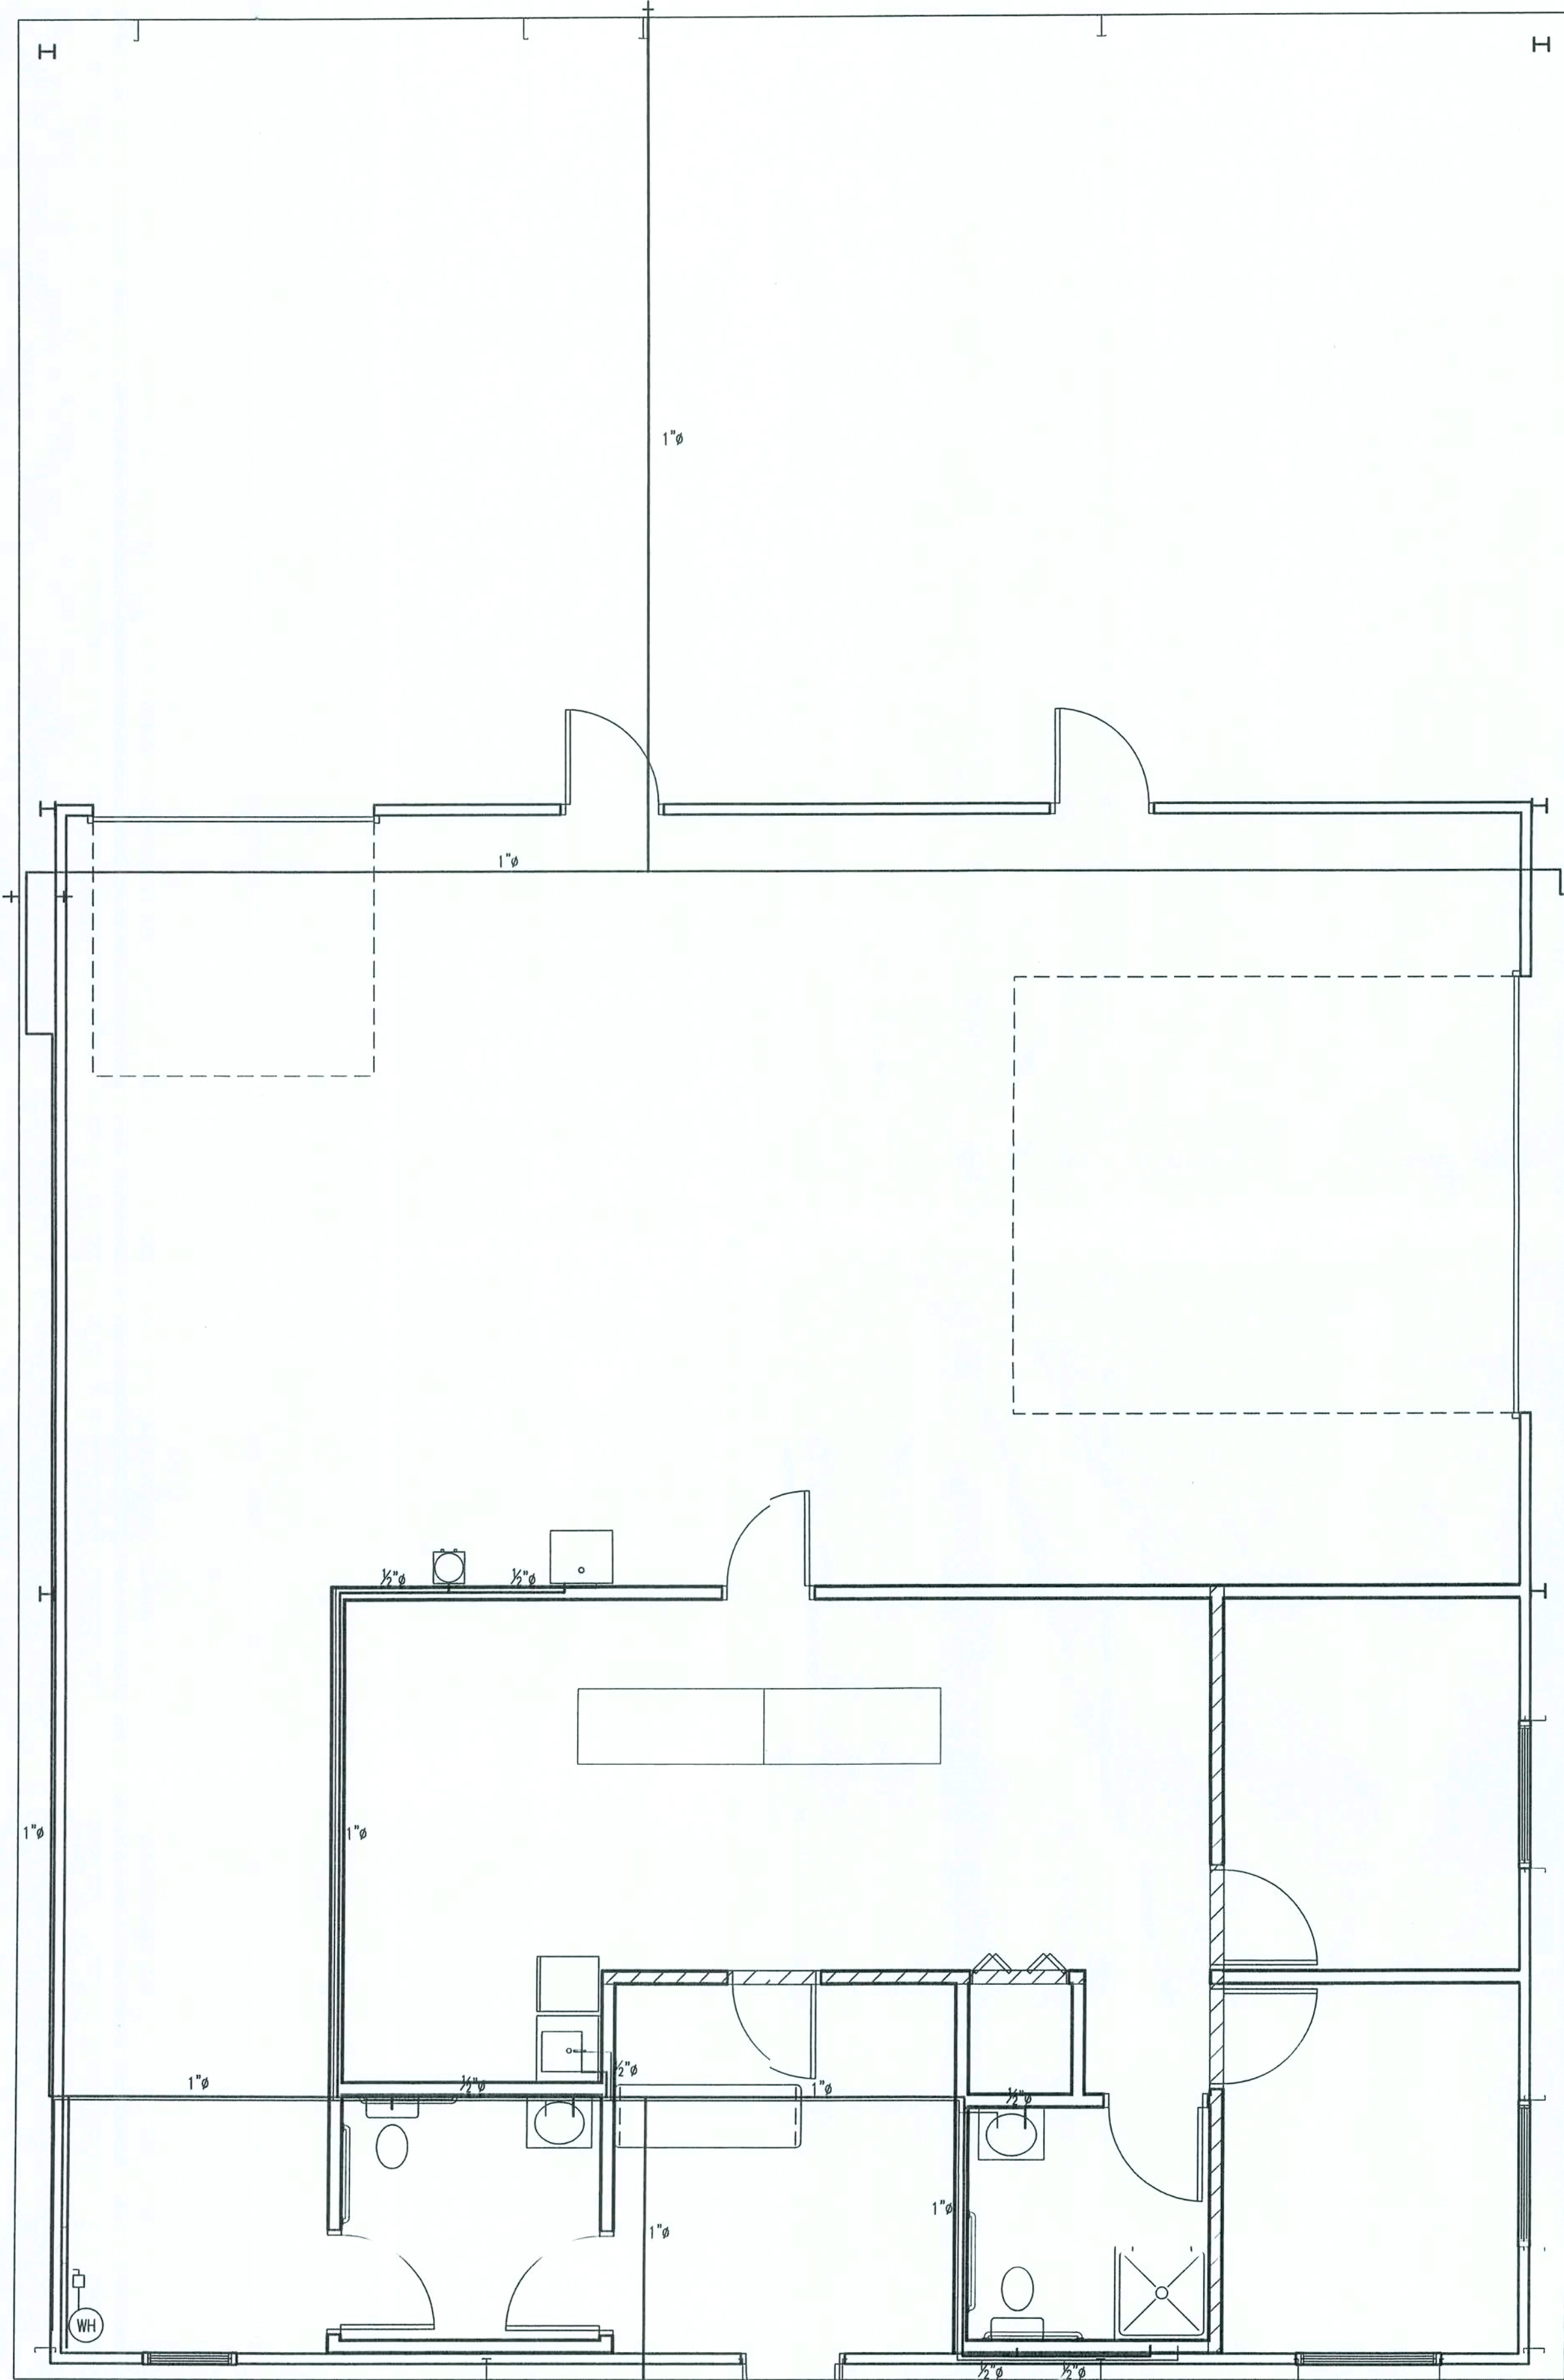

PLUMBING PLAN
1/4" = 1'-0"

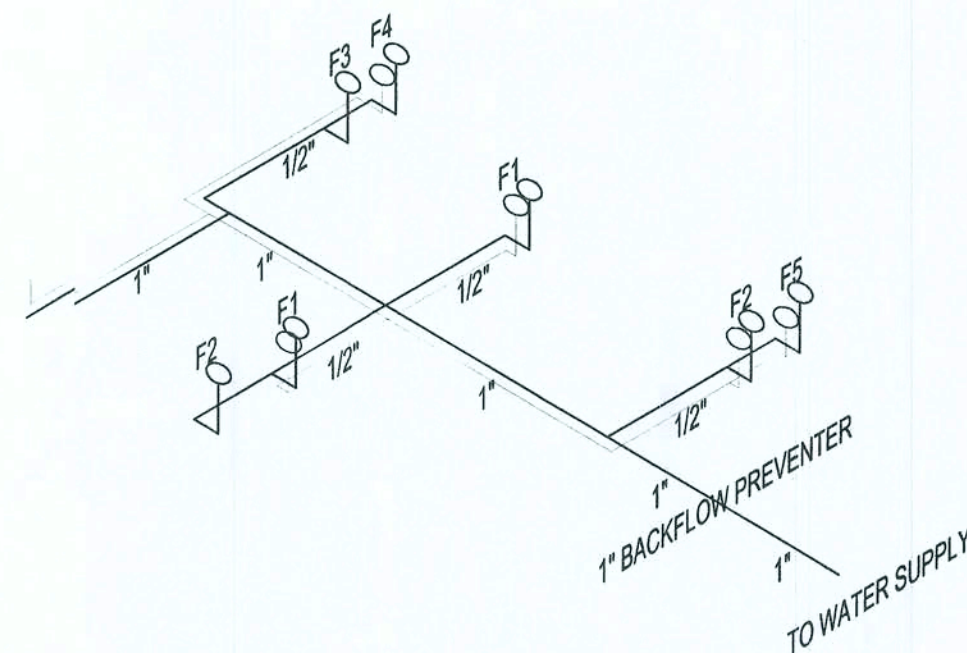

WATER RISER DIAGRAM

SCALE: N.T.S.

FIXTURES:

- F1 = LAVATORY
F2 = WATER CLOSET
F3 = WATER COOLER
F4 = SINK
F5 = SHOWER

NOTES:

1. SOIL PIPING, VENTS, AND STACK TO BE SCH. 40 PVC.
2. ALL AAV (AIR ADMITTANCE VENT) VALVES TO BE ACCESSIBLE IN CABINETS OR BY ACCESS GRILLE FOR MAINTENANCE.
3. ALL WORK TO BE INSPECTED AND TESTED IN ACCORDANCE WITH LOCAL CODES.

1. DRAWINGS ARE DIAGRAMMATIC AND SHALL NOT BE SCALED. REFER TO ARCHITECTURAL PLANS AND ELEVATIONS FOR EXACT LOCATION OF ALL PLUMBING FIXTURES, EQUIPMENT, ETC., PLUMBING CONTRACTOR SHALL FURNISH AND INSTALL ALL ITEMS REQUIRED FOR A COMPLETE AND ACCEPTABLE WORKING INSTALLATION.
2. ALL WORK AND MATERIAL SHALL COMPLY WITH THE NATIONAL, STATE, AND ALL LOCAL CODES AND ORDINANCES HAVING JURISDICTION.
3. THE PLUMBING CONTRACTOR SHALL VISIT THE SITE AND THOROUGHLY FAMILIARIZE HIMSELF WITH ALL EXISTING CONDITIONS. ALL EXECUTION AND BACKFILL AS REQUIRED FOR THIS PHASE OF CONSTRUCTION SHALL BE A PART OF THIS CONTRACT.
4. ALL MATERIAL SHALL BE NEW.
5. ALL WORK SHALL BE PERFORMED BY A LICENSED PLUMBING CONTRACTOR IN A FIRST CLASS WORKMANLIKE MANNER. THE COMPLETED SYSTEM SHALL BE FULLY OPERATIVE AND ACCEPTED BY ENGINEER/ARCHITECT.
6. ALL REQUIRED INSURANCE SHALL BE PROVIDED FOR PROTECTION AGAINST PUBLIC LIABILITY OR PROPERTY DAMAGE FOR THE DURATION OF THE WORK.
7. THE PLUMBING CONTRACTOR SHALL SECURE AND PAY ALL PERMIT FEES, INSPECTIONS, AND TESTS.
8. ALL WORK SHALL BE COORDINATED WITH OTHER TRADES TO AVOID INTERFERENCE WITH THE PROGRESS OF CONSTRUCTION.
9. THE PLUMBING CONTRACTOR SHALL GUARANTEE ALL MATERIAL AND WORKMANSHIP FREE FROM DEFECTS FOR A PERIOD OF NOT LESS THAN (1) ONE YEAR FROM DATE OF ACCEPTANCE. CORRECTION OF ANY DEFECTS SHALL BE COMPLETED WITHOUT ADDITIONAL CHARGES AND SHALL INCLUDE REPLACEMENT OR REPAIR OF ANY OTHER PHASE IN THE INSTALLATION WHICH MAY HAVE BEEN DAMAGED THEREBY.
10. VERIFY LOCATION, SIZE AND INVERTS OF ALL EXISTING UTILITIES PRIOR TO START OF CONSTRUCTION. ADVISE ENGINEER/ARCHITECT OF ANY DISCREPANCIES.
11. ALL FIXTURES SHALL BE PROVIDED WITH READILY ACCESSIBLE STOPS.
12. WATER PIPING SHALL BE CPVC.
13. SOIL, WASTE, AND VENT PIPING SHALL BE PVC SCHEDULE 40 DMV. WASTE AND VENT PIPING ABOVE SLAB SHALL BE PVC.
14. AIR CONDITIONING CONDENSATE DRAIN PIPING SHALL BE PVC SCHEDULE 40. INSULATE ALL CONDENSATE PIPING EXCEPT EXTERNAL PIPING. ALL PIPING TO BE INSTALLED PER LOCAL CODE.
15. FURNISH AND INSTALL APPROVED AIR CHAMBERS AT EACH PLUMBING FIXTURE AND PDI APPROVED SHOCK ARRESTERS ON MAIN LINE AND RISERS.
16. PROVIDE CHROME PLATED COMBINATION COVERED PLATE AND CLEANOUT PLUG FOR ALL WALL CLEANOUTS, JOSAM #58890.
17. INSULATE LINES AS FOLLOWS:
 - a. WATER SUPPLY AND RETURNS: 1" THICK ARMAFLEX
 - b. CONDENSATE DRAIN: 1/2" THICK ARMAFLEX

WATER HEATER
SHALL BE Takagi T-M1, TANKLESS, WITH MAX 225KBTU, WITH 3/4" WATER CONNECTION AND 1/2" GAS CONNECTION. WATER FLOW RATE OF 9.6 GPM.

WVC
SHALL BE AN AMERICAN STANDARD MODEL NEW CADET II AQUAMETER 2174, 139 ELONGATED TANK 1.6 GPF, VITREOUS CHINA, SIPHON ACTION BOWL, CLOSE-COUPLED TANK, SPEED CONNECT TANK/BOWL COUPLING SYSTEM TOILET AND AN OLSONITE #95 OPEN SEAT LESS COVER.

HC WC
SHALL BE AN AMERICAN STANDARD MODEL NEW CADET II AQUAMETER 2218, 143 ELONGATED 18" HIGH, 1.6 GPF, VITREOUS CHINA, SIPHON ACTION BOWL, CLOSE-COUPLED TANK, SPEED CONNECT TANK/BOWL COUPLING SYSTEM TOILET AND AN OLSONITE #95 OPEN SEAT LESS COVER.

KITCHEN SINK
SHALL BE ELKAY LUSTERTONE MODEL DLH-2222-10-C SINGLE BOWL, STAINLESS STEEL
SELF-RIMMING SINK WITH LK2432 HI-ARC FAUCET TO INCLUDE AN OMNI PRESSURE COMPENSATING 2.0 GPM FLOW RESTRICTOR.

JANITOR SINK
SHALL BE AN AMERICAN STANDARD MODEL FLORWELL 7740.020 ENAMELED CAST IRON SERVICE SINK WITH 7745.011 REMOVABLE VINYL-COATED RIM GUARD, 7721.038 DRAIN WITH STRAINER AND 77298.152 HERITAGE SERVICE SINK FITTING FAUCET TO INCLUDE AN OMNI PRESSURE COMPENSATING VANDAL RESISTANT 2.0 GPM FLOW RESTRICTOR WITH BUCKET HOOKS.

LAV
SHALL BE AN AMERICAN STANDARD MODEL RONDALYN 0491.019 VITREOUS CHINA SELF-RIMMING STYLE CLASSIC ROUND SHAPE. PROVIDE A 5401.152H HERITAGE CENTER SET FAUCET TO INCLUDE AN OMNI PRESSURE COMPENSATING 0.5 GPM FLOW RESTRICTOR.

HC LAV
SHALL BE AN AMERICAN STANDARD MODEL RONDALYN 0491.019 VITREOUS CHINA SELF-RIMMING STYLE CLASSIC ROUND SHAPE. PROVIDE A 5401.172H HERITAGE CENTER SET FAUCET WITH 4" WRIST BLADE HANDLES TO INCLUDE AN OMNI PRESSURE COMPENSATING 0.5 GPM FLOW RESTRICTOR
AQUASEAL VALVE AND CHROME FINISH, GRIP DRAIN, OFFSET PERFORATED WHEELCHAIR LAVATORY DRAIN ASSEMBLY WITH 1-1/2" TAILPIECE. MCGUIRE #155WC.

FEWC
SHALL BE AN OASIS MODEL PLI BWMLC, 8.0 GPM, 4.8 FLA AT 120 VOLT WITH A 1/5 HP COMPRESSOR

HOSE BIBB

SHALL BE A JOSAM 71000-95 SERIES CAST BRONZE BOX TYPE NON-FREEZE VANDAL PROOF WALL HYDRANT WITH COVER AND CONTROL KEY.

NOTES:

1. ALL PLUMBING FIXTURES SHALL BE AS SPECIFIED OR APPROVED EQUAL.
2. PROVIDE ANGLE STOPS ON ALL WATER SERVICE LINES TO FIXTURE FOR INDIVIDUAL SHUT OFF.
3. ALL HANDICAP PLUMBING FIXTURES SHALL BE INSTALLED PER THE LATEST ADA REQUIREMENTS.

— = WASTE
- - - = VENT

REVISION NOTES	
REV #	DATE

P.O. Box 187
130 West Howard Street
Live Oak, FL 32064
Phone: (386) 362-3678
Fax: (386) 362-6133
GARY GILL, P.E.
STRUCTURAL/CIVIL ENGINEER
Auth. # 9461








ACTION SIGN & GRAPHICS
COMMERCIAL SITE
LAKE CITY, FL

PLUMBING PLAN

PROJECT NUMBER
PF05-365
DRAWN BY
T.K.
CHECKED BY
G.G.

P-2.0

SHEET ###

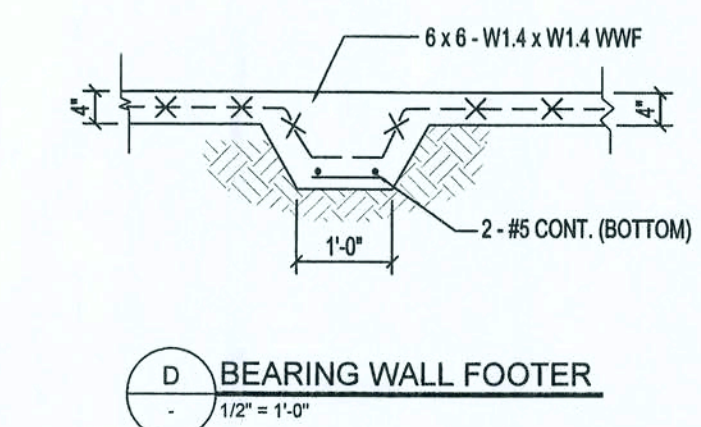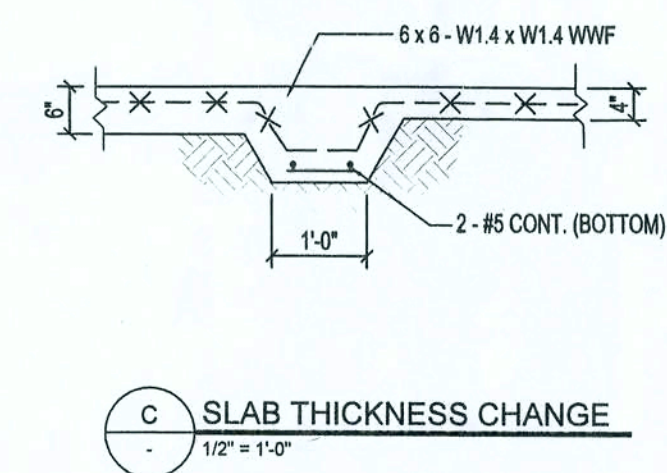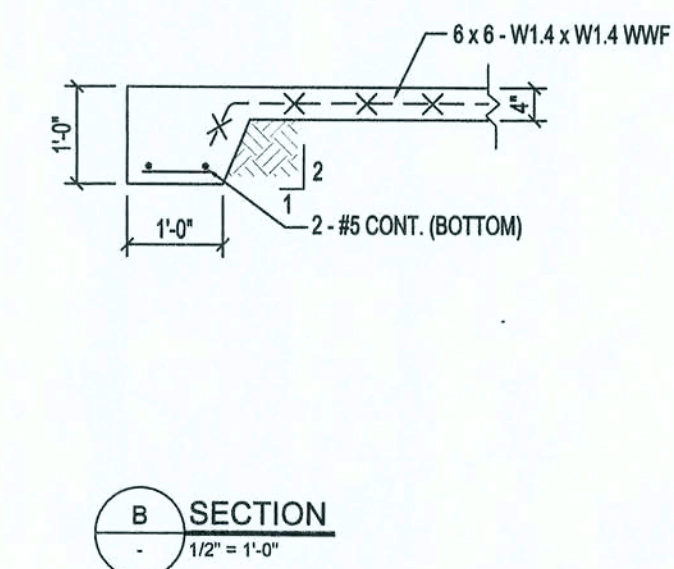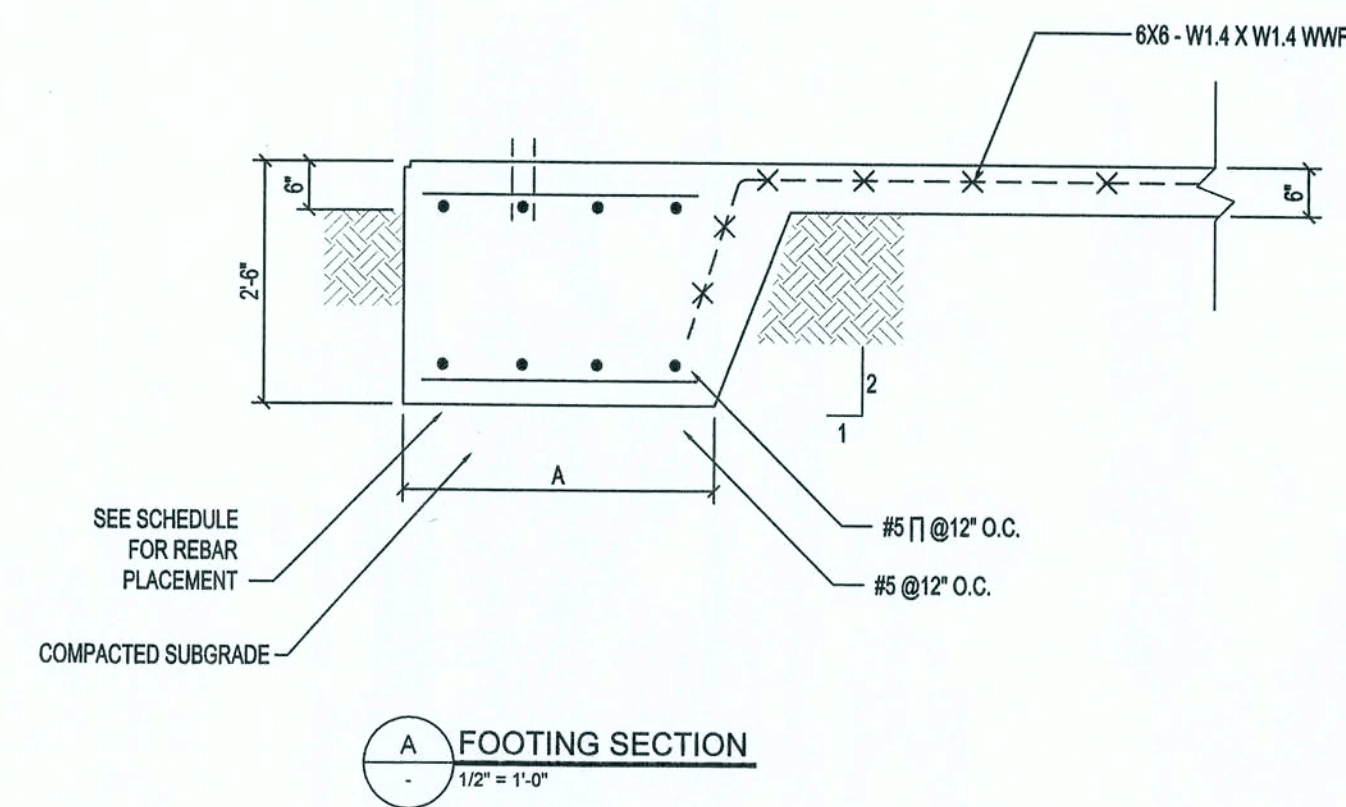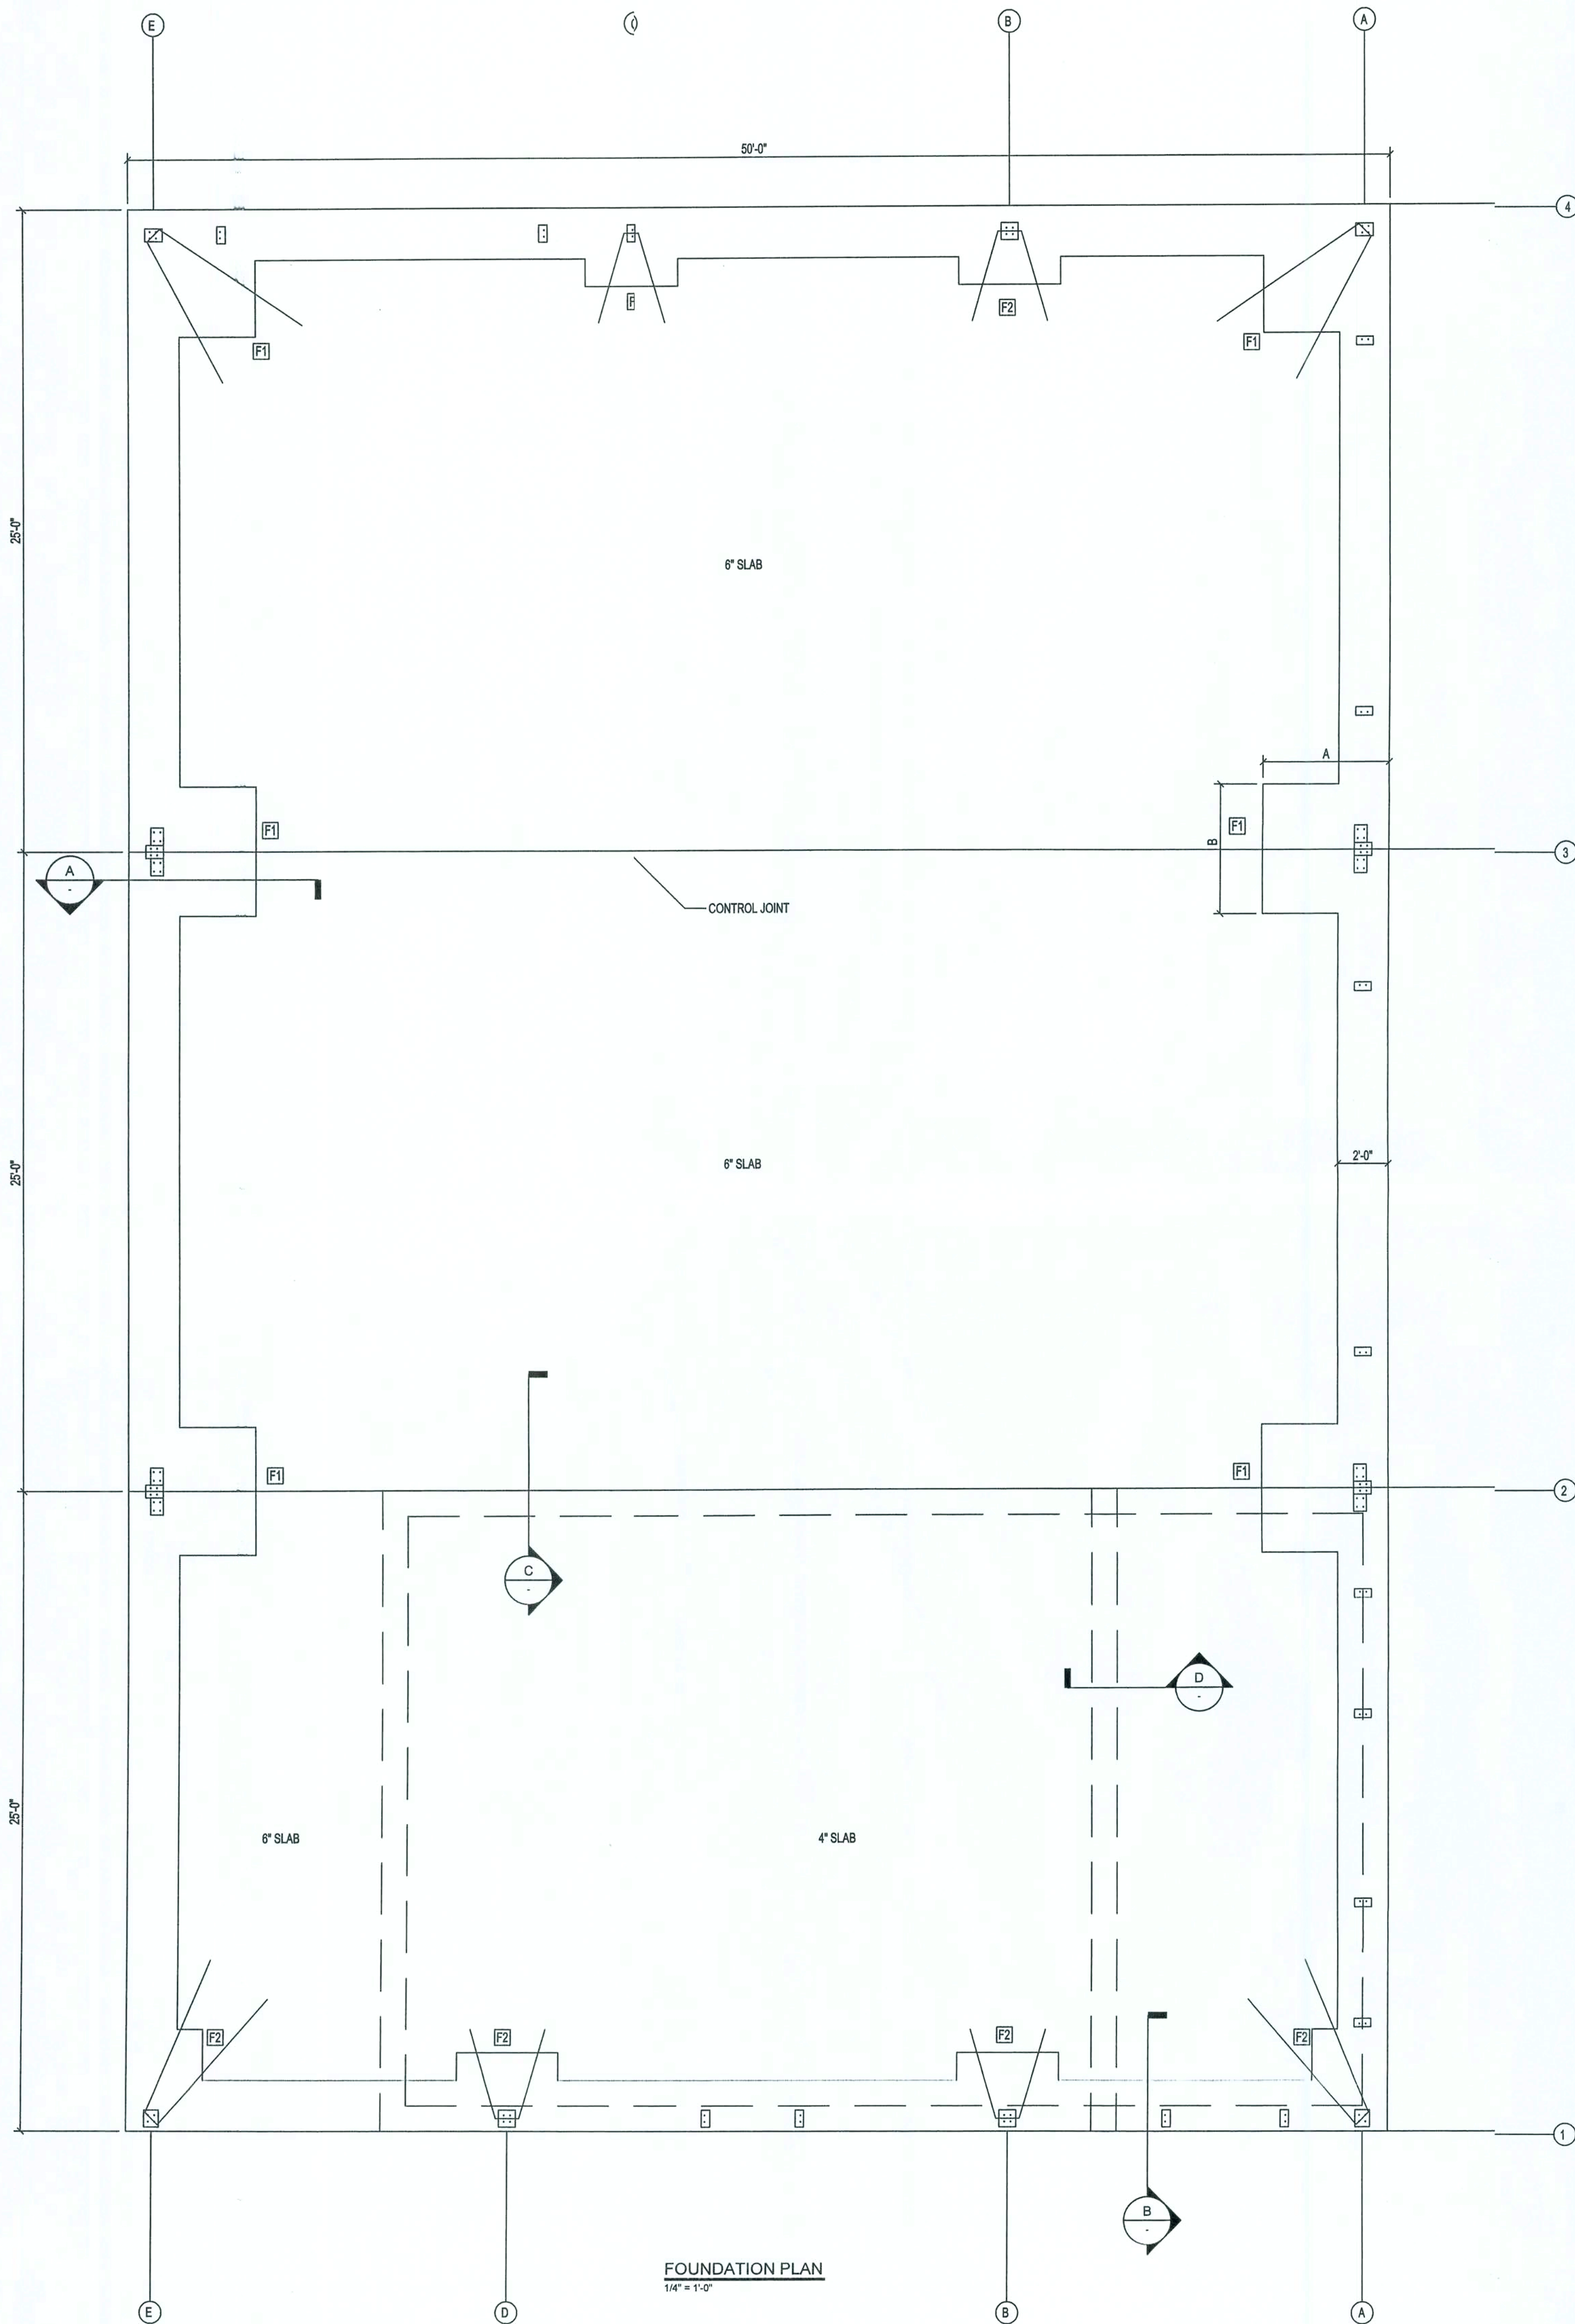

FOOTING SCHEDULE					
I.D.	A	B	C	BOTTOM REBAR	TOP REBAR
F1	5'-0"	5'-0"	2'-6"	5-#5 E.W.	5-#5 E.W.
F2	4'-0"	3'-0"	2'-6"	4-#5 E.W.	4-#5 E.W.

REV #	DATE	REVISION	NOTES

P.O. Box 187
 130 West Howard Street
 Live Oak FL 32064
 Phone: (386) 362-3678
 Fax: (386) 362-6133
 Auth. # 9461

ACTION SIGN & GRAPHICS
COMMERCIAL SITE
LAKE CITY, FL

FOUNDATION PLAN

PROJECT NUMBER
 PF05-365
 DRAWN BY
 T.K.
 CHECKED BY
 G.G.

S-1.0

SHEET ###

DESIGN CRITERIA

DESIGN PER 2004 FLORIDA BUILDING CODE, UNLESS OTHERWISE NOTED.

LIVE LOADS:	
ROOFS AND CANOPIES:	0 TO 200 SF16PSF
	201 TO 600 SF14PSF
	OVER 600 SF12PSF
STAIRS.....	100PSF
FLOORS.....	50PSF
CORRIDORS.....	80PSF
LOBBIES.....	80PSF
BALCONIES.....	60PSF
PARTITION LOAD (DEAD LOAD).....	20PSF

WIND LOADS:	
BASIC WIND SPEED: (ASCE 7).....	110 MPH
MEAN ROOF HEIGHT.....	21 FT
WIND IMPORTANCE FACTOR (CATEGORY II).....	1.0
WIND EXPOSURE.....	B
ENCLOSURE CLASSIFICATION.....	ENCLOSED
INTERNAL PRESSURE COEFFICIENT.....	±0.18
DIRECTIONALITY FACTOR (Kd).....	0.85
SHAPE FACTORS.....	PER CODE

THIS BUILDING IS NOT LOCATED IN THE WIND BORNE DEBRIS REGION. IMPACT RESISTANT GLAZING IS NOT REQUIRED.

DESIGN WIND PRESSURES FOR COMPONENTS & CLADDING:		
WALLS & WALL OPENINGS		
TRIBUTARY AREA	INTERIOR ZONE (> 6.3 ft FROM BLDG. CORNER)	END ZONE (< 6.3 ft FROM BLDG. CORNER)
10 sf	-23.61 / 21.7	-29.2 / 21.77
25 sf	-22.31 / 20.5	-26.55 / 20.5
(LINEARLY INTERPOLATE BETWEEN STATED VALUES)		

ROOFS & ROOF OPENINGS		
TRIBUTARY AREA	INTERIOR ZONE (> 6.3 ft FROM BLDG. CORNER)	END ZONE (< 6.3 ft FROM BLDG. CORNER)
10 sf	-21.77 / 19.92	-25.46 / 19.92
25 sf	-20.30 / 19.19	-23.99 / 19.19
(LINEARLY INTERPOLATE BETWEEN STATED VALUES)		

CONCRETE (DESIGN PER CURRENT EDITION ACI 318)	
SLAB ON GRADE.....	.F'C= 4000 PSI
FOOTINGS.....	.F'C= 3000 PSI
ALL OTHER CONCRETE.....	
.F'C= 3000 PSI	

ALL REINFORCING STEEL ASTM A615 GRADE 60

ALL WELDED WIRE FABRIC ASTM A165

CONCRETE MASONRY (DESIGN PER CURRENT EDITION ACI 530)	
COMPRESSIVE STRENGTH.....	.F'm= 1500 PSI

STRUCTURAL STEEL (DESIGN PER CURRENT EDITION AISC), UNLESS OTHERWISE NOTED MATERIALS SHALL BE AS FOLLOWS:

W-SHAPES.....	ASTM 992, Fy=50 KSI
OTHER SHAPES & PLATES.....	ASTM A36, Fy=36 KSI
HSS SQUARE & RECTANGULAR SHAPES.....	ASTM A500 GRADE B, Fy= 46 KSI
HSS ROUND SHAPES.....	ASTM A500 GRADE B, Fy= 42 KSI
STEEL PIPES.....	ASTM A53 GRADE B, Fy= 35 KSI
WELDING ELECTRODES.....	AWS A5.1 OR A5.5 SERIES E70
HIGH-STRENGTH BOLTS.....	¾"Ø ASTM A325
ANCHOR RODS.....	GRADE 36 ASTM F1554
WELDED STUDS.....	ASTM A108
DEFORMED BARS.....	ASTM A496
PAINT & PROTECTION.....	SSPC PAINT 25

SOIL BEARING (DESIGN MAXIMUM).....	REFER TO GEOTECHNICAL REPORT FOR ALLOWABLE BEARING PRESSURE
------------------------------------	---

GENERAL NOTES

CONCRETE

UNLESS OTHERWISE NOTED ON THE DRAWINGS, MINIMUM COVER FOR REINFORCING SHALL BE AS FOLLOWS:

FOOTINGS.....	3"
PILE CAPS.....	SEE TYPICAL DETAIL
GRADE BEAMS.....	3"
COLUMNS AND PEDESTALS (OVER VERTICAL REINF).....	2"
SLABS AND WALLS (EXPOSED TO EARTH, LIQUID OR WEATHER).....	2"
SLABS AND WALLS (NOT EXPOSED TO EARTH, LIQUID OR WEATHER).....	¾"
CANOPY SLABS.....	1 ½"
BEAMS (OVER MAIN REINFORCING).....	1 ½"
SLAB ON GRADE.....	4"

ALL REINFORCING SHALL BE HELD SECURELY IN POSITION WITH STANDARD ACCESSORIES IN CONFORMANCE WITH CRSI MANUAL OF STANDARD PRACTICE AND ACI 315 DURING THE PLACEMENT OF CONCRETE.

UNLESS OTHERWISE NOTED, SPLICES IN REINFORCING, WHERE PERMITTED, SHALL BE AS FOLLOWS:
WELDED WIRE FABRIC.....WIRE SPACING PLUS 6"
REINFORCING BARS.....40 BAR DIAMETERS

ALL HOOKS IN REINFORCING BARS SHALL BE AN ACI STANDARD HOOK, UNLESS OTHERWISE NOTED.

FOUNDATIONS

IF FOOTING EVALUATIONS SHOWN OCCUR IN A DISTURBED, UNSTABLE, OR UNSUITABLE SOIL, THE ENGINEER SHALL BE NOTIFIED.

STEPS IN WALL FOOTINGS SHALL NOT EXCEED A SLOPE OF (1) VERTICAL TO TWO (2) HORIZONTAL

PROVIDE A MINIMUM OF TWO #4 BARS IN TOP OF CONTINUOUS WALL FOOTINGS AT DOOR AND OTHER OPENINGS.
4'-0" LONGER THAN THE OPENING.

TERMITE PROTECTION NOTES:

SOIL CHEMICAL BARRIER METHOD:

1. A PERMANENT SIGN WHICH IDENTIFIES THE TERMITE TREATMENT PROVIDER AND NEED FOR REINSPECTION AND TREATMENT CONTRACT RENEWAL SHALL BE PROVIDED. THE SIGN SHALL BE POSTED NEAR THE WATER HEATER OR ELECTRIC PANEL. FBC 104.2.6

2. CONDENSATE AND ROOF DOWNSPOUTS SHALL DISCHARGE AT LEAST 1'-0" AWAY FROM BUILDING SIDE WALLS. FBC 1503.4.4

3. IRRIGATION/SPRINKLER SYSTEMS INCLUDING ALL RISERS AND SPRAY HEADS SHALL NOT BE INSTALLED WITHIN 1'-0" FROM BUILDING SIDE WALLS. FBC 1503.4.4

4. TO PROVIDE FOR INSPECTION FOR TERMITE INFESTATION, BETWEEN WALL COVERINGS AND FINAL EARTH GRADE SHALL NOT BE LESS THAN 6". EXCEPTION: PAINT AND DECORATIVE CEMENTIOUS FINISH LESS THAN 5/8" THICK ADHERED DIRECTLY TO THE FOUNDATION WALL. FBC 1403.1.6

5. INITIAL TREATMENT SHALL BE DONE AFTER ALL EXCAVATION AND BACKFILL IS COMPLETE. FBC 1816.1.1

6. SOIL DISTURBED AFTER THE INITIAL TREATMENT SHALL BE RETREATED INCLUDING SPACES BOXED OR FORMED. FBC 1816.1.2

7. BOXED AREAS IN CONCRETE FLOOR FOR SUBSEQUENT INSTALLATION OF TRAPS, ETC., SHALL BE MADE WITH PERMANENT METAL OR PLASTIC FORMS. PERMANENT FORMS MUST BE OF A SIZE AND DEPTH THAT WILL ELIMINATE THE DISTURBANCE OF SOIL AFTER THE INITIAL TREATMENT. FBC 1816.1.3

8. MINIMUM 6 MIL VAPOR RETARDER MUST BE INSTALLED TO PROTECT AGAINST RAINFALL DILUTION. IF RAINFALL OCCURS BEFORE VAPOR RET- ARDER PLACEMENT, RETREATMENT IS REQUIRED. FBC 1816.1.4

9. CONCRETE OVERPOUR AND MORTAR ALONG THE FOUNDATION PERIMETER MUST BE REMOVED BEFORE EXTERIOR SOIL TREATMENT. FBC 1816.1.5

10. SOIL TREATMENT MUST BE APPLIED UNDER ALL EXTERIOR CONCRETE OR GRADE WITHIN 1'-0" OF THE STRUCTURE SIDEWALLS. FBC 1816.1.6

11. AN EXTERIOR VERTICAL CHEMICAL BARRIER MUST BE INSTALLED AFTER CONSTRUCTION IS COMPLETE INCLUDING LANDSCAPING AND IRRIGATION. ANY SOIL DISTURBED AFTER THE VERTICAL BARRIER IS APPLIED, SHALL BE RETREATED. FBC 1816.1.6

12. ALL BUILDINGS ARE REQUIRED TO HAVE PER-CONSTRUCTION TREATMENT. FBC 1816.1.7

13. A CERTIFICATE OF COMPLIANCE MUST BE ISSUED TO THE BUILDING DEPART- MENT BY # LICENSED PEST CONTROL COMPANY BEFORE A CERTIFICATE OF OCCUPANCY WILL BE ISSUED. THE CERTIFICATE OF COMPLIANCE SHALL STATE: "THE BUILDING HAS RECEIVED A COMPLETE TREATMENT FOR THE PREVENTION OF SUBTERRANEAN TERMITES. THE TREATMENT IS IN ACCORDANCE WITH THE RULES AND LAWS OF THE FLORIDA DEPARTMENT OF AGRICULTURE AND CONSUMER SERVICES". FBC 1816.1.7

14. AFTER ALL WORK IS COMPLETED, LOOSE WOOD AND FILL MUST BE REMOVED FROM BELOW AND WITHIN 1'-0" OF THE BUILDING. THIS INCLUDES ALL GRADE STAKES, TUB TRAP BOXES, FORMS, SHORING OR OTHER CELLULOSE CONTAINING MATERIAL. FBC 2303.1.3

15. NO WOOD, VEGETATION, STUMPS, CARDBOARD, TRASH, ETC., SHALL BE BURIED WITHIN 15'-0" OF ANY BUILDING OR PROPOSED BUILDING. FBC 2303.1.4

REVISION NOTES

REV#	DATE	DESCRIPTION
0	03/15/06	

P.O. Box 187
130 West Howard Street
Tampa, FL 33606
Phone: (813) 302-3678
Fax: (813) 302-6133
Auth: # 9461



ACTION SIGN & GRAPHICS
NEW CONSTRUCTION
COLUMBIA COUNTY

GENERAL NOTES

PROJECT NUMBER	PF05-365
DRAWN BY	T.K.
CHECKED BY	G.G.
SHEET NUMBER	S-2