APPLICANT BOBBY BOWLES	
	PHON1 606,875,4402
ADDRESS 525 SW BIRLEY AVE	LAKE CITY 11 32024
OWNER BOBBY & CINDY BOWLES	PHONE 60.875 4402
ADDRESS 525 SW BIRLEY AVE	LAKECHY FL 32024
CONTRACTOR BOBBY & CINDY BOWLES	PHONE 606.876,4402
	ASEMEN JUST PAST COMMUNITY
CENTER, FOLLO BACK TO I	
	6360 A 750 A 75 A 75 A 75 A 75 A 75 A 75 A
THE TENTON	ROOF-PHCH 3'12 HOOR CONC
Minimum Set Back Requirments: STREET-TRONT 30,0	00 REAR 25,00 SIDI 25,00
NO. EX.D.U. 21 FLOOD ZONE X	DEVELOPMENT PERMIT NO.
PARCEL ID 32-38-16-02420-007 SUBDIVIS	ION
LOT BLOCK PHASE UNIT	TOTAL ACRES 10.00
OWNLRS	10 11 0
Culvert Permit No. Culvert Waiver Contractor's License N	umber Applicant Owner Contractor
EXISTING 19-0344 LH	TC Applicant Owner Contractor
	cked by Approved for Issuance New Resident Time STUP No
COMMENTS: NON-HABITABLE STRUCTURE.	and the second s
	Check # or Cash 2034
FOR BUILDING & ZON	ING DEPARTMENT ONLY
· ··· Doil Dillo & Lote	
	Hould Man
	Monolithic Lives In the Control of t
Temporary Power I oundation date lapp, by	Monolithic date app, by date app, by
Temporary Power I oundation date app. by Under slab rough-in plumbing Slab	Monolithic Lives In the Control of t
Temporary Power Toundation date/app. by Under slab rough-in plumbing date/app. by Framing Insulation	Monolithic date app, by Sheathing Nailing date app, by date app, by date app, l
Temporary Power Toundation date app. by Under slab rough-in plumbing Slab date app. by Framing Insulation date app. by	Monolithic date app, by Sheathing Nailing date app, by date app, by Jate app, by
Temporary Power I oundation date/app. by Under slab rough-in plumbing Slab date/app. by Framing Insulation	Monolithic date app, by Sheathing Nailing date app, by date app, by Lifectrical rough-in
Temporary Power Toundation date/app. by Under slab rough-in plumbing Slab date/app. by Insulation	Monolithic date app, by Sheathing Nailing date app, by Jate app, by Lifectrical rough-in date app, by date app, by
Temporary Power Toundation date app, by Under slab rough-in plumbing Slab date app, by Framing Insulation date app, by Rough-in plumbing above slab and below wood floor	Monolithic Monolithic
Temporary Power Toundation date app. by Under slab rough-in plumbing Slab Framing date app. by Rough-in plumbing above slab and below wood floor Heat & Air Duct Peri, beam (Lindate app. by Permanent power C.O. Final	Monolithic Monolithic
Temporary Power Foundation	Monolithic Monolithic
Temporary Power Foundation	Monolithic Monolithic
Temporary Power I oundation date/app. by Under slab rough-in plumbing Slab Framing date/app. by Rough-in plumbing above slab and below wood floor Heat & Air Duct Peri, beam (Lindate/app. by Permanent power C.O. Final date/app. by Pump pole date/app. by Reconnection RV Reconnection RV	Monolithic date app. by date app. by
Temporary Power I oundation date/app. by Under slab rough-in plumbing date/app. by Framing Insulation date/app. by Rough-in plumbing above slab and below wood floor Heat & Air Duct Peri, beam (Lindate/app. by Permanent power C.O. Final date/app. by Pump pole Utility Pole MHH tied date app. by Reconnection RV date/app. by	Monolithic date app. by date app. by
Temporary Power I oundation date/app. by Under slab rough-in plumbing date/app. by Framing Insulation date/app. by Rough-in plumbing above slab and below wood floor Heat & Air Duct Peri, beam (Lindate/app. by Permanent power C.O. Final date/app. by Pump pole Utility Pole MHH tied date app. by Reconnection RV date/app. by	Monolithic date app, by Sheathing Nailing date app, by Lilectrical rough-in date app, by Lilectrical rough-in date app, by Culvert date app, by downs, blocking, electricity and plumbing Re-root date app, by
Temporary Power I oundation date app. by Under slab rough-in plumbing date app. by Framing Insulation date app. by Rough-in plumbing above slab and below wood floor Heat & Air Duet Peri, beam (Lindate app. by Permanent power C.O. Final date app. by Pump pole date app. by Reconnection RV date app. by BUILDING PERMIT FEE S 0.00 CERTIFICATION F	Monolithic date app, by Sheathing Nailing date app, by Lifectrical rough-in date app, by Lifectrical rough-in date app, by Culvert date app, by Culvert date app, by date app, by Culvert date app, by Serior date app, by
Temporary Power I oundation date app. by Under slab rough-in plumbing date app. by Framing date app. by Rough-in plumbing above slab and below wood floor Heat & Air Duet Peri, beam (Lindate app. by Permanent power date app. by Pump pole date app. by Reconnection RV date app. by BUILDING PERMIT FEES 0.00 CERTIFICATION F	Monolithic date app, by Sheathing Nailing date app, by Lifectrical rough-in date app, by Lifectrical rough-in date app, by Culvert date app, by Culvert date app, by date app, by Culvert date app, by date app, by date app, by date app, by Culvert date/app, by date app, by EEES 6.00 SURCHARGE FEES 6.00
Temporary Power date app. by Under slab rough-in plumbing date app. by Framing date app. by Rough-in plumbing above slab and below wood floor Heat & Air Duet Peri, beam (Lindate app. by Permanent power date app. by Pump pole date app. by Reconnection RV date app. by BUILDING PERMIT FEES 0.00 CERTIFICATION F	Monolithic date app. by Sheathing Nailing date app. by Lifectrical rough-in date app. by Lifectrical rough-in date app. by Culvert date app. by Culvert date app. by date app. by date app. by Culvert date app. by EEES 6.00 SURCHARGE FIES 6.00

Columbia County Building Permit

DATE 05/03/2019

PERMIT

IMPROVEMENTS TO YOUR PROPERTY. IF YOU INTEND TO OBTAIN FINANCING, CONSULT WITH YOUR LENDER OR AN ATTORNEY BEFORE RECORDING YOUR NOTICE OF COMMENCEMENT." EVERY PERMIT ISSUED SHALL BECOME INVALID UNLESS THE WORK AUTHORIZED BY SUCH PERMIT IS COMMENCED WITHIN 180 DAYS AFTER ITS ISSUANCE, OR IF THE WORK AUTHORIZED BY SUCH PERMIT IS SUSPENDED OR

ABANDONED FOR A PERIOD OF 180 DAYS AFTER THE TIME THE WORK IS COMMENCED. A VALID PERMIT RECIEVES AN APPROVED INSPECTION EVERY 180 DAYS. WORK SHALL BE CONSIDERED NOT SUSPENDED, ABANDONED OR INVALID WHEN THE PERMIT HAS RECIEVED AN APPROVED INSPECTION WITHIN 180 DAYS OT THE PREVIOUS INSPECTION The Issuance of this Permit Does Not Waive Compliance by Permittee with Deed Restrictions.

Columbia County New Building Permit Application

or Office Use Only Application # 1904 - 75 Date Received 4-2449 By WH Permit # 38069
Zoning Official Date 4-25-19 Flood Zone Land Use Ag Zoning A-3
FEMA Map # Elevation MFE NA River Plans Examiner 1.4 Date 4-3-49
Comments NON-Habitable Structure
NOC YEH Deed or PA Site Plan State Road Info Well letter 911 Sheet Parent Parcel #
Dev Permit # In Floodway Tetter of Auth. from Contractor F W Comp. letter
Owner Builder Disclosure Statement Land Owner Affidavit Ellisville Water App Fee Paid Sub VF Form
Septic Permit No. 19-034 A OR City Water Fax
Applicant (Who will sign/pickup the permit) Bobby Bowles Phone 606-875-4402
Address 525 SW Birley AVE. Late City 32024
Owners Name Bobby & Cindy Bowles Phone 606-875-4402
911 Address 525 SW Birley AVE. Lake City FL. 606-875-5715
Contractors Name Bobby Bowles Phone 606-875. 4402
Address 525 SW BILLEY AVE.
Contractor Email Bobby bowles 62@ Yahoo . Com ***Include to get updates on this job.
Fee Simple Owner Name & Address
Bonding Co. Name & Address
Architect/Engineer Name & Address Moure & Associates 1009 E Ave. North Augusta, SC 29841
Mortgage Lenders Name & Address
Circle the correct power company FL Power & Light Clay Elec. Suwannee Valley Elec. Duke Energy
Property ID Number 32-35-16-02420-007 Estimated Construction Cost 16500, W
Subdivision Namo
Driving Directions from a Major Road 90 W. (D) Bitlen Rd, (D) on easement i ust
Driving Directions from a Major Road 90W, @ Birley Rd, @ on easement just past Community Center, follow Back to home
pus) community can con promise
Construction of garage Commercial OR Residential
Proposed Use/Occupancy personal Number of Existing Dwellings on Property /
Is the Building Fire Sprinkled? NO If Yes, blueprints included Or Explain
Circle Proposed Culvert Permit or Culvert Waiver or D.O.T. Permit or Have an Existing Drive
Actual Distance of Structure from Property Lines - Front 300 FT. Side 275 FT Side 360 + Rear 800 +
Number of Stories Heated Floor Area O Total Floor Area 1200 5F Acreage 10
Zoning Applications applied for (Site & Development Plan, Special Exception, etc.)

Columbia County Building Permit Application

CODE: Florida Building Code 2017 and the 2014 National Electrical Code.

non is hereby made to obtain a permit to do work and installations as indicated. I certify that no work or installation has imenced prior to the issuance of a permit and that all work be performed to meet the standards of all laws regulating construction in this jurisdiction.

TIME LIMITATIONS OF APPLICATION: An application for a permit for any proposed work shall be deemed to have been abandoned 180 days after the date of filing, unless pursued in good faith or a permit has been issued.

<u>TIME LIMITATIONS OF PERMITS:</u> Every permit issued shall become invalid unless the work authorized by such permit is commenced within 180 days after its issuance, or if the work authorized by such permit is suspended or abandoned for a period of 180 days after the time work is commenced. A valid permit receives an approved inspection every 180 days. Work shall be considered not suspended, abandoned or invalid when the permit has received an approved inspection within 180 days of the previous approved inspection.

FLORIDA'S CONSTRUCTION LIEN LAW: Protect Yourself and Your Investment: According to Florida Law. those who work on your property or provide materials, and are not paid-in-full, have a right to enforce their claim for payment against your property. This claim is known as a construction lien. If your contractor fails to pay subcontractors or material suppliers or neglects to make other legally required payments, the people who are owed money may look to your property for payment, even if you have paid your contractor in full. This means if a lien is filed against your property, it could be sold against your will to pay for labor, materials or other services which your contractor may have failed to pay.

NOTICE OF RESPONSIBILITY TO CONTRACTOR AND AGENT: YOU ARE HEREBY NOTIFIED as the recipient of a building permit from Columbia County, Florida, you will be held responsible to the County for any damage to sidewalks and/or road curbs and gutters, concrete features and structures, together with damage to drainage facilities, removal of sod, major changes to lot grades that result in ponding of water, or other damage to roadway and other public infrastructure facilities caused by you or your contractor, subcontractors, agents or representatives in the construction and/or improvement of the building and lot for which this permit is issued. No certificate of occupancy will be issued until all corrective work to these public infrastructures and facilities has been corrected.

WARNING TO OWNER: YOUR FAILURE TO RECORD A NOTICE OF COMMENCEMENT MAY RESULT IN YOU PAYING TWICE FOR IMPROVEMENTS TO YOUR PROPERTY. A NOTICE OF COMMENCEMENT MUST BE RECORDED AND POSTED ON THE JOB SITE BEFORE THE FIRST INSPECTION, IF YOU INTEND TO OBTAIN FINANCING, CONSULT WITH YOUR LENDER OR ATTORNEY BEFORE RECORDING YOUR NOTICE OF COMMENCEMENT.

OWNERS CERTIFICATION: I CERTIFY THAT ALL THE FOREGOING INFORMATION IS ACCURATE AND THAT ALL WORK WILL BE DONE IN COMPLIANCE WITH ALL APPLICABLE LAWS REGULATING CONSTRUCTION AND ZONING.

<u>NOTICE TO OWNER:</u> There are some properties that may have deed restrictions recorded upon them. These restrictions may limit or prohibit the work applied for in your building permit. You must verify if your property is encumbered by any restrictions or face possible litigation and or fines.

Bobby Bowles Print Owners Name	Owners Signature	**Property owners <u>must sign</u> here <u>before</u> any permit will be issued.
--------------------------------	------------------	---

**If this is an Owner Builder Permit Application then, ONLY the owner can sign the building permit when it is issued.

<u>CONTRACTORS AFFIDAVIT:</u> By my signature I understand and agree that I have informed and provided this written statement to the owner of all the above written responsibilities in Columbia County for obtaining this Building Permit including all application and permit time limitations.

	Contractor's License Number
Contractor's Signature	Columbia County
	Competency Card Number
Affirmed under penalty of perjury to by the Contractor ar	nd subscribed before me this day of 20
Personally known or Produced Identification	
	SEAL:
State of Florida Notary Signature (For the Contractor)	

SUBCONTRACTOR VERIFICATION

APPLICATION/PERMIT #	JOB NAME	
711 - E10711101171 - E11111111111		

THIS FORM MUST BE SUBMITTED BEFORE A PERMIT WILL BE ISSUED

Columbia County issues combination permits. One permit will cover all trades doing work at the permitted site. It is <u>REQUIRED</u> that we have records of the subcontractors who actually did the trade specific work under the general contractors permit.

NOTE: It shall be the responsibility of the general contractor to make sure that all of the subcontractors are licensed with the Columbia County Building Department.

Use website to confirm licenses: http://www.columbiacountyfla.com/PermitSearch/ContractorSearch.aspx

NOTE: If this should change prior to completion of the project, it is your responsibility to have a corrected form submitted to our office, before that work has begun.

Violations will result in stop work orders and/or fines.

		Need
ELECTRICAL	Print NameSignature	□ Lic □ Liab
	Company Name:	
CC#	Licence #:	I EX
- CC#	License #: Phone #:	I DE
MECHANICAL/	Print Name Signature	I Lic
A/C	Company Name:	T Leab
CC#	20	I EX
	License #:Phone #:	T DE Need
PLUMBING/	Print Name Signature	I Lic
GAS	Company Name:	I Liab I W/c
CC#	License #: Phone #:	I EX
		T DE Need
ROOFING	Print Name	Z Lic
	Company Name:	T trab
CC#	9/	_ EX
	License #:	I DE Need
SHEET METAL	Print Name Signature	I Lic
	Company Name:	I Liab I w/c
CC#		I EX
	License #: Phone #:	I DE Need
FIRE SYSTEM/	Print Name Signature	T Lic
SPRINKLER	Company Name:	I trab I w/c
CC#		□ EX
	License#:Phone #:	I DE Need
SOLAR	Print NameSignature	I Lie
	Company Name:	I Liab I W/C
CC#	License #: Phone #:	□ EX
		DE Need
STATE	Print NameSignature	I Lic
SPECIALTY	Company Name:	□ Liab □ W/c
SPECIALTY CC#	Company Name: Phone #:	

Ref: F.S. 440.103; ORD. 2016-30



PARCEL: 32-35-16-02420-007 | MOBILE HOM (000200) | 9.92 AC

COMM AT SW COR OF NE1/4, RUN N 05 DG E 1013.66 FT, S 78 DG E 1114.70 FT FOR POB, N 05 DG E 392.62 FT, E

1152.55 FT, S 7 DG W 394.25 FT, W 1139.22 FT T

	BOWLES BOI	OWLES BOBBY E & CINDY S			2018 Certified Values			
Owner	333 SOUTHWES	ST SLEEPY GL	EN	Mkt Lnd	\$45,739	Appraised	\$62,452	
	LAKE CITY, FL 3	32024		Ag Lnd	\$0	Assessed	\$62,452	
Site:	525 BIRLEY AVE	E, LAKE CITY		Bldg	\$15,513	Exempt	\$0	
Sales	5/27/2014	\$39,900	I (U)	XFOB	\$1,200		county:\$62,452	
Info	4/29/2014 6/26/2013	\$100 \$100	1 (U) 1 (U)	Just	\$62,452	Total Taxable		



This information, was derived from data which was compiled by the Columbia County Property Appraiser Office solely for the governmental purpose of property assessment. This information should not be relied upon by anyone as a determination of the ownership of property or market value. No warranties, expressed or implied, are provided for the accuracy of the data herein, it's use, or it's interpretation. Although it is periodically updated, this information may not reflect the data currently on file in the Property Appraiser's office.

GrizzlyLogic.com

Columbia County Property Appraiser

Jeff Hampton

Use Code**

Parcel: << 32-3S-16-02420-007 >>

Tax District

Owner & Pr	roperty Info	Result:	1 of 1	
Owner	BOWLES BOBBY E & 333 SOUTHWEST SLE LAKE CITY, FL 32024			
Site	525 BIRLEY AVE, LAKE CITY			
Description*	COMM AT SW COR OF 1 1013.66 FT, S 78 DG E 1 DG E 392.62 FT, E 1152. W 1139.22 FT TO POB. O JERRY GLEN CPOE 110 1275-1126, SWD 1275-12	114.70 FT FOR 55 FT, S 7 DG V DRB 1032-1635 3-15), WD 1183	POB, N 05 V 394.25 FT, , (DC	
Area	9.92 AC	S/T/R	32-3S-16E	

*The <u>Description</u> above is not to be used as the Legal Description for this parcel

In any legal transaction.

**The <u>Use Code</u> is a FL Dept. of Revenue (DOR) code and is not maintained by the Property Appraiser's office. Please contact your city or county Planning & Zoning office for specific zoning information.

Property & Assessment Values

MOBILE HOM

(000200)

2018 Certified Values		2019 Working Values		
Mkt Land (3)	\$44,489	Mkt Land (3) \$45,		
Ag Land (0)	\$0	Ag Land (0)	\$0	
Building (1)	\$15,850	Building (1)	\$15,513	
XFOB (1)	\$1,200	XFOB (1)	\$1,200	
Just	\$61,539	Just	\$62,452	
Class	\$0	Class	\$0	
Appraised	\$61,539	Appraised	\$62,452	
SOH Cap [?]	\$0	SOH Cap [?]	\$0	
Assessed	\$61,539	Assessed	\$62,452	
Exempt	\$0	Exempt	\$0	
Total Taxable	county:\$61,539 city:\$61,539 other:\$61,539 school:\$61,539	Total Taxable	county:\$62,452 city:\$62,452 other:\$62,452 school:\$62,452	



Aerial Viewer	Pictometery	Google Maps		
● 2019 ○ 20	16 2013	2010 🔘 2007	2005	✓ Sales
+		, , , , , , , , , , , , , , , , , , ,		
-				
(; ; ; ; ; ; ; ; ; ; ; ; ; ; ; ; ; ; ;	-) <u>-</u>		8	į
ar I			HEADH	
			MILITARY SEE	
	是		6	4 6 1
SWSUSEPY OU			William I	Notice
· ·				STATE
.N				
		10000000000000000000000000000000000000		j' de la companion de la compa
	SW SUWA	INEE DOWNS DR		
	SWAJERIN-GT			1
	INCI			
9				
		186		

▼ Sales History

Sale Date	Sale Price	Book/Page	Deed	V/I	Quality (Codes)	RCode
5/27/2014	\$39,900	1275/1285	WD	ı	U	12
4/29/2014	\$100	1275/1126	QC	1	U	18
6/26/2013	\$100	1259/1291	CT	1	U	18
8/27/2009	\$100	1183/0394	WD	V	U	11
11/11/2004	\$100	1031/1635	QC	V	U	01

Building Characteristics

Bldg Sketch	Bldg Item	Bldg Desc*	Year Blt	Base SF	Actual SF	Bldg Value
Sketch	1	MOBILE HME (000800)	1999	1680	1888	\$15,513

*Bldg Desc determinations are used by the Property Appraisers office solely for the purpose of determining a property's Just Value for ad valorem tax purposes and should not be used for any other purpose.

▼ Extra Features & Out Buildings (Codes)

Code	Desc	Year Bit	Value	Units	Dims	Condition (% Good)
0190	FPLC PF	2004	\$1,200.00	1.000	0 x 0 x 0	(000.00)



COLUMBIA COUNTY BUILDING DEPARTMENT

135 NE Hernando Ave., Suite B-21 Lake City, FL 32055

Office: 386-758-1008 Fax: 386-758-2160

OWNER BUILDER DISCLOSURE STATEMENT

I understand that state law requires construction to be done by a licensed contractor and have applied for an owner-builder permit under an exemption from the law. The exemption specifies that I, as the owner of the property listed, may act as my own contractor with certain restrictions even though I do not have a license.

I understand that building permits are not required to be signed by a property owner unless he or she is responsible for the construction and is not hiring a licensed contractor to assume responsibility.

I understand that, as an owner-builder, I am the responsible party of record on a permit. I understand that I may protect myself from potential financial risk by hiring a licensed contractor and having the permit filed in his or her name instead of my own name. I also understand that a contractor is required by law to be licensed and bonded in Florida and to list his or her license numbers on permits and contracts.

I understand that I may build or improve a one-family or two-family residence or farm outbuilding. I may also build or improve a commercial building if the costs do not exceed \$75,000. The building or residence must be for my own use or occupancy. It may not be built or substantially improved for sale or lease. If a building or residence that I have built or substantially improved myself is sold or leased with in 1 year after the construction is complete, the law will presume that I built or substantially improved it for sale or lease, which violates the exemption.

I understand that, as the owner-builder, I must provide direct, onsite supervision of the construction.

I understand that I may not hire an unlicensed person to act as my contractor or to supervise persons working on my building or residence. It is my responsibility to ensure that the persons whom I employ have the licenses required by law and by county or municipal ordinance.

I understand that it is frequent practice of unlicensed persons to have the property owner obtain an owner-builder permit that erroneously implies that the property owner is providing his or her own labor and materials. I, as an owner-builder, may be held liable and subjected to serious financial risk for any injuries sustained by an unlicensed person or his or her employees while working on my property. My homeowner's insurance may not provide coverage for those injuries. I am willfully acting as an owner-builder and am aware of the limits of my insurance coverage for injuries to workers on my property.

I understand that I may not delegate the responsibility for supervising work to a licensed contractor who is not licensed to perform the work being done. Any person working on my building who is not licensed must work under my direct supervision and must be employed by me, which means that I must comply with laws requiring the withholding of federal income tax and social security contributions under the Federal Insurance Contributions Act (FICA) and must provide workers' compensation for the employee. I understand that my failure to follow these laws may subject me to serious financial risk.

I agree that, as the party legally and financially responsible for this proposed construction activity, I will abide by all applicable laws and requirements that govern owner-builders as well as employers. I also understand that the construction must comply with all applicable laws, ordinances, building codes, and zoning regulations.

I understand that I may obtain more information regarding my obligations as an employer from the Internal Revenue Service, the United States Small Business Administration, the Florida Department of Financial Services, and the Florida Department of Revenue. I also understand that I may contact the Florida Construction Industry Licensing Board at 850-487-1395 or Internet website address http://www.myfloridalicense.com/dbpr/ for more information about licensed contractors.

I am aware of, and consent to, an owner-builder building permit applied for in my name and understand that I am the party legally and financially responsible for the proposed construction activity at the following address:

I agree to notify Columbia County Building Department immediately of any additions, deletions, or changes to any of the information that I have provided on this disclosure. Licensed contractors are regulated by laws designed to protect the public. If you contract with a person who does not have a license, the Construction Industry Licensing Board and Department of Business and Professional Regulation may be unable to assist you with any financial loss that you sustain as a result of a complaint. Your only remedy against an unlicensed contractor may be in civil court. It is also important for you to understand that, if an unlicensed contractor or employee of an individual of firm is injured while working on your property, you may be held liable for damages. If you obtain an owner-builder permit and wish to hire a licensed contractor, you will be responsible for verifying whether the contractor is properly licensed and the status of the contractor's workers' compensation coverage.


I understand that if I hire subcontractors they must be licensed for that type of work in Columbia County, ex: framing, stucco, masonry, and state registered builders. Registered Contractors must have a minimum of \$300,000.00 in General Liability insurance coverage and the proper workers' compensation. Specialty Contractors must have a minimum of \$100,000.00 in General Liability insurance coverage and the proper workers' compensation coverage.

Before a building permit can be issued, this disclosure statement must be completed and signed by the property owner and returned to Columbia County Building Department.

TYPE OF CONSTRUCTION

() Single Family Dwelling () Two-Family Residence () Farm Outbuilding
() Addition, Alteration, Modification or other Improvement
() Commercial, Cost of Construction for construction of
(y Other
statement for exemption from contractor licensing as an owner/builder. I agree to comply with all requirements provided for in Florida Statutes allowing this exception for the construction permitted by Columbia County Building Permit.
Dotty Bowles 4/24/19 Owner Builder Signature Date
NOTARY OF OWNER BUILDER SIGNATURE
The above signer is personally known to me or produced identification Driver's License
Notary Signature Maria M. Landin Date Motary Public State of Florida Maria M Landin My Commission GG 238853
FOR BUILDING DEPARTMENT USE ONLY
I hereby certify that the above listed owner builder has been given notice of the restriction stated above.
Building Official/Representative

Revised: 7-1-15 DISCLOSURE STATEMENT 15 Documents: B&Z Forms

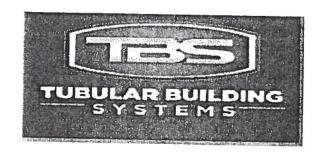

STRUCTURAL DESIGN



ENCLOSED BUILDING EXPOSURE B

MAXIMUM 30'-0" WIDE X 20'-0" EAVE HEIGHT- BOX EAVE FRAME AND BOW FRAME

18 December 2017 Revision 4 M&A Project No. 16022S/17300S

Prepared for:

Tubular Building Systems, LLC 631 SE Industrial Circle Lake City, Florida 32025

Prepared by:

Moore and Associates Engineering and Consulting, Inc. 1009 East Avenue North Augusta, SC 29841

> 401 S. Main Street, Suite 200 Mount Airy, NC 27030



No 57170

NOV 2 12918

STATE OF

ORIONGIANTINA

ORI

				T		
	•					
The parties of the land of the land of	9					
PERSONAL PROPERTY.				AND RESIDENCE ASSESSMENT ASSESSME		
A STATE OF THE PERSON NAMED IN						
				B.		
			\dashv			HINE S. MOON
					(H) (I) (I)	No 57170 NOV 2 7 248 STATE OF WEST
	MOORE AND AS INGINEERING AND CO	ONSULTING, INC.		D BY: PDH	1 30'-0"x20'-0	LAR BUILDING SYSTEMS "ENCLOSED BUILDING EXP. B ESEAL COVER SHEET
COI THI BE	S DOCUMENT IS THE PROPERTY OF MODRE AN ISULTING. THE UNAUTHORIZED REPRODUCTION, S DOCUMENT IS STRICTLY PROHIBITED AND A SUBJECT TO LEGAL, ACTION.	U ASSICIATES ENGINEERING AND COPYING, OR OTHERWISE USE OF NY INFRINGEMENT THEREUPON MAY	PROJEC CLIENT:		1 1	SCALE: NTS 160225/173005 DVG. NO: SK-3 REV.: 4

DRAWING INDEX

SHEET 1	PE SEAL COVER SHEET
SHEET 2	DRAWING INDEX
SHEET 3	INSTALLATION NOTES AND SPECIFICATIONS
SHEET 4	TYPICAL SIDE AND END ELEVATIONS
SHEET 5	TYPICAL RAFTER COLUMN END AND SIDE FRAMING SECTIONS (BOX EAVE RAFTER)
SHEET 6A	TYPICAL RAFTER COLUMN CONNECTION DETAILS (LACED COLUMN)
SHEET 6B	TYPICAL RAFTER COLUMN CONNECTION DETAILS (DOUBLE COLUMN)
SHEET 6C	TYPICAL RAFTER COLUMN CONNECTION DETAILS (SINGLE COLUMN)
SHEET 7	TYPICAL RAFTER COLUMN END AND SIDE FRAMING SECTIONS (BOW RAFTER)
SHEET 8A	TYPICAL RAFTER COLUMN CONNECTION DETAILS (DOUBLE COLUMN)
SHEET 8B	TYPICAL RAFTER COLUMN CONNECTION DETAILS (SINGLE COLUMN)
SHEET 9A	BASE RAIL ANCHORAGE OPTIONS
SHEET 9B	OPTIONAL FOUNDATION ANCHORAGE
SHEET 10	TYPICAL END WALL AND SIDE WALL OPENING FRAMING SECTIONS (BOX EAVE RAFTER)
SHEET 11	TYPICAL END WALL AND SIDE WALL OPENING FRAMING SECTIONS (BOW RAFTER)
SHEET 12	WALL OPENING DETAILS
SHEET 13	LEAN-TO OPTIONS (BOX EAVE RAFTER)
SHEET 14	LEAN-TO OPTIONS (BOW RAFTER)
SHEET 15	VERTICAL ROUF/SIDING OPTION END AND SIDE ELEVATION AND SECTION
SHEET 16	OPTIONAL DOOR HEADER



ENGINEERING AND CONSULTING INC	DRAVN BY: LT	JLAR BUILDING O" ENCLOSED BU	SYSTEMS JILDING EXP. B
THIS DOCUMENT IS STRICTLY PROHIBITED AND ANY INFRINGEMENT THEREUPON MAY		SCALE: NTS	JOB NO: 160225/173005

INSTALLATION NOTES AND SPECIFICATIONS

- 1. DESIGN IS FOR A MAXIMUM 30'-0" WIDE x 20'-0" EAVE HEIGHT ENCLOSED STRUCTURES
- 2 DESIGN WAS DONE IN ACCORDANCE WITH THE 2017 FLORIDA BUILDING CODE (FBC) 6TH EDITION, 2012 INTERNATIONAL BUILDING CODE (IBC), AND 2015 IBC.
- 3. DESIGN LOADS ARE AS FOLLOWS:

A) DEAD LOAD

= 1.5 PSF

B) LIVE LOAD

= 12 PSF

- C) GROUND SNOW LOAD = 10 PSF
- 4 LOW ULTIMATE WIND SPEED 105 TO 140 MPH (NOMINAL WIND SPEED 81 TO 108 MPH) MAXIMUM RAFTER/POST AND END POST SPACING = 50 FEET
- 5. HIGH ULTIMATE WIND SPEED 141 TO 170 MPH (NOMINAL WIND SPEED 109 TO 132 MPH): MAXIMUM RAFTER/POST AND END POST SPACING = 4.0 FEET.
- 6 LOW HAZARD RISK CATEGORY I (WIND)
- 7. WIND EXPOSURE CATEGORY B.
- 8. SPECIFICATIONS APPLICABLE TO 29 GAUGE METAL PANELS FASTENED DIRECTLY TO 2 1/2" x 2 1/2" 14 GAUGE TUBE STEEL (TS) FRAMING MEMBERS. FOR VERTICAL PANELS, 29 GAUGE METAL PANELS SHALL BE FASTENED TO 18 GAUGE HAT CHANNELS (UNLESS OTHERWISE NOTED).
- 9. AVERAGE FASTENER SPACING ON-CENTERS ALDNG RAFTERS OR PURLINS, AND POSTS, INTERIOR = 9" OR END = 6", (MAX)
- ID FASTENERS CONSIST OF #12-14x3/4" SELF-DRILLING FASTENER (SDF), USE CONTROL SEAL WASHER WITH EXTERIOR FASTENERS.

 SPECIFICATIONS APPLICABLE DNLY FOR MEAN ROOF HEIGHT OF 20 FEET OR LESS, AND ROOF SLOPES OF 14" (3:12 PITCH) OR LESS

 SPACING REQUIREMENTS FOR OTHER ROOF HEIGHTS AND/OR SLOPES MAY VARY.
- 11 GROUND ANCHORS SHALL BE INSTALLED THROUGH BASE RAIL WITHIN 6" OF EACH RAFTER COLUMN ALONG SIDES.
- 12 GROUND ANCHORS (SDIL NAILS) CONSIST OF #4 REBAR W/WELDED NUT × 30' LONG IN SUITABLE SDIL CONDITIONS MAY BE USED FOR LOW (< 108 MPH NOMINAL) WIND SPEEDS ONLY. OPTIONAL ANCHORAGE MAY BE USED IN SUITABLE SDILS AND MUST BE USE IN UNSUITABLE SDILS AS NOTED
- 13 OPTIONAL BASE RAIL ANCHORAGE MAY BE USED FOR LOW AND MUST BE USED FOR HIGH WIND SPEEDS
- 14 WIND FORCES GOVERN OVER SEISMIC FORCES SEISMIC PARAMETERS ANALYZED ARE

SDIL SITE CLASS = D RISK CATEGORY I/II/III

R= 3,25

 $I_{E} = 1.0$


S_{DS}= 1522 Spi= 0.839

V= CsW

THE THE PARTY OF T

MOORE AND ASSOCIATES ENGINEERING AND CONSULTING, INC.	DRAWN BY: L7 CHECKED BY: PDH	TUBULAR BUILDING SYSTEMS 30'-0"x20'-0" ENCLOSED BUILDING EXP.		
THIS DOCUMENT IS THE PROPERTY OF MODRE AND ASSOCIATES ENGINEERING AND CONSULTING. THE UNAUTHORIZED REPRODUCTION, COPYING, OR OTHERWISE USE OF THIS DOCUMENT IS STRICTLY PROHIBITED AND ANY INFRINGEMENT THEREUPON MAY BE SUBJECT TO LEGAL ACTION.			SCALE: NTS	JOB NO: 16022S/17300S REV.: 4

BOX EAVE FRAME RAFTER ENCLOSED BUILDING

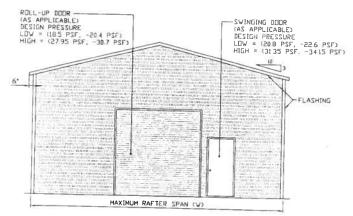


TYPICAL END ELEVATION-HORIZONTAL ROOF


TYPICAL SIDE ELEVATION-HORIZONTAL ROOF

-WINDDW (AS APPLICABLE)
DESIGN PRESSURE
LDW = (218 PSF, -23.6 PSF)
HIGH = (32.85 PSF, -35.6 PSF)

BOY FRAME RAFTER ENCLOSED BUILDING

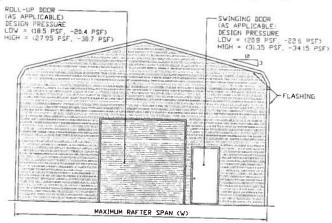

TYPICAL END ELEVATION

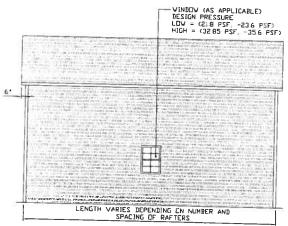


TYPICAL SIDE ELEVATION
SCALE NTS



MOORE AND ASSOCIATES
ENGINEERING AND CONSULTING, INC.


CONSULTING, THE UNAUTHORIZED REPRODUCTION, COPYING, OR OTHERVISE USE OF THIS DOCUMENT IS STRICTLY PROHIBITED AND ANY INFRINGEMENT THEREUPON MAY BE SUBJECT TO LEGAL, ACTION.
--

DRAWN BY: LT	TUBULAR BUILDING SYSTEMS 30'-0"x20'-0" ENCLOSED BUILDING EXP. B					
PROJECT MGR: WSM	DATE: 12-18-17	SCALE: NTS	JOB NO: 160225/173005			
CLIENT: TBS	SHT. 4	DVG. NO: SK-3	REV: 4			

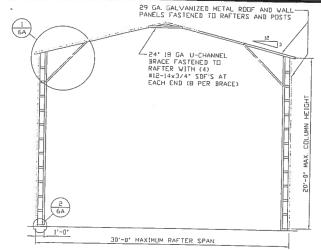


TYPICAL RAFTER/COLUMN END FRAME SECTION

SCALE NTS

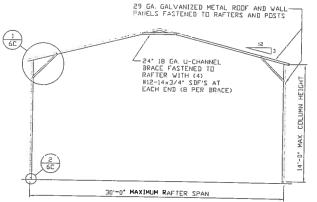


TYPICAL RAFTER/COLUMN END FRAME SECTION


SCALE NTS

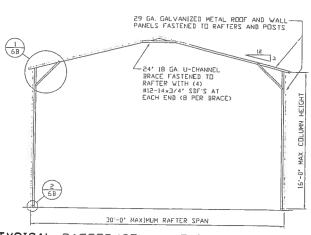

TYPICAL RAFTER/COLUMN END FRAME SECTION

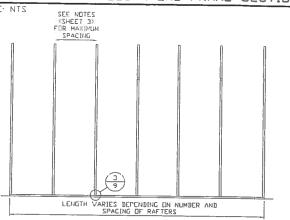


TYPICAL RAFTER/COLUMN SIDE FRAMING SECTION

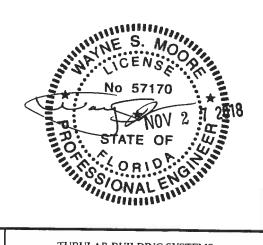

1.00	
MOORE AND ASSOCIATES	
ENGINEERING AND CONSULTING, I	VIC
- Combolino, I	·VC.

THIS DOCUMENT IS THE PROPERTY OF MODRE AND ASSOCIATES ENGINEERING AND CONSULTING. THE UNAUTHORIZED REPRODUCTION, COPYING, OR OTHERWISE USE OF THIS DOCUMENT IS STRICTLY PROHIBITED AND ANY INFRINGEMENT THEREUPON MAY BE SUBJECT TO LEGAL ACTION.

DRAWN BY: LT		TUBULAR BUILDING SYSTEMS 30'-0"x20'-0" ENCLOSED BUILDING EXP. B					
PROJECT MGR: VSM	DATE: 12-18-17	SCALE: NTS	JOB NO: 160225/173005				
CLIENT: TBS	SHT. 5	DVG. NO: SK-3	REV.: 4				

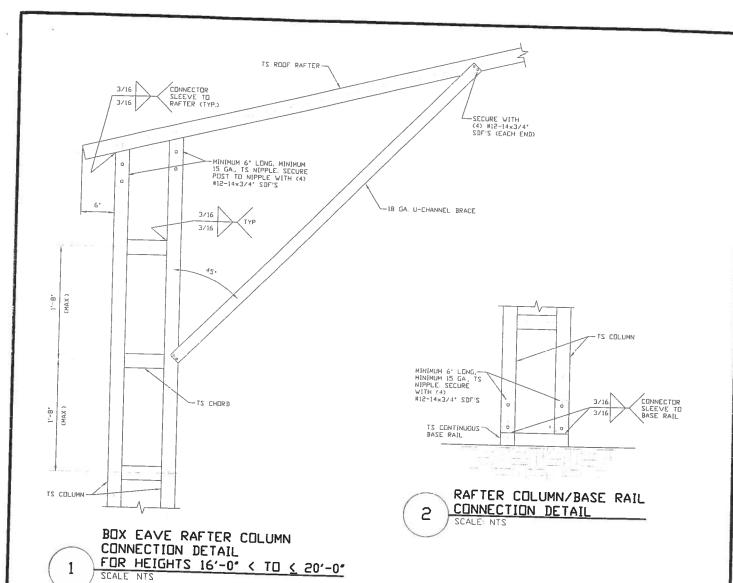

18 GA. U-CHANNEL BRACE
FASTENED TO THE COLLUMN
AND REFE BEAM, WITH (4)
#12-14x3/4' SDF'S AT EACH
END (8 FER BRACE)

BRACE SECTION
SCALE NTS

No 57170


NO 57170

NO 57170

STATE OF


NOV 2 7 208

ENGINEERING AND CONSULTING, INC.	DRAVN BY: LT	TUBULAR BUILDING SYSTEMS 30'-0"x20'-0" ENCLOSED BUILDING EXP		S SYSTEMS UILDING EXP. B
BE SUBJECT TO LEGAL ACTION.		DATE: 12-18-17 SHT. 6A	SCALE: NTS	JOB NO: 160225/173005

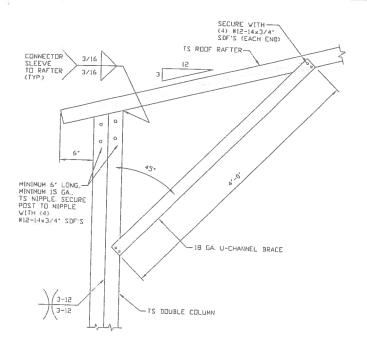


BOX EAVE RAFTER COLUMN
CONNECTION DETAIL
FOR HEIGHTS 14'-0" < TO < 16'-0"

SCALE: NTS

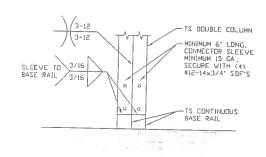


2 RAFTER COLUMN/BASE RAIL
CONNECTION DETAIL
SCALE NTS

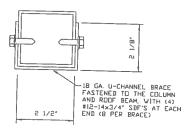


BRACE SECTION
SCALE: NTS


ENGINEERING AND CONSULTING, INC.	DRAVN BY: LT	TUBULAR BUILDING SYSTEMS 30'-0"x20'-0" ENCLOSED BUILDING EXP. B		
THIS DOCUMENT IS THE PROPERTY OF MODRE AND ASSOCIATES ENGINEERING AND CONSULTING. THE UNAUTHORIZED REPRODUCTION, COPYING, OR OTHERWISE USE OF THIS DOCUMENT IS STRICTLY PROHIBITED AND ANY INFRINGEMENT THEREUPON MAY BE SUBJECT TO LEGAL ACTION.			SCALE: NTS	JOB NO: 160225/173005

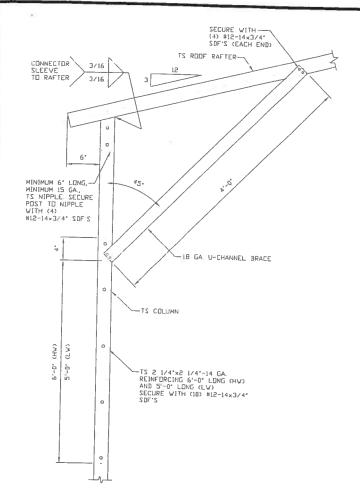


BOX EAVE RAFTER COLUMN CONNECTION DETAIL FOR HEIGHTS 10'-0' < TO < 14'-0'

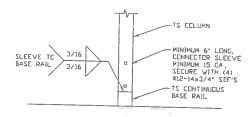


RAFTER COLUMN/BASE RAIL
CONNECTION DETAIL
SCALE: NTS

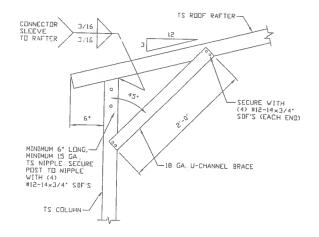

BOX EAVE RAFTER COLUMN CONNECTION DETAIL FOR HEIGHTS & 10'-0"

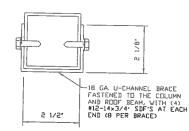


BRACE SECTION

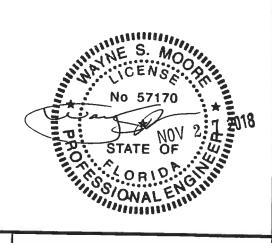


MOORE AND ASSOCIATES	
ENGINEERING AND CONSULTING, INC	

THIS DOCUMENT IS THE PROPERTY OF MODRE AND ASSOCIATES ENGINEERING AND CONSULTING. THE UNAUTHORIZED REPRODUCTION, COPYING, OR OTHERVISE USE OF THIS DOCUMENT IS STRICTLY PROHIBITED AND ANY INFRINGEMENT THEREUPON MAY BE SUBJECT TO LEGAL ACTION.


DRAWN BY: LT		ULAR BUILDIN 0" ENCLOSED I	G SYSTEMS BUILDING EXP. B
PROJECT MGR: VSM	DATE: 12-18-17	SCALE: NTS	JOB NO: 160225/173005
CLIENT: TBS	SHT. 6C	DVG. NO: SK-3	REV.: 4

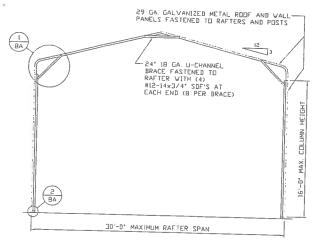


TYPICAL RAFTER/COLUMN END FRAME SECTION

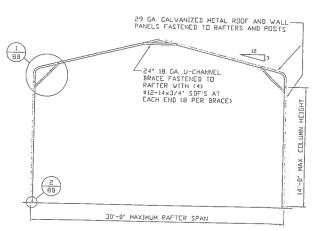


TYPICAL RAFTER/COLUMN END FRAME SECTION

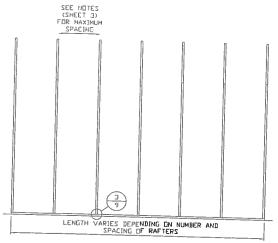


TYPICAL RAFTER/COLUMN SIDE FRAMING SECTION

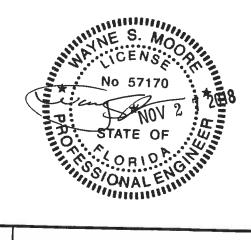

ENGINEERING AND CONSULTING, INC.	DRAWN BY: LT	TUBULAR BUILDING SYSTEMS 30'-0"x20'-0" ENCLOSED BUILDING EXP. B		
BE SUBJECT TO LEGAL ACTION		DATE: 12-18-17 SHT. 7	SCALE: NTS	JOB NO: 160225/173005

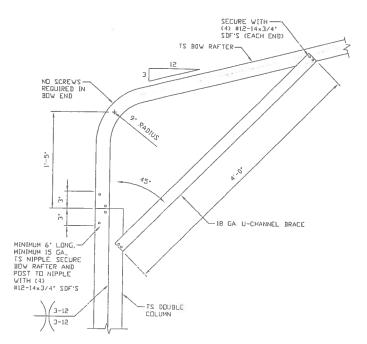


BOX EAVE RAFTER COLUMN
CONNECTION DETAIL
FOR HEIGHTS 14'-0" < TO < 16'-0"

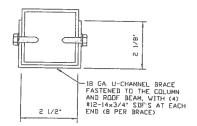


BRACE SECTION


SCALE NTS

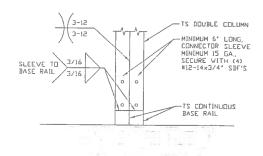



2 RAFTER COLUMN/BASE RAIL
SCALE NTS

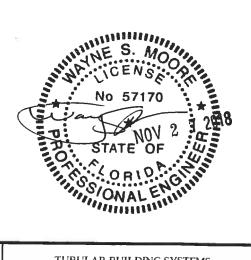


ENGINEERING AND CONSULTING INC	DRAWN BY: LT	TUBULAR BUILDING SYSTEMS 30'-0"x20'-0" ENCLOSED BUILDING EXP. B		
THIS DOCUMENT IS THE PROPERTY OF MODRE AND ASSOCIATES ENGINEERING AND CONSULTING. THE UNAUTHORIZED REPRODUCTION, COPYING, OR OTHERWISE USE OF THIS DOCUMENT IS STRICTLY PROHIBITED AND ANY INFRINGEMENT THEREUPON MAY BE SUBJECT TO LEGAL ACTION.		DATE: 12-18-17 SHT. 8A	SCALE: NTS	JOB NO: 160225/173005

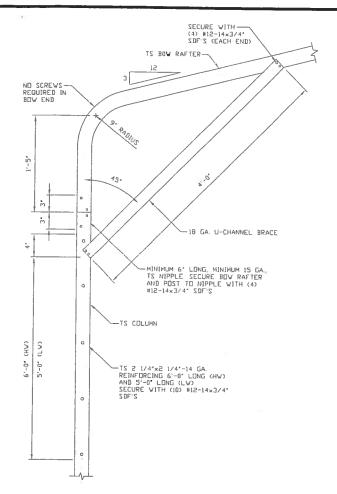

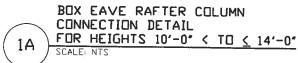

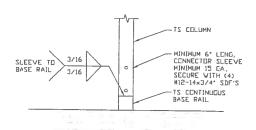


2 RAFTER COLUMN/BASE RAIL
CONNECTION DETAIL
SCALE: NTS

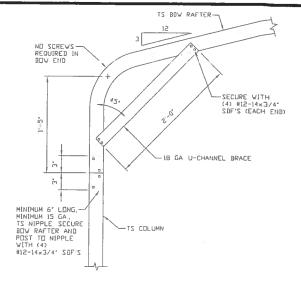


BOX EAVE RAFTER COLUMN CONNECTION DETAIL FOR HEIGHTS < 10'-0"

SCALE: NTS

1B

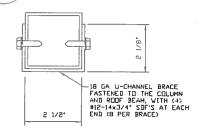


BRACE SECTION SCALE: NTS

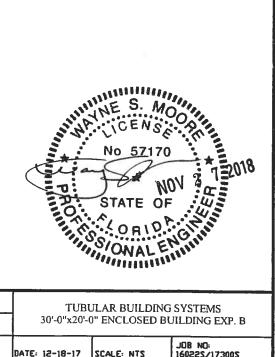


MOORE AND ASSOCIATES	DRAVN BY: LT
ENGINEERING AND CONSULTING, INC.	CHECKED BY: PDH
THIS DOCUMENT IS THE PROPERTY OF MODRE AND ASSOCIATES ENGINEERING AND CONSULTING. THE UNAUTHORIZED REPRODUCTION, COPYING, OR OTHERWISE USE OF	PROJECT MGR: VSM
THIS DOCUMENT IS STRICTLY PROHIBITED AND ANY INFRINGEMENT THEREUPON MAY BE SUBJECT TO LEGAL ACTION.	CLIENT, TRE

	DRAVN BY: LT	TUBULAR BUILDING SYSTEMS 30'-0"x20'-0" ENCLOSED BUILDING EXP. B						
	CHECKED BY: PDH							
-	PROJECT MGR: VSM	DATE: 12-18-17	SCALE: NTS	JOB 1602	NO: 2S/17300S			
	CLIENT: TBS	SHT. 8B	DWG. NO: SK-3		REV.: 4			

BASE RAIL ANCHORAGE OPTIONS FOR LOW AND HIGH WIND SPEED

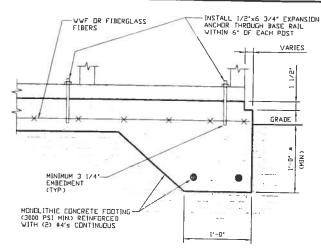

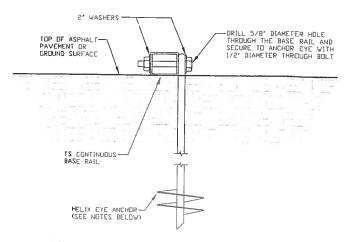

CONCRETE MONOLITHIC SLAB BASE RAIL ANCHORAGE

SCALE: NTS (MINIMUM ANCHOR EDGE BISTANCE IS 4")
* COORDINATE WITH LOCAL CODES/ORD.

GROUND BASE HELIX ANCHORAGE SCALE: NTS (CAN BE USED FOR ASPHALT)

GENERAL NOTES

CONCRETE:

CONCRETE SHALL HAVE A MINIMUM SPECIFIED COMPRESSIVE STRENGTH OF 3,000 PSI AT 28 DAYS.

COVER OVER REINFORCING STEEL:

FOR FOUNDATIONS, MINIMUM CONCRETE COVER OVER REINFORCING BARS SHALL BE PER ACI-318:

3 INCHES IN FOUNDATIONS WHERE THE CONCRETE IS CAST AGAINST AND PERMANENTLY IN CONTACT WITH THE EARTH OR EXPOSED TO THE EARTH OR WEATHER, AND 1 1/2 INCHES ELSEWHERE.

REINFORCING STEEL:

THE TURNDOWN REINFORCING STEEL SHALL BE ASTM A615 GRADE 60. THE SLAB REINFORCEMENT SHALL BE WELDED WIRE FABRIC MEETING ASTM A185 OR FIBERGLASS FIBER REINFORCEMENT


REINFORCEMENT MAY BE BENT IN THE SHOP OR THE FIELD PROVIDED:

REINFORCEMENT IS BENT COLD.

2 THE DIAMETER OF THE BEND, MEASURED ON THE INSIDE OF THE BAR, IS NOT LESS THAN SIX-BAR DIAMETERS.
3 REINFORCEMENT PARTIALLY EMBEDDED IN CONCRETE SHALL NOT BE FIELD BENT.

HELIX ANCHOR NOTES:

- 1 FOR VERY DENSE AND/OR CEMENTED SANDS, COARSE GRAVEL AND CCBBLES CALICHE, PRELITATED SILTS AND CLAYS USE MINIMUM (2) 4" HELICES WITH MINIMUM 30 INCH EMBEDMENT.
- 2. FOR CORAL USE MINIMUM (2) 4" HELICES WITH MINIMUM 30 INCH EMBEDMENT
- 3 FOR MEDIUM DENSE CHARSE SANDS, SANDY GRAVELS, VERY STIFF SILTS, AND CLAYS USE MINIMUM (2) 4' HELICES WITH MINIMUM 30 INCH EMBEDMENT
- 4. FOR LODSE TO MEDIUM DENSE SANDS, FIRM TO STIFF CLAYS AND SILTS ALLUVIAL FILL USE MINIMUM (2) 6' HELICES WITH MINIMUM 50 INCH EMBEDMENT.
- 5 FOR VERY LOSE TO MEDIUM DENSE SANDS, FIRM TO STIFFER CLAYS AND SILTS, ALLUVIAL FILL USE MINIMUM (2) 8' HELICES WITH MINIMUM 60 INCH EMBERMENT

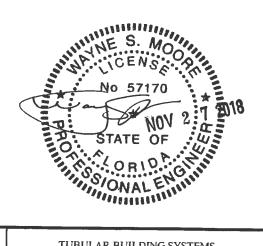


MOORE AND ASSOCIATES
ENGINEERING AND CONSULTING, INC.

THIS DOCUMENT IS THE PROPERTY OF MODRE AND ASSOCIATES ENGINEERING AND CONSULTING. THE UNAUTHORIZED REPRODUCTION, COPYING, OR OTHERVISE USE OF THIS DOCUMENT IS STRICTLY PROHIBITED AND ANY INFRINGEMENT THEREUPON MAY BE SUBJECT TO LEGAL ACTION.

DRAWN BY: LT		TUBULAR BUILDING SYSTEMS						
CHECKED BY: PDH	30'-0"x20'-	30'-0"x20'-0" ENCLOSED BUILDING EXP. B						
PROJECT HGR: VSH	DATE: 12-18-17	SCALE: NTS	JOB NO: 160225/173005					
CLIENT: TBS	SHT. 9A	DVG. NO: SK-3	REV.: 4					

OPTIONAL FOUNDATION ANCHORAGE FOR LOW & HIGH WIND SPEED

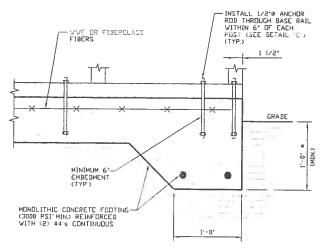

CONCRETE MONOLITHIC SLAB ANCHORAGE BASE RAIL

SCALE: NTS * CODRDINATE WITH LOCAL CODES/ORD.

GENERAL NOTES

CONCRETE:

CONCRETE SHALL HAVE A MINIMUM SPECIFIED COMPRESSIVE STRENGTH OF 3,000 PSI AT 28 DAYS

COVER OVER REINFORCING STEEL:

FOR FOUNDATIONS, MINIMUM CONCRETE COVER OVER REINFORCING BARS SHALL BE PER ACI-318:

3 INCHES IN FOUNDATIONS WHERE THE CONCRETE IS CAST AGAINST AND PERMANENTLY IN CONTACT WITH THE EARTH OR EXPOSED TO THE EARTH OR WEATHER, AND 1 1/2 INCHES ELSEWHERE.


REINFORCING STEEL:

THE TURNDOWN REINFORCING STEEL SHALL BE ASTM A615 GRADE 60. THE SLAB REINFORCEMENT SHALL BE WELDED WIRE FABRIC MEETING ASTM A185 OR FIBERGLASS FIBER REINFORCEMENT.

REINFORCEMENT MAY BE BENT IN THE SHOP OR THE FIELD PROVIDED:

1. REINFORCEMENT IS BENT COLD.
2. THE DIAMETER OF THE BEND, MEASURED ON THE INSIDE OF THE BAR, IS NOT LESS THAN SIX-BAR DIAMETERS.
3. REINFORCEMENT PARTIALLY EMBEDDED IN CONCRETE SHALL NOT

BE FIELD BENT

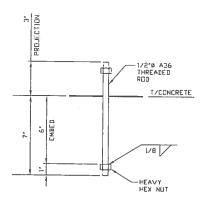

1C

ANCHOR ROD THROUGH BASE RAIL DETAIL SCALE NTS

MOORE AND ASSOCIATES


THIS DOCUMENT IS THE PROPERTY OF MODRE AND ASSOCIATES ENGINEERING AND CONSULTING. THE UMAUTHORIZED REPRODUCTION, COPYING, OR OTHERWISE USE OF THIS DOCUMENT IS STRICTLY PROHIBITED AND ANY INFRINGEMENT THEREUPON MAY BE SUBJECT TO LEGAL ACTION.

ENGINEERING AND CONSULTING, INC.

GRADE CMIMO 1.-0 EMBEDMENT 0 MONDLITHIC CONCRETE FOOTING (3000 PSI MIN) REINFORCED WITH (2) #4°s CONTINUOUS CONCRETE MONOLITHIC SLAB BASE RAIL ANCHORAGE 1B


INSTALL 1/2° ANCHOR—
RDD THROUGH BASE RAIL
WITHIN 6° DF EACH
POST (SEE DETAIL "C")
(TYP.)

(MINIMUM ANCHOR EDGE DISTANCE IS 1 1/2") * COORDINATE WITH LOCAL CODES/ORD.

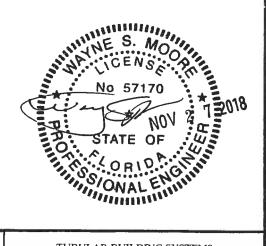


	DRAWN BY: LT CHECKED BY: PDH	TUBULAR BUILDING SYSTEMS 30'-0"x20'-0" ENCLOSED BUILDING EXP. B				
-	PROJECT MGR: VSM	DATE: 12-18-17	SCALE: NTS		NG: 225/17300S	
	CLIENT: TBS	SHT. 9B	DVG ND SK-3		REV.: 4	

BOX EAVE RAFTER END WALL AND SIDE WALL OPENINGS

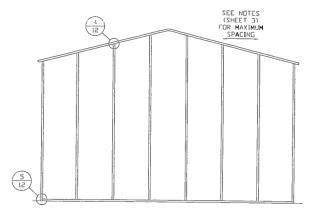


TYPICAL BOX EAVE RAFTER END WALL FRAMING SECTION

SCALE NTS

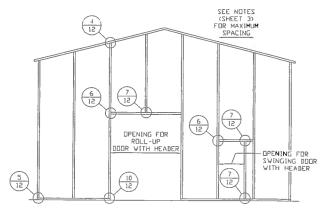


TYPICAL BOX EAVE RAFTER END WALL OPENINGS FRAMING SECTION

SCALE: NTS

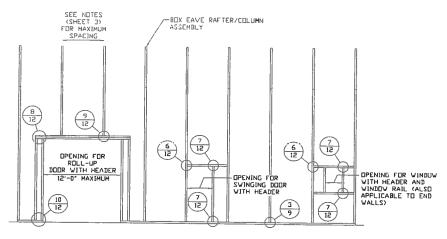


TYPICAL BOX EAVE RAFTER SIDE WALL OPENINGS FRAMING SECTION

SCALE NTS

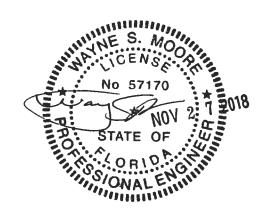

MOORE AND ASSOCIATES	DRAWN BY: LT	SYSTEMS		
ENGINEERING AND CONSULTING, INC.	AND CONSULTING, INC. CHECKED BY: PDH 30'-0"x20'-0" ENCLOS			
r consucting the unocirential relation till till till to the profes are no	PROJECT MGR: VSM	DATE: 12-18-17	SCALE: NTS	JOB NO: 200221/25003
THIS DOCUMENT IS STRICTLY PROHIBITED AND ANY INFRINGEMENT THEREUPON MAY BE SUBJECT TO LEGAL ACTION.	CLIENT: TBS	SHT. 10	DWG. NO: SK-3	REV: 4

BOW RAFTER END WALL AND SIDE WALL OPENINGS

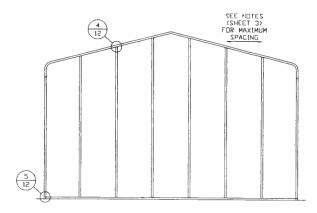

TYPICAL BOX EAVE RAFTER END WALL FRAMING SECTION

SEE NOTES
(SHEET 3)
FIR MAXIMUM
SPACING

OPENING FOR
RDLL-UP
DDOR WITH HEADER

TO THE SWINGING FOR
SWINGING DODR
WITH HEADER


TO THE SWINGING DODR
WITH HEADER

TO THE SWINGING DODR
WITH HEADER

TYPICAL BOX EAVE RAFTER END WALL OPENINGS FRAMING SECTION


SCALE: NTS

SCALE: NTS

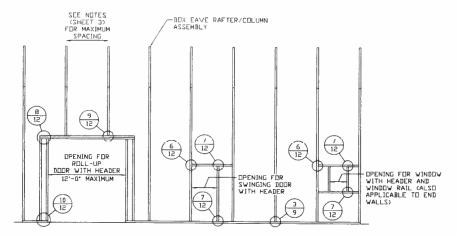


TYPICAL BOX EAVE RAFTER SIDE WALL OPENINGS FRAMING SECTION

SCALE: NTS

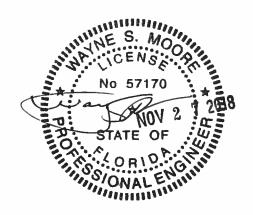

ENGINEEDING AND CONSULTING INC	DRAWN BY: LT	TUBULAR BUILDING SYSTEMS 30'-0"x20'-0" ENCLOSED BUILDING EXP. B		
THIS DOCUMENT IS THE PROPERTY OF MODRE AND ASSOCIATES ENGINEERING AND CONSULTING. THE UNAUTHORIZED REPRODUCTION, COPYING, OR OTHERWISE USE OF THIS DOCUMENT IS STRICTLY PROHIBITED AND ANY INFRINGEMENT THEREUPON MAY BE SUBJECT TO LEGAL ACTION.			SCALE: NTS	JOB NO: 16022\$/17300\$

BOW AND BOX EAVE RAFTER WALL OPENING DETAILS

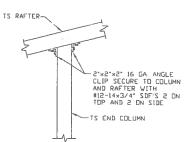

MINIMUM 6' LÖNG, MINIMUM 15 GA., TS NIPPLE. SECURE WITH (4) #12-14x3/4' SDF'S -2'x2'x2' 16 GA. CLIP ANGLE SECURE TO RAFTER COLUMN AND BASE RAIL W/(4) #12-14x3/4' SDF'S NIPPLE TO BASE RAIL 3/16 TS CONTINUOUS BASE RAIL


TS COLUMN OR END COLUMN -2"x2"x2" 16 GA. ANGLE CLIP SECURE TO COLUMN AND EITHER TOP OF HEADER, OR BOTTOM OF VINDOW RAIL WITH #12-14x3/4" SDF'S

END COLUMN/RAFTER CONNECTION DETAIL 4 SCALE: NTS

END COLUMN/BASE RAIL CONNECTION DETAIL

HEADER OR WINDOW RAIL TO COLUMN CONNECTION DETAIL 6 SCALE NTS

SCALE: NTS

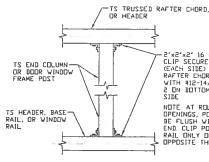

-2'x2'x2' 16 GA. ANGLE CLIP SECURE TO COLUMN (EACH SIDE) AND RAFFER CHORD/RAIL WITH #12-14x3/4' SDF'S 2 DN BOTTOM AND 2 DN SIDE

NOTE AT ROLL-UP DOOR EPENINGS, POST SHOULD BE FLUSH WITH RAIL END. CLIP POST TO RAIL ONLY ON SIDE DPPOSITE THE OPENING.


3-12 3/16 3/16 3-12 -MINIMUM 6' LONG, MINIMUM 15 GA, TS NIPPLE, SECURE EACH WITH (4) #12-14×3/4' SDF'S TS COLUMN

TS COLUMN 3/16 NIPPLE TO MINIMUM 6° LDNG, MINIMUM 15 GA., TS NIPPLE SECURE VITH (4) #12-14x3/4° SDF'S 3/16 TS DOUBLE HEADER


COLUMN TO HEADER, BASE RAIL, OR WINDOW RAIL CONNECTION DETAIL SCALE: NTS

DOUBLE HEADER/COLUMN CONNECTION DETAIL 8

COLUMN/DOUBLE HEADER CONNECTION DETAIL 9

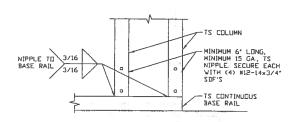


COLUMN/BASE RAIL CONNECTION DETAIL 10 SCALE NTS

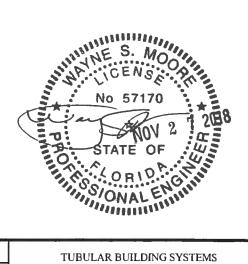

MOORE AND ASSOCIATES	
ENGINEERING AND CONSULTING, INC.	


THIS DOCUMENT IS THE PROPERTY OF MODRE AND ASSOCIATES ENGINEERING AND CONSULTING. THE UNAUTHORIZED REPRODUCTION, COPYING, OR OTHERWISE USE OF THIS DOCUMENT IS STRICTLY PROHIBITED AND ANY INFRINGEMENT THEREUPON MAY BE SUBJECT TO LEGAL ACTION.


DRAWN BY: LT	TUBULAR BUILDING SYSTEMS 30'-0"x20'-0" ENCLOSED BUILDING EXP. B			
PROJECT MGR: VSM	DATE: 12-18-17	SCALE: NTS	JOB NO: 160225/173005 REV.: 4	

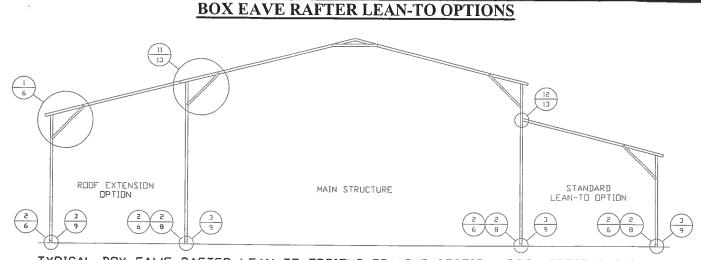

TYPICAL BOX EAVE RAFTER LEAN-TO OPTIONS FRAMING SECTION (BOTH OPTIONS SHOWN)


SCALE NTS MAXIMUM WIDTH OF SINGLE MEMBER RAFTER LEAN-TO IS 16'-0'.

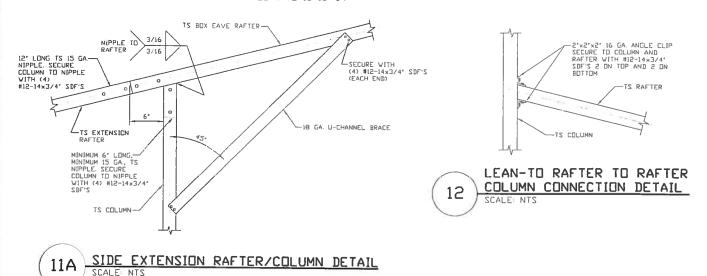

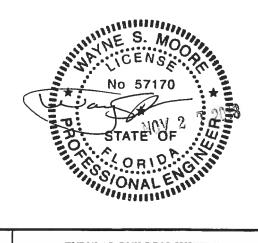


MOORE AND ASSOCIATES ENGINEERING AND CONSULTING, INC.	DRAVN BY: LT	TUBULAR BUILDING SYSTEMS 30'-0"x20'-0" ENCLOSED BUILDING EXP.		
THIS DOCUMENT IS THE PROPERTY OF MODRE AND ASSOCIATES ENGINEERING AND CONSULTING. THE UNAUTHORIZED REPRODUCTION, COPYING, OR OTHERWISE USE OF THIS DOCUMENT IS STRICTLY PROHIBITED AND ANY INFRINGEMENT THEREUPON MAY BE SUBJECT TO LEGAL ACTION.	PROJECT MGR: VSM	DATE: 12-18-17 SHT. 13	SCALE: NTS DVG. NO: SK-3	JOB NO: 160225/173005 REV.: 4

BOW RAFTER LEAN-TO OPTIONS

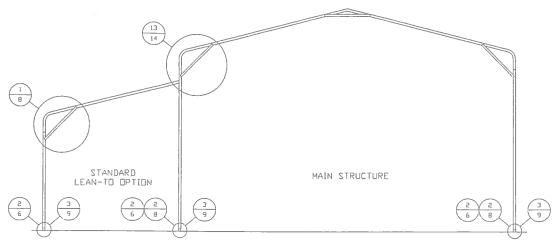

TYPICAL BOW RAFTER LEAN-TO OPTIONS FRAMING SECTION (BOTH OPTIONS SHOWN)

SCALE: NTS MAXIMUM WIDTH OF SINGLE MEMBER RAFTER LEAN-TO IS 16'-0".

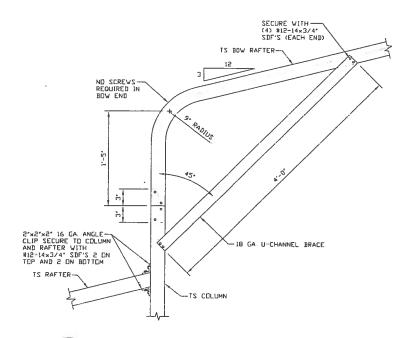


13 SIDE EXTENSION RAFTER/COLUMN DETAIL




ENGINEEDING AND CONSULTING INC	DRAVN BY: LT	4	ULAR BUILDING O" ENCLOSED BU	
THIS DOCUMENT IS THE PROPERTY OF MODRE AND ASSOCIATES ENGINEERING AND CONSULTING. THE UNAUTHORIZED REPRODUCTION, COPYING, OR OTHERWISE USE OF THIS DOCUMENT IS STRICTLY PROBLET AND ANY INFRINGEMENT THEREUPON MAY BE SUBJECT TO LEGAL ACTION.	PROJECT MGR: VSM		SCALE: NTS	JOB NO: 160225/173005 REV: 4


BOX EAVE RAFTER VERTICAL ROOF/SIDING OPTION

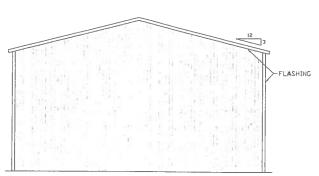


TYPICAL END ELEVATION VERTICAL ROOF/SIDING OPTION

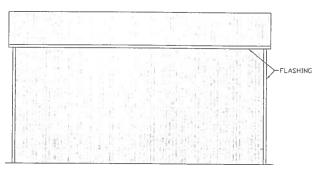


TYPICAL SIDE ELEVATION
VERTICAL ROOF/SIDING OPTION
SCALE, NTS

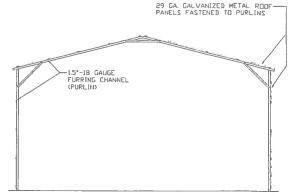

TYPICAL SECTION VERTICAL ROOF/SIDING OPTION

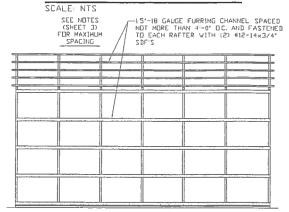

TYPICAL FRAMING SECTION VERTICAL ROOF/SIDING OPTION SCALE NTS

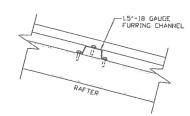


ROOF PANEL ATTACHMENT

(ALTERNATE FOR VERTICAL ROOF PANELS)




MOORE AND ASSOCIATES ENGINEERING AND CONSULTING, INC.	DRAWN BY: LT	TUBULAR BUILDING SYSTEMS 30'-0"x20'-0" ENCLOSED BUILDING EXP.		
THIS DOCUMENT IS THE PROPERTY OF MODRE AND ASSOCIATES ENGINEERING AND CONSULTING. THE UNAUTHORIZED REPRODUCTION, COPYING, OR OTHERWISE USE OF THIS DOCUMENT IS STRICTLY PROHIBITED AND ANY INFRINGEMENT THEREUPON MAY BE SUBJECT TO LEGAL ACTION.			SCALE: NTS	JOB NO: 160225/173005 REV: 4

OPTIONAL DOOR HEADER

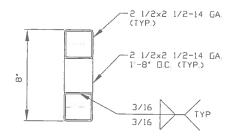


HEADER DETAIL FOR DOOR □PENINGS 12'-0' < LENGTH < 15'-0'

SCALEENTS

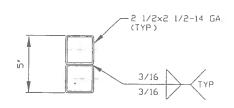


HEADER DETAIL FOR DOOR OPENINGS LENGTH < 12'-0"

SCALE NTS

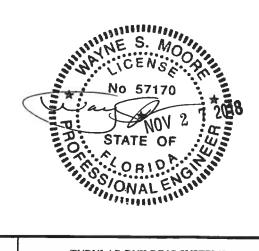

MOORE AND ASSOCIATES ENGINEERING AND CONSULTING, INC.	DRAWN BY: LT	-	ULAR BUILDING 0" ENCLOSED BU	
THIS DOCUMENT IS THE PROPERTY OF MODRE AND ASSOCIATES ENGINEERING AND CONSULTING. THE UNAUTHORIZED REPRODUCTION, COPYING, OR OTHERWISE USE OF THIS DOCUMENT IS STRICTLY PROHIBITED AND ANY INFRINGEMENT THEREUPON MAY BE SUBJECT TO LEGAL ACTION.	PROJECT MGR: VSM		SCALE: NTS	JOB NO: 160225/173005 REV.: 4

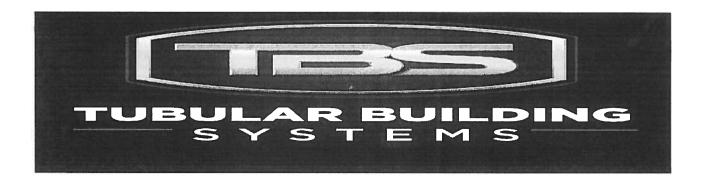

Florida Product Approval Codes

Roll-Up Doors:

Janus International Corporation Model 3652: 14425.1	EXP 12/31/19
Janus International Corporation Model 3100: 12765.3	EXP 12/31/19
Janus International Corporation Model 3100: 12765.4	EXP 12/31/19
Janus International Corporation Model 1100: 21450.2	EXP 12/31/19
Janus International Corporation Model 3100: 21450.4	EXP 12/31/19
Janus International Corporation Model 750: 21450.5	EXP 12/31/19
Janus International Corporation Model 750: 21450.6	EXP 12/31/19
Janus International Corporation Model 750: 21450.8	EXP 12/31/19

Walk-In Door:

*	Elixir Door & Metal Company blank (no window): 17996.5	EXP 9/14/20
	Elixir Door & Metal Company with 12x12 window: 17996.5	EXP 9/14/20
	Flixir Door & Metal Company regular door w/ 9 light window: 17996.6	FXP 9/14/20

Window:

* Kinro 993.7 EXP 10/19/21


Roof Deck:

* Capital Metal Supply Inc. Ag Panel: 20147.1 EXP 07/20/20

Wall Panel:

* Capital Metal Supply Inc. Ag Panel: 20148.1 EXP 07/20/20

If you have any questions on concern, please contact Donald Little at 386-961-0006 or at tubularbuildingsystems@gmail.com.

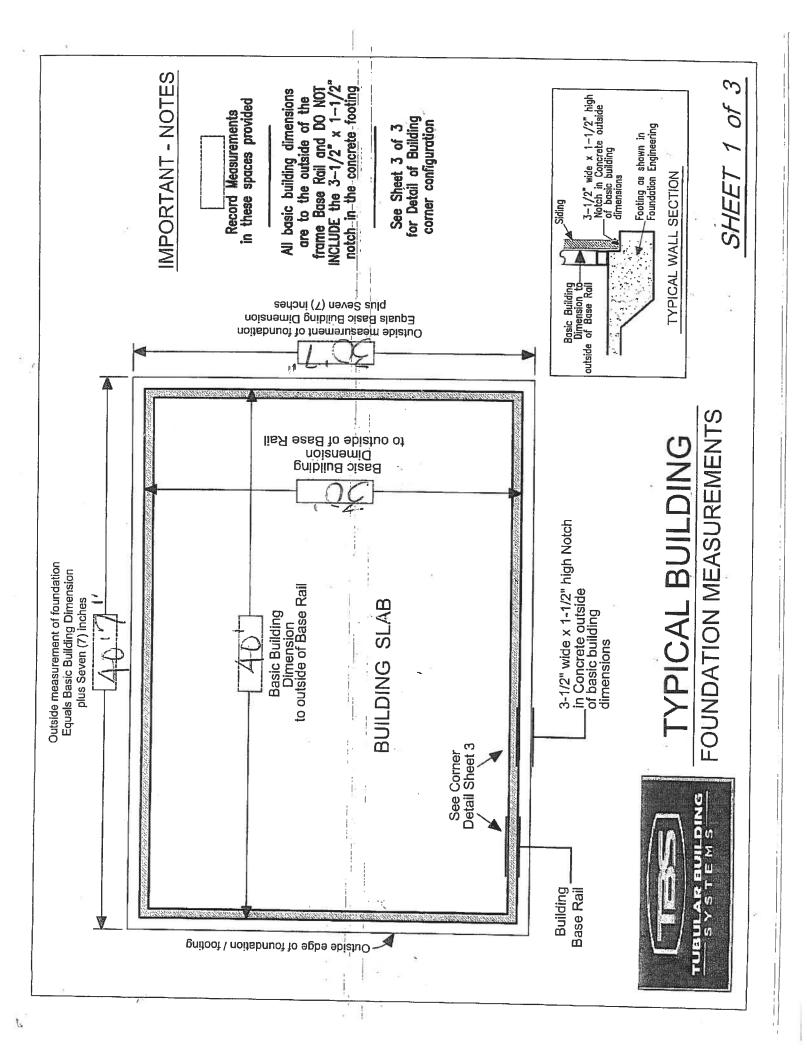

IMPORTANT - NOTES

Record Measurements in these spaces provided

All basic building diagonal dimensions are to the outside comer of the frame Base Rail and DO NOT INCLUDE the 3-1/2" x 1-1/2" notch_in_the_concrete_footing—

less de la proposición del la proposición del proposición de la proposición del proposición de la proposición de la proposición de la proposición de la proposición del proposición de la proposición de la proposición de la proposición de la proposición del proposición del proposició

See Sheet 3 of 3 for Detail of Building corner configuration


BUILDING SLAB

See Corner Detail Sheet 3 Building Base Rail

3-1/2" wide x 1-1/2" high Notch in Concrete outside of basic building dimensions


TYPICAL BUILDING

FOUNDATION MEASUREMENTS
DIAGONALS

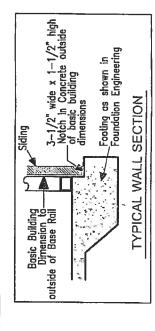

TUBULAR BUILDING

gnitoot \ notisbnuot to agba abistuC

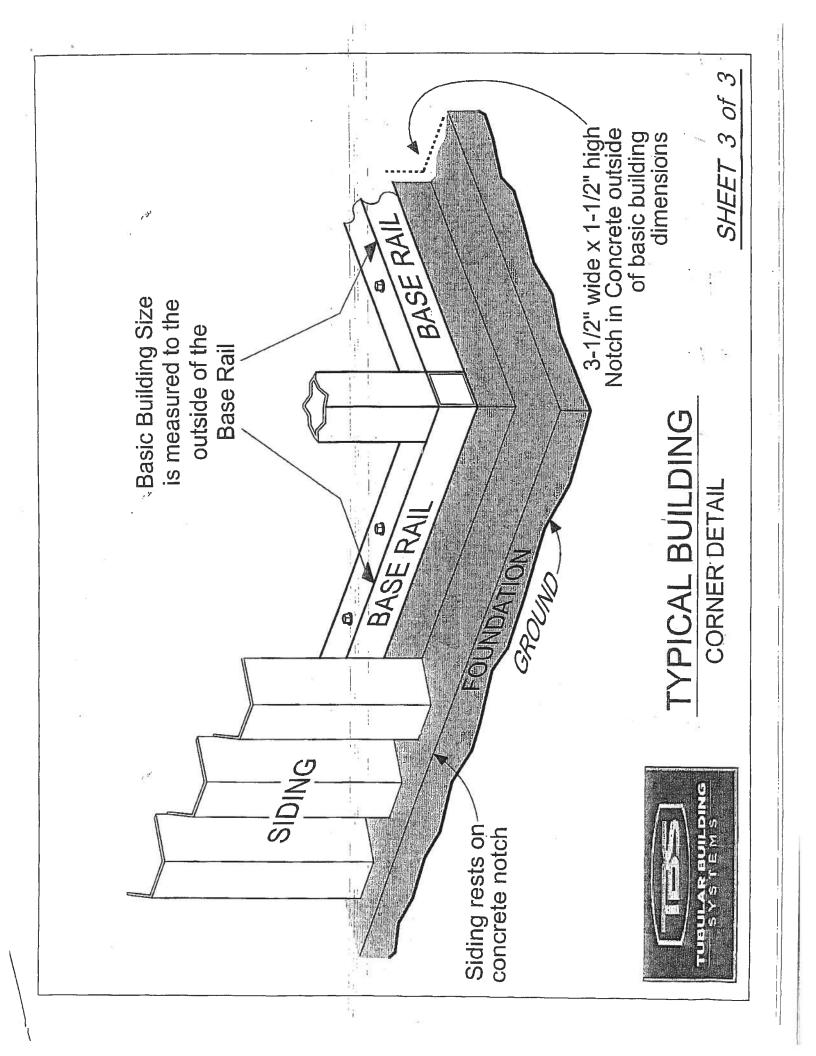

STATE OF FLORIDA DEPARTMENT OF HEALTH

APPLICATION FOR CONSTRUCTION PERMIT

Permit Application Number 9-234

----- PART II - SITEPLAN -----Scale: Each block represents 10 feet and 1 inch = 40 feet, Ŋ 30 × 40 Garage 40 301.40 House 514×€ Notes: __ Site Plan submitted by: Bothy Bouler TITLE Junez DATE:

Plan Approved Not Approved Date

By White Submitted by: Bouler Columbia County County Health Department

ALL CHANGES MUST BE APPROVED BY THE COUNTY HEALTH DEPARTMENT



STATE OF FLORIDA DEPARTMENT OF HEALTH ONSITE SEWAGE TREATMENT AND DISPOSAL SYSTEM FOR CONSTRUCTION PERMIT

PERMIT NO.	19-2344
DATE PAID:	4126/19
FEE PAID:	60.00
RECEIPT #:	14/09/5

APPLICATION FOR CONSTRUCTION PERMIT
APPLICATION FOR: [] New System [] Existing System [] Holding Tank [] Innovative [] Repair [] Abandonment [] Temporary []
APPLICANT: Bobby Bowles
AGENT: NONE TELEPHONE: 606-875 - W40.
MAILING ADDRESS: 525 SW Birley AVE. LAKE City FL. 32024
TO BE COMPLETED BY APPLICANT OR APPLICANT'S AUTHORIZED AGENT. SYSTEMS MUST BE CONSTRUCTED BY A PERSON LICENSED PURSUANT TO 489.105(3)(m) OR 489.552, FLORIDA STATUTES. IT IS THE APPLICANT'S RESPONSIBILITY TO PROVIDE DOCUMENTATION OF THE DATE THE LOT WAS CREATED OR PLATTED (MM/DD/YY) IF REQUESTING CONSIDERATION OF STATUTORY GRANDFATHER PROVISIONS.
PROPERTY INFORMATION
LOT: BLOCK: SUBDIVISION: PLATTED:
PROPERTY ID #: 32-35-16-02420-00720NING: Residental/M OR EQUIVALENT: [Y N
PROPERTY SIZE: 10 ACRES WATER SUPPLY: [PRIVATE PUBLIC []<=2000GPD []>2000GPD
IS SEWER AVAILABLE AS PER 381.0065, FS? [Y / N] DISTANCE TO SEWER:FT
PROPERTY ADDRESS: 525 SW Birley AVE. Lake City Fl. 32024
DIRECTIONS TO PROPERTY: 90 West TO Rivley AVE. ON The JEFT
3-5 Miles From iH 75
BUILDING INFORMATION [] RESIDENTIAL [] COMMERCIAL
Unit Type of No. of Building Commercial/Institutional System Design No Establishment Bedrooms Area Sqft Table 1, Chapter 64E-6, FAC
Garage 0 1200 metal/concrete stab
3
4
-
[] Floor/Equipment Drains [] Other (Specify)
SIGNATURE: Bothy Bourles DATE: 4-25-2019

