
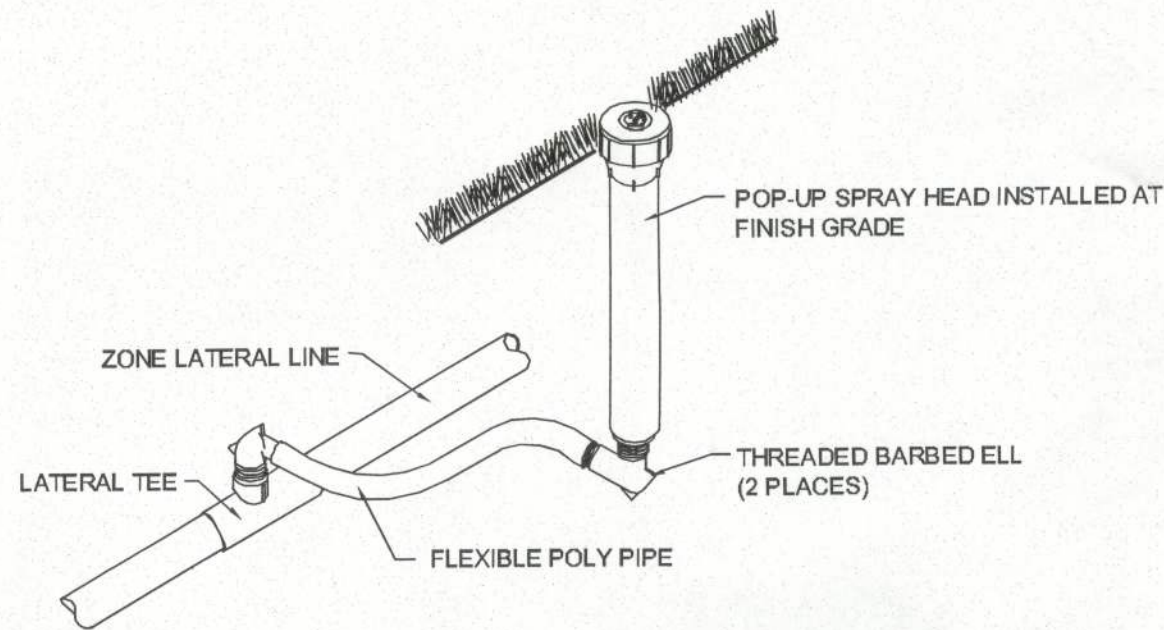


IRRIGATION_SCHEDULE


SYMBOL	MANUFACTURER/MODEL	ARC	PSI	GPM	RADIUS
■	Rain Bird 1806-PRS w/Maxijet ARCRHF09H	360	30	0.50	1'
SYMBOL	MANUFACTURER/MODEL/DESCRIPTION				
●	Rain Bird PGA in 12" Valve Box				
BF	Wilkins 975XL 1" Backflow Preventer				
C	Rain Bird ESP-3M 3 Station Controller				
R	Rain Bird RSD-BEx				
M	Water Meter 3/4" to produce 14gpm @ 50psi				
---	Irrigation Lateral Line: PVC Class 200 SDR 21				
---	Irrigation Mainline: PVC 1" Schedule 40				
---	Pipe Sleeve: PVC Schedule 40				
---	Extend sleeves 18 inches beyond edges of paving or construction.				

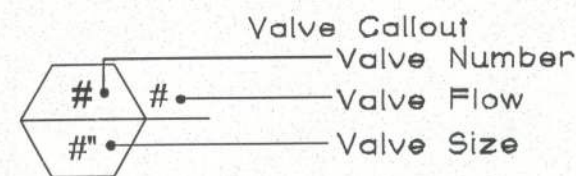

SPRAY HEAD INSTALLATION DETAIL



SCALE: NTS

PROVIDE MEASUREMENTS FROM 2 REFERENCE POINTS TO STUB UP ON THE AS-BUILD DRAWING

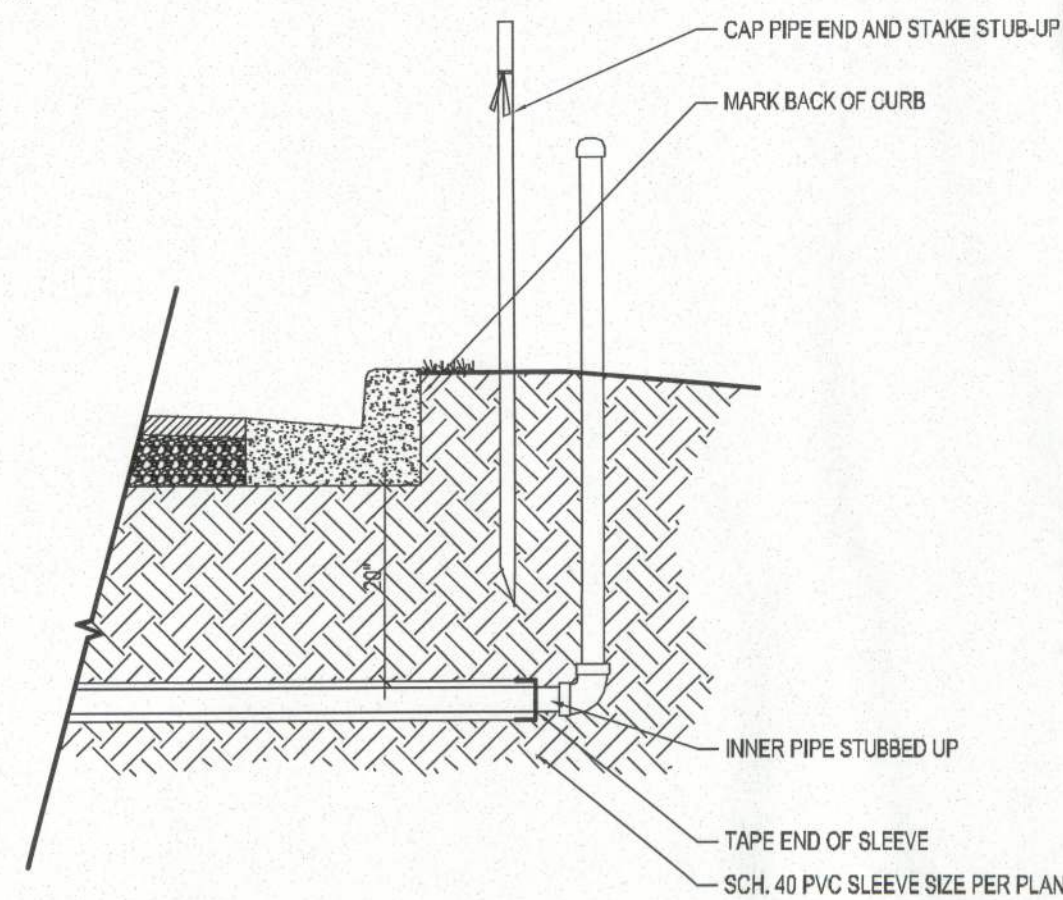

SLEEVING ROUGH-IN DETAIL

SCALE: NTS

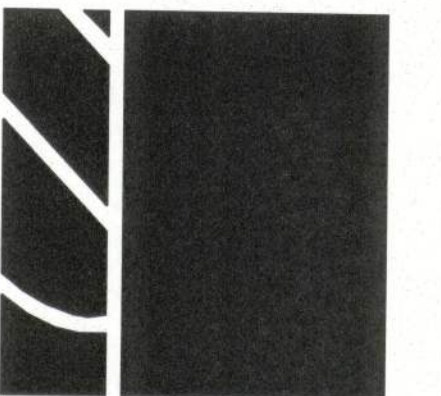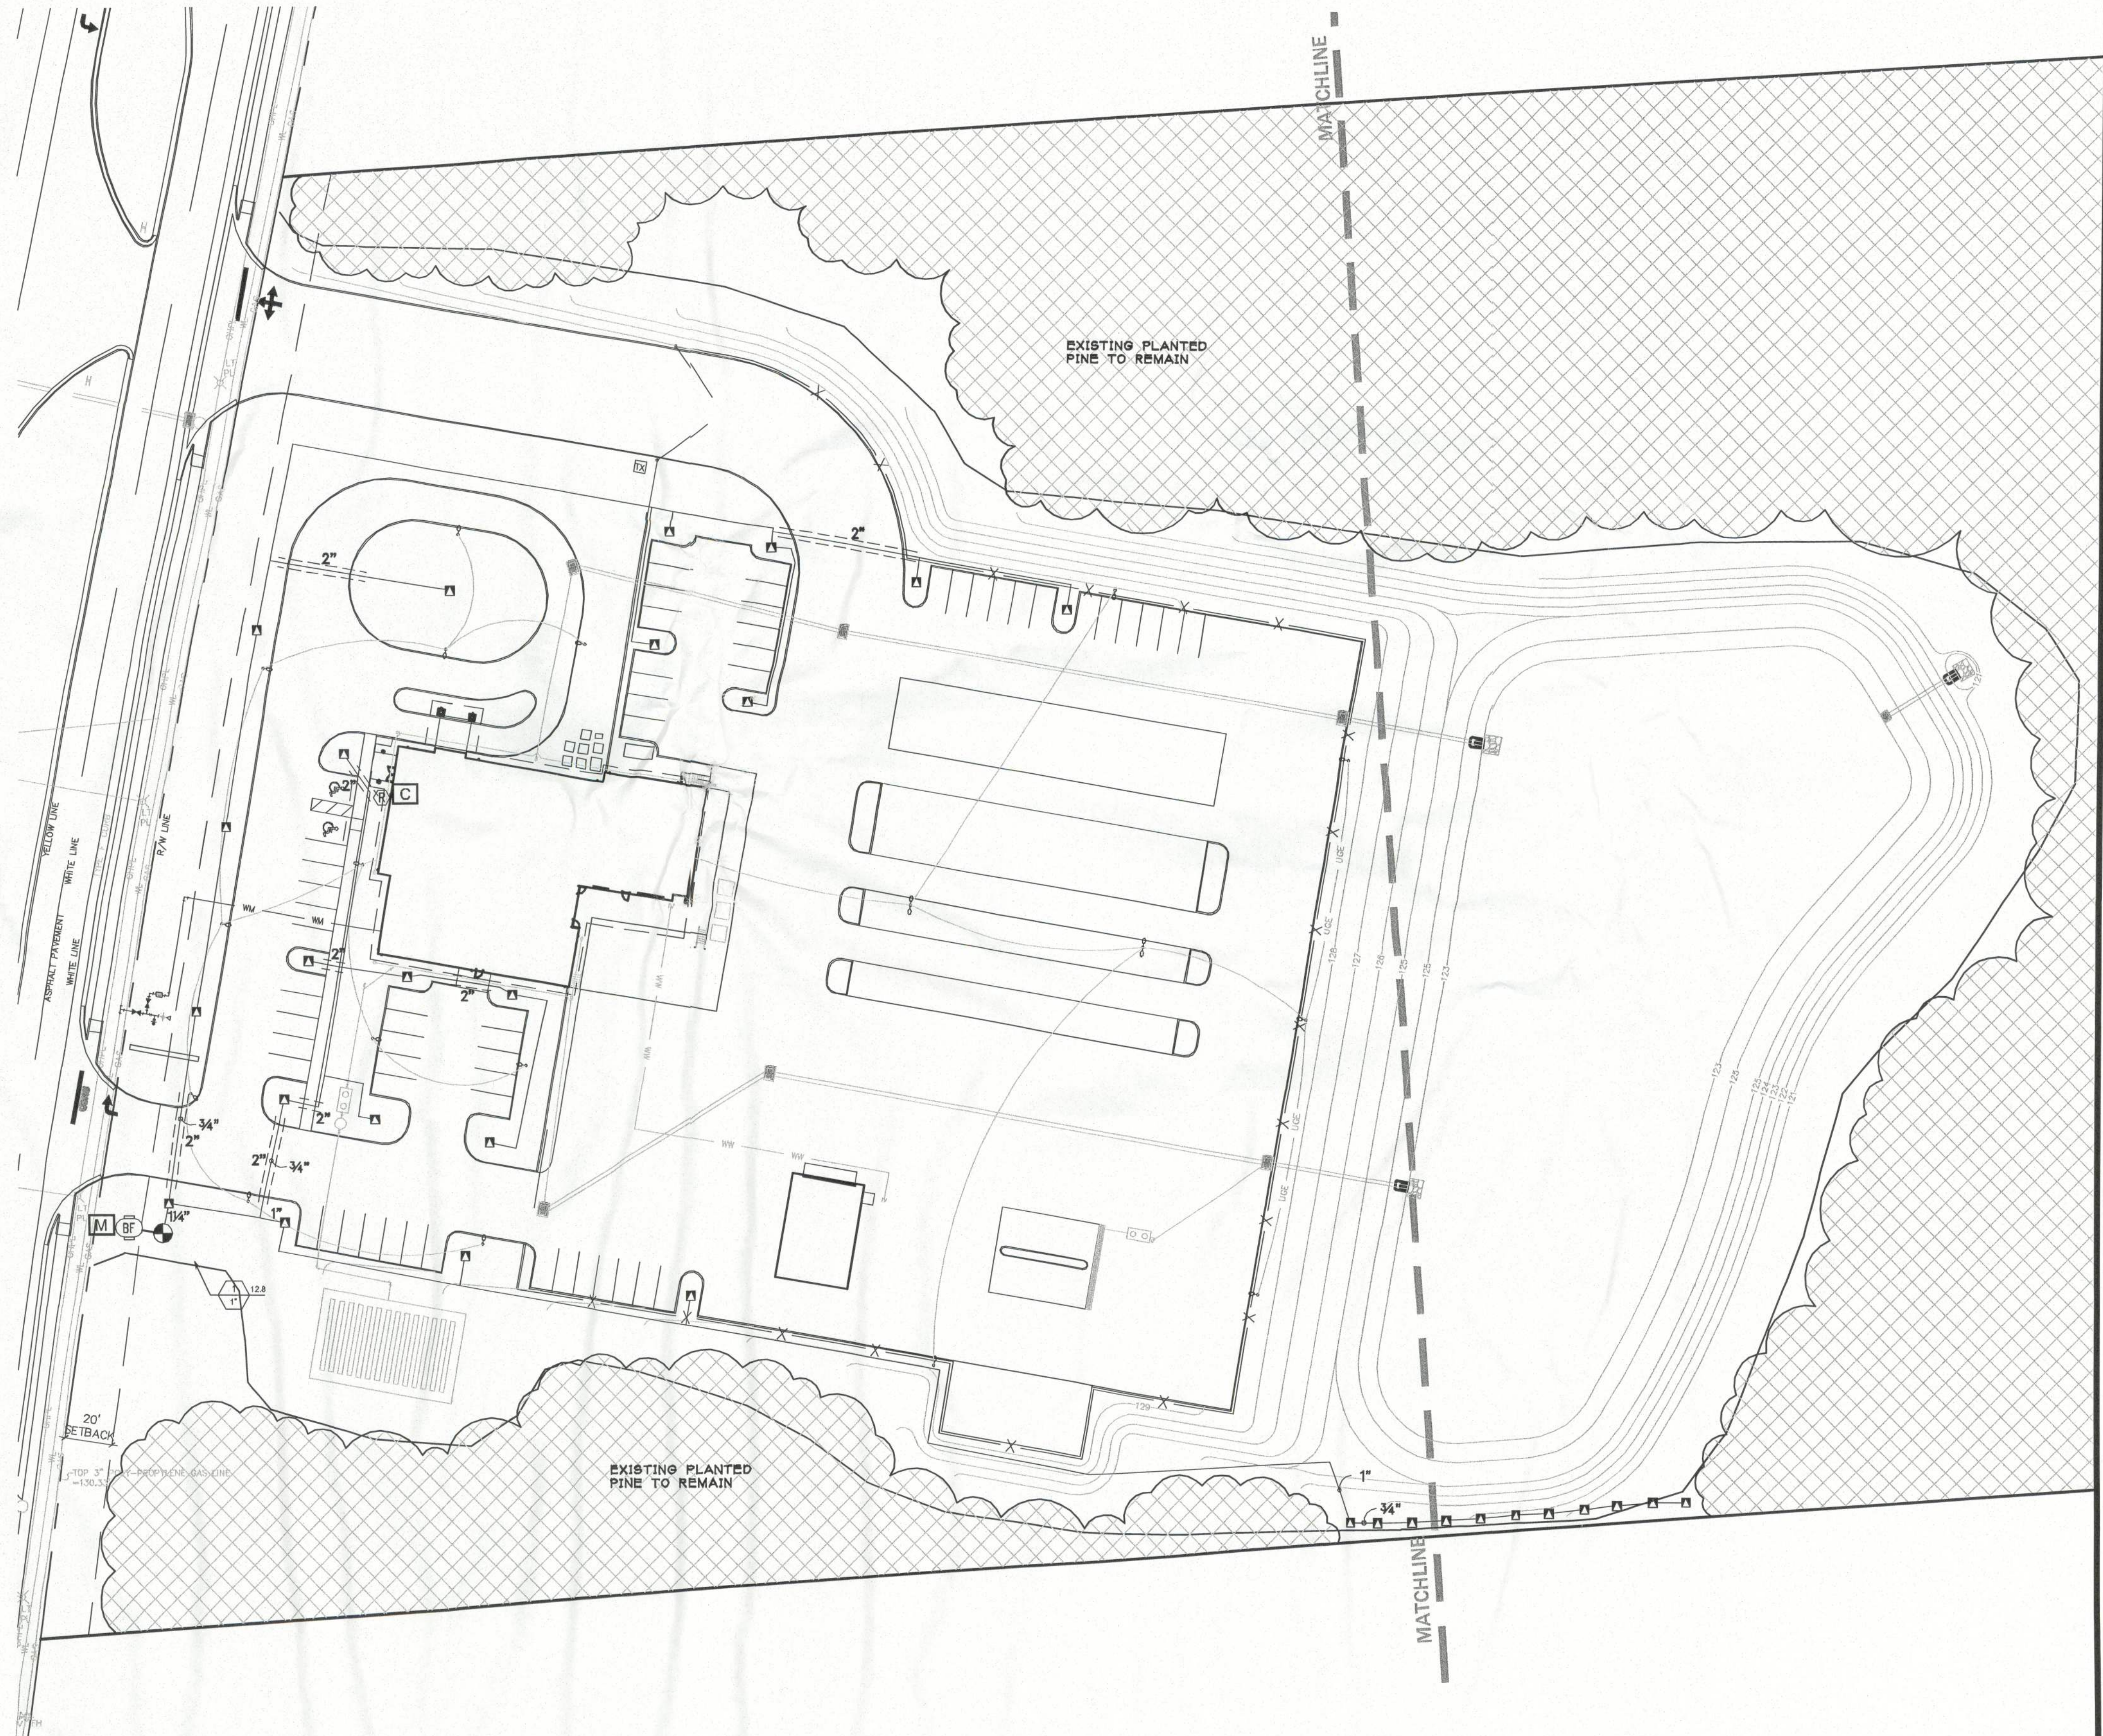

Buford Davis + Associates
 landscape architects site planners
 2406 NW 43rd Street
 Gainesville, Florida 32606
 352.335.1896 tel
 352.373.6407 fax

CLAY ELECTRIC
 HWY 47
 COLUMBIA COUNTY, FLORIDA

PROJECT TITLE & LOCATION:

IRRIGATION PLAN

SHEET TITLE:

SEAL:

DRAWN BY: JAC
 CHECKED BY: EJB3
 DATE: 02-03-12
 REVISIONS: 02-17-12
 02-20-12

DRAWING SCALE: 1"=40'
 PROJECT NUMBER: 11-009
 SHEET: IR-1