

-5.5" SPRAY FOAM INSULATION

PRE-ENGINEERED WOOD ROOF TRUSSES AT 24" O.C. SELECT TRUSS CONNECTORS FROM THE ANCHOR TABLE PER TRUSS UPLIFT LOADS

SEE EXT. ELEVATIONS

PREFINISHED ALUMINUM DRIP

ALUMINUM FASCIA

ON PT 2x 6 SUB-FASCIA

-2X4/6 PRECUT STUDS AT 16" O.C.

-3.5" SPRAY FOAM INSULATION

TYPICAL EXTERIOR FINISH SHOWN SEE CONTRACT FOR SPECIFICATIONS

-4" CONCRETE FLOOR SLAB

-2X4/6 P.T. PINE SOLE PLATE

CONCRETE BLOCK STEMWALL SEE ENGINEERING FOR SIZE AND REINFORCEMENT

APPROX. FINISH GRADE

-POURED CONCRETE STRIP FOOTING SEE ENGINEERING FOR SIZE AND REINFORCEMENT

R302.5.1 Openg protection:

SEPARATION

assemblies used fceparation

required by this seen

TABLE R302.0WELLING/GARAGE SEPARATION:

MATERIAL

TYPICAL DESIGN WALL SECTION

1" = 1'- 0"

NON - STRUCTURAL DATA

O.S.B. WALL SHEATHING

- PREFINISHED VENTED

ALUM SOFFIT SYSTEM —(2) 2X4/6 DOUBLE TOP PLATE

- ARCHITECTURAL SHINGLES OSB ROOF SHEATHING

1/2" GCB

NOTE: SEALALL
PENETRATIONS
IN TOP PLATE AND
FIRE STOP BLOCKING
WITH CODE APPROVED
SEALANT

REVISIONS

Adams Residence ADDRESS: 461 SW Pinehurst Drive Lake City, FL 32024 PARCEL ID#:


Group

22-4S-16-03087-112 Lot 12 Forest Country SD 6TH Addition Columbia County, FL PRINTED DATE:

Wednesday, August 5, 2020 DRAWN BY:

Matthew A. Erkinger Sr. DRAWING NUMBER


OF 3 SHEETS

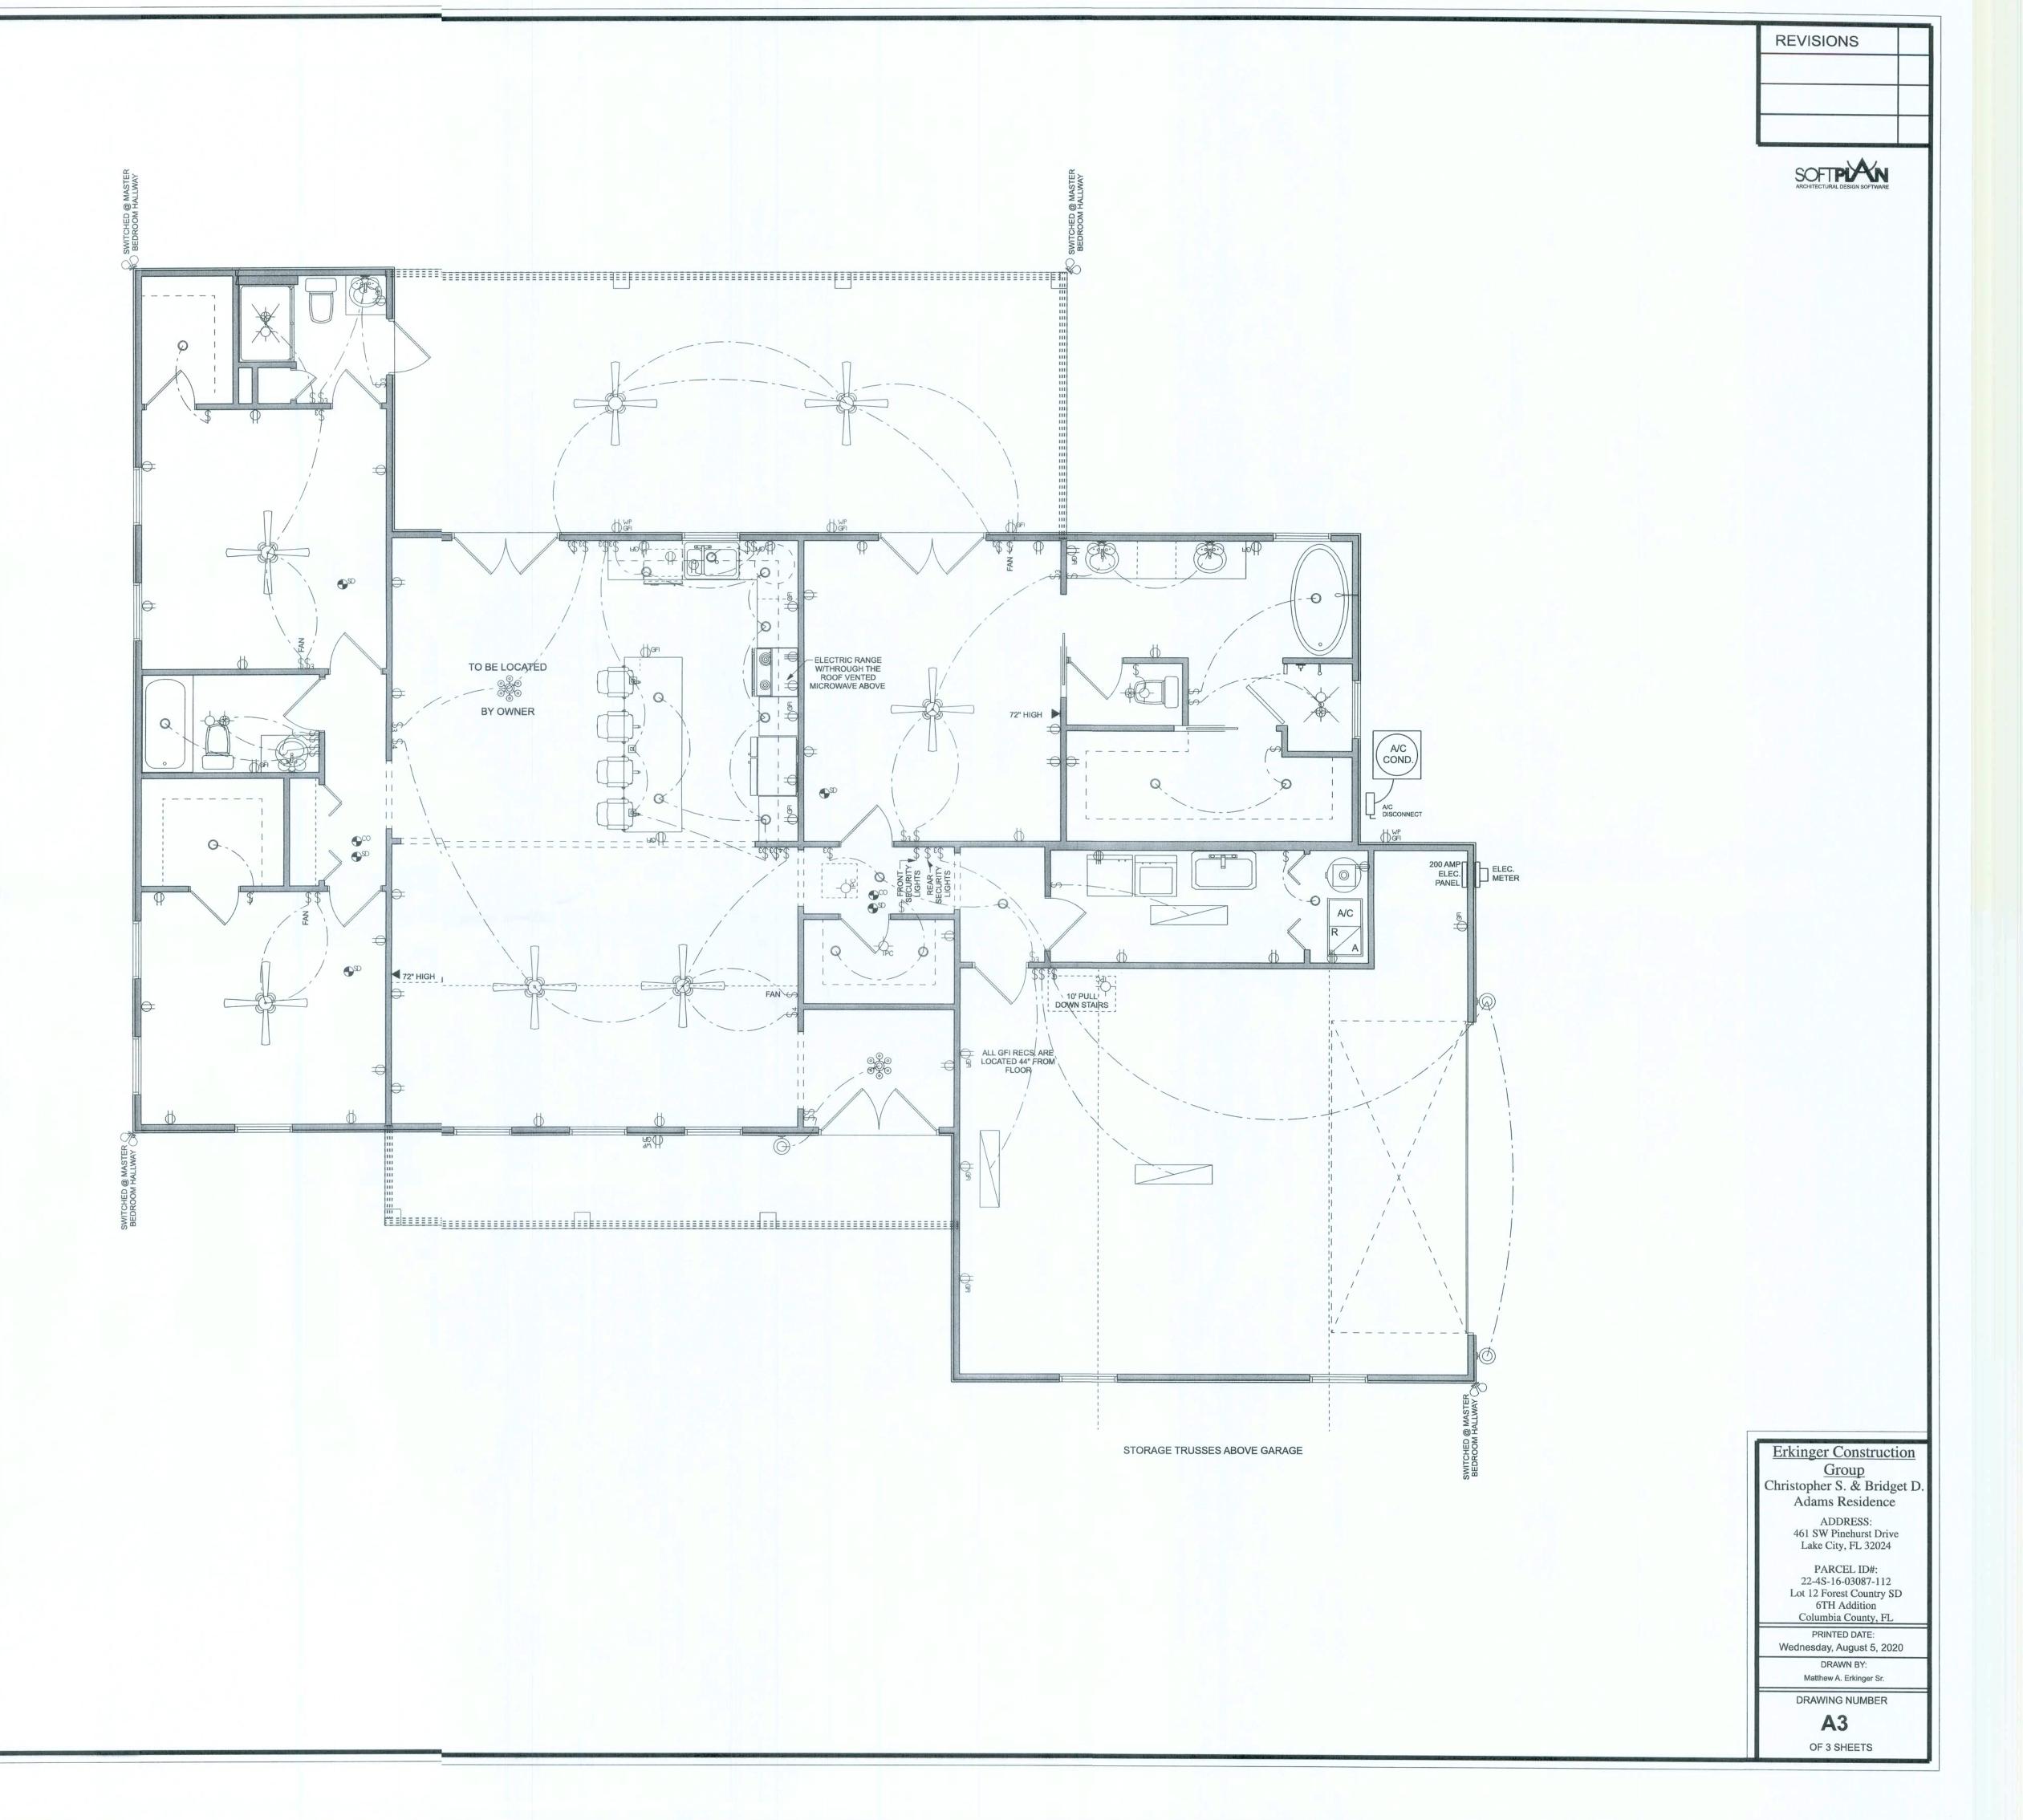


ELE(CTRICAL PLAN NOTES:
E - 1	WIRE ALL APPLIANCES, HVAC UNITS AND OTHER EQUIPMENT PER MANUF. SPECIFICATIONS.
E - 2	CONSULT THE OWNER FOR THE NUMBER OF SEPERATE TELEPHONE LINES TO BE INSTALLED.
E - 3	ALL INSTALLATIONS SHALL BE PER NAT'L. ELECTRIC CODE.
E-4	ALL SMOKE DETECTORS SHALL BE 120V W/ BATTERY BACKUP OF THE PHOTOELECTRIC TYPE, AND SHALL BE INTERLOCKED TOGETHER. INSTALL INSIDE AND NEAR ALL BEDROOMS.
E - 5	TELEPHONE, TELEVISION AND OTHER LOW VOLTAGE DEVICES OR OUTLETS SHALL BE AS PER THE OWNER'S DIRECTIONS, & IN ACCORDANCE W/ APPLICABLE SECTIONS OF NEC-LATEST EDITION.
E - 6	ELECTRICAL CONT'R SHALL BE RESPONSIBLE FOR THE DESIGN & SIZING OF ELECTRICAL SERVICE AND CIRCUITS.
E - 7	ENTRY OF SERVICE (UNDERGROUND OR OVERHEAD) TO BE DETERMINED BY POWER COMPANY.
E - 8	ALL 120-VOLT, SINGLE-PHASE, 15- AND 20-AMPERE BRANCH CIRCUITS SUPPLYING OUTLETS INSTALLED IN DWELLING UNIT FAMILY ROOMS, DINING ROOMS, LIVING ROOMS, PARLORS, LIBRARIES, DENS, BEDROOMS, SUN ROOMS, RECREATION ROOMS, CLOSETS, HALLWAYS, OR SIMILAR ROOMS OR AREAS SHALL BE PROTECTED BY A LISTED ARC-FAULT CIRCUIT INTERRUPTER, COMBINATION-TYPE INSTALLED TO PROVIDE PROTECTION OF THE BRANCH CIRCUIT.
E-9	ALL OUTLETS TO BE LOCATED ABOVE BASE FLOOD ELEVATION
	A SERVICE DISCONNECT WITH OVER CURRENT PROTECTION SHALL BE INSTALLED OUTSIDE OF THE BUILDING, ON THE LOAD SIDE OF THE METER, AT THE PLACE ELECTRIC CONDUCTORS ENTER THE BUILDING. SERVICE ENTRANCE CONDUCTORS MAY NOT BE LOCATED INSIDE OF THE OF THE BUILDING WITHOUT SPECIAL APPROVAL OF THE BUILDING OFFICIAL
E - 11	CARBON MONOXIDE ALARMS SHALL BE REQUIRED WITHIN 10' OF ALL ROOMS FOR SLEEPING PURPOSES IN BUILDINGS HAVING A FOSSIL-FUEL-BURNING HEATER OR APPLIANCE, A FIREPLACE, OR ATTACHED GARAGE.
	ALL OUTLETS LOCATED IN DESIDENTIAL


E - 12 ALL OUTLETS LOCATED IN RESIDENTIAL TO BE TAMPER-RESISTANT PER NEC.


E - 13 A MINIMUM OF 75% OF PERMANENTLY INSTALLED LAMPS OR LIGHTING FIXTURES SHALL BE HIGH EFFICACY 2017 FBC EC SEC. R404.1

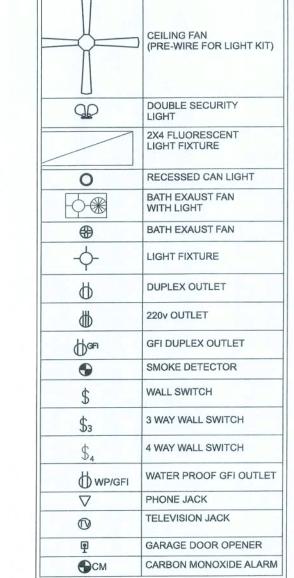

ELECTRICAL LEGEND

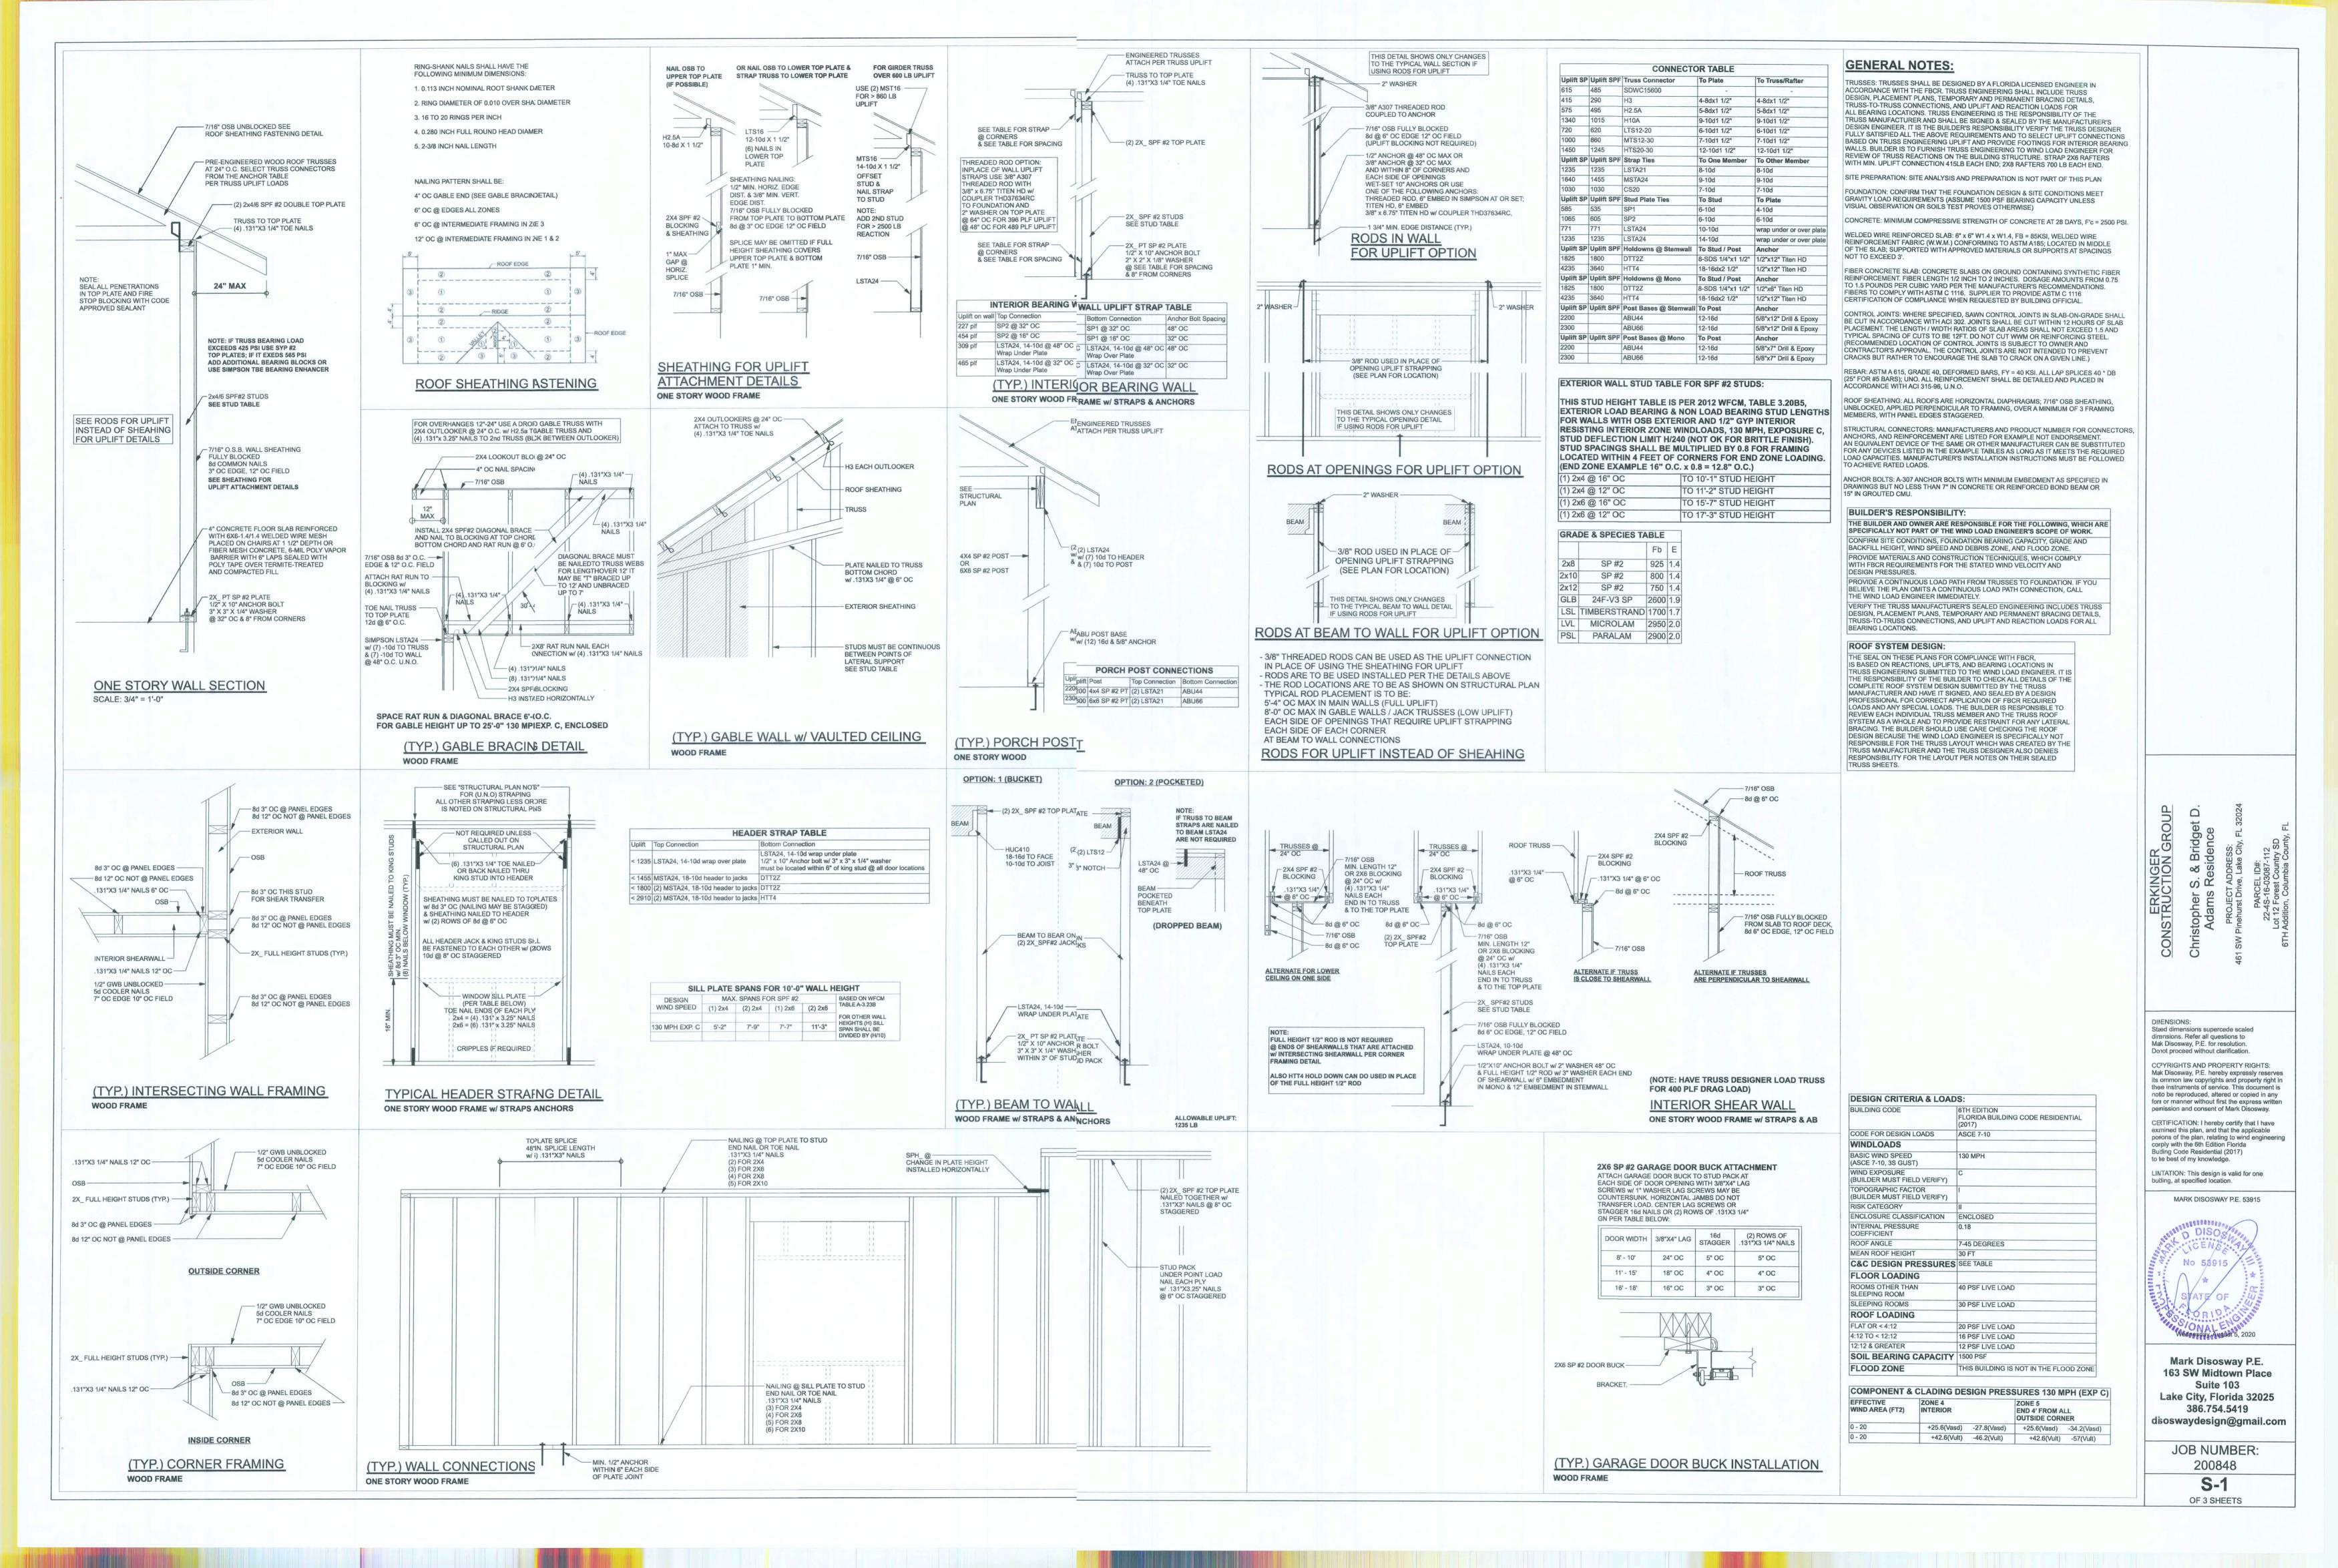

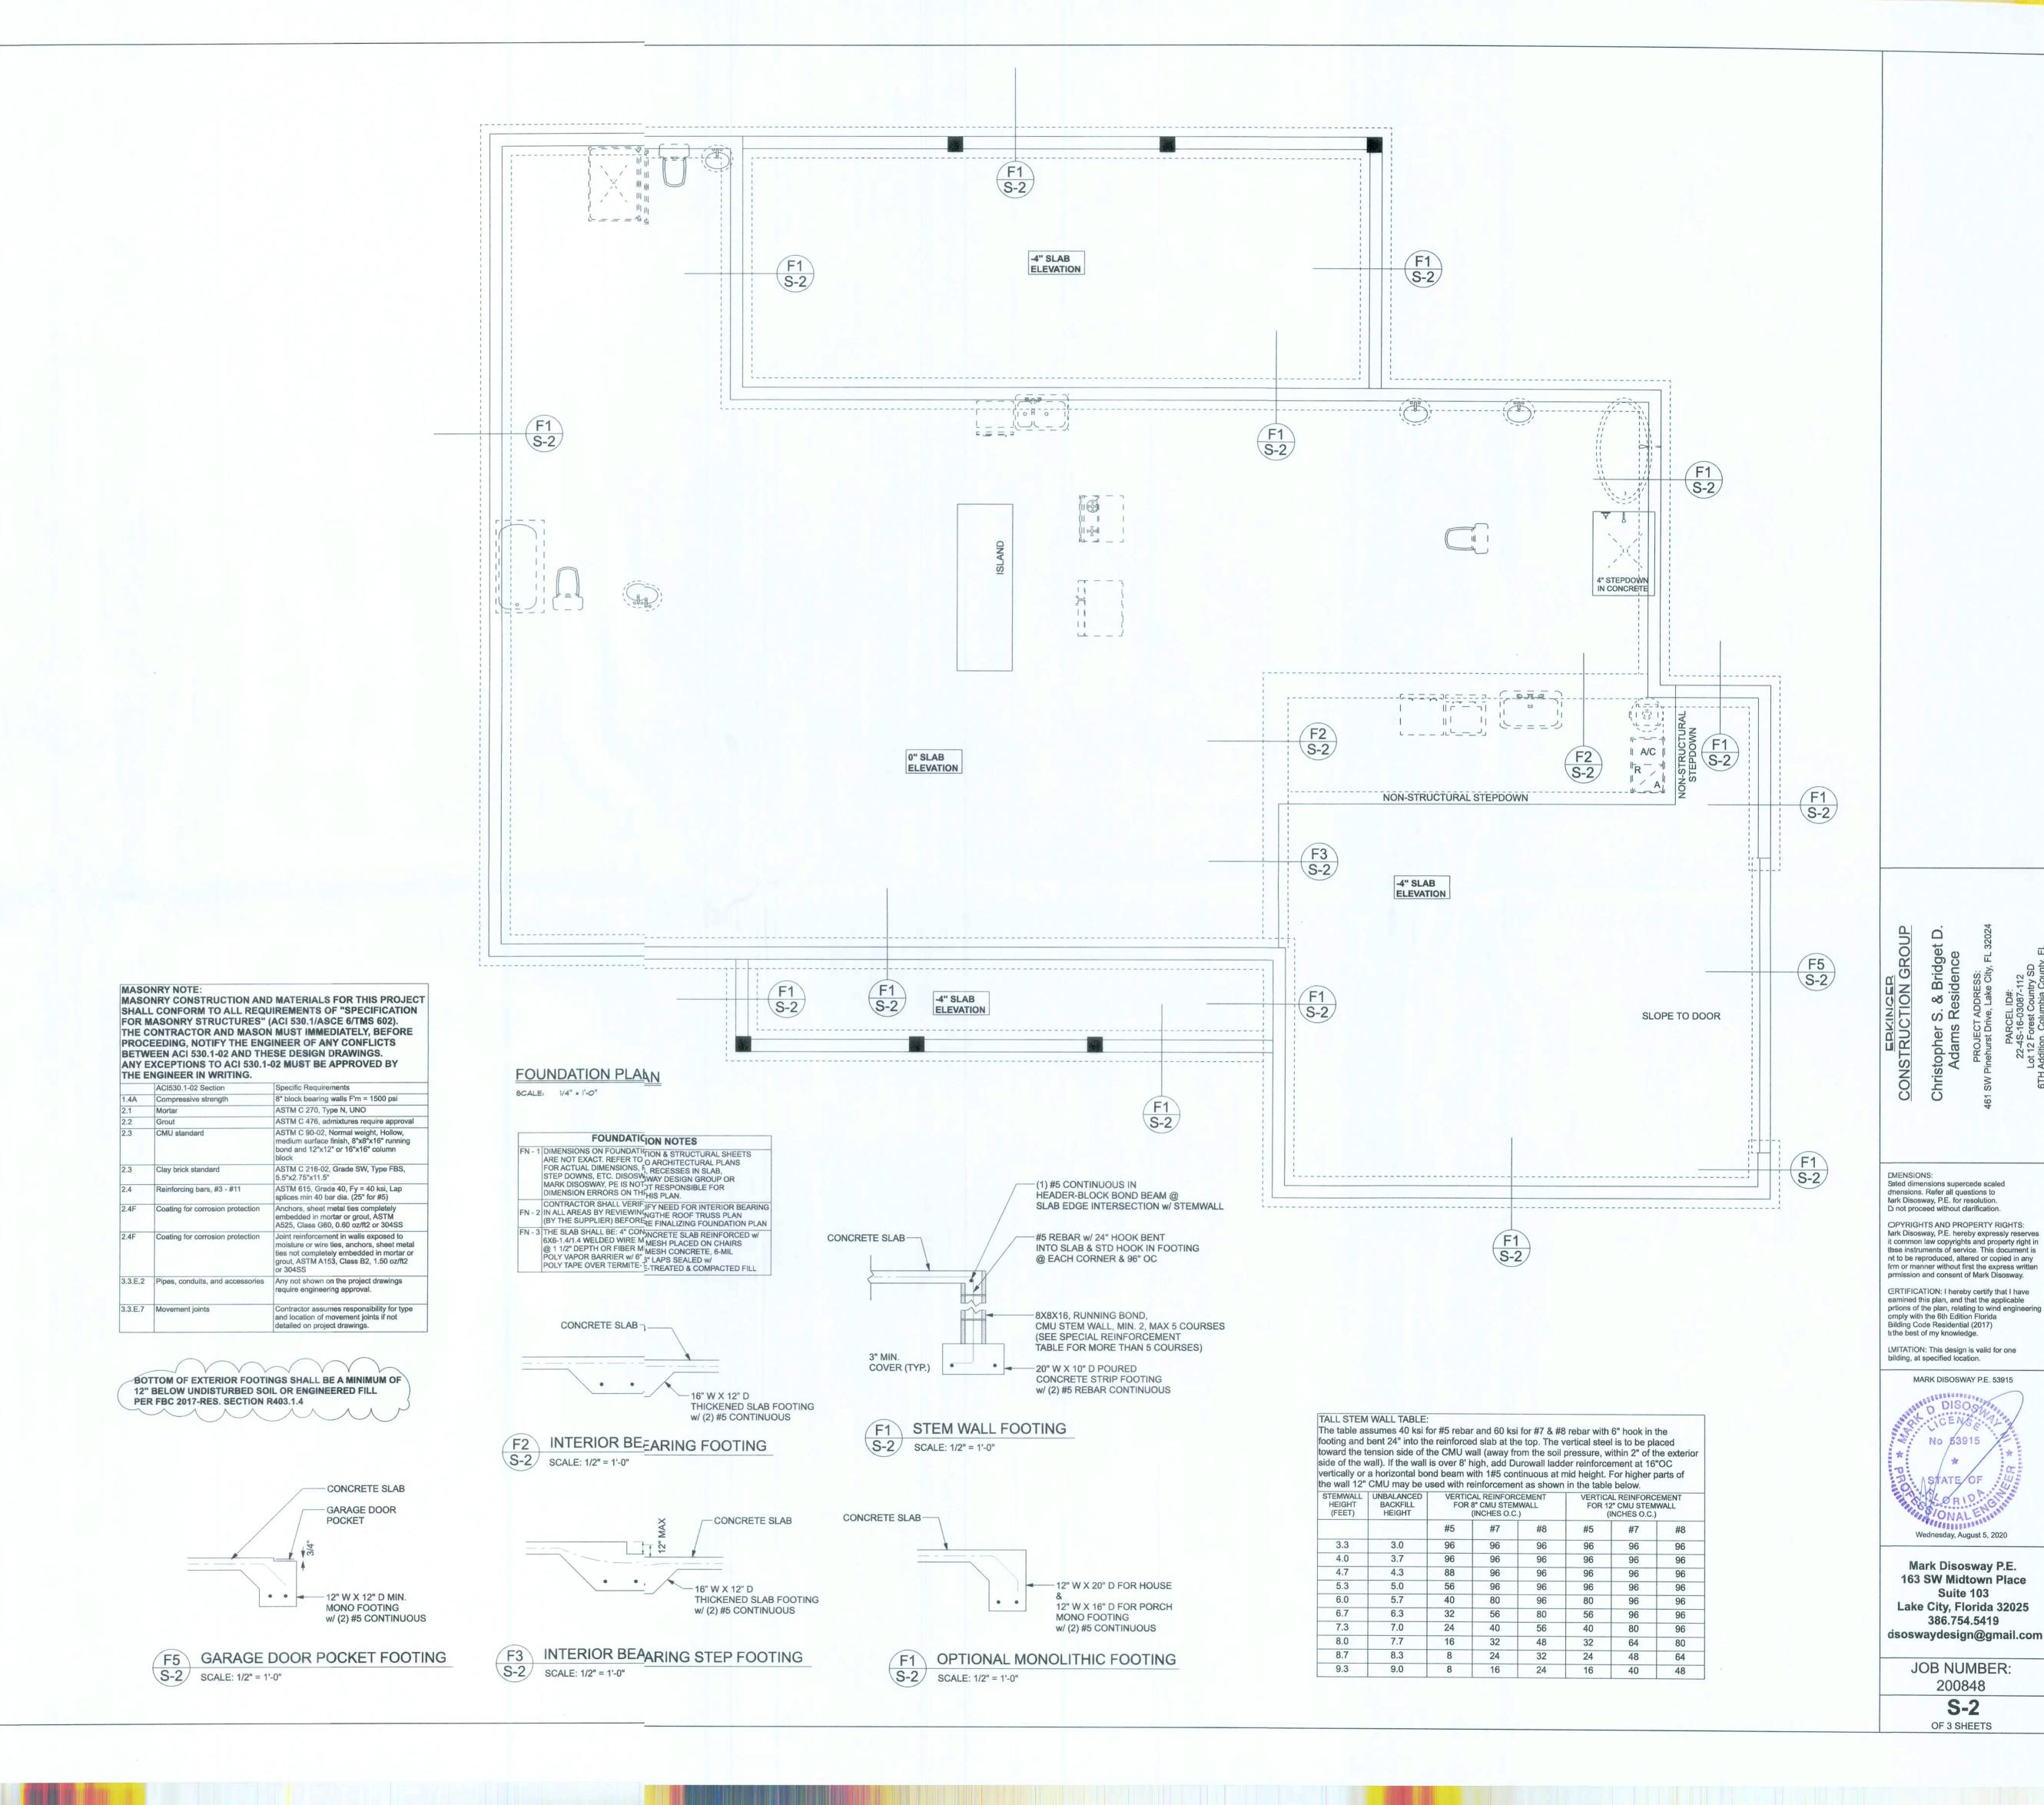

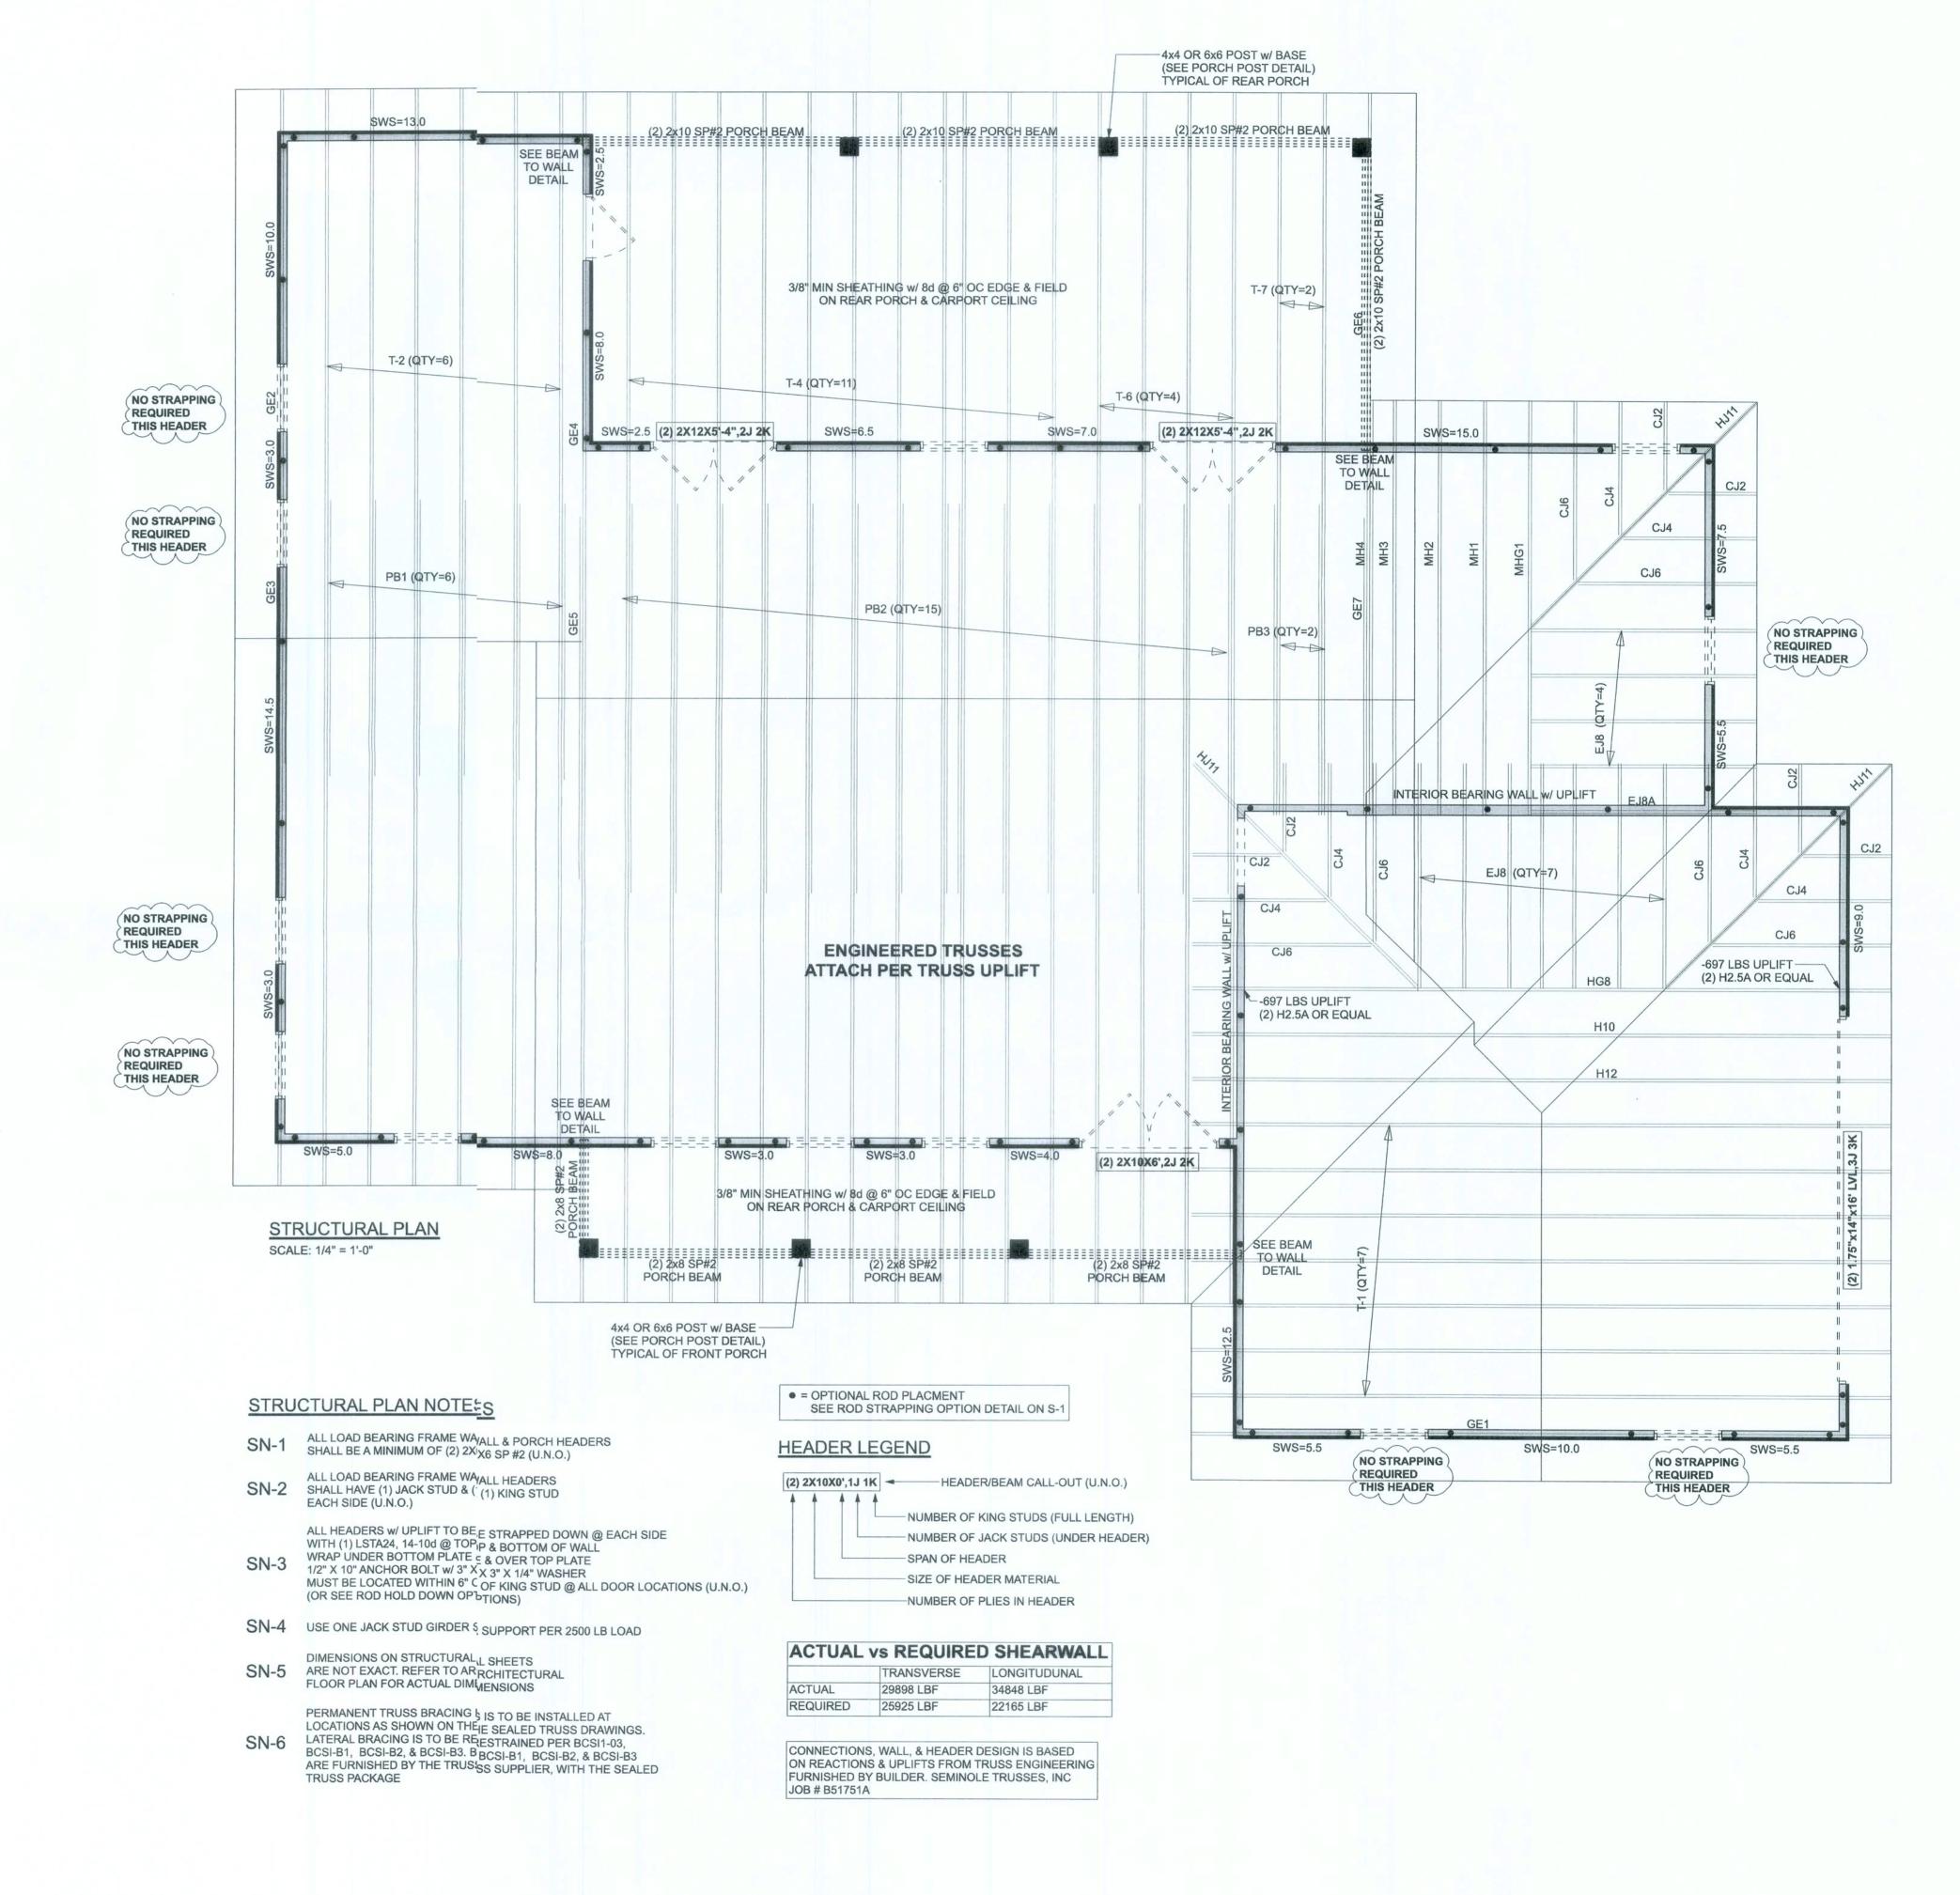

ERKINGER NOTRUCTION GROUP

DIMPOSIONS:
State dimensions supercede scaled dimesions. Refer all questions to MarkDisosway, P.E. for resolution.
Do nt proceed without clarification.

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CER'IFICATION: I hereby certify that I have
examed this plan, and that the applicable
portions of the plan, relating to wind engineering
compy with the 6th Edition Florida

portics of the plan, relating to wind engine compy with the 6th Edition Florida Buildng Code Residential (2017) to the best of my knowledge.

LIMI ATION: This design is valid for one

buildig, at specified location.

MARK DISOSWAY P.E. 53915



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JOB NUMBER: 200848

S-3
OF 3 SHEETS