



SOFTPIAN ARCHITECTURAL DESIGN SOFTWARE

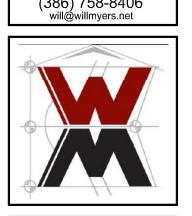

JOB NUMBER
20230120
DATE:
January 23, 2023

SHEET NUMBER

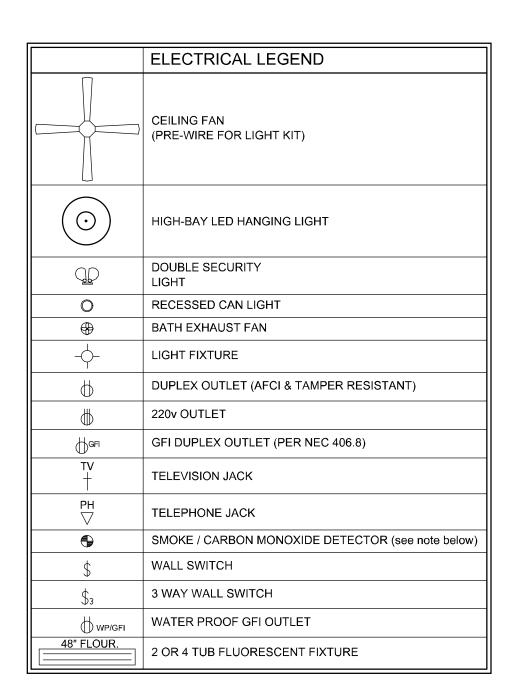


ALL INTERIOR RECEPTACLES SHALL BE AFCI (ARC FAULT CIRCUIT INTERRUPT) PER NEC 210.12 & TAMPER RESISTANT PER NEC 406.11

ALL INTERIOR & EXTERIOR LIGHTING SHALL MEET OR EXCEED THE MIN. 75% HIGH-EFFICIENCY LIGHTING PER FBC-ENERGY CONSERVATION R404.

ALL SMOKE DETECTORS BE A COMBO SMOKE & CARBON MONOXIDE DETECTOR AND SHALL HAVE BATTERY BACKUP POWER AND ALL WIRED TOGETHER SO IF ANY ONE UNIT IS ACTUATED THEY

THE ELECTRICAL SERVICE OVERCURRENT PROTECTION DEVICE SHALL BE INSTALLED ON THE EXTERIOR OF STRUCTURES TO SERVE AS A DISCONNECT MEANS. CONDUCTORS USED FROM THE EXTERIOR DISCONNECTING MEANS TO A PANEL OR SUB PANEL SHALL HAVE FOUR-WIRE CONDUCTORS, OF WHICH ONE CONDUCTOR SHALL BE USED AS AN EQUIPMENT GROUND.

IT IS THE LICENSED ELECTRICAL CONTRACTORS RESPONSIBILITY TO INSURE THAT ALL WORK PERFORMED AND EQUIPMENT INSTALLED MEETS OR EXCEEDS THE 2017 (NFPA-70) NATIONAL ELECTRIC CODE AND ALL OTHER LOCAL CODES AND ORDINANCES.

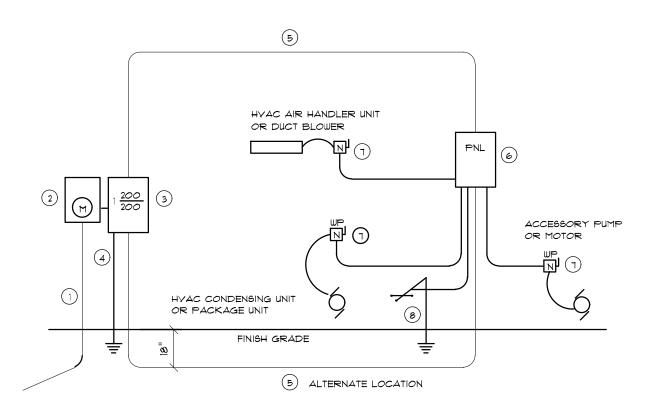


- Service/Feeder Entrance Conductors: 2" rigid conduit, min.


  18" deep, w/ continuous Ground Bonding Conductor, Service/ Entrance Conductors shall not be spliced except that bolted connections at the Meter, Disconnecting Devices and Panel shall be allowed.
- 2 Meter Enclosure, weatherproof, U.L. Listed.
- 3) Main Disconnect Switch: fused or Main BRKR, weatherproof, U.L. Listed.
- Grounding Conductor shall be bonded to each piece of Service/ Entrance Equipment, and shall be sized per Item \*5, below.
- 5 200 AMPERE SERVICE: 3-\*2/0-USE-Cu, 1-\*4-Cu-GND, 2" Conduit.
- 6 House Panel (PNL), U.L. Lised, sized per schedule. Equipment Disconnect Switch: non-fused, in weatherproof
- enclosure, size according to Panel Schedule loads.
- (8) Provide Ground Bond Wire to metal piping, size in accordance with the Service Ground Conductor.

THE MINIMUM AIC RATING FOR PANEL BOARDS, BRKRS AND DISCONNECT SWITCHES SHALL BE 22,000 AIC.

ELECTRICAL RISER DIAGRAM: 200A SCALE: NONE

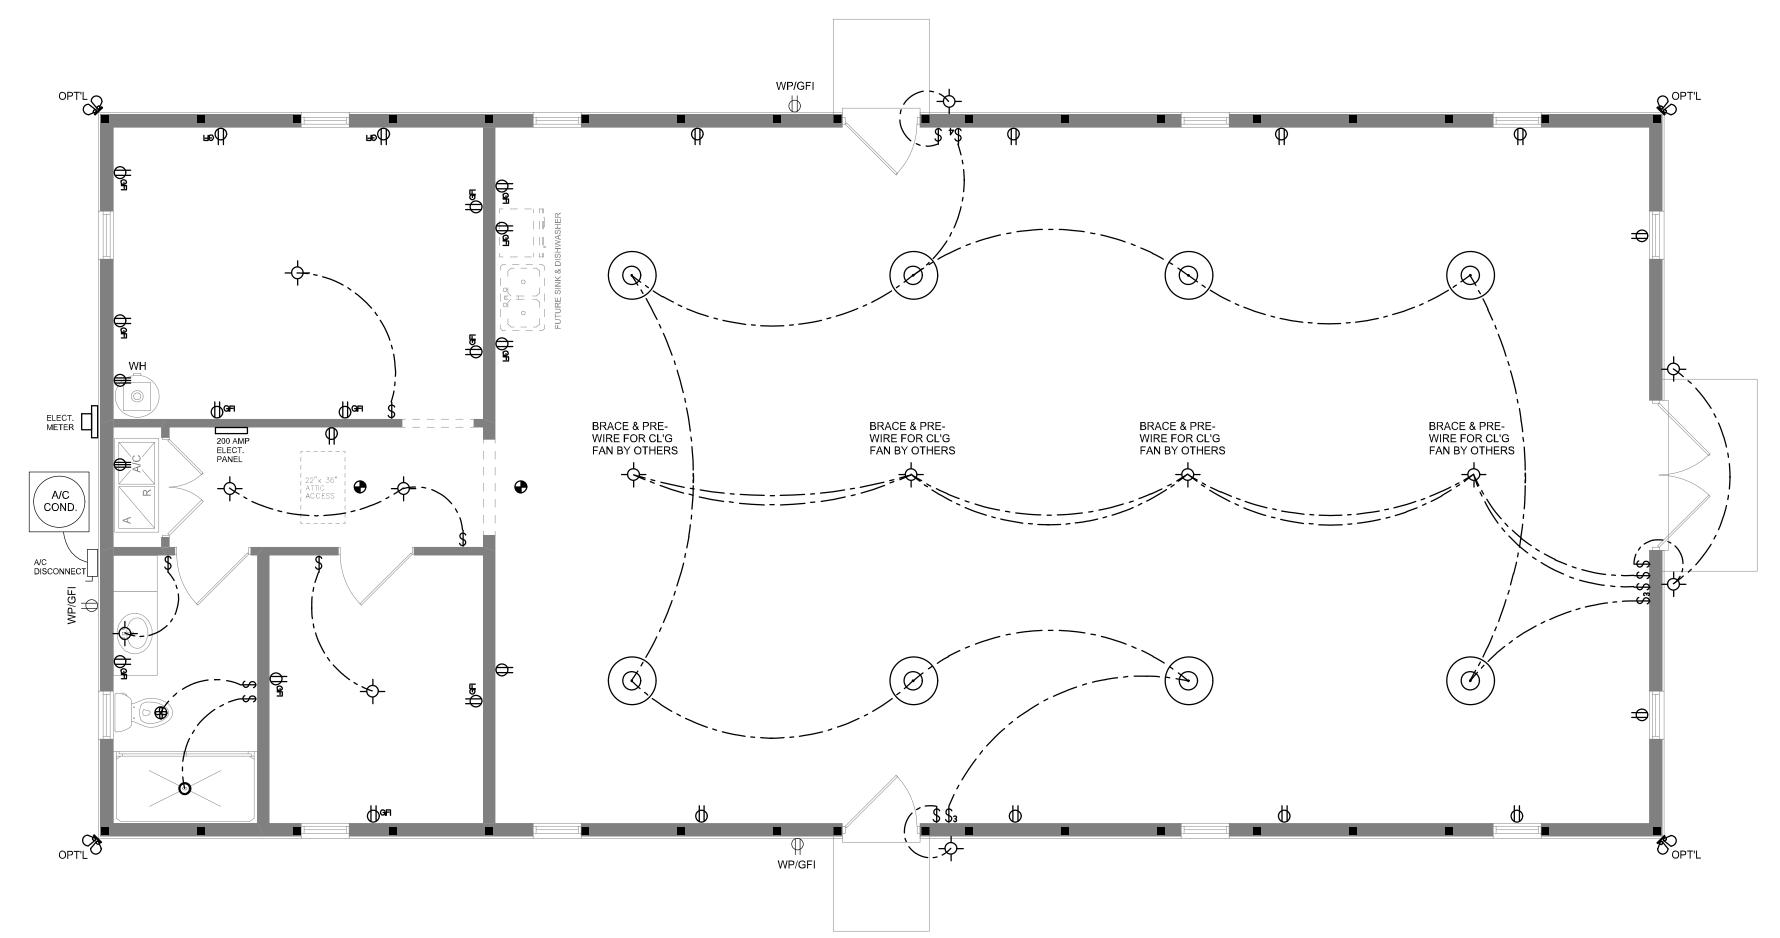



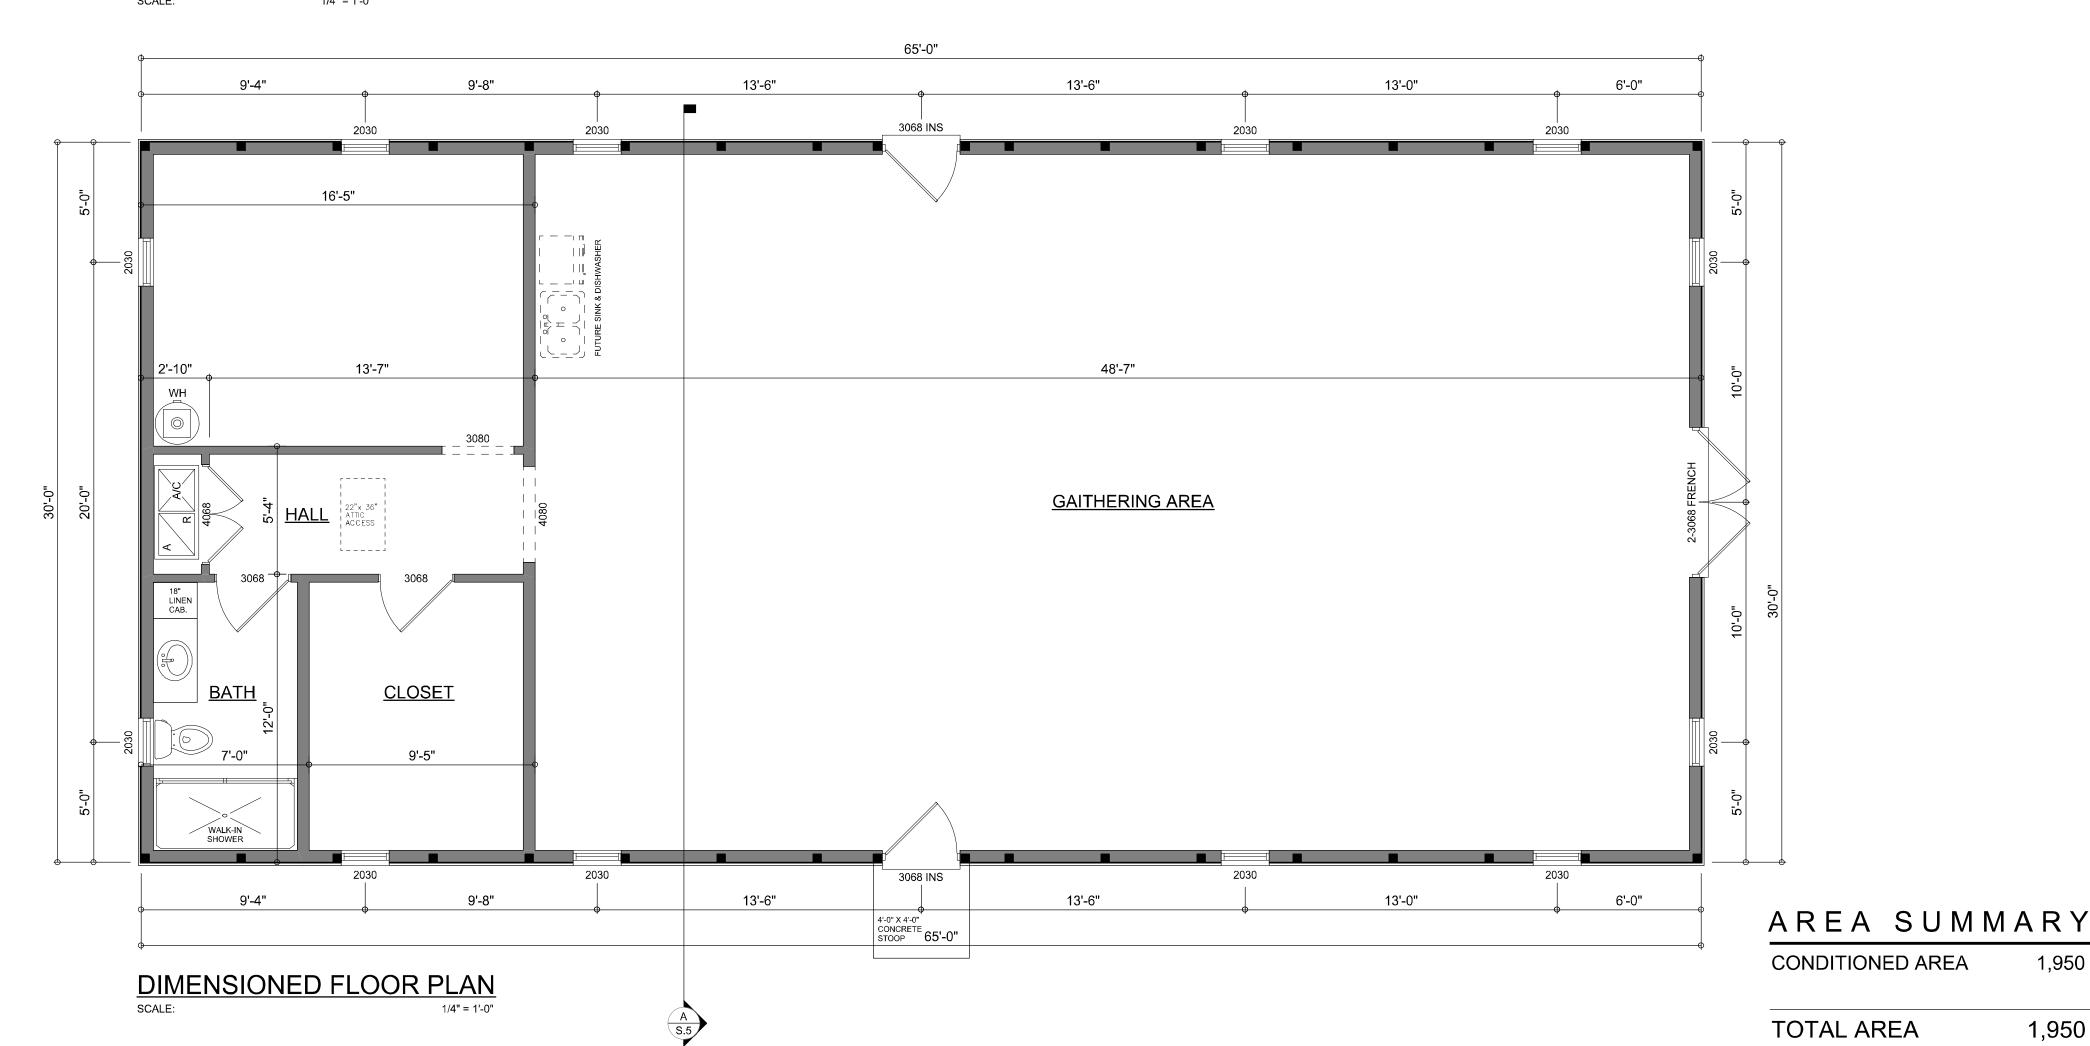

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AR0007005 OU = ARCHITECT Date: 2023.02.14 10:31:44 -05'00'



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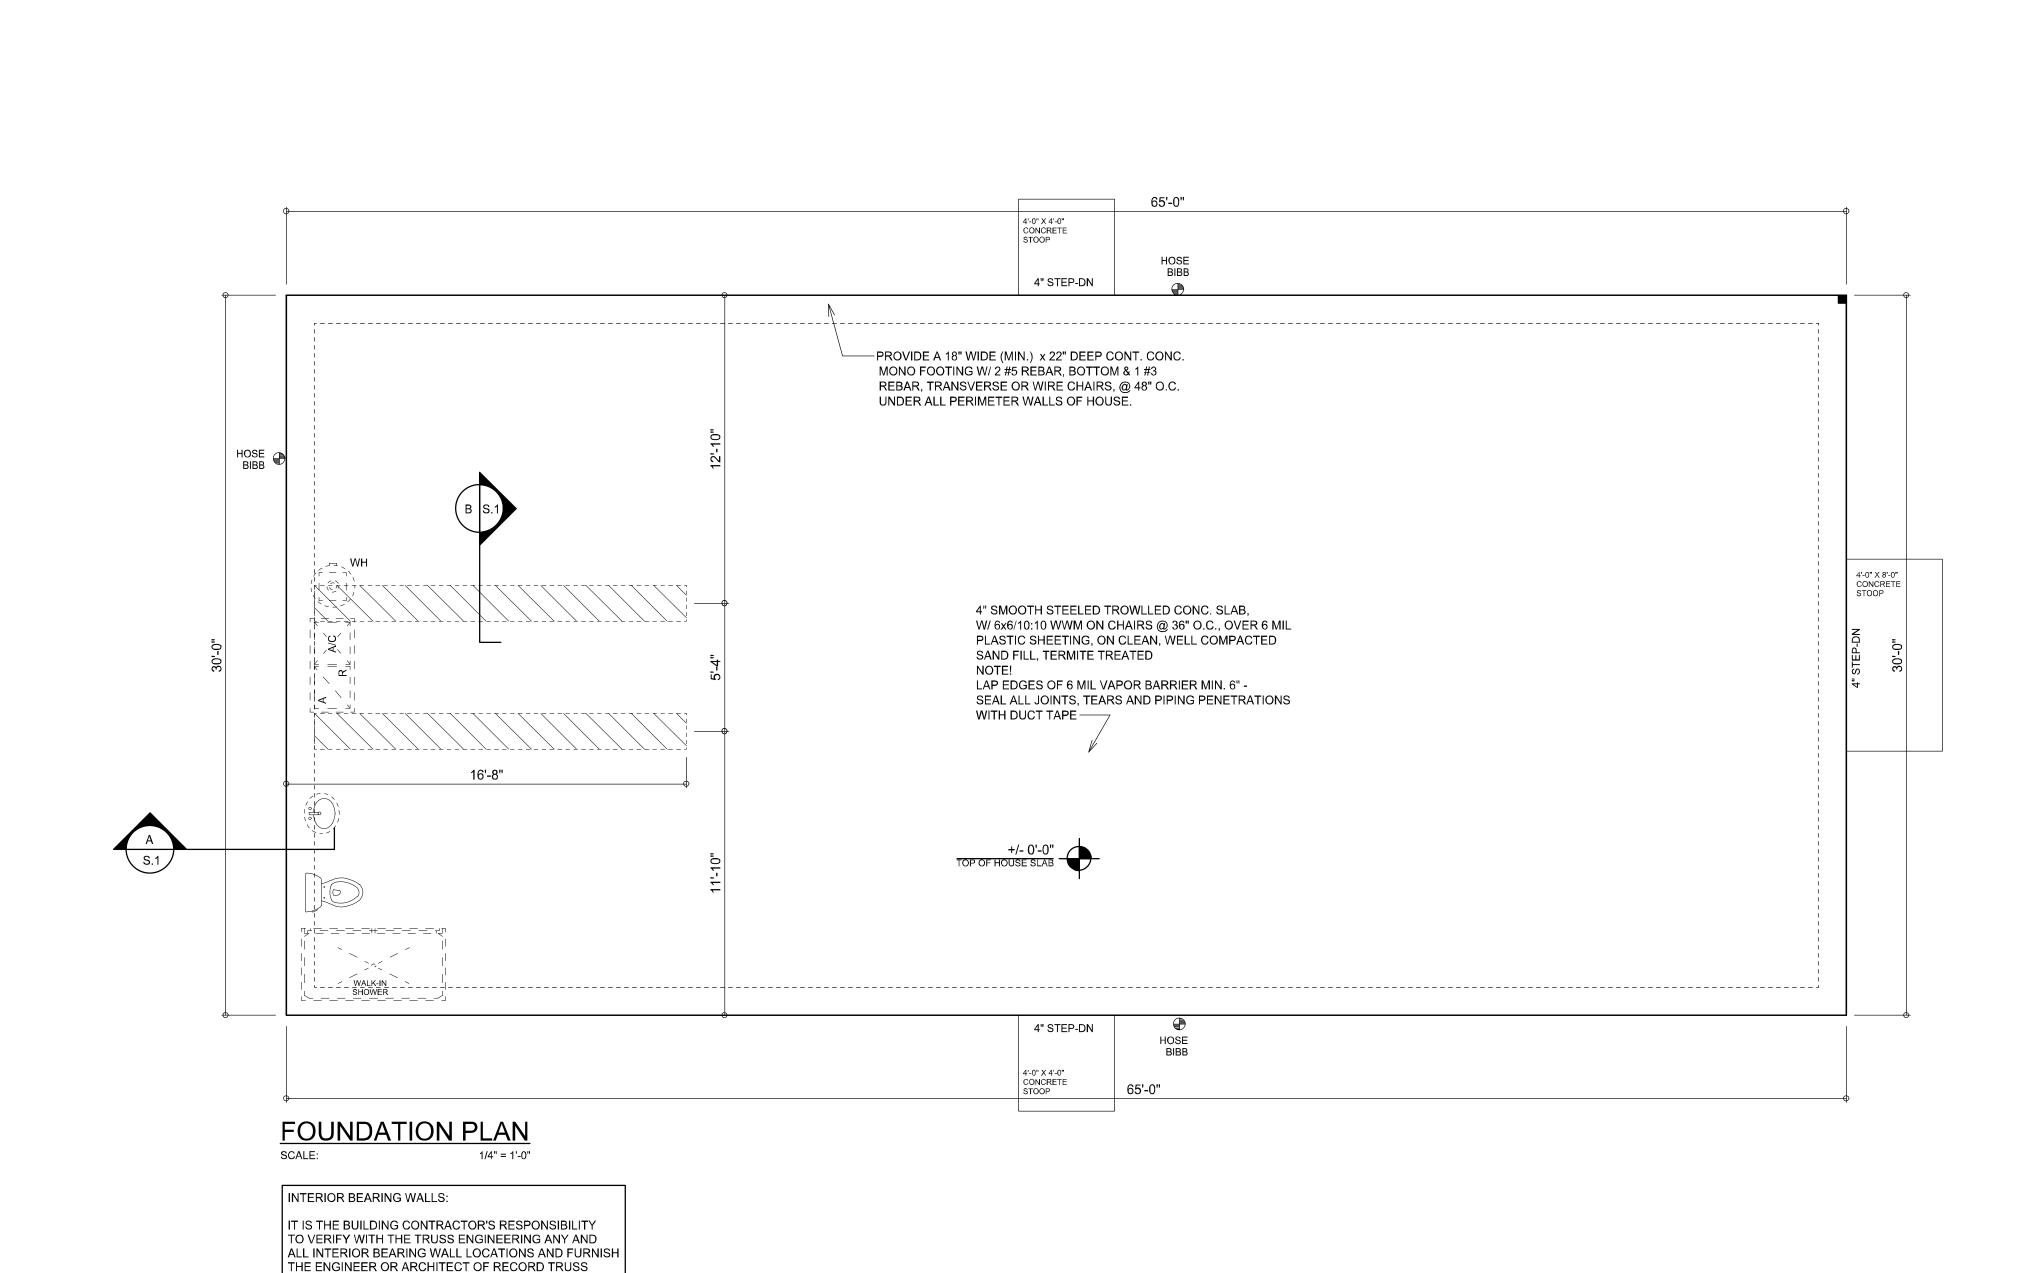


JOB NUMBER 20230120 DATE: January 23, 2023

1,950 S.F.

1,950 S.F.

SHEET NUMBER **A.2** 



INFO SO THICKENED FOOTING'S CAN BE SIZED AND

PRIOR TO THE CONSTRUCTION OF THE FOUNDATION,

THE CONTRACTOR SHALL COORDINATE ANY INTERIOR BEARING LOCATION CONDITIONS PER THE TRUSS

ENGINEERED SHOP DRAWINGS WITH THE FOUNDATION PLAN. ANY INTERIOR BEARING LOCATIONS OR ANY

POINT LOADS OF 4.0 K OR GREATER SHALL BE

PRIOR TO POURING ANY CONCRETE.

SUPPORTED VIA A MODIFIED FOUNDATION PLAN

TAKING THESE LOADS INTO CONSIDERATION. THE CONTRACTOR SHALL MAKE THE ENGINEERED TRUSS

SHOP DRAWINGS AVAILABLE TO THE ARCHITECT FOR

THE PURPOSE OF RENDERING SUCH MODIFICATIONS

LOCATED ON THE FOUNDATION PLAN.

### CONCRETE / MASONRY / METALS GENERAL NOTES:

- 1. DESIGN SOIL BEARING PRESSURE: 1000 PSF.
- 2. EXPANSIVE SOILS: WHERE DIRECTED BY THE SOILS ENGINEER, SOIL AUGMENTATION PER THE SOILS ENGINEER'S SPECIFICATIONS SHALL BE IMPLEMENTED PRIOR TO PLACING ANY FOUNDATIONS - TESTS AS SPECIFIED SHALL BE PREFORMED TO DETERMINE THE SUITABILITY OF THE SUB-GRADE TO SUPPORT THE DESIGN LOADS.
- CLEAN SAND FILL OVER STRIPPED AND COMPACTED EXISTING GD. SHALL BE PLACED IN 12" LIFTS. BOTH SUB-SOIL AND FILL COMPAC-TION SHALL BE NOT LESS THAN 98% AS MEASURED BY A MODIFIED PROCTOR TEST AT THE RATE OF ONE TEST FOR EACH 1500 SF OF BUILDING PAD AREA, OR FRACTION THEREOF, FOR EACH 12" LIFT.
- REINFORCING STEEL SHALL BE GRADE 60 AND MEET THE REQUIRE-MENTS OF ASTM A615, ALL BENDS SHALL BE MADE COLD.
- 5. WELDED WIRE MESH SLAB REINFORCING SHALL MEET THE REQUIRE-MENTS OF ASTM A185 - MIN. YEILD STRESS = 85 KSI.
- 6. CONCRETE SHALL BE STANDARD MIX F'c = 3000 PSI FOR ALL FTGS, SLABS, COLUMNS AND BEAMS OR SHALL BE STANDARD PUMP MIX F'c = 3000 PSI. STRENGTH SHALL BE ATTAINED WITHIN 28 DAYS OF PLACE-MENT. MIXING, PLACING AND FINISHING SHALL BE AS PER ACI STANDARDS.
- 7. CONCRETE BLOCK SHALL BE AS PER MANUFACTURER'S PRODUCT GUIDE FOR ASTM C-90 REQUIREMENTS WITH MEDIUM SURFACE FINISH F'm = 1500 PSI.
- 8. MORTAR SHALL BE TYPE "M" OR "N" FOR ALL MASONRY UNITS.
- 9. STRUCTURAL STEEL SHALL CONFORM TO ASTM A36 STANDARDS FOR STRENGTH, BOLTS SHALL BE ASTM A307 / GRADE 1 OR A325, AS PER PLAN REQUIREMENTS.
- 10. WELDS SHALL BE AS PER "AMERICAN WELDING SOCIETY" STANDARDS FOR STRUCTURAL STEEL APPLICATIONS.

— 4" THK. 3000 PSI CONCRETE SLAB

- 8" CMU BOND

@ 48" O.C.

(2) #5 BARS

SECTION (optional)

SCALE: 3/4" = 1'-0

CONTINUOUS

8" CMU

BEAM W/#5 BAR

CONT/25" MIN. LAP

#5 DOWELS @ 48" O.C. MAX.

#3 BARS HORIZ. OR CHAIRS

-3,000 PSI CONCRETE FOOTING


OVER 6 MIL POLY VAPOR BARRIER

W/ 6x6/10:10 WWM ON CHAIRS @ 36" O.C.,

OVER, TREATED, CLEAN COMPACTED FILL

—#5 ELLS X 18" X 18" @ 48" O.C. MAX.

11. 2X4 P/T WOOD SILL, CONT., ALL AROUND, W/ 5/8"~ A.B. W/ 3" SQ. X 1/4" PLATE WASHERS WITHIN 6" FROM EACH CORNER, EA. WAY, & WITHIN 6" FROM ALL WALL OPENINGS / ENDS - 1/2"~ A.B. W/ 2" SQ. WASHERS ALONG EACH RUN @ 48" O.C., MAX. - ALL ANCHOR BOLTS SHALL HAVE A MINIMUM OF 8" EMBEDMENT INTO THE CONCRETE.

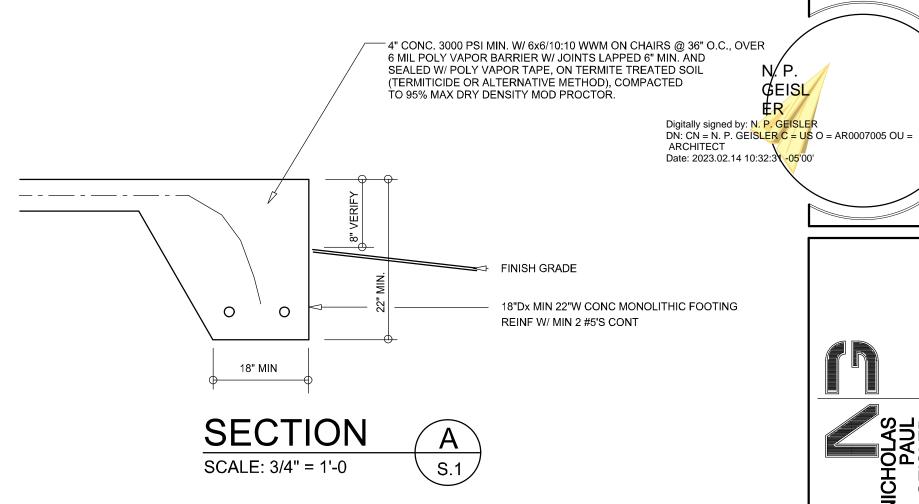

M BARN

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JOB NUMBER 20230120 DATE: January 23, 2023

SHEET NUMBER A.3

THE DESIGN WIND SPEED FOR THIS PROJECT IS 130 MPH PER 2020 FBC (7TH EDITION)

AND LOCAL JURISDICTION REQUIREMENTS

#### ADDED FILL SHALL BE APPLIED IN 8" LIFTS -EA. LIFT SHALL BE CONPACTED TO 98% DRY COMPACTION PER THE "MODIFIED PROCTOR"

PLUMBING CONTRACTOR SHALL PREPARE "AS-BUILT" SHOP DRAWINGS INDICATING ALL PLUMBING WORK, INCLUDING ALL PLUMBING LINE LOCATIONS AND RISER DIAGRAM - CONT'R

SHALL PROVIDE 1 COPY OF AS-BUILT DWGS TO OWNER AND

## 1 COPY TO THE PERMIT ISSUING AUTHORITY.

METHOD.

H.V.A.C. CONTRACTOR SHALL PREPARE "AS-BUILT" SHOP DRAWINGS INDICATING ALL H.V.A.C. WORK, INCLUDING ALL DUCTWORK LOC., SIZES, LINES, EQUIPMENT SCH. & BALANCING REPORT - CONT'R SHALL PROVIDE 1 COPY OF AS-BUILT DWGS TO OWNER & 1 COPY TO THE PERMIT ISSUING AUTHORITY.

-ALL MESH 6X6-10/10

6-MIL POLY VAPOR BARRIER

DOUBLE MESH ALONG EDGE -

24" WIDE — FULL PERIMETER

<sup>2</sup> − # 5'S, CONTINUOUS

ALL CONCRETE 2500 PSI

COMPRESSIVE STRENGTH

AT 28 DAYS


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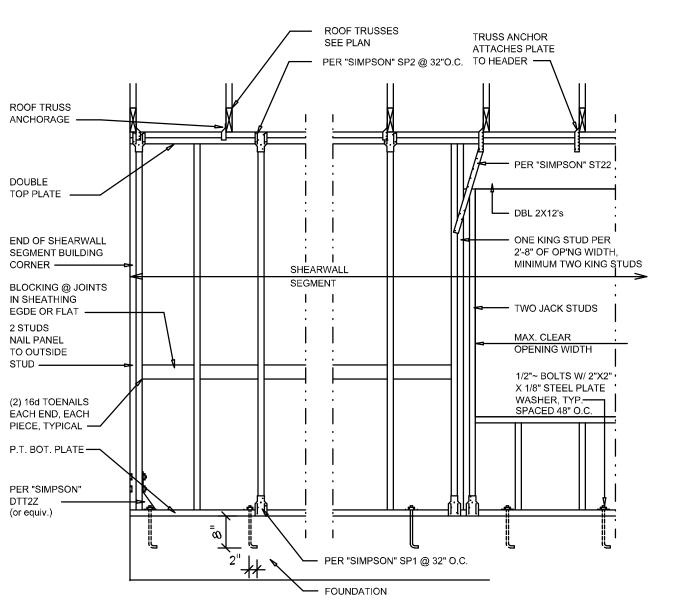
SCALE: 3/4" = 1'-0

WELDED WIRE MESH

BUILDING COMPONENTS & CLADDING LOADS MEAN BUILDING HEIGHT = 30.0', EXPOSURE "B"								
	ZONE	AREA	Vult 110 MPH	Vult 120 MPH	Vult 130 MPH	Vult 140 MPH		
ROOF 7^ TO 27^	1 1 1	10 20 50	12.0 / -19.9 11.4 / -19.4 10.0 / -18.6	14.9 / -23.7 13.6 / -23.0 11.9 / -22.2	17.5 / -27.8 16.0 / -27.0 13.9 / -26.0	20.3 / -32.3 18.5 / -31.4 16.1 / -30.2		
	2 2 2	10 20 50	12.5 / -34.7 11.4 / -31.9 10.0 / -28.2	14.9 / -41.3 13.6 / -38.0 11.9 / -33.6	17.5 / -48.4 16.0 / -44.6 13.9 / -39.4	20.3 / -56.2 18.5 / -51.7 16.1 / -45.7		
	3 3 3	10 20 50	12.5 / -51.3 11.4 /-47.9 10.0 / -43.5	14.9 / -61.0 13.6 / -57.1 11.9 / -51.8	17.5 / -71.6 16.0 / -67.0 13.9 / -60.8	20.3 / -83.1 18.5 / -77.7 16.1 / -70.5		
ורר	4 4 4	10 20 50	21.8 / -23.6 20.8 / -22.6 19.5 / -21.3	25.9 / -34.7 24.7 / -26.9 23.2 / -25.4	30.4 / -33.0 29.0 / -31.6 27.2 / -29.8	35.3 / -38.2 33.7 / -36.7 31.6 / -34.6		
WALL	5 5 5	10 20 50	21.8 / -29.1 20.8 / -27.2 19.5 / -24.6	25.9 / -34.7 24.7 / -32.4 23.2 / -29.3	30.4 /-40.7 29.0 / -38.0 27.2 / -34.3	35.3 / -47.2 33.7 / -44.0 31.6 / -39.8		

HEADER SPANS FOR EXTERIOR BEARING WALLS										
		BUILDING WIDTH (FT)								
HEADERS	HEADER SIZE	20'		28'		36'				
SUPPORTING:		SPAN	# JACKS	SPAN	# JACKS	SPAN	# JACKS			
	2-2x4	3'-6"	1	3'-2"	1	2'-10"	1			
	2-2x6	5'-5"	1	4'-8"	1	4'-2"	1			
ROOF, CEILING	2-2x8	6'-10"	1	5'-11"	2	5'-4"	1			
	2-2x10	8'-5"	2	7'-3"	2	6'-6"	2			
	2-2x12	9'-9"	2	8'-5"	2	7'-6"	2			
	3-2x8	8'-4"	1	7'-5"	1	6'-8"	1			
	3-2x10	10'-6"	1	9'-1"	2	8'-2"	1			
	3-2x12	12'-2"	2	10'-7"	2	9'-5"	2			
	4-2x8	9'-2"	1	8'-4"	1	9'-2"	1			
	4-2x10	11'-8"	1	10'-6"	1	9'-5"	1			
	4-2x12	14'-1"	1	12'-2"	2	10'-11"	1			



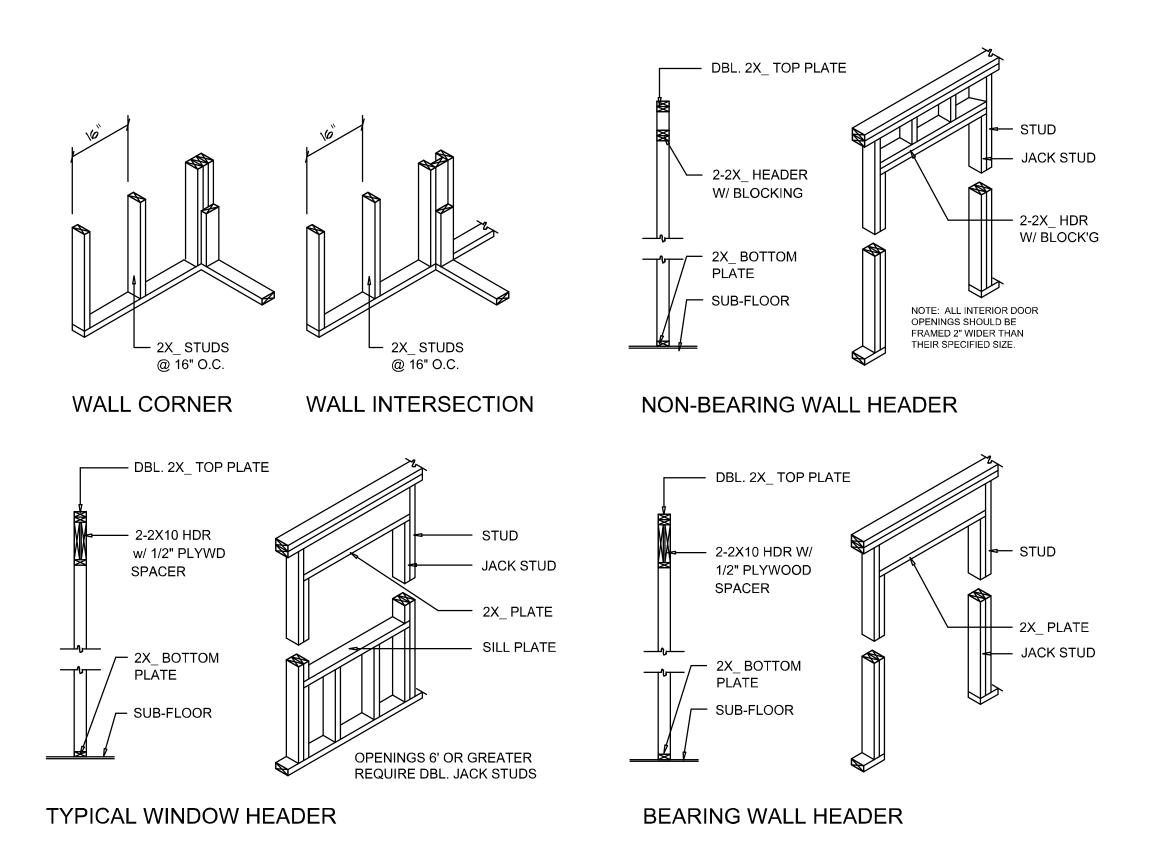

SHEARWALL NOT

 ALL SHEARWALLS SHALL BE TYPE 2 SHEARWALLS AS DEFINED BY STD 10-97 SBBCI 305.4.3.
 THE WALL SHALL BE ENTIRELY SHEATHED WITH

"WindSTORM" ALT. SHEATHING METHOD:

Alternate 'Titan' bolt concrete anchor system

EANCHOR SILL PLATE WITH 5/8" TITAN ANCHOR BOLT, PLACED AT 40" O.C. AROUND PERIMETER OF SLAB AND ALL INTERIOR BEARING WALLS.

PROJECT SHALL ALLOWED AS FOLLOWS:

O.C. OR 8d COMMONS @ 8" O.C.

ALTERNATIVE METHOD FOR ANCHORING THE TOP WALL PLATE TO THE FOUNDATION IN LIEU OF THE SP1/SP2 OR SP4 STRAPS INDICATED IN THE CONSTRUCTION DOCUMENTS FOR THIS

APPLY VERTICALLY, "WindSTORM" 7/16" OSB 48" X 97", 109", 121" OR 145" SHEATHING. FASTEN TO THE TOP PLATE AND THE SILL PLATE WITH EITHER 6d COMMONS @ 3" O.C. OR 8d COMMONS @ 4" O.C., FASTEN TO EACH STUD WITH EITHER 6d COMMONS @ 6"

- 7/16 " O.S.B. INCLUDING AREAS ABOVE AND BELOW OPENING.S

  3. ALL SHEATHING SHALL BE ATTACHED TO FRAMING
- ALONG ALL FOUR EDGES WITH JOINTS FOR ADJACENT PANELS OCCURING OVER COMMON FRAMING MEMBERS OR ALONG BLOCKING.

  4. NAIL SPACING SHALL BE 4" O.C. EDGES AND
- 4. NAIL SPACING SHALL BE 4" O.C 8" O.C. IN THE FIELD.
- 5. TYPE 2 SHEARWALLS ARE DESIGNED FOR THE OPENING IT CONTAINS. MAXIMUM HEIGHT OF OPENING SHALL BE 5/6 TIMES THE WALL HEIGHT. THE MINIMUM DISTANCE BETWEEN OPENINGS SHALL BE THE WALL HEIGHT/3.5 FOR 8'-0" WALLS (2'-3").

OPENING WIDTH	SILL PLATES	16d TOE NAILS EACH END
UP TO 6'-0"	(1) 2x4 OR (1) 2x6	1
s' TO 9'-0"	(3) 2x4 OR (1) 2x6	2
> 9' TO 12'-0"	(5) 2x4 OR (2) 2x6	3

# Wall Framing/Header DETAILS

SCALE: NONE



Shear Wall DETAILS

SCALE: NONE




REVISIONS
January 23, 2023

ARCHITECTURAL DESIGN SOFTWAR

CUSTOM BARNDOMINIUM DESIGN FOR:

TEPHEN SERABALLS


OJECT ADDRESS: SW DAWN LANE, COLUMBIA COUNTY, FLORIDA

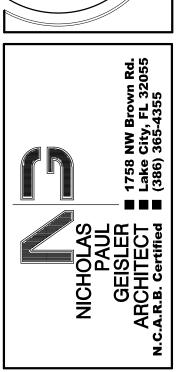

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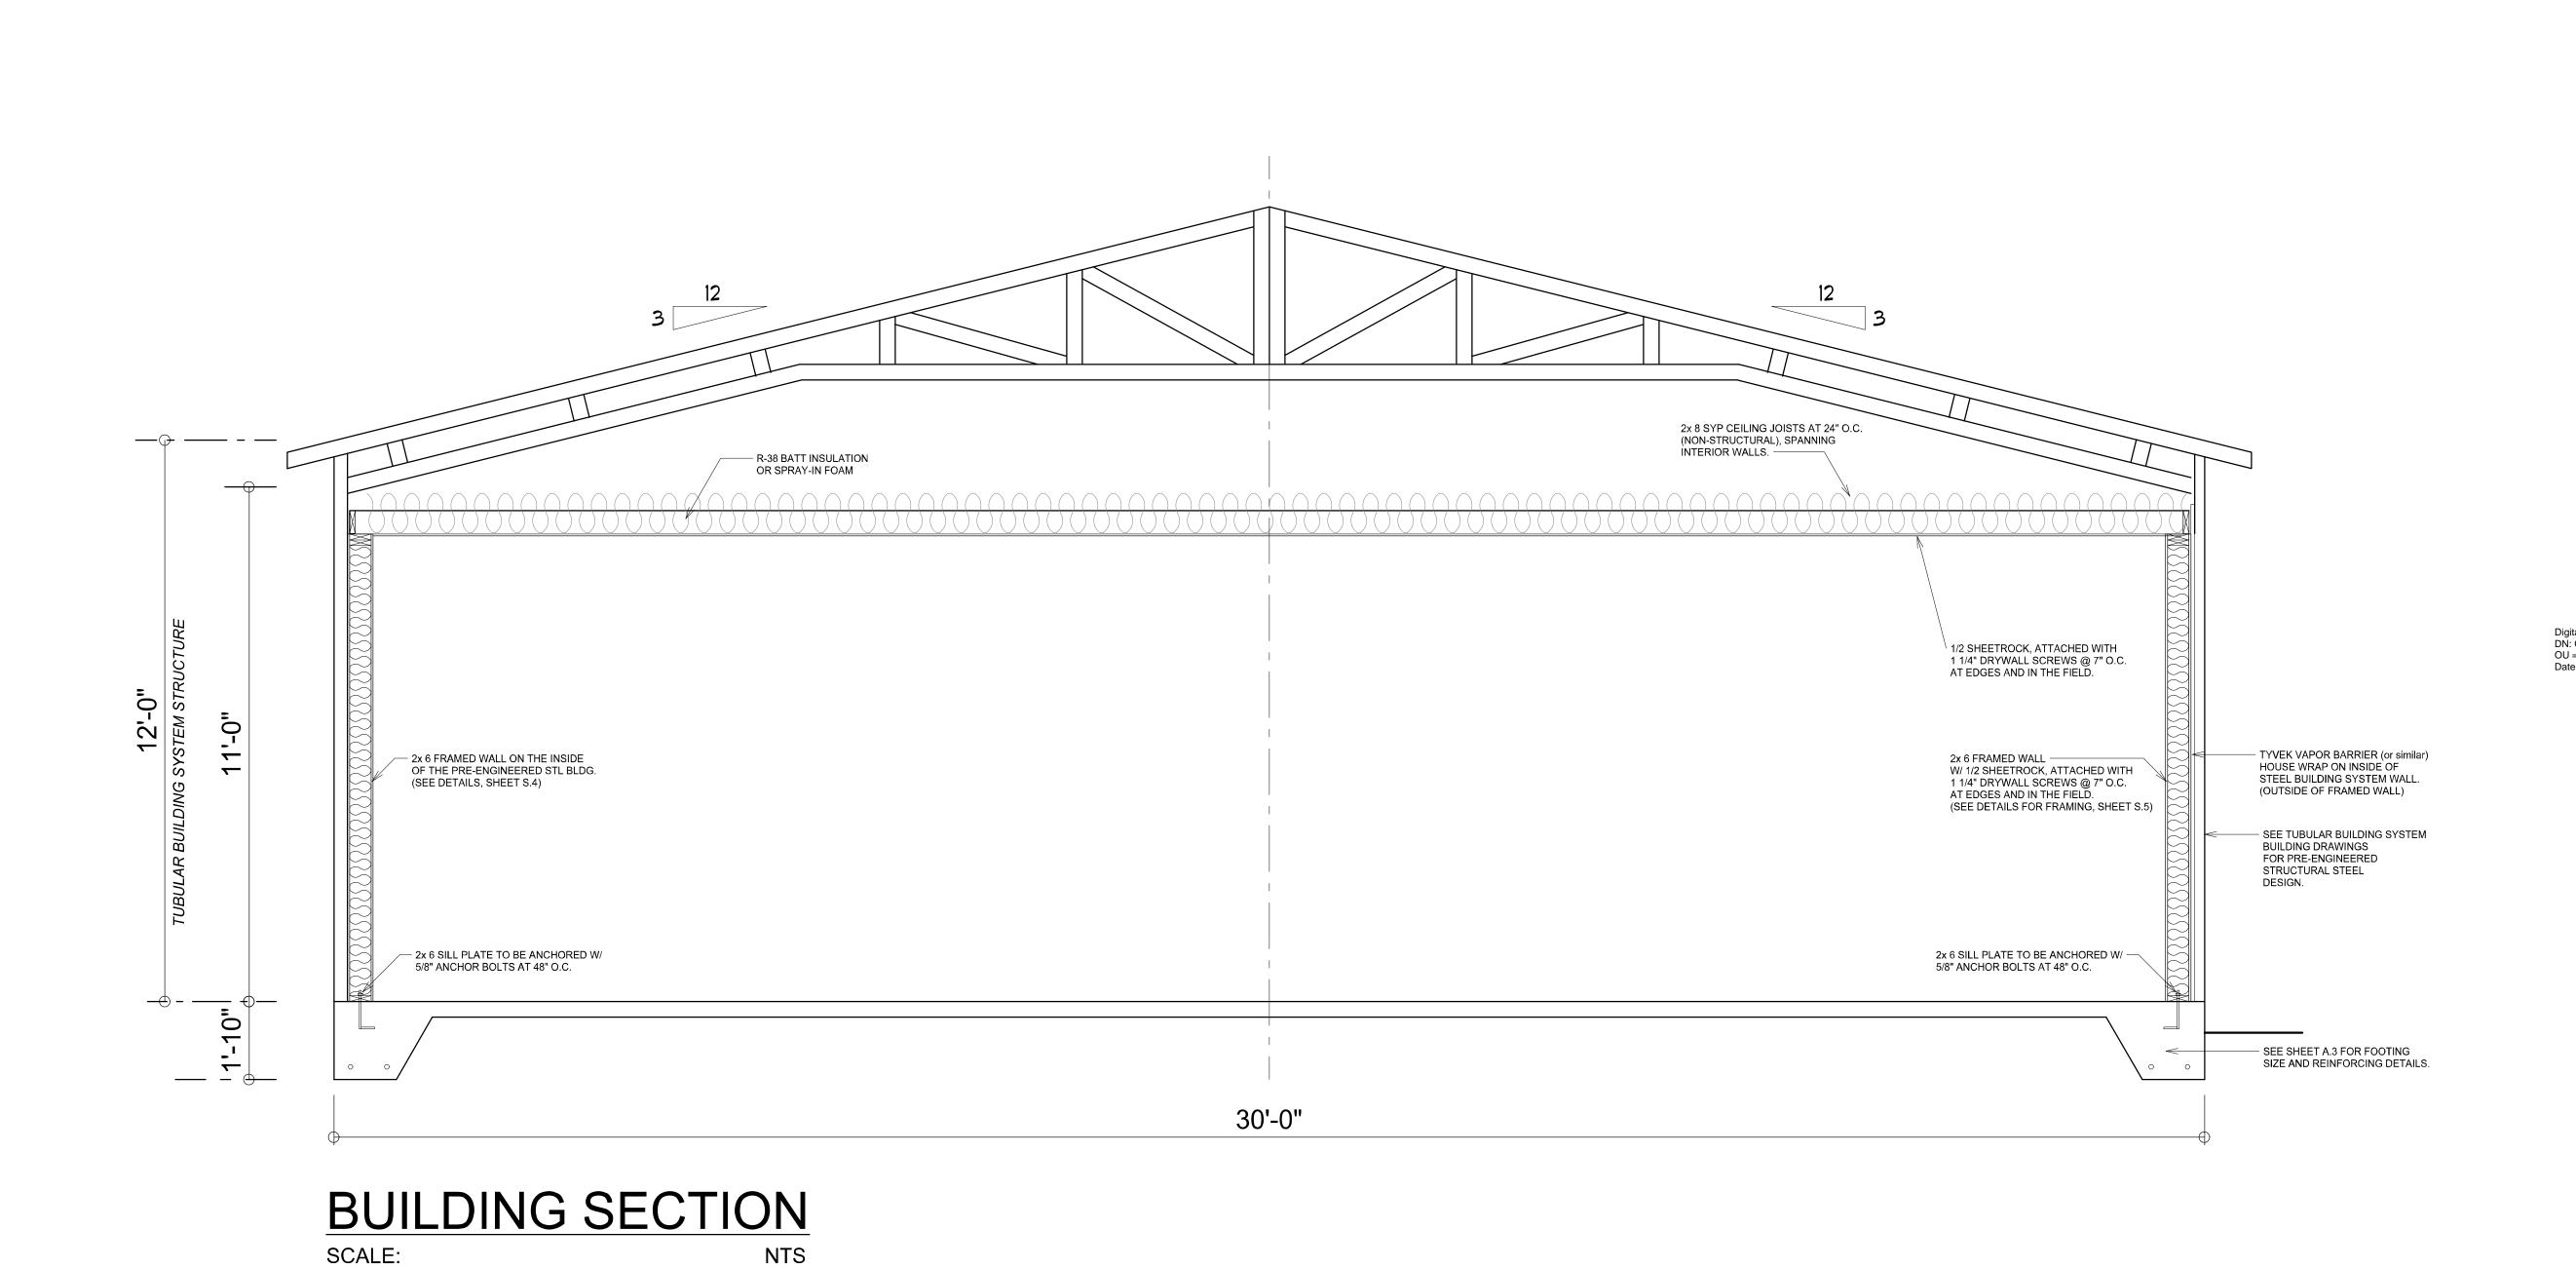
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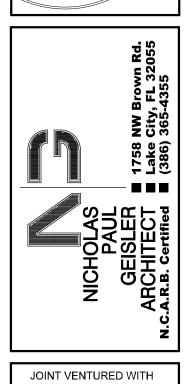
JOB NUMBER
20230120
DATE:
January 23, 2023

SHEET NUMBER

A.4

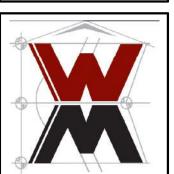

STEPHEN PROJECT ADDRESS: SW DAW Digitally signed by: N. P. GEISLER
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