



REVISIONS	
24May05	


SOFTPLAN
ARCHITECTURAL DESIGN SOFTWARE

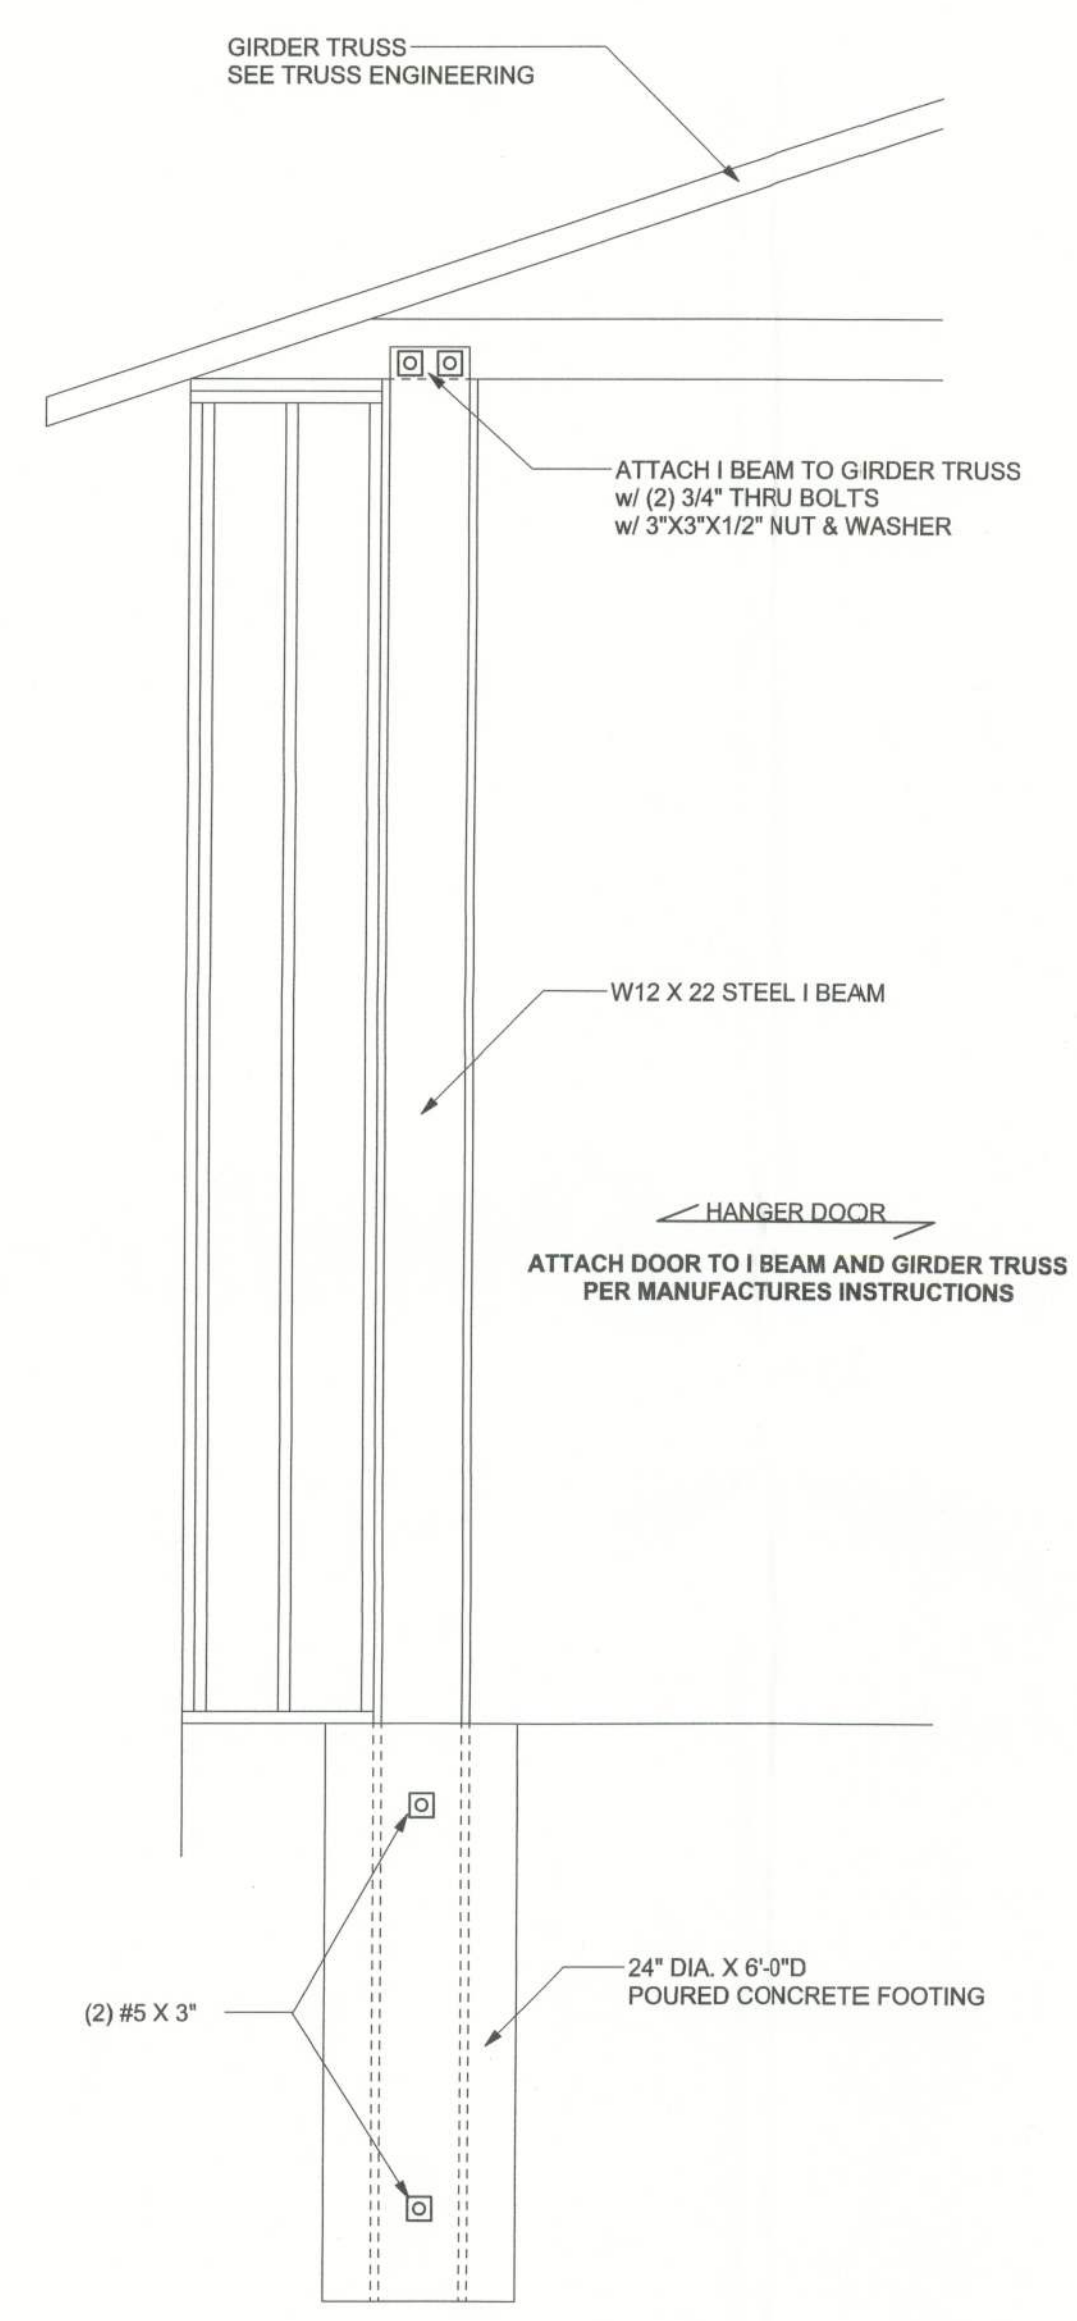

HANGER DOOR WALL DETAIL
SCALE: 1/2" = 1'-0"

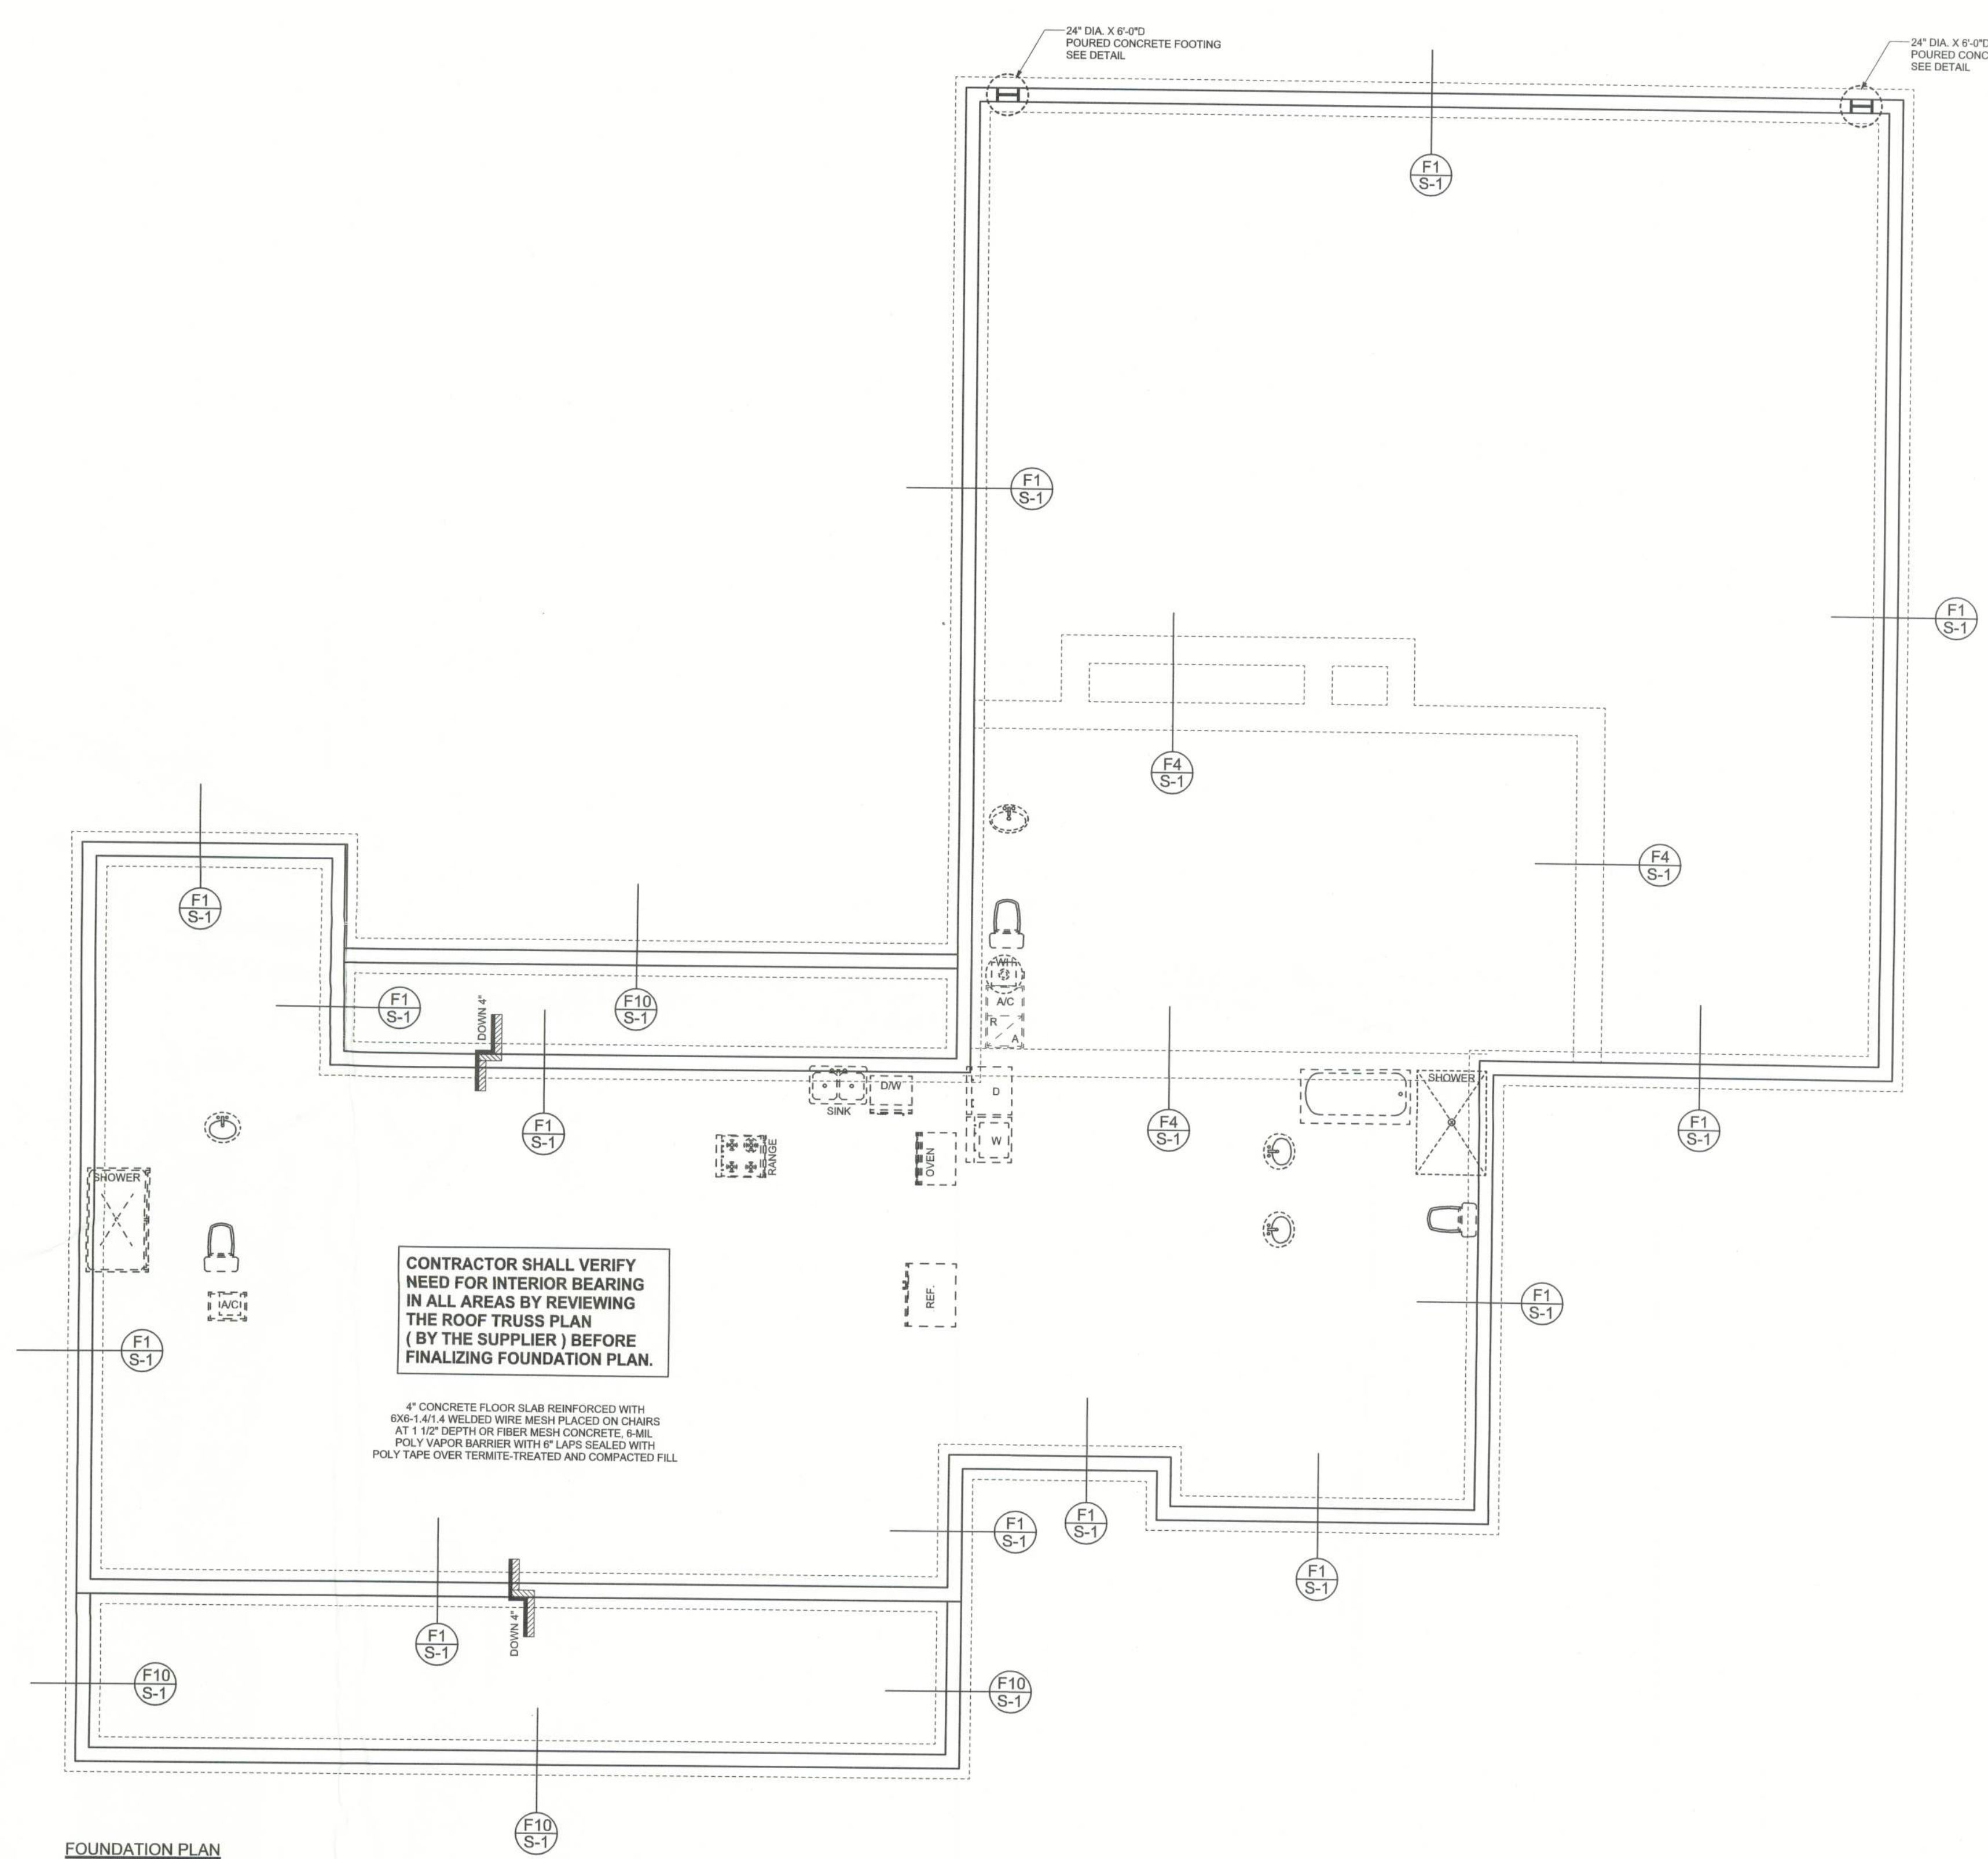

FOUNDATION PLAN
SCALE: 3/16" = 1'-0"
DIMENSIONS ON STRUCTURAL SHEETS ARE NOT EXACT. REFER TO ARCHITECTURAL FLOOR PLAN FOR ACTUAL DIMENSIONS

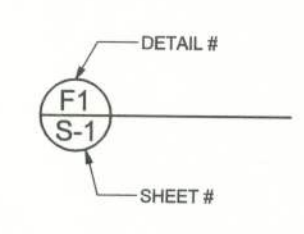

WINDLOAD ENGINEER: Mark Disosway,
P.E. No. 53815, P.O. Box 868, Lake City, FL
32056, 386-754-5419

DIMENSIONS:
Stated dimensions supercede scaled dimensions. Refer all questions to Mark Disosway, P.E. for resolution. Do not proceed without clarification.

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CERTIFICATION: These plans and "Windload Engineering", Sheet S-1, attached, comply with Florida Building Code 2001, Section 1606 wind loads, to the best of my knowledge.

LIMITATION: This design is valid for one building at specified location. In case of conflict, structural requirements, scope of work, and builder responsibilities on sheet S-1 control.

MARK DISOSWAY
P.E. 53815
Mark Disosway
26MAY05
SEAL

EDGLEY CONSTRUCTION, INC.

Stephenson Residence

ADDRESS:
231 SW Bonanza Glen
Lake City, Florida 32025

Mark Disosway P.E.
P.O. Box 868
Lake City, Florida 32056
Phone: (386) 754 - 5419
Fax: (386) 754 - 6749
Email: mdpe@bellsouth.net

PRINTED DATE:
May 26, 2005

DRAWN BY: David Disosway CHECKED BY:

DESIGNED BY:
David Disosway

FINALS DATE:
02 / Mar / 05

JOB NUMBER:
502044

DRAWING NUMBER
A-5
OF 6 SHEETS