

THE GAINEY HOME

NEW HOME

Project Address:


3181 SW COUNTY ROAD 138 FORT WHITE, FL 32038

Legal: COMM AT NE COR OF SEI/4 OF NE 1/4, RUN W 661.09 FT TO NE COR OF EI/2 OF WI/2, RUN S 1256.75 FT FOR POB, RUN W 330.95 FT S 1321.77 FT TO N R/W OF C R 138, E ALONG R/W 330.93 FT, N 1316.08 FT TO POB. 985-2199, PARCEL 3-B, WD 1148 2411

Project Summary:

THE PROJECT INVOLVES THE DESIGN AND CONSTRUCTION OF A NEW HOME FEATURING 4 BEDROOMS AND 2.5 BATHROOMS. THE HOUSE WILL HAVE AN OPEN FLOOR PLAN, CREATING A SEAMLESS FLOW BETWEEN THE KITCHEN, LIVING, AND DINING AREAS, IDEAL FOR BOTH FAMILY LIVING AND ENTERTAINING. A BONUS ROOM ABOVE THE GARAGE WILL PROVIDE ADDITIONAL FLEXIBLE SPACE, SUITABLE FOR A PLAYROOM, HOME OFFICE, OR GUEST AREA. THE DESIGN WILL PRIORITIZE FUNCTIONALITY AND COMFORT, WHILE MAXIMIZING SPACE AND CREATING A COHESIVE, INVITING ATMOSPHERE THROUGHOUT THE HOME.

Project Location Map:

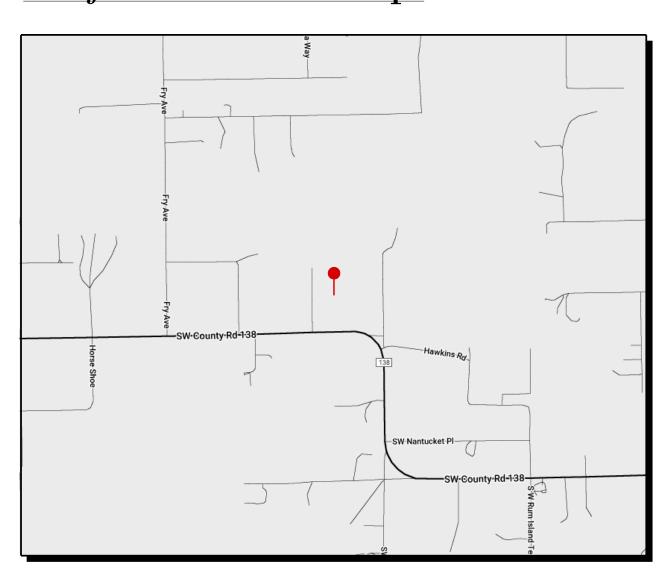

Owner:

CHASE D GAINEY

DATE

BROOKE GAINEY

DATE

Project Number:

GAINE-2894-N

Project Drawing Index:

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ALL MATERIALS & METHODS IN ACCORDANCE WITH THE FLORIDA BUILDING CODE. ALL DIMENSIONS TO BE FIELD VERIFIED PRIOR TO CONSTRUCTION. USE OF TOBACCO PRODUCTS NOT PERMITTED ON SITE AT ANY TIME. ALL AREAS OF SITE MUST BE RETURNED TO ORIGINAL CONDITION PRIOR TO COMPLETION.



THE GAINEY HOME
GAINEY HOME
GAINE-2894-N
3181 SW COUNTY ROAD 138

NO.	DATE:	DESCRIPTION:
	05/14/2025	PERMIT

6ALES INITIALS: OWNER INITIALS:

DESCRIPTION:

COVER SHEET

SCALE: AS NOTED

G1.0

Abbreviations: ABY above FOF face of finish MOD modular TV television AFF above finished floor MLD molding or moulding THK thick(ness) FOM face of masonry FOS face of stud MR mop receptor THR threshold ACC access FF factory finish MT mount(ed) or mount(ing) TPTN toilet partition MOV movable AP access pane FAS fasten(er) TPD toilet paper dispenser ACT acoustical tile FBD fiberboard TOL tolerance ADH adhesive FGL fiberglass TiG tongue and groove NAT natural ADJ adjacent FIN finish(ed) TC top of curb NRC noise reduction coefficient TG top of grade ADJT adjustable FFE finished floor elevation FFL finished floor line NOM nominal TP top of pavement AGG aggregate TRS transom A/C air conditioni FA fire alarm NMT non-metallic ALT alternate FBRK fire brick north TSL top of slab NIC not in contract TS top of steel ALUM aluminum FE fire extinguisher AB anchor bolt FEC fire extinguisher cabine NTS not to scale TW top of wall FHS fire hose station TB towel bar ANOD anodized T tread FPL fireplace OC on center APX approximate FP fireproof TYP typical FRT fire-retardant ASPH asphalt OPG opening FLG flashing UNFIN unfinished AT asphalt tile OPP opposite FLX flexible UR urinal AUTO automatic OPH opposite hand FLR floor(ing) OPS opposite surfac AW awning FLCO floor cleanout VB vapor barrie OD outside diamete FD floor drain VAR varnish BSMT basement OA overall VNR veneer BRG bearing FPL floor plate OH overhead VERT vertical BPL bearing plate FLUR fluorescent BM bench mark FTG footing PNT paint(ed) VG vertical grain FND foundation PNL panel VIN ∨inyl BEL below BET between FR french PB panic bar VB vinyl base bi-fold FRA frame or framing PTD paper towel dispenser VT vinyl tile BYL beveled FS full size PTR pater towel receptor WSCT wainscot BIT bituminous FBO furnished by others PAR parallel BLK block FUR furred or furring PARK park(ing) WTW wall to wall FUT future PK pocket WH wall hung BLKG blockin BD board PBD particle board WC water closet B6 both sides WP waterproof(ing. PTN partition BW both ways GA gage or gauge PV paved or paving WR water repellent WS water stop BOT bottom GALY galvanized Gl galvanized iron WWF welded wire fabric BRK brick PED pedestal GP galvanized pipe BRI bronze PERF perforate(d) W west PERI perimeter W width or wide BLDG building GSS galvanized steel sheet BUR built up roofing GC general contract(or PLAS plaster WDW window BYP bypass GL glass or glazing P.L. plastice laminate WG wired glass GLB glass block plate WM wire mesh CAB cabinet GLF glass fiber W/O without PG plate glass CPT carpet(ed GB grab bar PW plywood WD wood casement GD grade or grading point WB wood base PVC polyvinyl chloride WPT working point cast iron GVL gravel CIPC cain-in-place of PTC post-tensioned concrete WI wrought iron GT grout CST cast stone GYP gypsum dry wall PCF pounds per cubic foot PLF pounds per lineal foot CB catch basin PSF pounds per square foot CLG ceiling PSI pounds per square inch CHT ceiling height HDW hardware PCC precast concrete CEM cement HWD hardwood PFB prefabricate(d) CER ceramic HTG heating PFN prefinished PSC prestressed concrete ceramic tile HVAC heating / venting / air cond. CMT ceramic mosaic HT height PL property line HC hollow core CHAM chamfe CIR circle HM hollow metal QT quarry tile CLR clear(ance COL column HB hose bib RAD radius COMB combination HWH hot water heater RDWD redwood CONC concrete HS horizontal slider REF reference CMU concrete masonry unit CO change-out INCIN incinerator REFR refrigerator CONST construction INCL include(d) or including REG register REINF reinforced or reinforcing CONT continue or continuous ID inside diameter RCP reinforced concrete pipe CONTR contract(or) INSUL insulate(d) or insulating INT interior RESIL resilient CLL contract limit line INTM intermediate RET return CJ control joint CG corner guard INV invert RA return air IP iron pipe REV revision(s) or revised CORR corrugated IPS fron pipe size RH right hand CFL counter flashing ROW right of way CRS course(s) CF cubic foot JC janitor's closet R remove RD roof drain CY cubic yard JT joint JF joint filler RFG roofing RM room DP dampproofing JST joist dead load RO rough opening DEMO demolish or demolition KIT kitchen RSC rough sawn ceda RLK rowlock KO knockout DTL detail DIAG digaonal DIAM diameter LBL label SFGL safety glass SCH schedule DIM dimension LAB laboratory DIV division SCN screen door LAM laminate(d) STG seating SECT section LAY lavatory DA double acting DH double hung LH left hand SHTG sheathing SHT sheet downspout L length drain SG sheet glass SGD sliding glass door DWR drawer LW lightweight SH single hung DF drinking fountain LWC lightweight concrete SHLF shelf or shelving LMS limestone DW dumbwaiter SIM similar LTL lintel SLDC soldier course EA each LL live load each face LYR louver SC solid core east LPT low point soundproof ELEC electric(al) south MH manhole SPK speaker electrical panelboard EWC electric water cooler MFR manufacture(r. SPL special MAS masonry SPEC specification(s) elevator ELEY elevation MO masonry openin SQ square MTL material(s) SS stainless stee EMER emergency MAX maximum STD standard EQ equal EST estimate MECH mechanic(al) STA station MC medicine cabinet STL steel EXCA excavate MED medium STOR storage EXH exhaust MBR member SD storm drain EXIST existing EB expansion bol MMB membrane STRUCT structural EXP exposed MET metal SCT structural clay tile EXT exterior M meter(s) SUSP suspended MM millimeter(s) EXS extra strong SYS system MIN minimum MIR mirror FB face brick TEMP tempered FOC face of concrete MISC miscellaneous TEL telephone

General Notes:

GENERAL CONDITIONS:

- I. WHEN WORK IS NOT SPECIFICALLY NOTED BUT IS REQUIRED TO COMPLETE THE PROJECT, IT SHALL BE PROVIDED BY THE CONTRACTOR AT NO ADDITIONAL EXPENSE TO THE OWNER, AND SHALL BE OF THE BEST MATERIALS AND WORKMANSHIP.
- 2. THE DOCUMENTS ARE DIAGRAMMATIC AND SHALL NOT BE SCALED. ADDITIONAL DATA SHALL BE OBTAINED FROM RRCH THROUGH WRITTEN CLARIFICATION ONLY. YERIFY ALL EXISTING CONDITIONS, ELEVATIONS, AND DIMENSIONS BEFORE PROCEEDING WITH ANY PORTION OF ANY WORK.
- 3. ALL WORK AS OUTLINED IN THESE DOCUMENTS SHALL CONFORM TO THE APPLICABLE CODES AND ORDINANCES IN EFFECT AT THE TIME THESE DOCUMENTS WERE PREPARED. IN THE EVENT OF A CONFLICT, THE MORE STRINGENT REQUIREMENTS SHALL
- 4. THE CONTRACTORS SHALL VISIT THE JOB SITE AND BECOME FAMILIAR WITH ALL EXISTING CONDITIONS WHICH MAY AFFECT
- 5. THE CONTRACTORS SHALL BE EXPERIENCED IN THIS TYPE OF WORK, NO ALLOWANCES WILL BE MADE AFTER THE BID FOR LACK
- 6. THE CONTRACTORS SHALL TAKE ALL NECESSARY PRECAUTIONARY MEASURES TO PROTECT THE PUBLIC AND ADJACENT
- PROPERTIES FROM DAMAGE THROUGHOUT THE CONSTRUCTION. 1. ANY EXISTING UTILITIES TO BE ABANDONED SHALL BE PROPERLY DISCONNECTED, PLUGGED, OR CAPPED, AS REQUIRED BY CODE OR SOUND CONSTRUCTION PRACTICES.
- 8. DAMAGED OR DISRUPTED EXISTING CONDITIONS INCLUDING BUT NOT LIMITED TO LANDSCAPING, LIGHTING, IRRIGATION, PEDESTRIAN AND VEHICLE ACCESS SHALL BE REPLACED AT THE END OF CONSTRUCTION TO THE SAME STANDARDS OF QUALITY AS EXISTED PRIOR TO CONSTRUCTION DISRUPTION.
- 9. DISRUPTED ELECTRICAL AND WATER LINES SHALL BE RE-ROUTED DURING PROJECT CONSTRUCTION AND ARE TO REMAIN IN CONTINUOUS SERVICE UNLESS OTHERWISE INDICATED OR INSTRUCTED BY THE OWNER. IO. NO CHANGES, MODIFICATIONS OR DEVIATIONS SHALL BE MADE FROM THE DRAWINGS OR SPECIFICATIONS WITHOUT FIRST
- SECURING WRITTEN PERMISSION FROM RRCH. II. WHERE LACK OF INFORMATION OR ANY DISCREPANCY SHOULD APPEAR IN THE DRAWINGS OR SPECIFICATIONS, REQUEST WRITTEN INTERPRETATION FROM RRCH BEFORE PROCEEDING WITH THAT PART OF THE WORK
- 12. WHEN INSTRUCTED, PROVIDE 6IX (6) SETS OF SHOP DRAWINGS FOR ALL PRODUCTS, MATERIALS, AND EQUIPMENT TO RRCH FOR APPROVAL PRIOR TO ORDERING, EQUIPMENT INSTALLED WITHOUT APPROVAL SHALL BE SUBJECT TO REJECTION AND
- REPLACEMENT AT CONTRACTOR'S EXPENSE 13. UNLESS OTHERWISE NOTED, ELECTRICAL CONDUITS, PLUMBING LINES, ETC. SHALL BE RUN CONCEALED AND FRAMING SHALL
- BE CORRECTLY SIZED TO ACCOMPLISH THIS WITHOUT CREATING VARIATIONS IN THE WALL PLANE. 14. PROVIDE ADEQUATE CONCEALED BLOCKING AND ANCHORING FOR ALL CEILING AND WALL MOUNTED EQUIPMENT, HARDWARE, AND ACCESSORIES.
- 15. WHEN A PRODUCT, SYSTEM OR ASSEMBLY IS CALLED FOR, ALL NECESSARY PARTS AND MATERIALS REQUIRED FOR A COMPLETE AND FULLY OPERATIONAL SYSTEM SHALL BE PROVIDED AND INSTALLED AND INSTALLATION SHALL BE ACCORDING TO THE MANUFACTURER'S INSTRUCTIONS, PRIOR TO PROCEEDING WITH WORK, CONTRACTORS SHALL COORDINATE WITH EACH
- TRADE, THE LOCATIONS OF SLEEVES OR OTHER PRESET ACCESSORIES INVOLVING OTHER TRADES. 16. ALL DIMENSIONS SHOWN ARE EXACT UNLESS OTHERWISE NOTED.
- IT, THE CONTRACTOR 6HALL GUARANTEE ALL MATERIALS AND WORKMANSHIP FURNISHED UNDER THIS CONTRACT FOR A MINIMUM PERIOD OF ONE YEAR FROM THE DATE OF FINAL ACCEPTANCE OF WORK OF THIS CONTRACT BY OWNER AND RRCH, BUT IN NO EVENT LEGS THAN AS REQUIRED BY TERMS OF THE AGREEMENT BETWEEN THE OWNER AND CONTRACTOR FOR THE CONSTRUCTION OF THE PROJECT OR STATE STATUTE, ANY DEFECTS DEVELOPING WITHIN THIS PERIOD TRACEABLE TO MATERIALS OR WORKMANSHIP PROVIDED OR PERFORMED BY THE CONTRACTOR, SHALL BE MADE GOOD AT THE EXPENSE OF THE CONTRACTOR, NOT THE OWNER. THE CONTRACTOR SHALL ACCEPT AND FULLY UNDERSTAND THIS PROVISION PRIOR TO THE CONTRACT BEING AWARDED. NO CLAIM FOR EXTRA COMPENSATION WILL BE ALLOWED FOR CORRECTION OF FAULTY WORK OR DEFECTIVE MATERIALS, AT ANY TIME DURING THE CONSTRUCTION PERIOD, OWNER'S REPRESENTATIVES AND THE ENGINEER RETRAIN THE RIGHT TO REQUIRE THE CONTRACTOR TO REMOVE AND REINSTALL ANY EQUIPMENT OR MATERIALS NOT FOLLOWING THE STANDARDS AS PRESENTED HEREIN OR ON THE DRAWINGS AND AT NO COST TO THE OWNER OR ENGINEER.

SITE CONDITIONS:

- 1. LOCATE, IDENTIFY, AND PROTECT ALL EXISTING UTILITIES ENCOUNTERED DURING THE WORK, IF ANY, NOTIFY UTILITY
- 2. ENSURE THAT ALL UTILITY AND OTHER SERVICES WHICH MAY BE DISTURBED DURING CLOSE EXCAYATION ARE TEMPORARILY STAYED AND BRACED IN POSITION DURING THE WORK.
- 3. PROVIDE 6LEEVES APPROPRIATE TO CONSTRUCTION WHERE NEW PIPES, CONDUIT, AND DUCTS PENETRATE WALLS AND
- FLOORS, FILL YOIDS WITH FIRE SAFING INSULATION OR FOAM PENETRATION SEALANT. 4. PROGRESS CLEANING: REMOVE DEBRIS FROM INTERIOR OF BUILDING ON A DAILY BASIS AND STORE TEMPORARILY IN COMMERCIAL TRAGH CONTAINERG, REMOVE DEBRIG FROM BUILDING SITE AT INTERVALS REQUIRED TO MINIMIZE OVERFLOW AND SPILLAGE, HANDLE HAZARDOUG, DANGEROUG, OR UNGANITARY WASTE MATERIALS SEPARATELY FROM OTHER WASTE BY
- 5, PROVIDE TEMPORARY TOILET FACILITIES FOR CONSTRUCTION USE, USE OF THE OWNER'S TOILET FACILITIES WILL NOT BE

CONTAINERIZING PROPERLY, DISPOSE OF MATERIAL IN A LAWFUL MANNER,

FINAL COMPLETION:

- 1. DO NOT BURN WASTE MATERIALS, DO NOT BURY DEBRIS OR EXCESS MATERIALS ON THE OWNER'S PROPERTY, DO NOT DISCHARGE VOLATILE, HARMFUL OR DANGEROUS MATERIALS INTO DRAINAGE SYSTEMS. REMOVE WASTE MATERIALS FROM THE SITE AND DISPOSE IN A LAWFUL MANNER. 2. COMPLETE CLEANING OPERATIONS BEFORE REQUESTING INSPECTION FOR CERTIFICATION OF SUBSTANTIAL COMPLETION AND
- MAINTAIN BUILDING IN CLEANED CONDITION UNTIL FINAL COMPLETION.
- 3. REMOVE TEMPORARY PROTECTION AND FACILITIES INSTALLED FOR PROTECTION OF THE WORK DURING CONSTRUCTION. 4. REMOYE LABELS, CLEAN GLASS SURFACES, DUST, AND WIPE CLEAN ALL PRODUCTS, MATERIALS, SYSTEMS, FINISHES, EQUIPMENT, AND SURFACES

GENERAL ACCESSIBILITY NOTES:

- 1. THE INTERNATIONAL SYMBOL OF ACCESSIBILITY SIGN SHALL BE DISPLAYED AT ALL ACCESSIBLE RESTROOM FACILITIES AND AT ACCESSIBLE BUILDING ENTRANCES UNLESS ALL ENTRANCES ARE ACCESSIBLE, NON ACCESSIBLE ENTRANCES SHALL HAVE DIRECTIONAL SIGNS INDICATING THE ROUTE TO THE NEAREST ACCESSIBLE ENTRANCE,
- 2. DOORS TO ALL ACCESSIBLE SPACES SHALL HAVE ACCESSIBLE HARDWARE (I.E. LEVER OPERATED, PUSH-TYPE, U-SHAPED) MOUNTED NO HIGHER THAN 48 INCHES ABOVE THE FLOOR.
- 3. ALL DOORS SHALL BE OPENABLE BY A SINGLE EFFORT, THE MAXIMUM FORCE REQUIRED TO OPEN A DOOR SHALL NOT EXCEED 8.5 LBS, FOR EXTERIOR SWINGING DOORS AND 5 LBS, FOR ALL SLIDING, FOLDING, AND INTERIOR SWINGING DOORS.
- 4. FLOOR SURFACES SHALL BE STABLE, FIRM AND SLIP-RESISTANT. CHANGES IN LEVEL SHALL BE BETWEEN 0.25 INCH AND 0.5 INCH. CHANGES IN LEVEL GREATER THAN 0.5 INCH REQUIRE RAMPS, GRATINGS IN FLOOR SHALL HAVE SPACES NO GREATER THAN 0.5 INCH WIDE IN ONE DIRECTION, DOORWAY THRESHOLDS SHALL NOT EXCEED 0.5 INCHES IN HEIGHT,
- 5. TOILET STALL DOORS SHALL BE THE SELF-CLOSING TYPE. 6. A TOWEL DISPENSER SHALL BE LOCATED ADJACENT TO ALL LAYATORIES.
- 1. FIXTURE MOUNTING HEIGHTS SHALL COMPLY WITH THOSE INDICATED ON THE STANDARD MOUNTING HEIGHT DIAGRAMS UNLESS NOTED OTHERWISE.
- 8. FIXTURE SPACING AND CLEARANCE SHALL COMPLY WITH THOSE INDICATED ON THE PLANS.

LIFE SAFETY NOTES:


- I. FIRE EXTINGUISHER CABINETS SET IN FIRE RATED WALLS SHALL BE OF CONSTRUCTION HAVING A FIRE RATED EQUAL TO THE WALL IT IS MOUNTED IN.
- 2. THE LOCATION AND / OR QUANTITY OF EXIT SIGNS, FIRE EXTINGUISHERS, SMOKE / C.O. DETECTORS AND FIRE EXTINGUISHER
- CABINETS IS SUBJECT TO REVIEW AND REVISION BY THE CODE AUTHORITY HAVING JURISDICTION. 3. THE CONTRACTOR SHALL MAKE ALL LIFE SAFETY CHANGES REQUIRED BY THE CODE AUTHORITY HAVING JURISDICTION
- TO ACHIEVE A CODE COMPLIANT BUILDING CONDITION. 4, EMERGENCY LIGHTING AND EXIT SIGNS, SHALL BE PROVIDED AS DIRECTED BY THE FIRE MARSHAL AND SHALL BE WIRED

PER CODE (NEC 100-12F)


ELECTRICAL NOTES:

- 1. ELECTRICIAN TO YERIFY & INSTALL SMOKE DETECTOR / CARBON MONO, DETECTOR PER CODE
- 2. GFI @ ALL AFFECTED WET AREAS, ALL OTHER REC. TO BE AFCI
- 3. LIGHT SWITCH TO MATCH EXISTING OR 4'-0" TO TOP OF BOX 4. OWNER MAY ELECT TO DO A WALK-THRU TO PROVIDE FURTHER INSIGHT ON ELECTRICAL FIXTURES AND LOCATIONS

Material Legend:

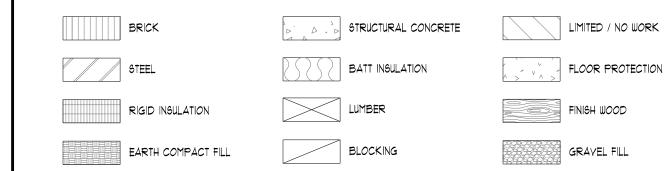

Symbols Legend:

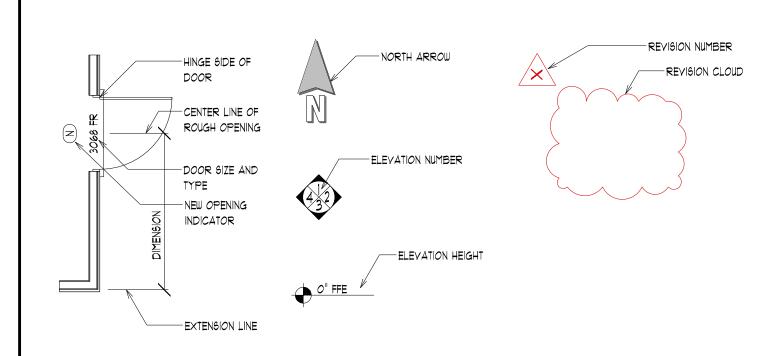

Wall Legend:

EXISTING & DEMO DIMENSIONS: 1. ALL DIMENSIONS ARE FROM FINISHED FACE OF WALL ASSEMBLY

NEW FRAMING DIMENSIONS:

I. EXTERIOR WALLS ARE MEASURED FROM EXTERIOR FACE OF SHEATHING OR EXTERIOR FACE OF CMU 2. INTERIOR WALLS ARE MEASURED FROM INTERIOR FACE OF STUD OR CMU

NEW CONSTRUCTION:

2X EXT WALL W/ SIDING / B&B
2X EXT WALL W/ BRICK / STO
CMU EXT WALL W/ SIDING / B&
CMU EXT WALL W/ STUCCO

2X INT FRAMED WALL 2X INT BEARING WALL

2X INT INSULATED BEARING WALL 2X INT INSULATED FRAMED WALL

GLASS / SCREEN WALL

KNEEWALL UNDER COUNTERTOP KNEEWALL W/ GLASS ABOVE

FOUNDATION: 2X INT NON-BEARING WALL

2X INT BEARING WALL D. D. D. CMU STEM WALL

CONC. MONO SLAB CONC. MONO SLAB W/ CURB

FOOTER BELOW

_ __ _ CONTROL JOINT IN SLAB

DEMOLITION:

[[[]]]]	2X EXT WALL W/ BRICK / STONE
6 = = = = = = 3	2X EXT WALL W/ SIDING / B&B
	CMU EXT WALL W/ SIDING / B#B
[[[]]]	CMILENT HIALL HIL STUCCO

CMU EXT WALL W/ STUCCO 2X INT FRAMED WALL f------2X INT BEARING WALL

------GLASS / SCREEN WALL

EXISTING: 2X EXT WALL W/ BRICK / STONE 2X EXT WALL W/ SIDING / B&B

CMU EXT WALL W/ SIDING / B&B

CMU EXT WALL W/ STUCCO 2X INT FRAMED WALL

2X INT BEARING WALL

KNEEWALL UNDER COUNTERTOP KNEEWALL W/ GLASS ABOVE

GLASS / SCREEN WALL REMODEL:

2X EXT WALL W/ BRICK / STONE

2X EXT WALL W/ SIDING / B&B CMU EXT WALL W/ SIDING / B&B CMU EXT WALL W/ STUCCO

2× INT WALL 2X INT BEARING WALL

2X INT INSULATED BEARING WALL

KNEEWALL W/ GLASS ABOYE [/*] [] [*] [] KNEEWALL UNDER COUNTERTOP

GLASS / SCREEN WALL

2× INT INSULATED WALL

Project Code Outline:

Florida Building Code - 8th Edition (2023) National Electrical Code (NFPA 70) - 2020 Edition

Project Square Footage:

TYPE	CONDITIONED	UNCONDITIONED	TOTAL
MAIN FLOOR	2,660 SF	-	2,660 SF
GARAGE	-	770 SF	770 SF
PORCH	•	249 SF	249 SF
LANAI	-	492 SF	492 SF
BONUS	-	553 SF	553 SF
TOTAL	2,660 SF	2,064 SF	4,724 SF

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Permitting Agency:


COLUMBIA COUNTY

PERMIT JURISDICTION AREA

Utility Agency:

CLAY ELECTRIC COOPERATIVE, INC.


Project Key Plan:

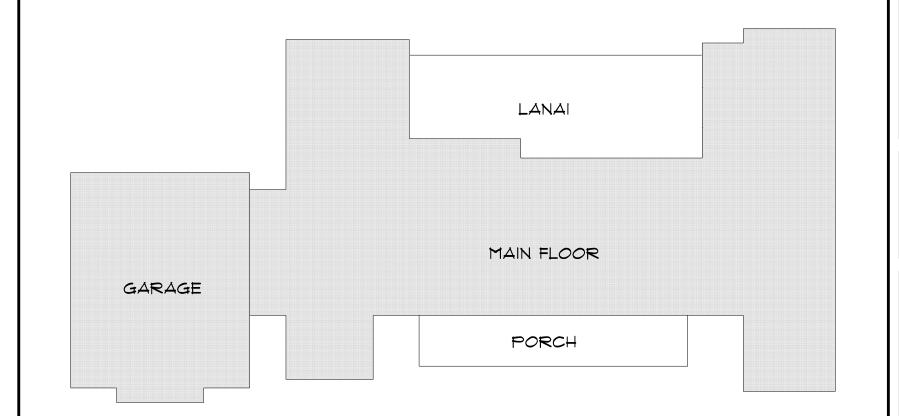

NO. DATE: DESCRIPTION: 05/14/2025 PERMIT

SALES INITIALS: OWNER INITIALS: DESCRIPTION: GENERAL NOTES SCALE: AS NOTED

SHEET NUMBER G2.0

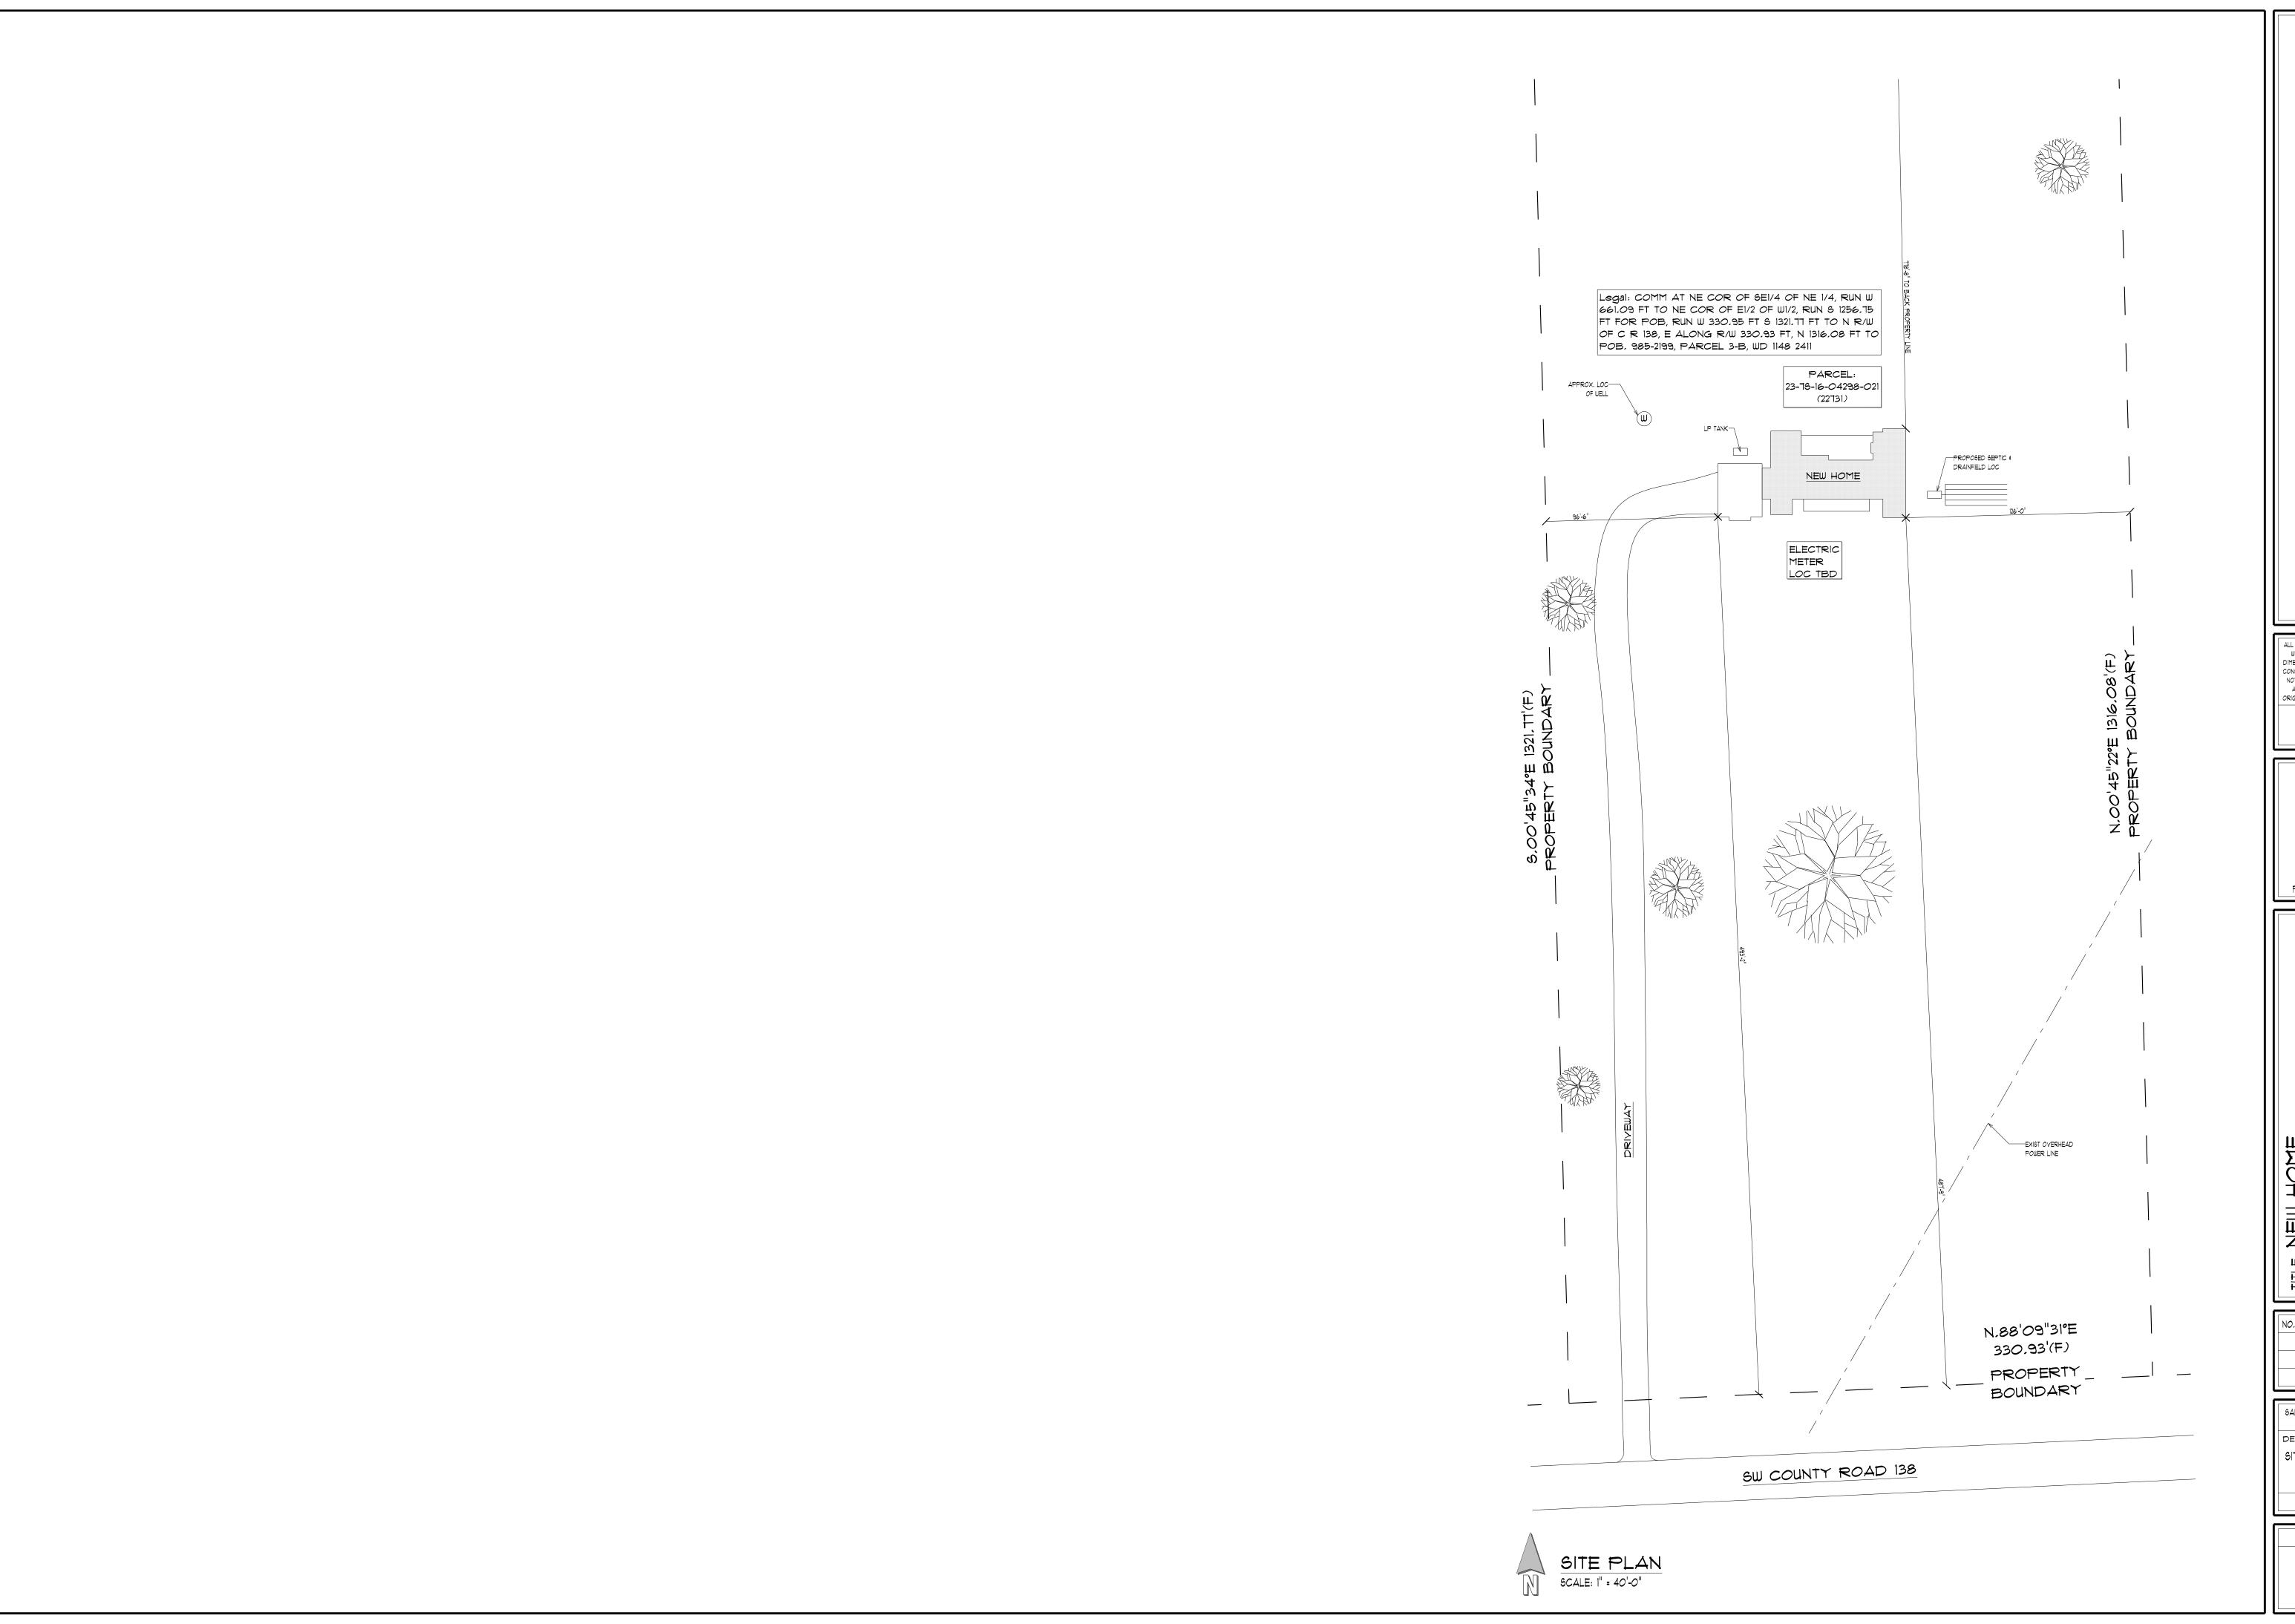

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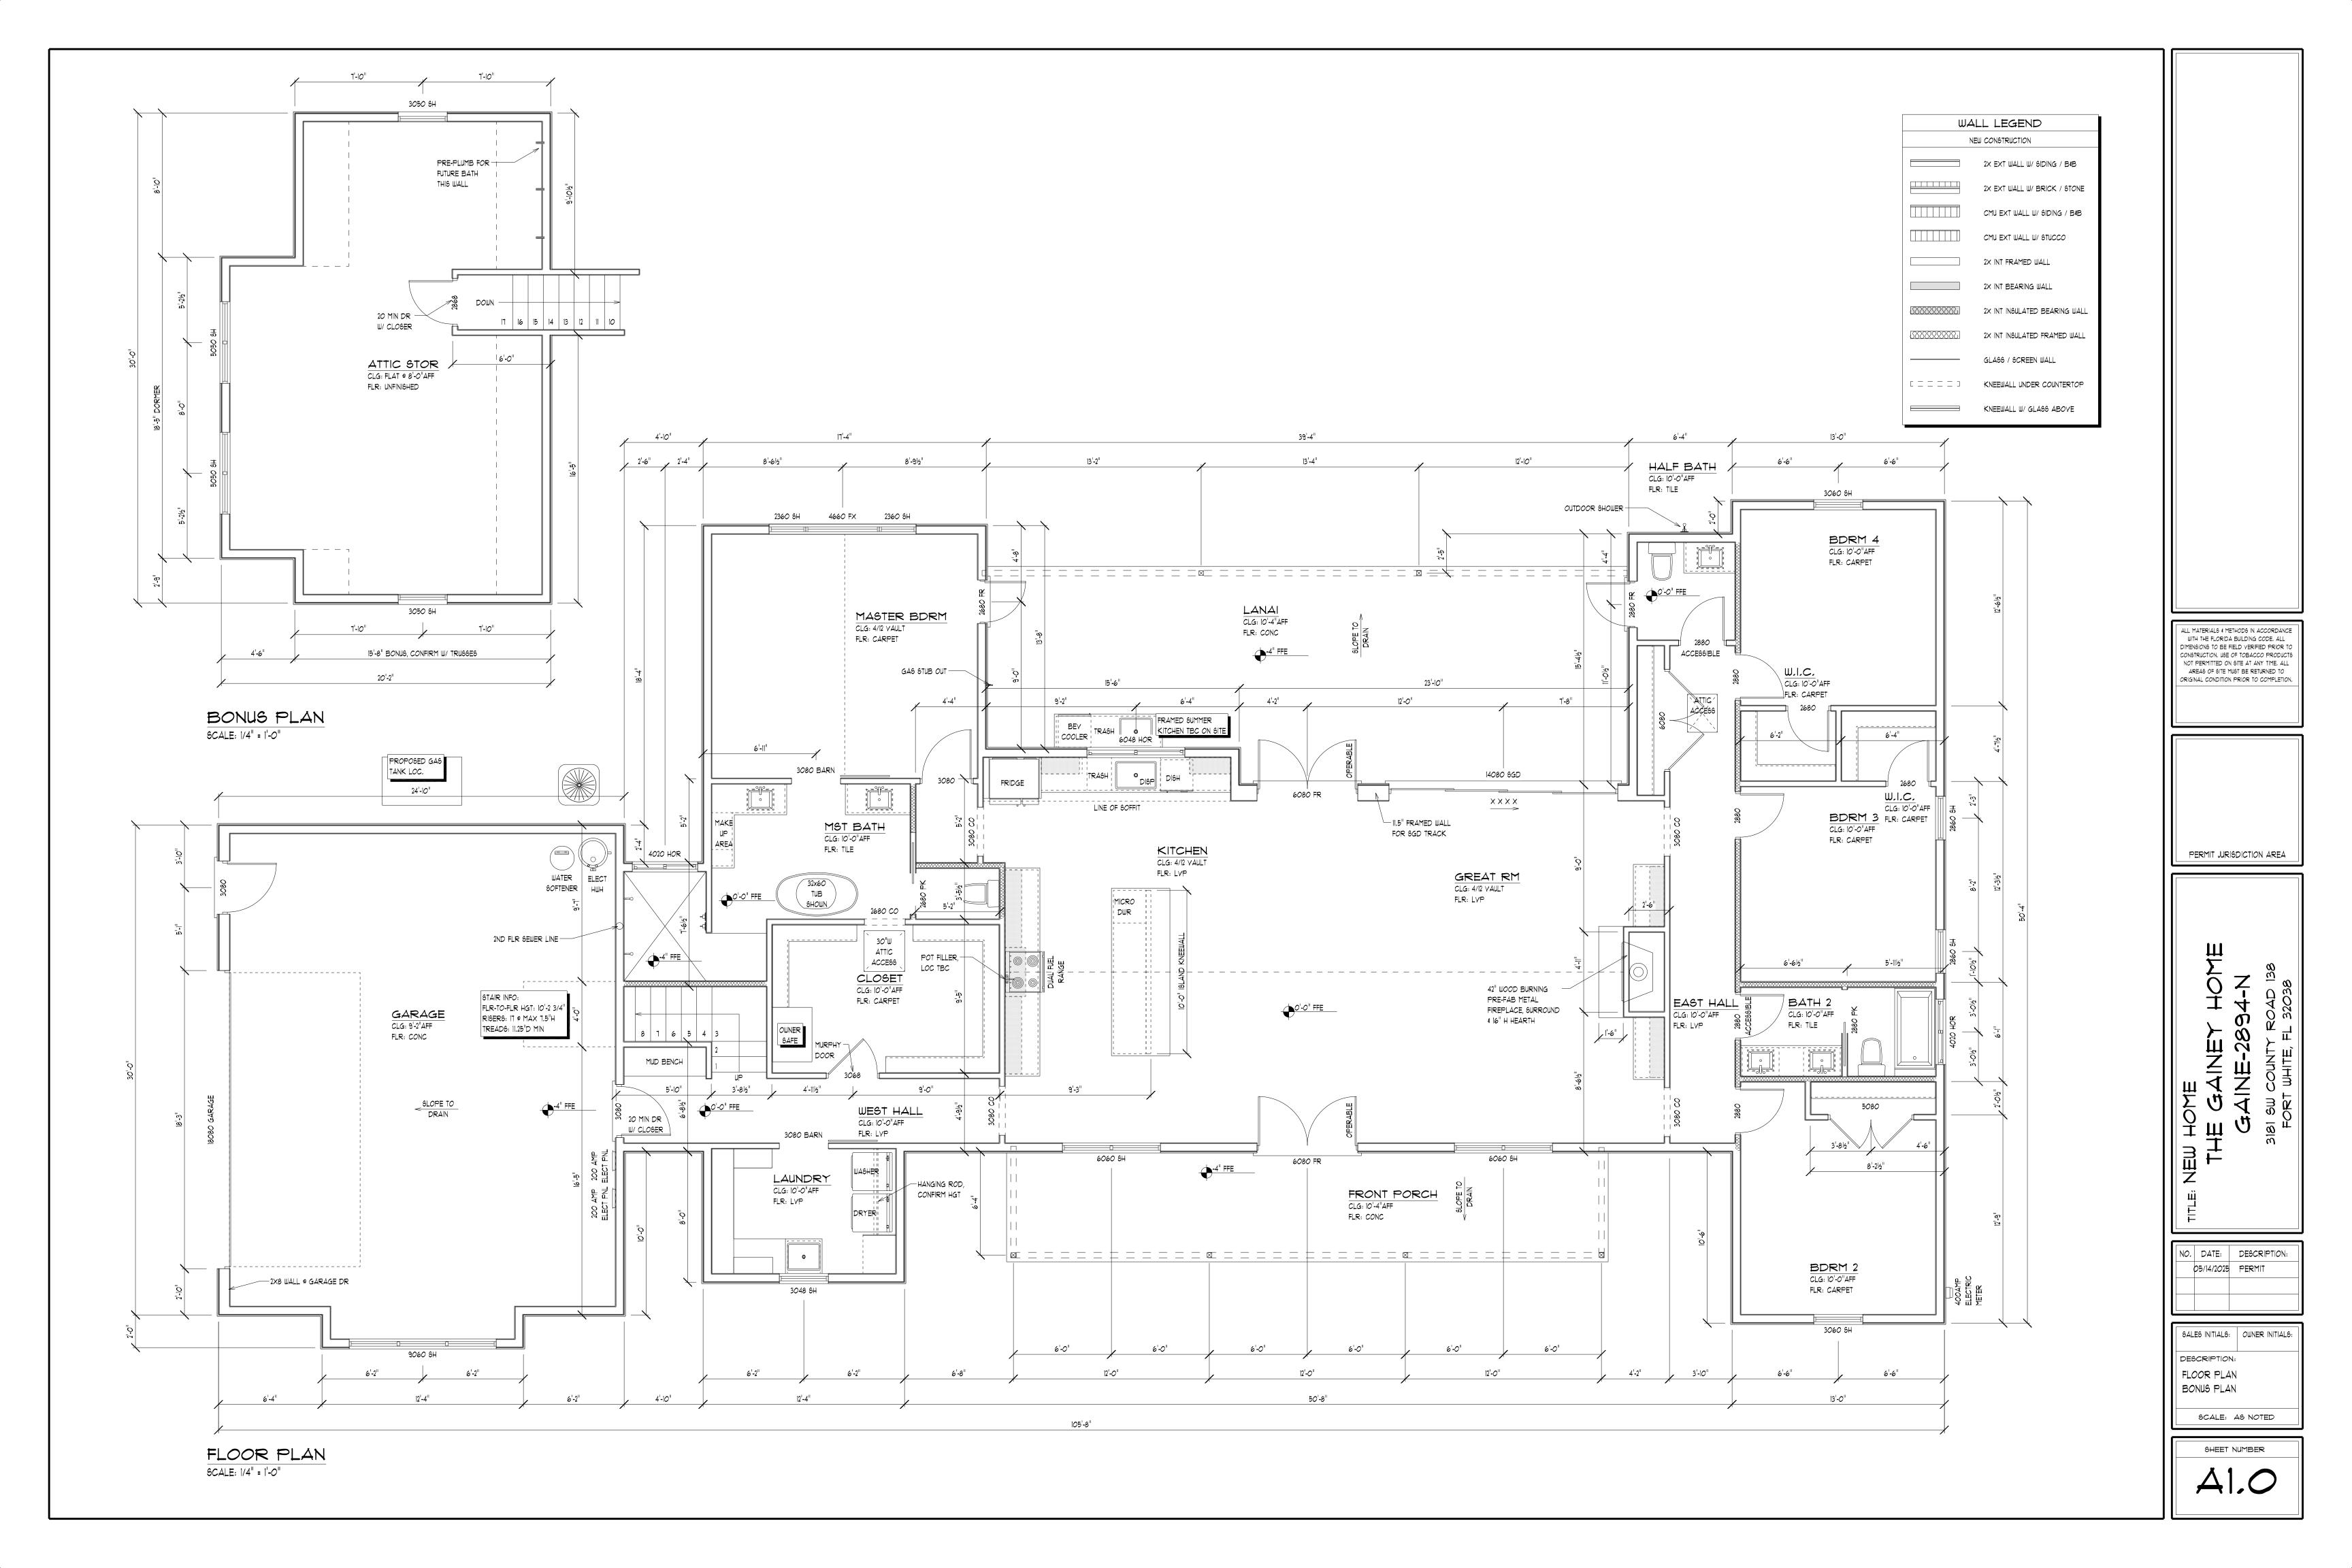
PERMIT JURISDICTION AREA


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,	DATE:	DESCRIPTION:	
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SALES INITIALS: OWNER INITIALS:

SITE PLAN

SCALE: AS NOTED



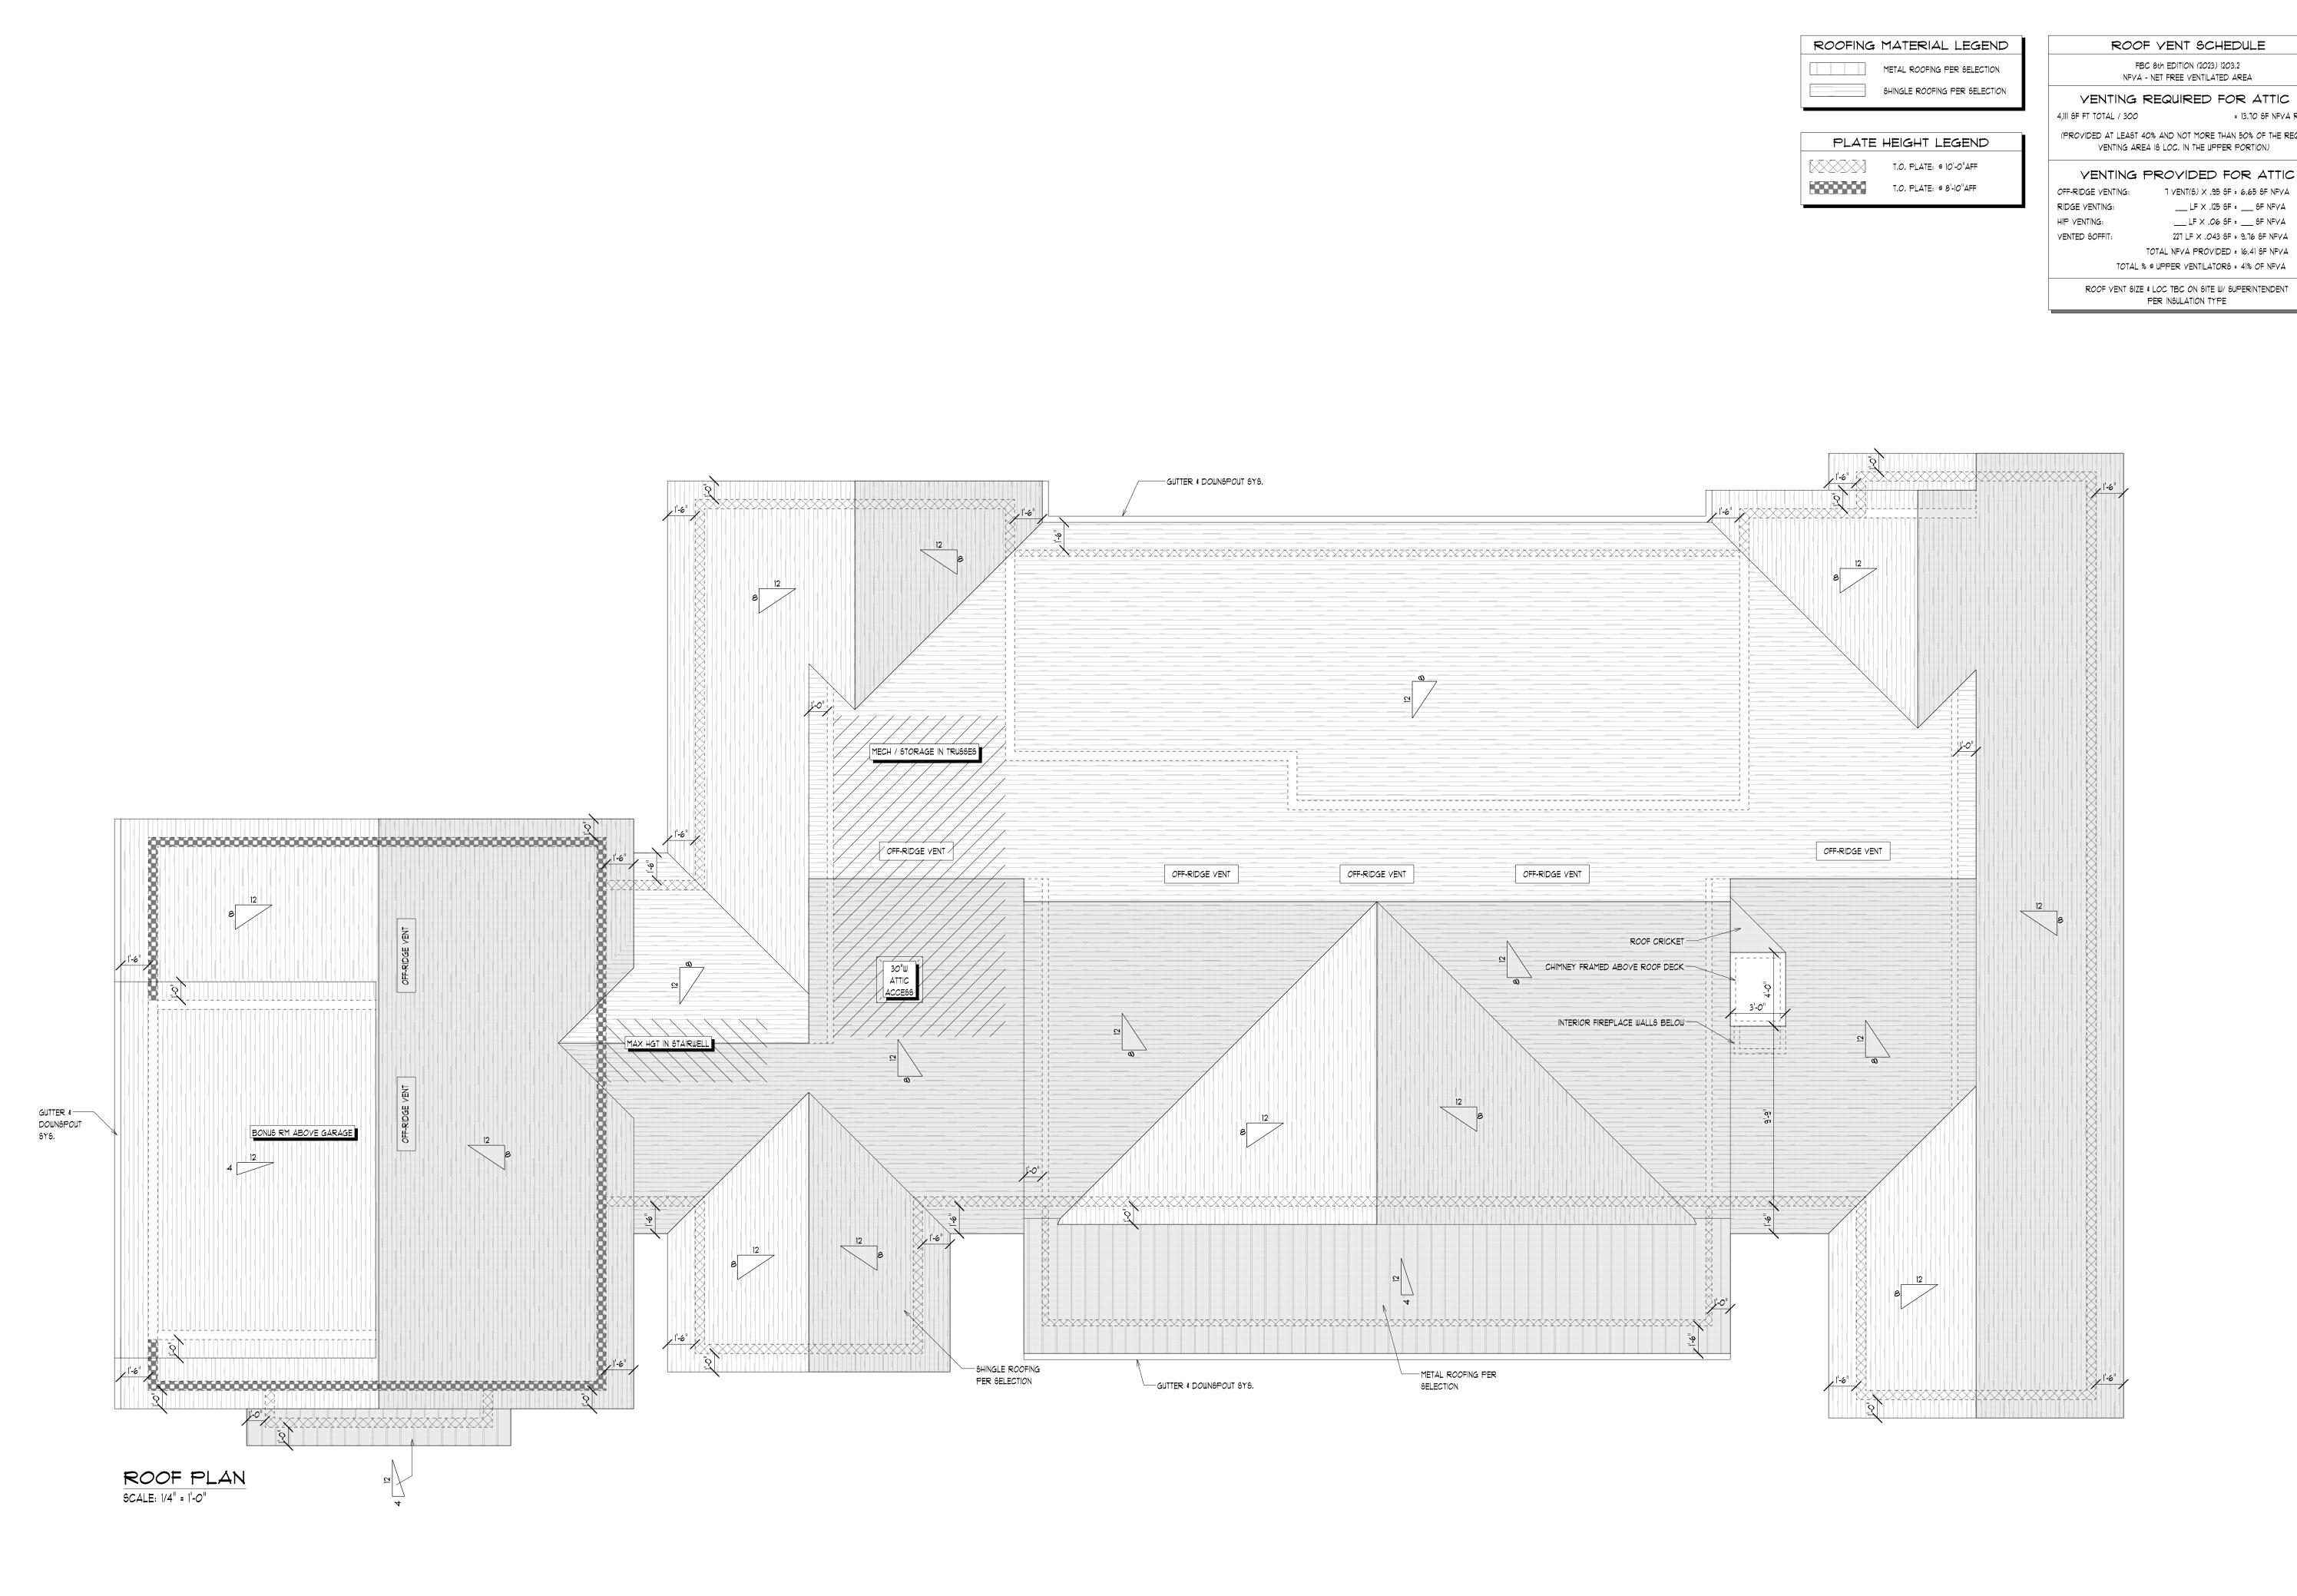

ROOF YENT SCHEDULE

= 13,70 6F NFYA REQ'D

(PROVIDED AT LEAST 40% AND NOT MORE THAN 50% OF THE REQ'D VENTING AREA IS LOC. IN THE UPPER PORTION)

YENTING PROVIDED FOR ATTIC 1 $VENT(6) \times .95 SF = 6.65 SF NFVA$

___ LF X .125 SF = ___ SF NFYA ___ LF X .06 SF = ___ SF NFYA

> 227 LF × .043 SF = 9.76 SF NFVA TOTAL NEVA PROVIDED = 16.41 SF NEVA

ROOF VENT SIZE & LOC TBC ON SITE W/ SUPERINTENDENT

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SALES INITIALS: OWNER INITIALS: DESCRIPTION: ROOF PLAN

> SCALE: AS NOTED SHEET NUMBER





EAST ELEVATION

SCALE: 1/4" = 1'-0"

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工井田 GAIN田Y HOME
 GAIN田-2894-N
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SALES INITIALS:

DESCRIPTION:

SOUTH / EAST

EXTERIOR ELEVATIONS

CHIMNEY SECTION

SHEET NUMBER

SCALE: AS NOTED

Δ2 O



NORTH ELEVATION

SCALE: 1/4" = 1'-0"



WEST ELEVATION

SCALE: 1/4" = 1'-0"

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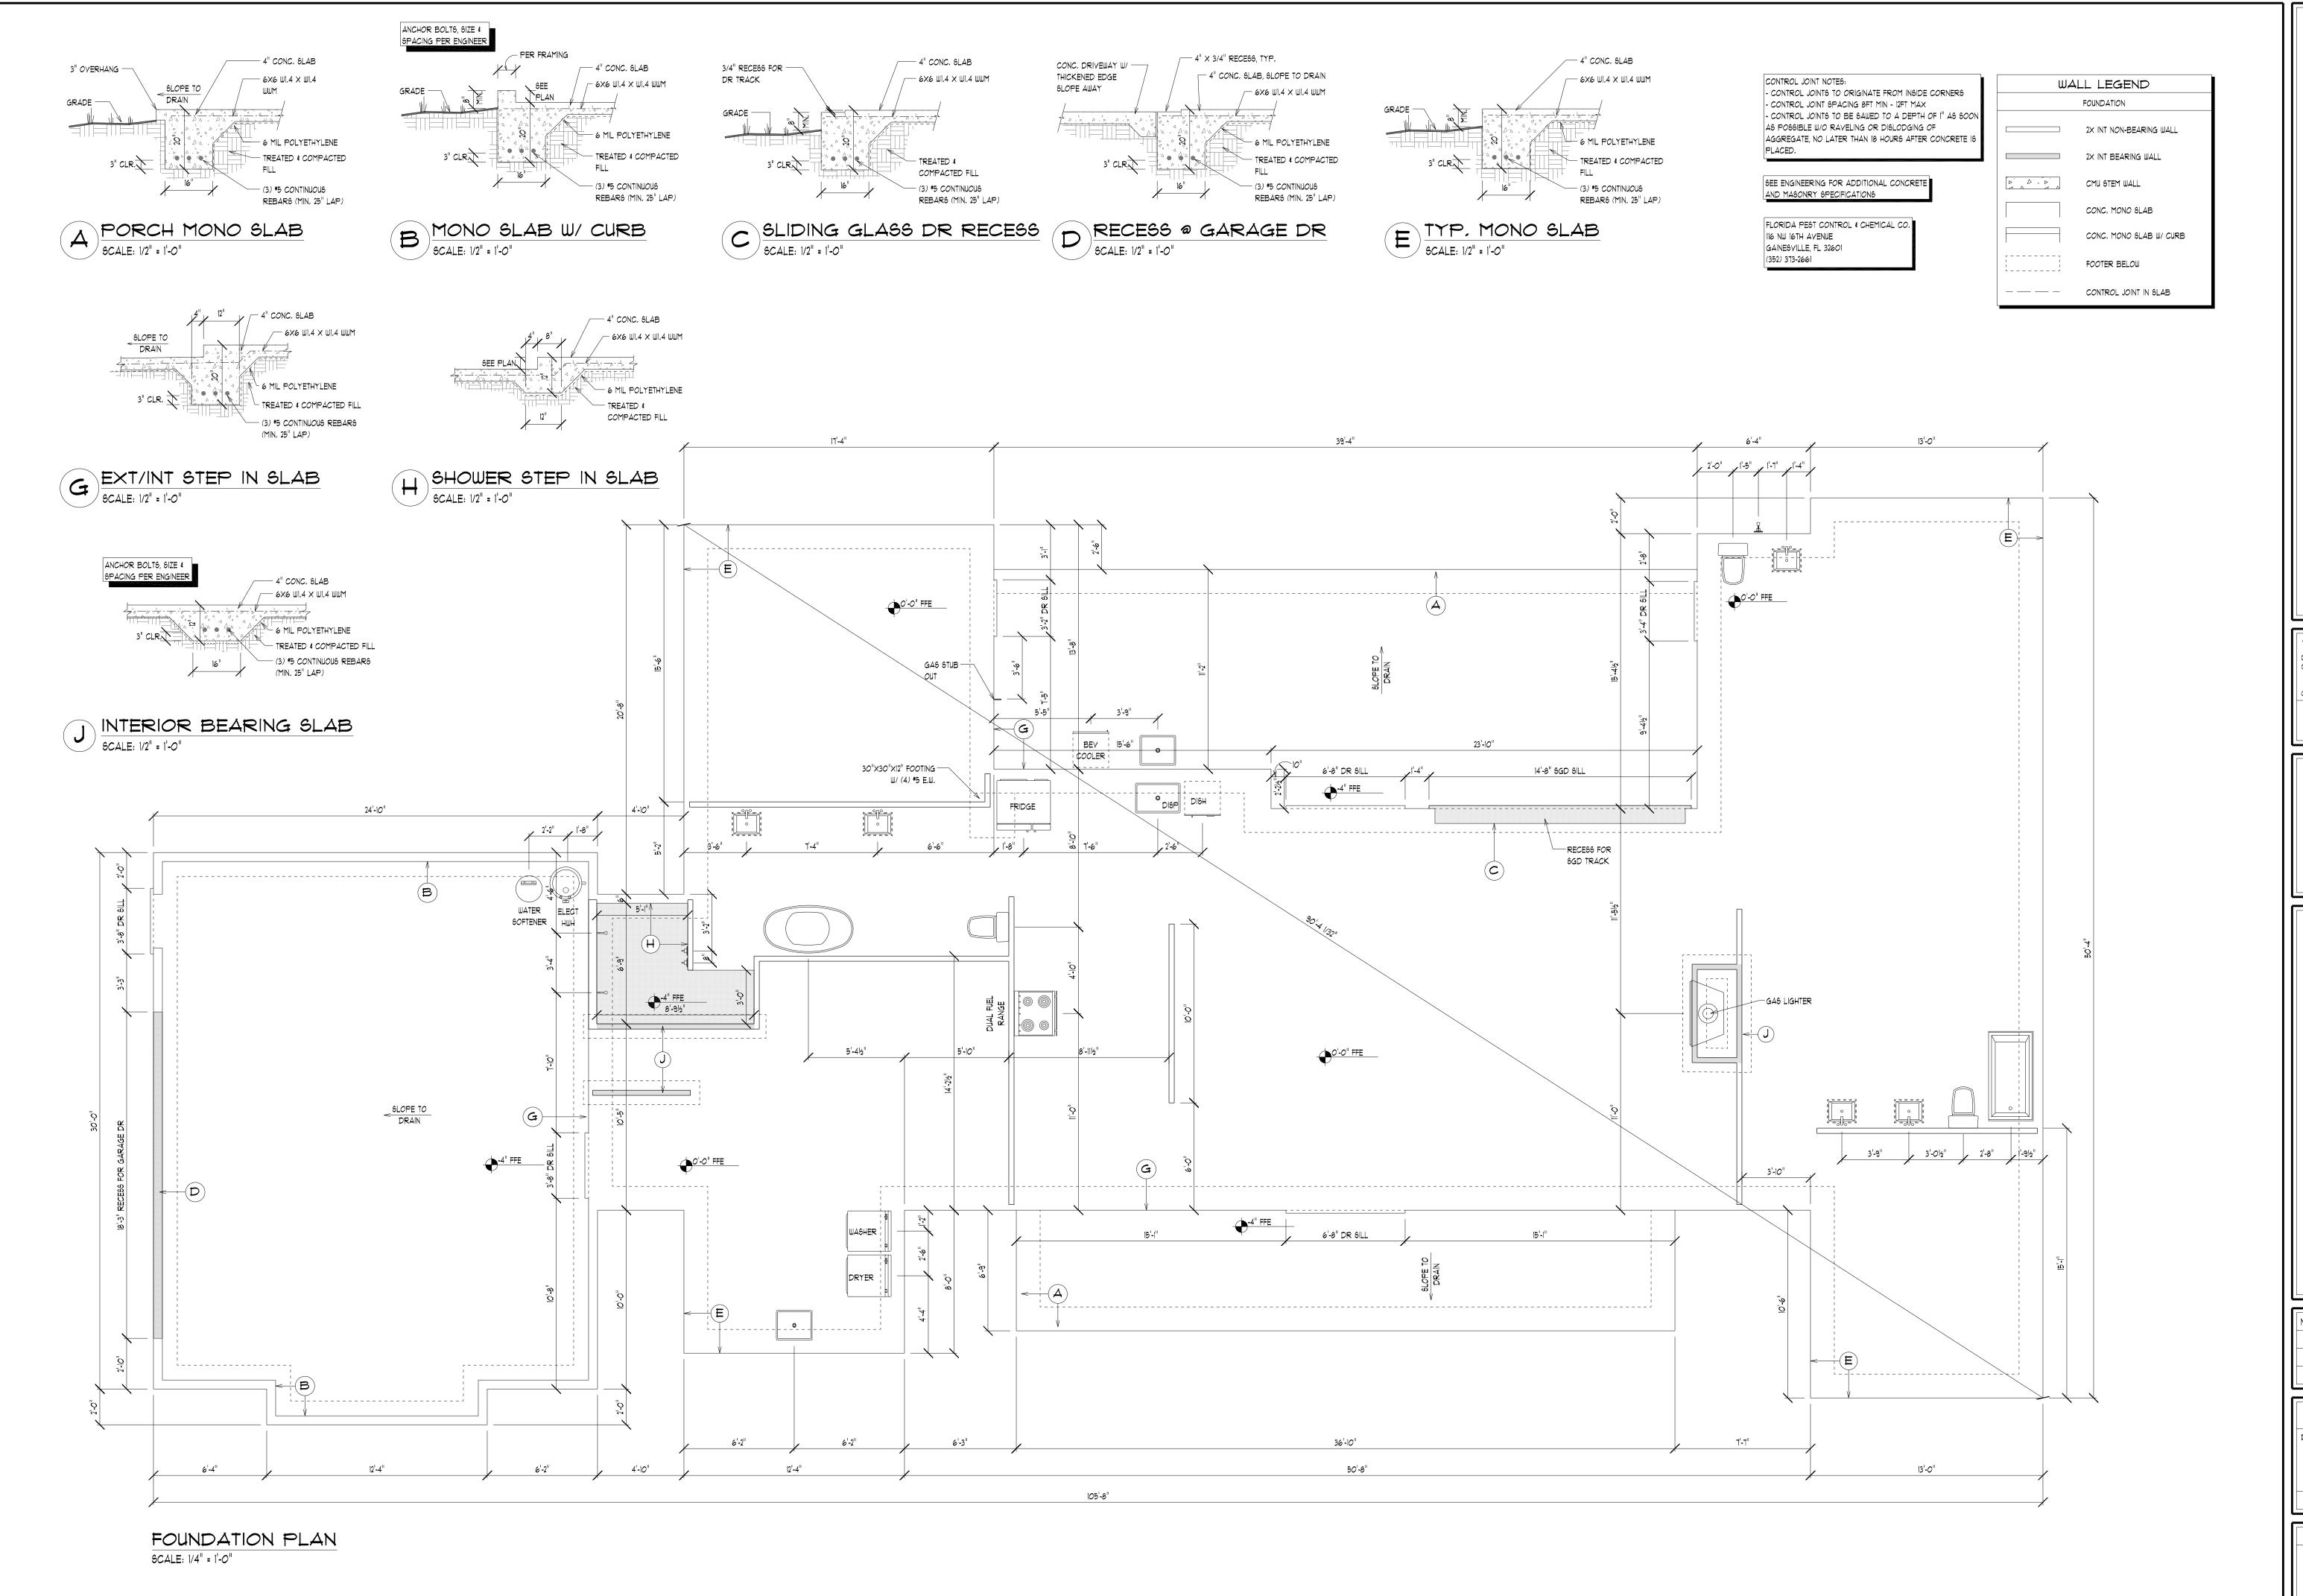
NORTH / WEST

EXTERIOR ELEVATIONS

SHEET NUMBER

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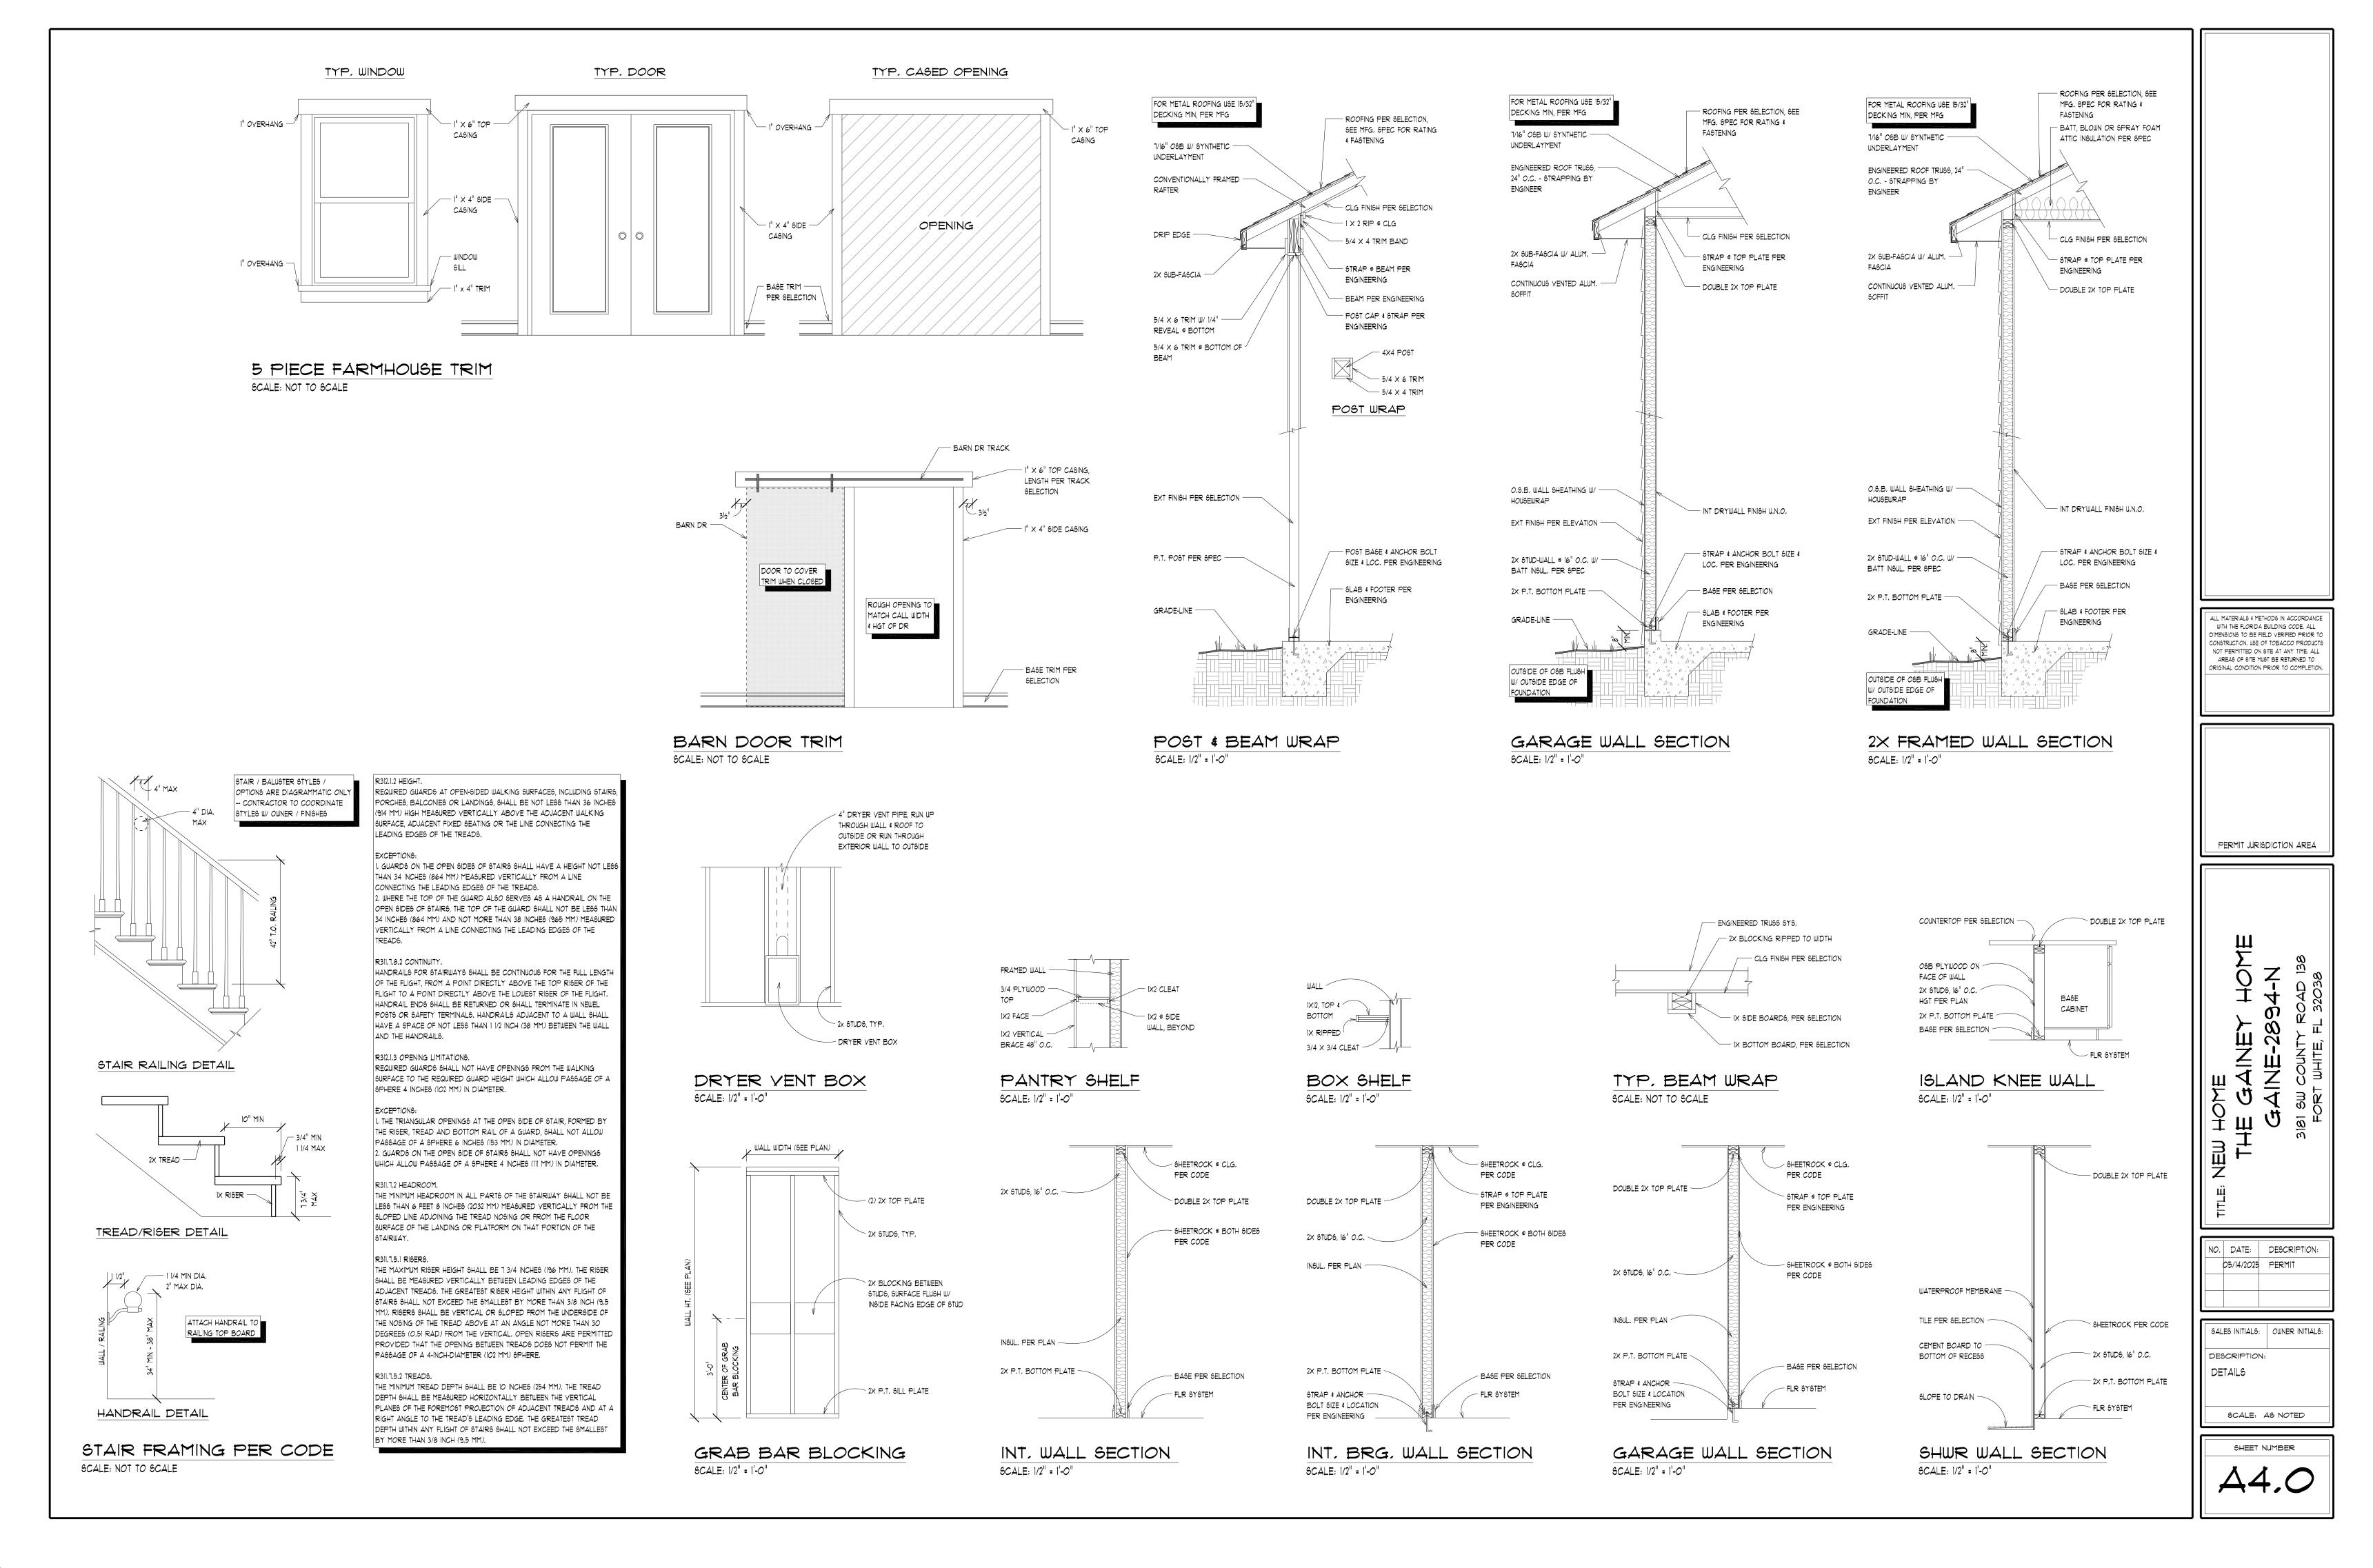
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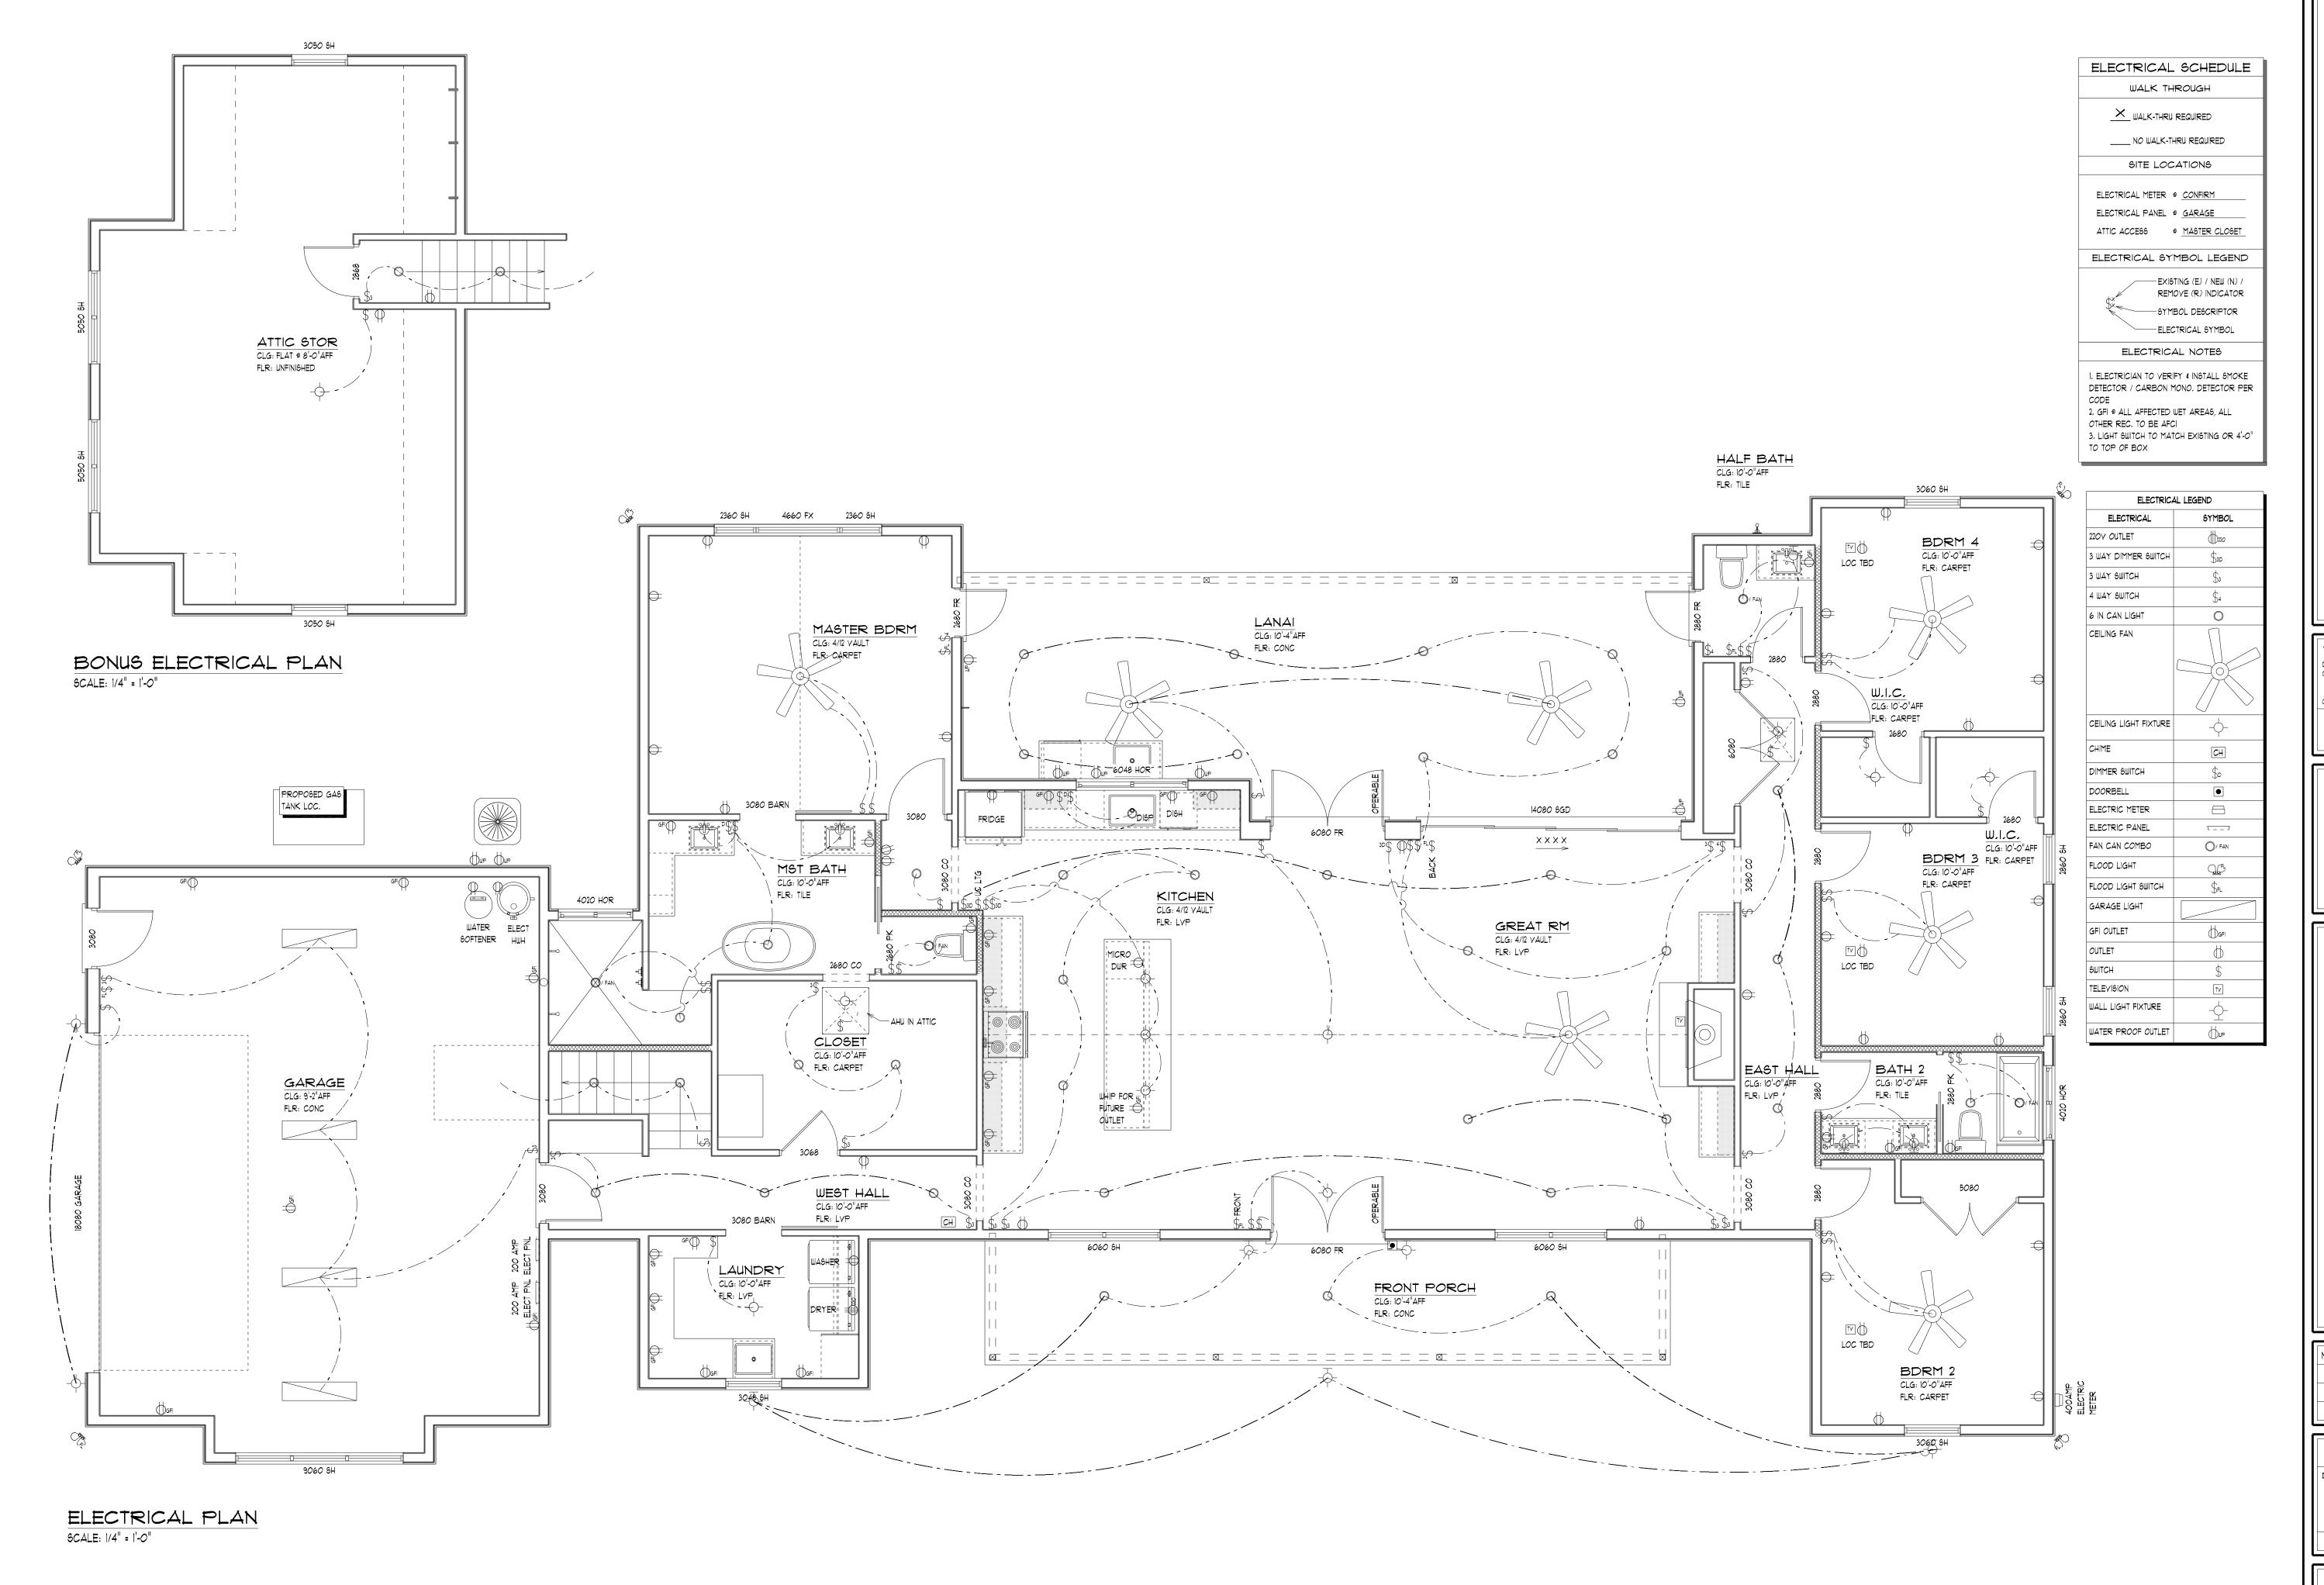
FOUNDATION PLAN

DETAILS

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ELECTRICAL PLAN

BONUS ELECTRICAL PLAN

SCALE: AS NOTED

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