




SOF PLAN

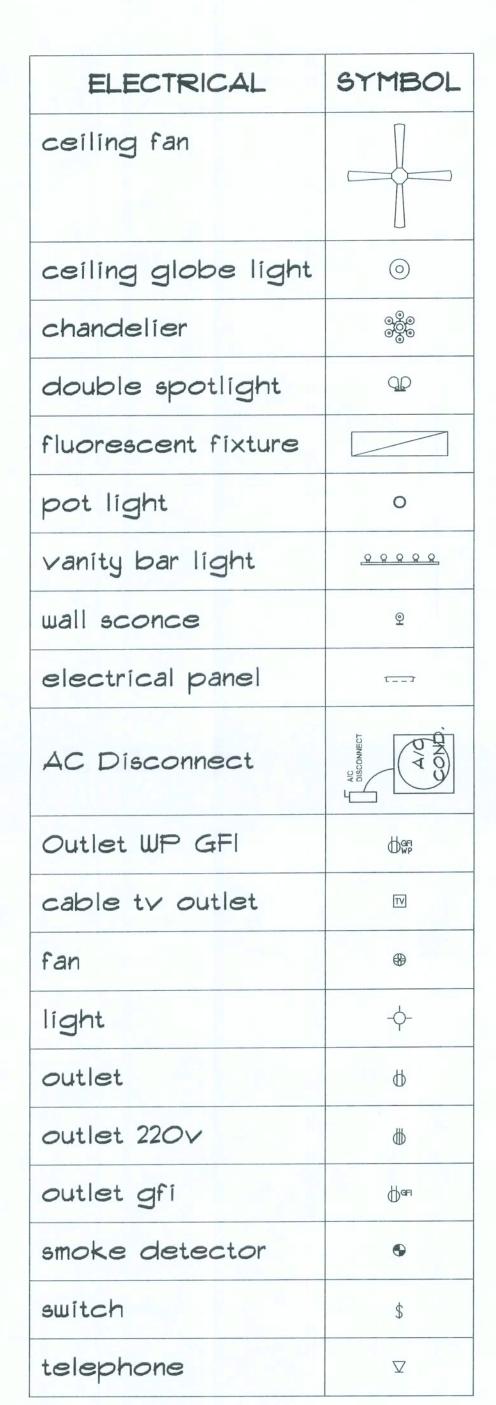

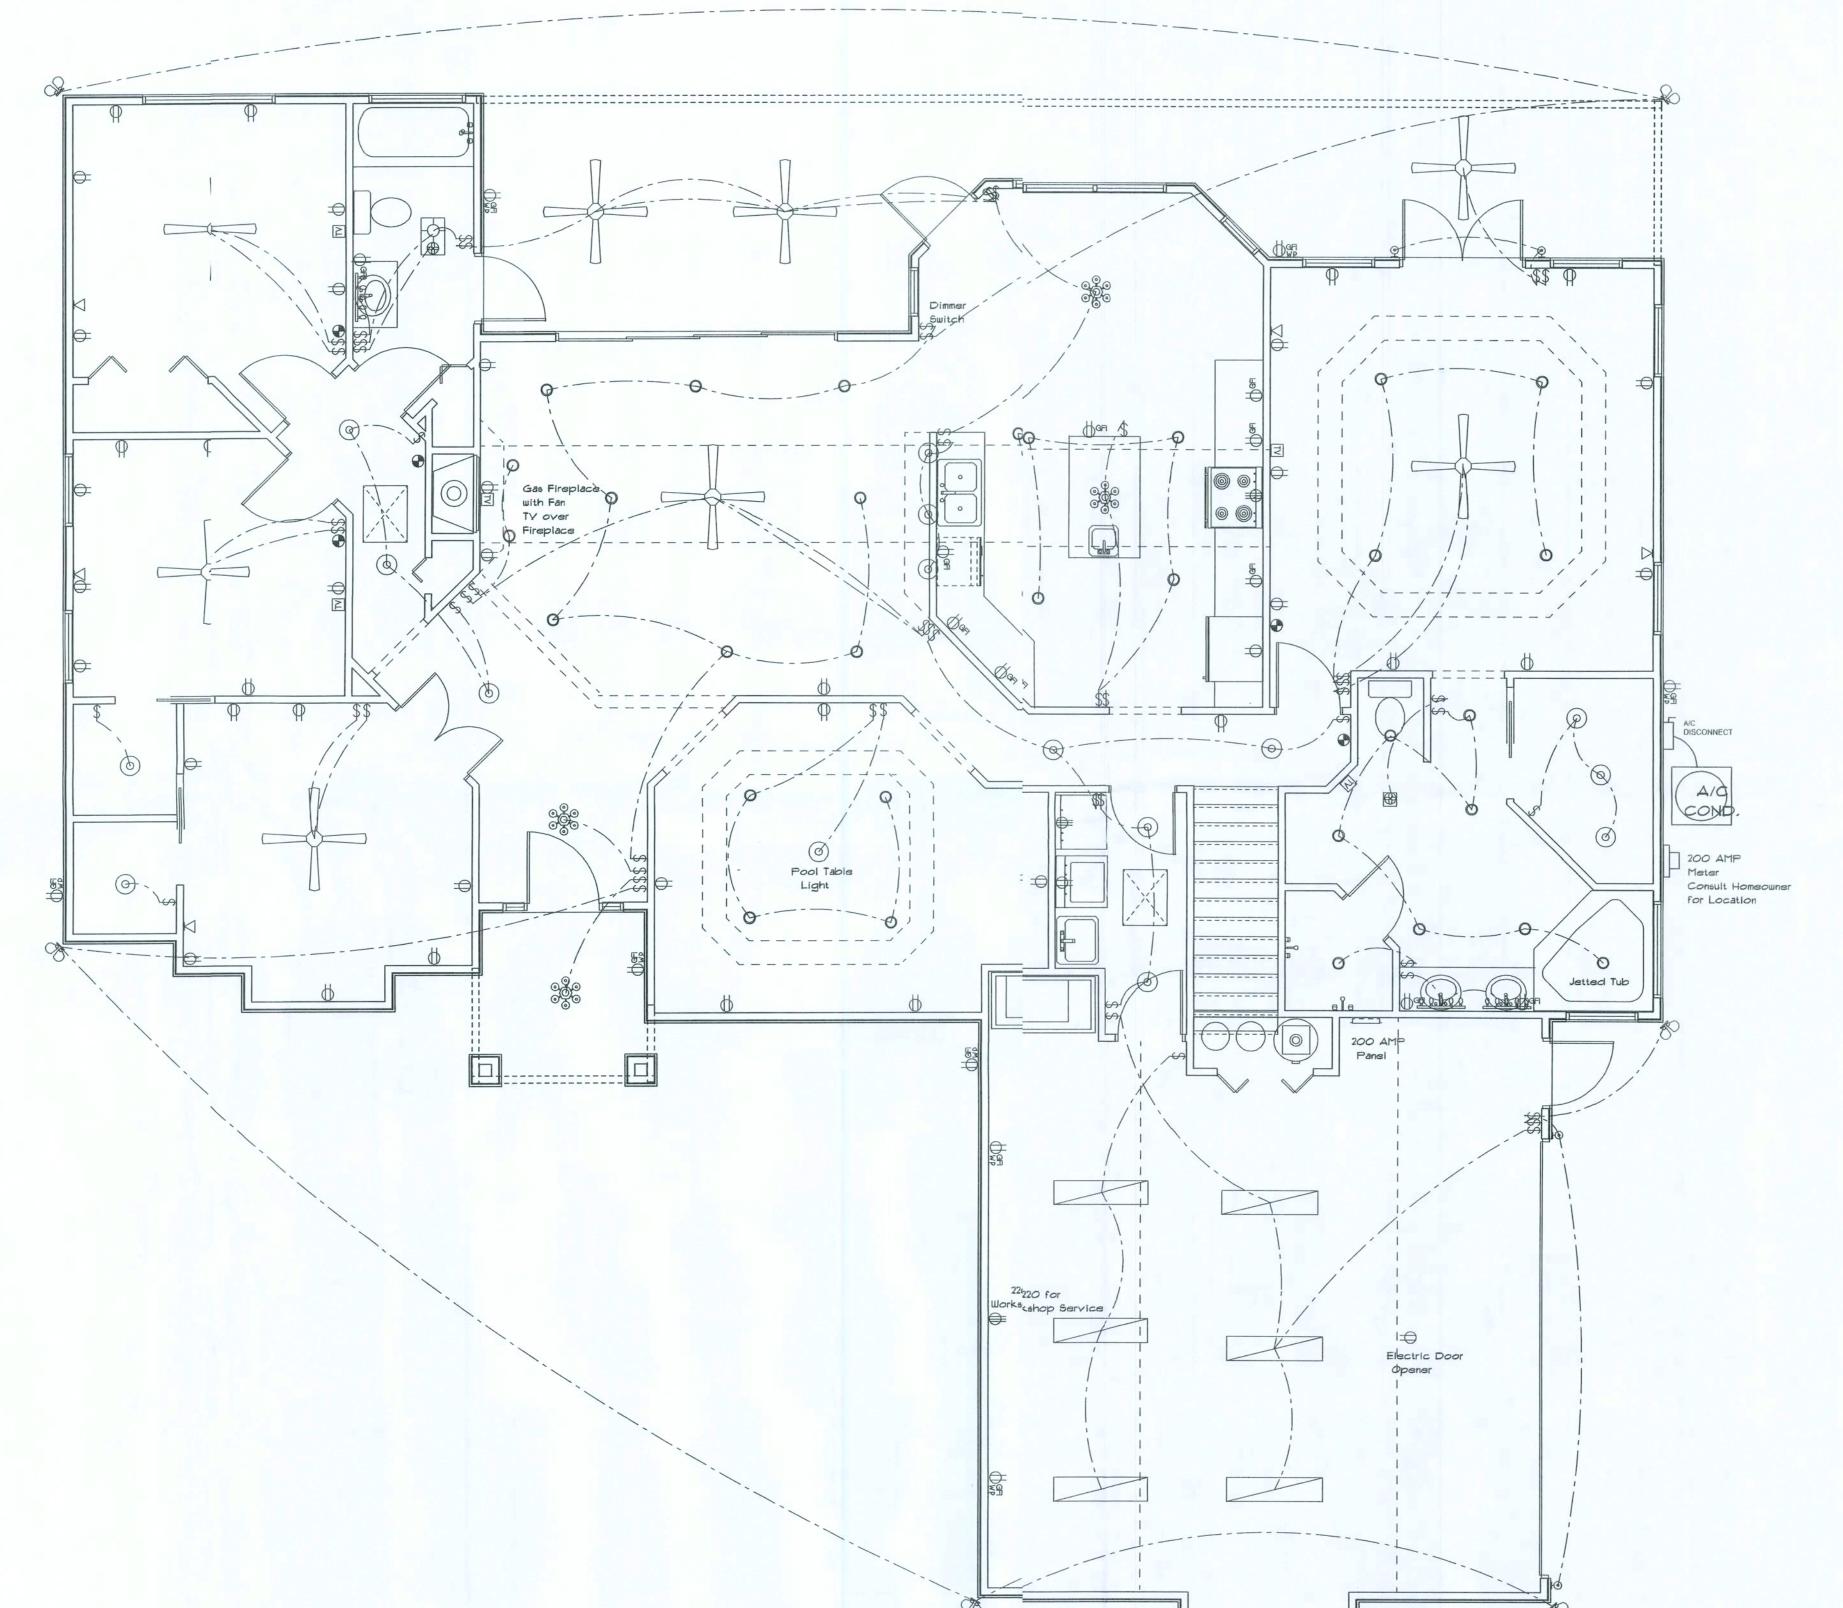

Electrical Plan Notes:

- E-I Wire all appliances, HVAC units and other equiptment per manufactures specifications.
- E-2 Consult the owner for the number or seperate telephone lines to be installed. Owner is responsible for all overages not noted on plan.
- E-3 All installations shall be per national code.
- E-4 All smoke detectors shall be 120v with battery back-up of the photoelectric type, and shall be interlocked together. Install inside and near all bedrooms.
- E-5 Telephone, television and other low voltage devices or outlets shall be as per the owners directions and in accordance with applicable sections of the National Electric Codes latest edition. Owner is responsible for all overages not noted on plan.
- E-6 Electrical contractor shall be responssible for the design and sizing of electrical service and circuits.
- E-7 Entry of service (underground or overhead) to to be determined by contractor agreement.
- E-8 All bedroom receptacles shall be AFCI (arc fault circuit interrupter).
- E-9 All outlets to be located above base flood elevation.
- E-10 All exterior GFI outlets shall be weatherproof.
- E-II Overcurrent Protection device shall be installed on the exterior ofstructures to serve as a disconnecting means. Conductors used from the exterior disconnecting means to a panel or sub panel shall have four-wire conductors, of which one conductor shall be used as an equiptment ground.

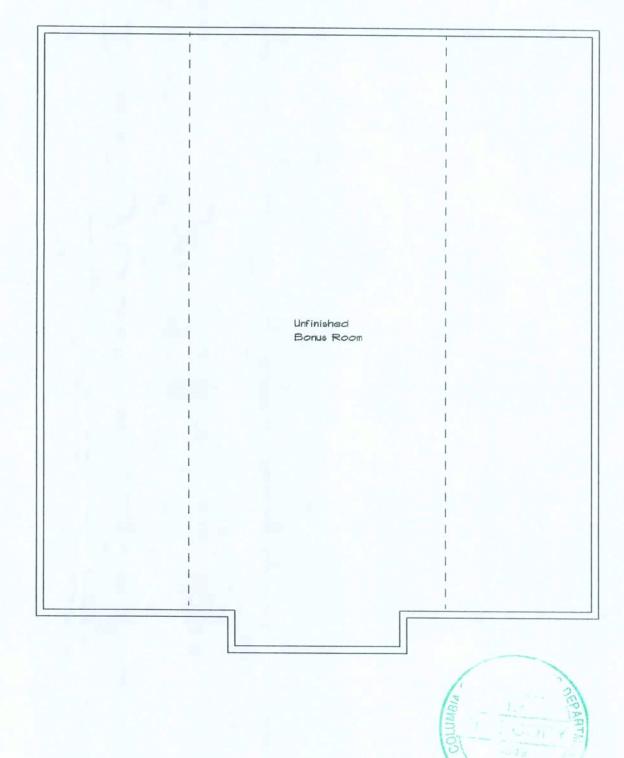

RESIDENCE
Matt and Kristy Stape

AIDRESS: ColumbiaCounty, Florida

Woodman Park Builders, Inc. Lake City, Florida Phone: (336) 755 - 2411 Fax: (3&) 755-8684 Email:

PRIN'ED DATE:

DRAWN BY: CHECKED BY:

DESGNED BY:


Mark Haddo-x


FINALS DATE:


JOB NUMBER:


DRAWNG NUMBER
A-2


Electrical Plan

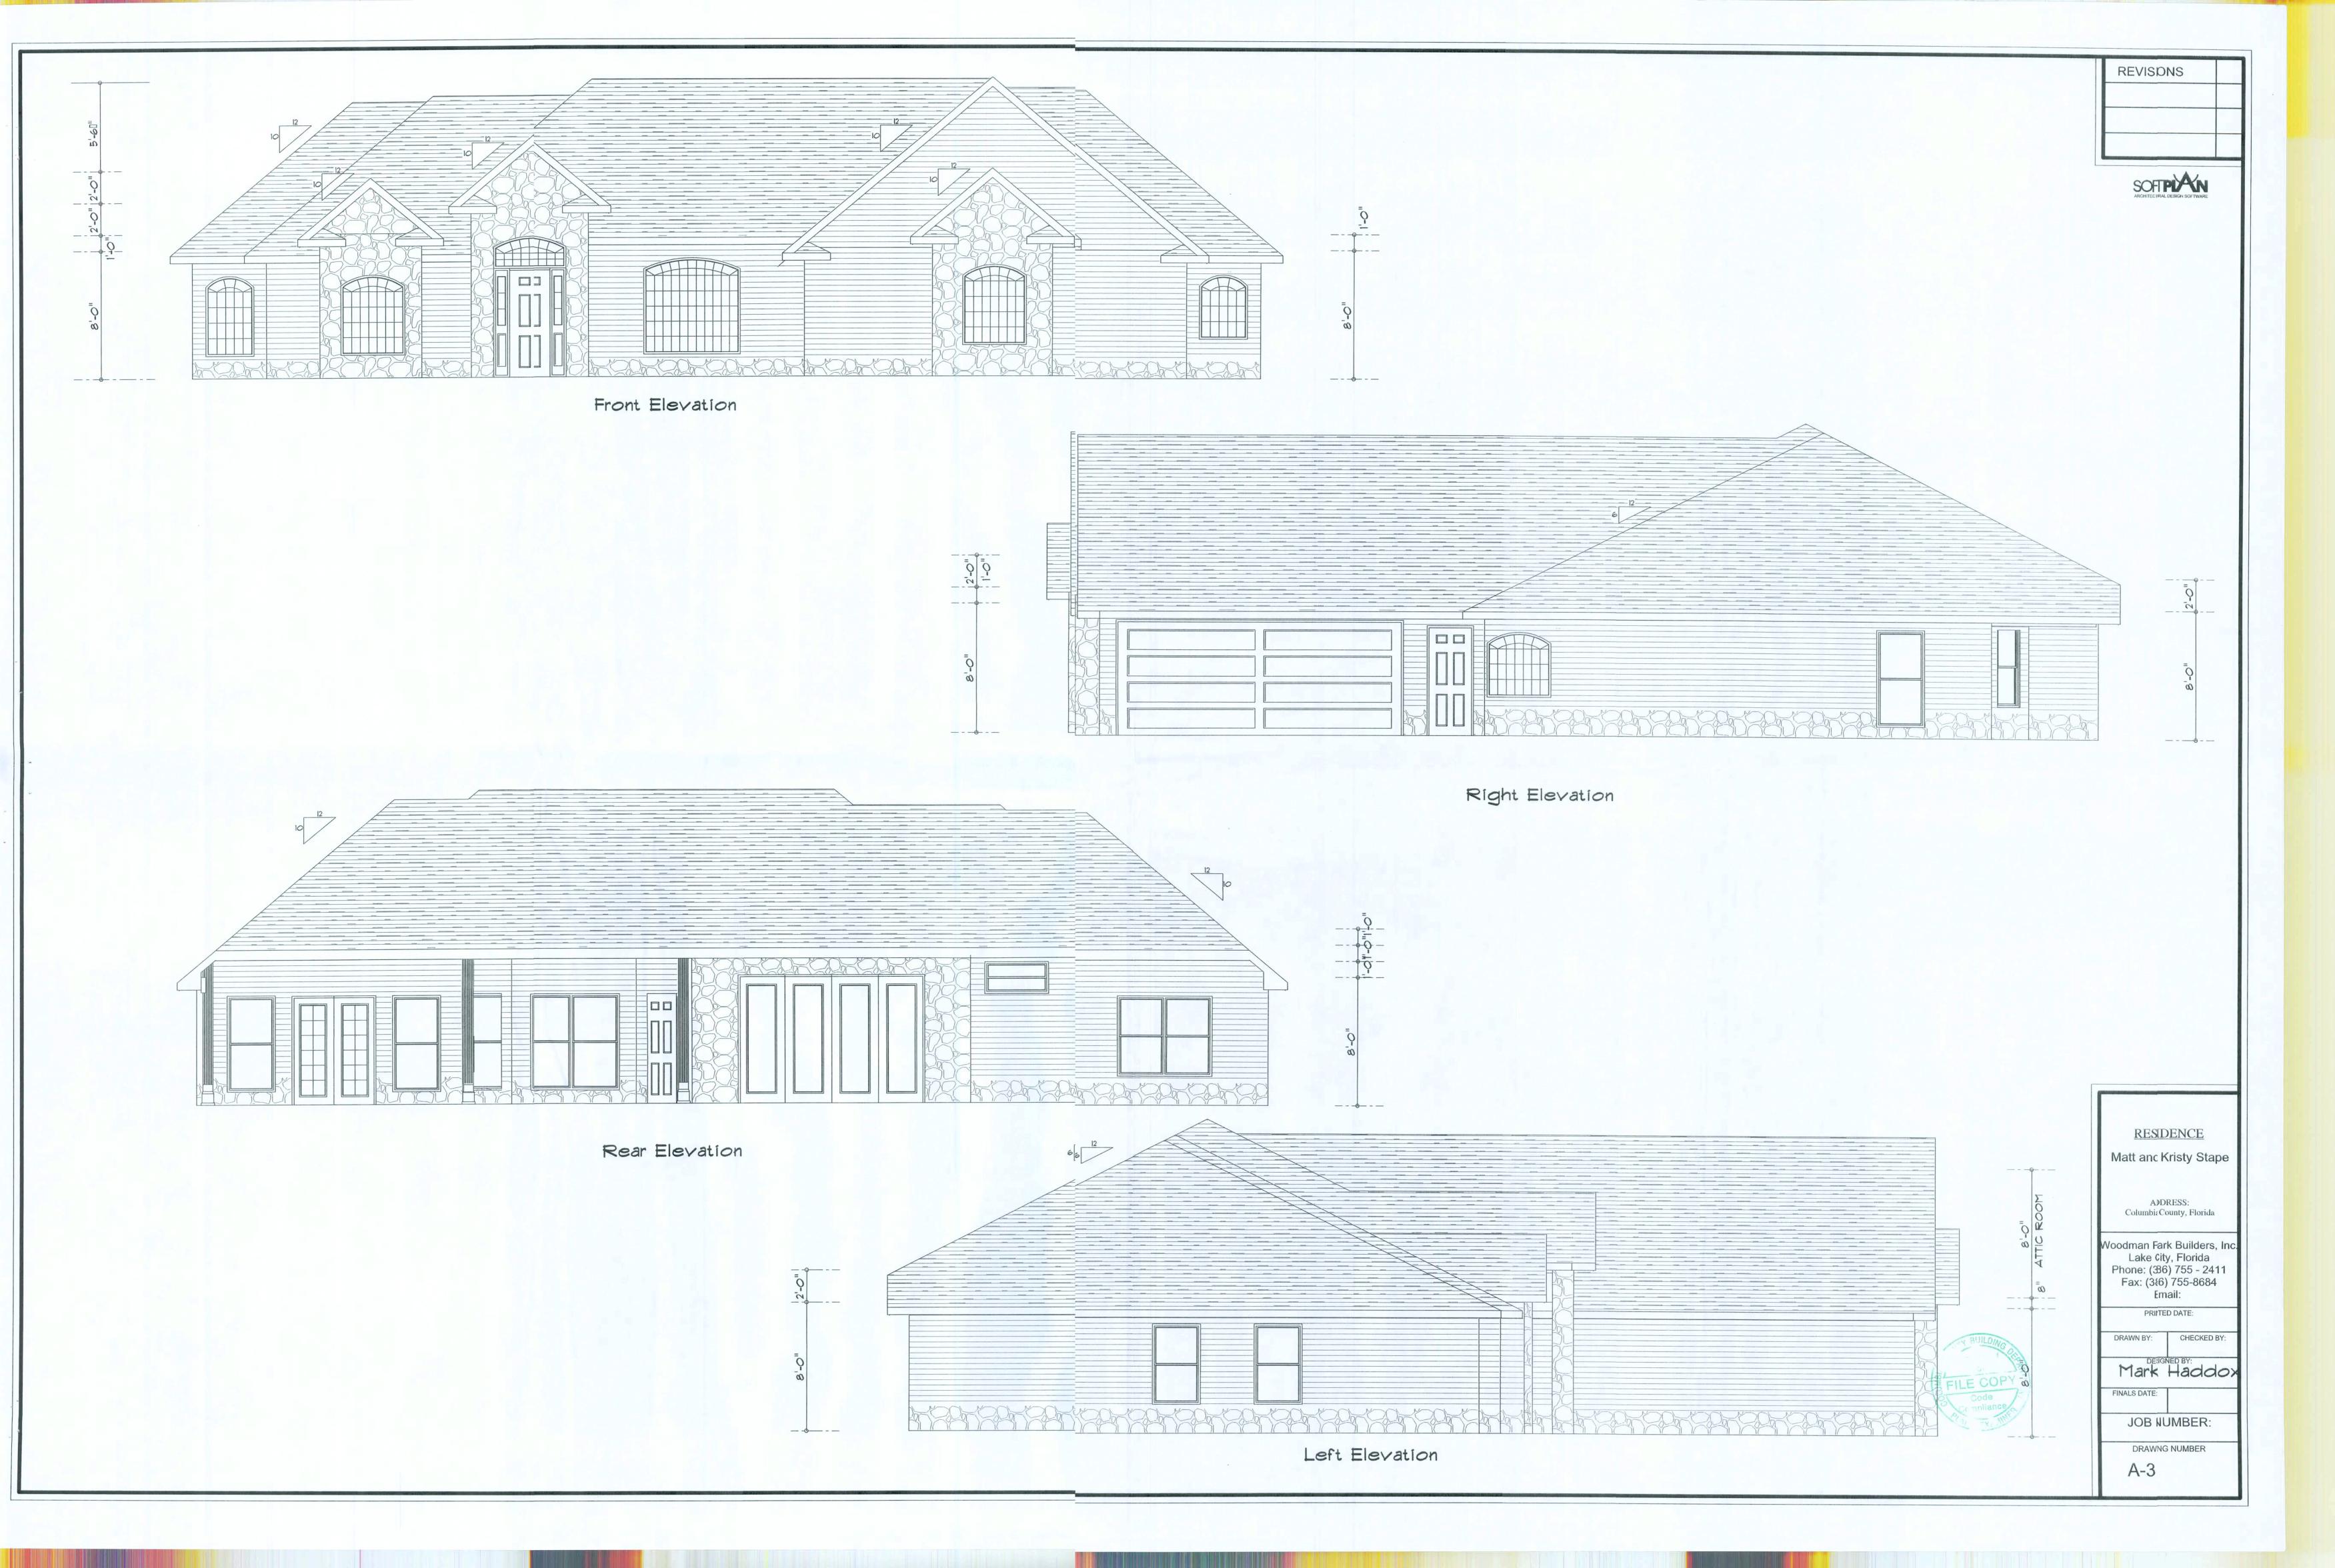

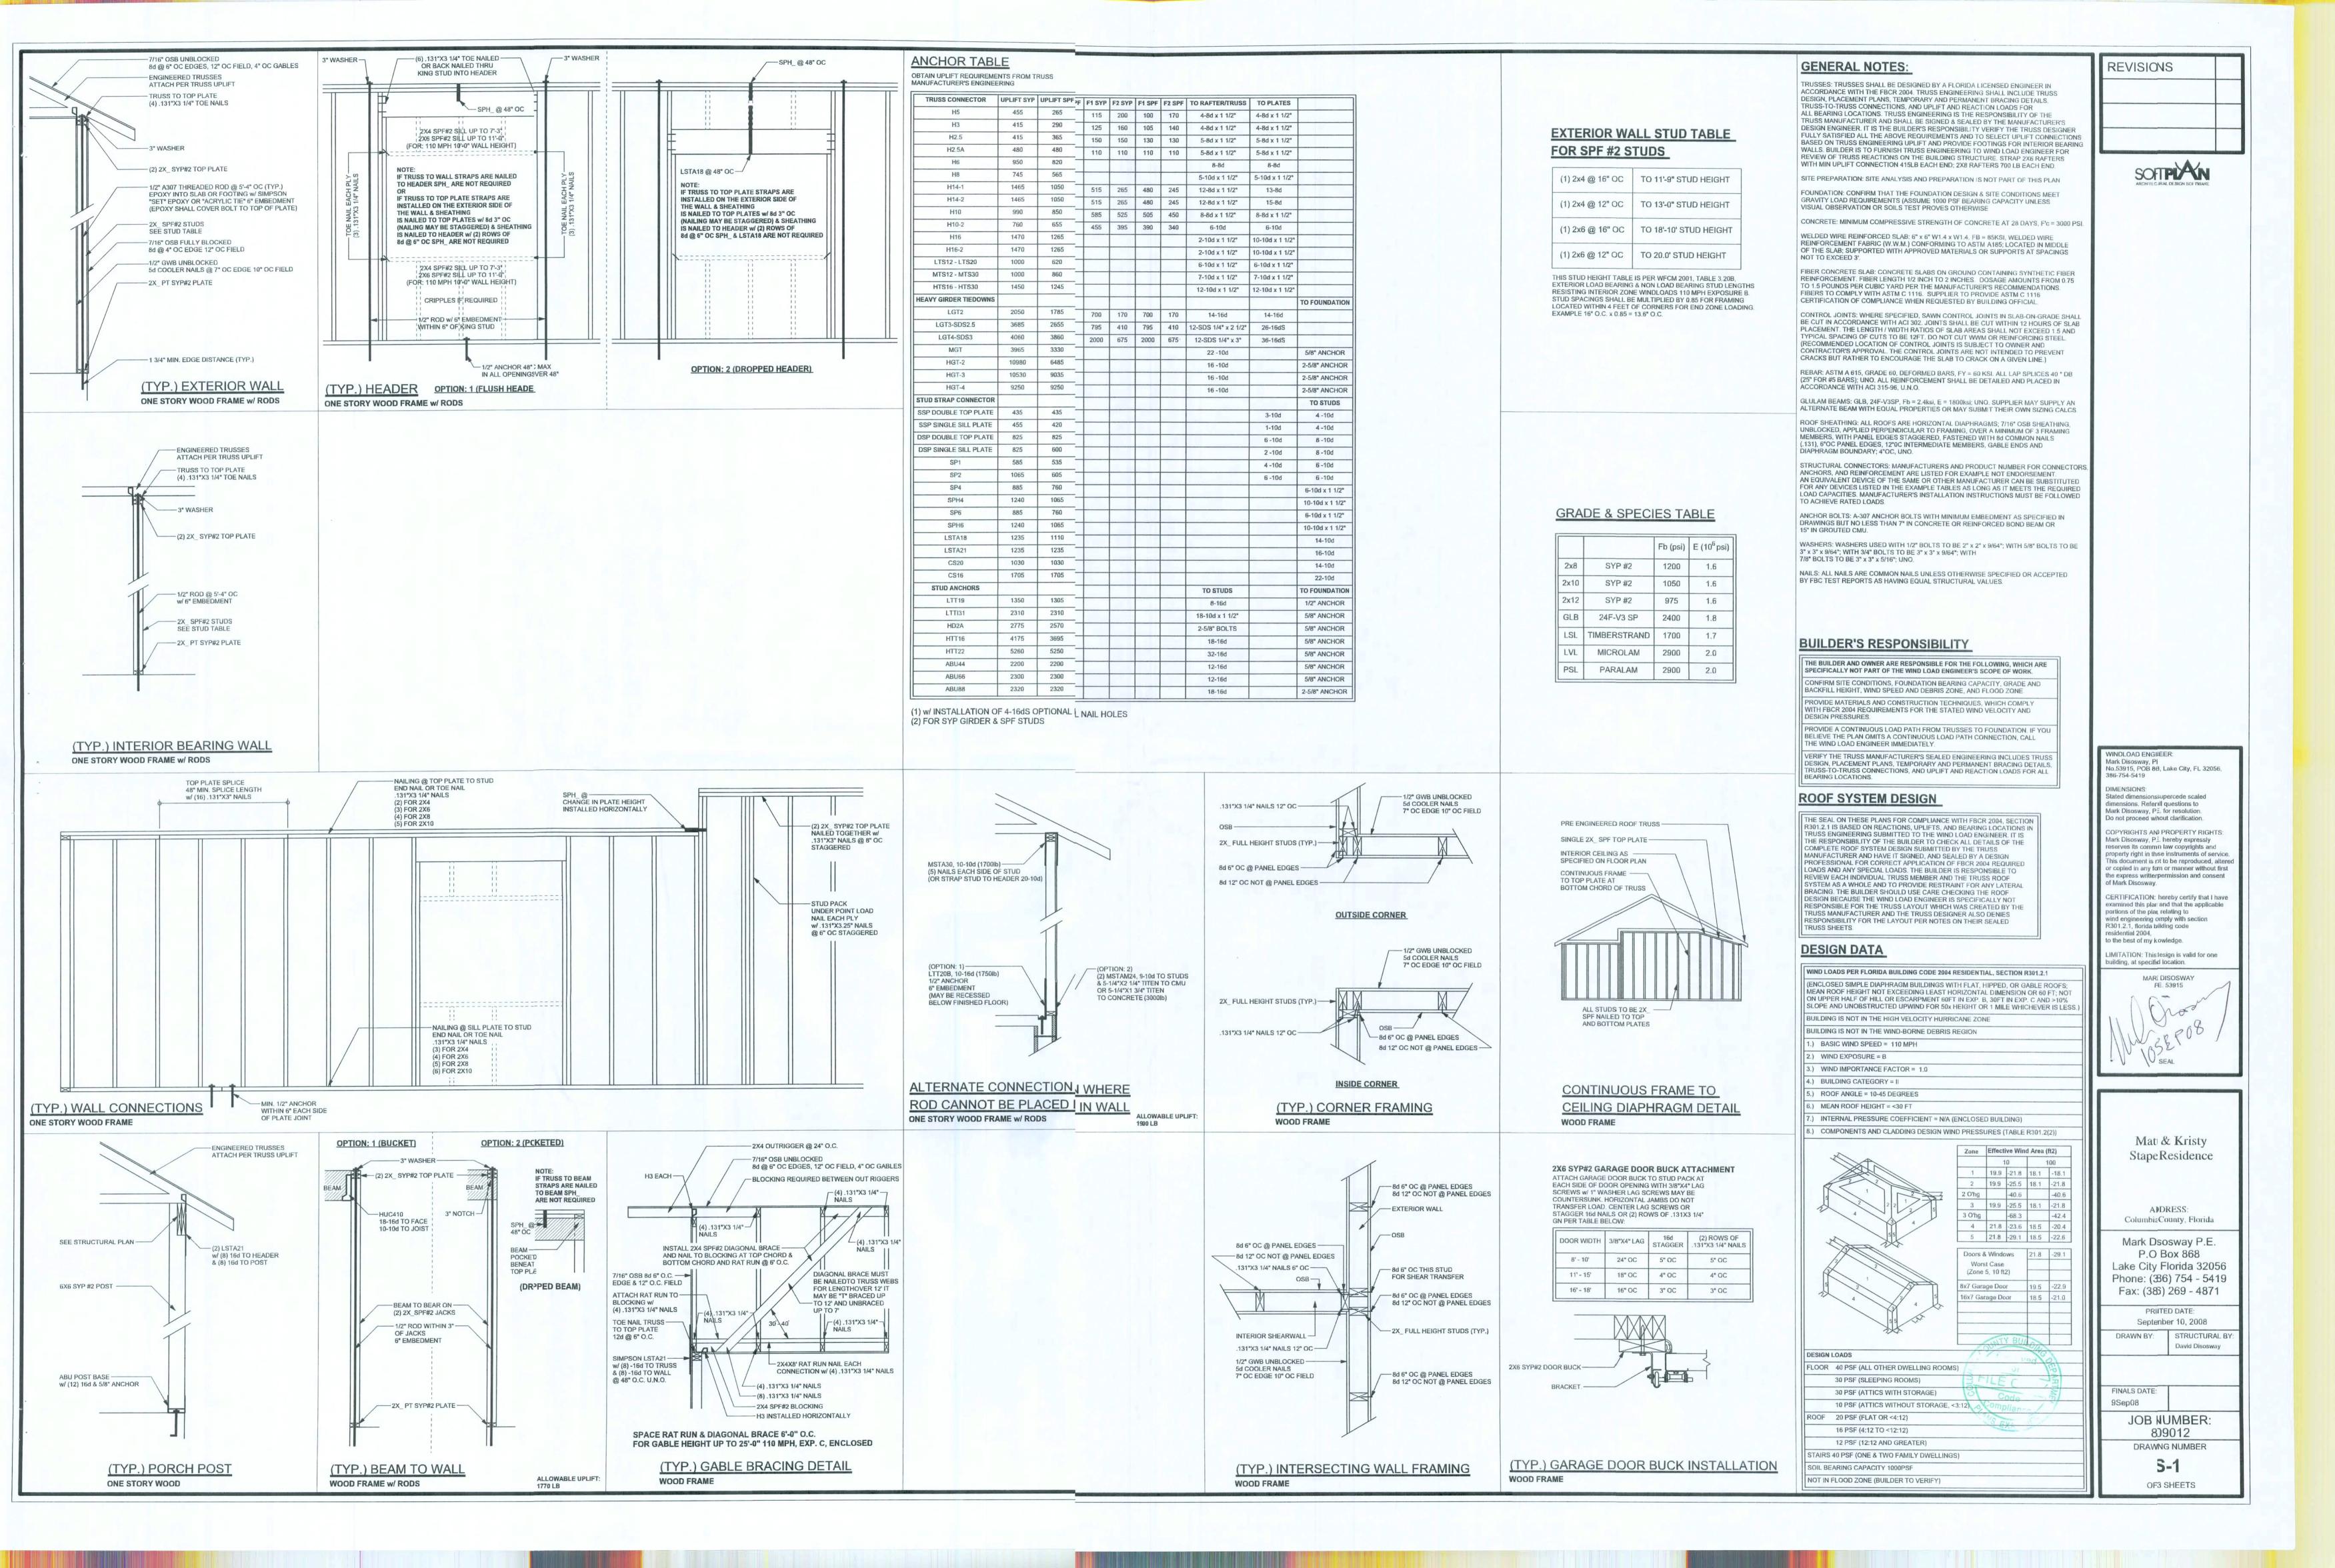

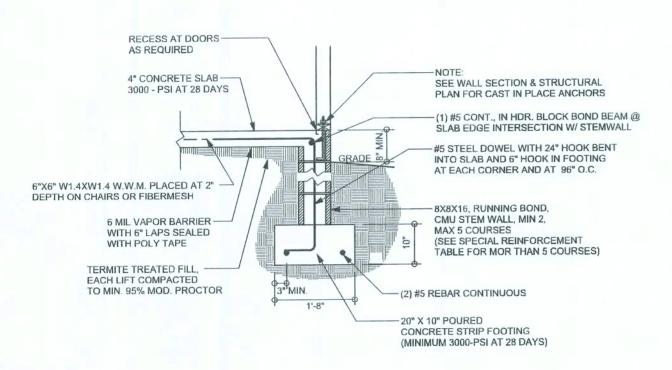

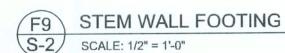

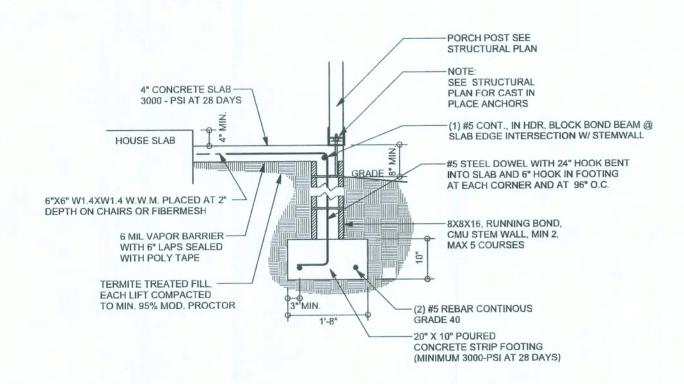


STEM WALL PORCH FOOTING S-2 SCALE: 1/2" = 1'-0"


TALL STEM WALL TABLE

The table assumes 60 ksi reinforcing bars with 6" hook in the footing and bent 24" into the reinforced slab at the top. The vertical steel is to be placed toward the tension side of the CMU wall (away from the soil pressure, within 2" of the exterior side of the wall). If the wall is over 8' high, add Durowall ladder reinforcement at 16"OC vertically or a horizontal bond beam with 1#5 continuous at mid height. For higher parts of the wall 12" CMU may be used with reinforcement as shown in the table below.

STEMWALL HEIGHT (FEET)	UNBALANCED BACKFILL HEIGHT	VERTICAL REINFORCEMENT FOR 8" CMU STEMWALL (INCHES O.C.)			VERTICAL REINFORCEMENT FOR 12" CMU STEMWALL (INCHES O.C.)		
		#5	#7	#8	#5	#7	#8
3.3	3.0	96	96	96	96	96	96
4.0	3.7	96	96	96	96	96	96
4.7	4.3	88	96	96	96	96	96
5.3	5.0	56	96	96	96	96	96
6.0	5.7	40	80	96	80	96	96
6.7	6.3	32	56	80	56	96	96
7.3	7.0	24	40	56	40	80	96
8.0	7.7	16	32	48	32	64	80
8.7	8.3	8	24	32	24	48	64
9.3	9.0	8	16	24	16	40	48

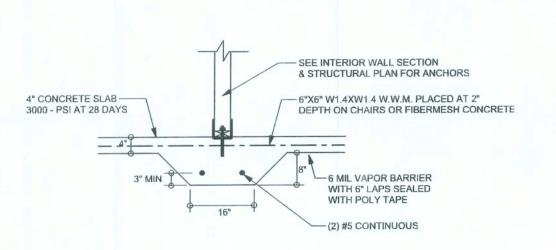





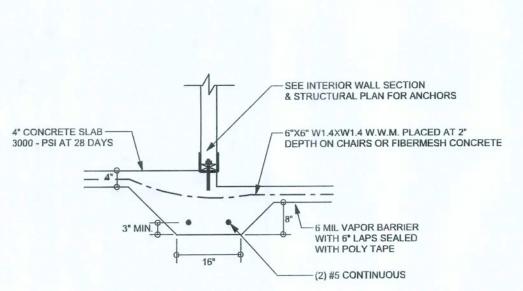



S-2 SCALE: 1/2" = 1'-0"

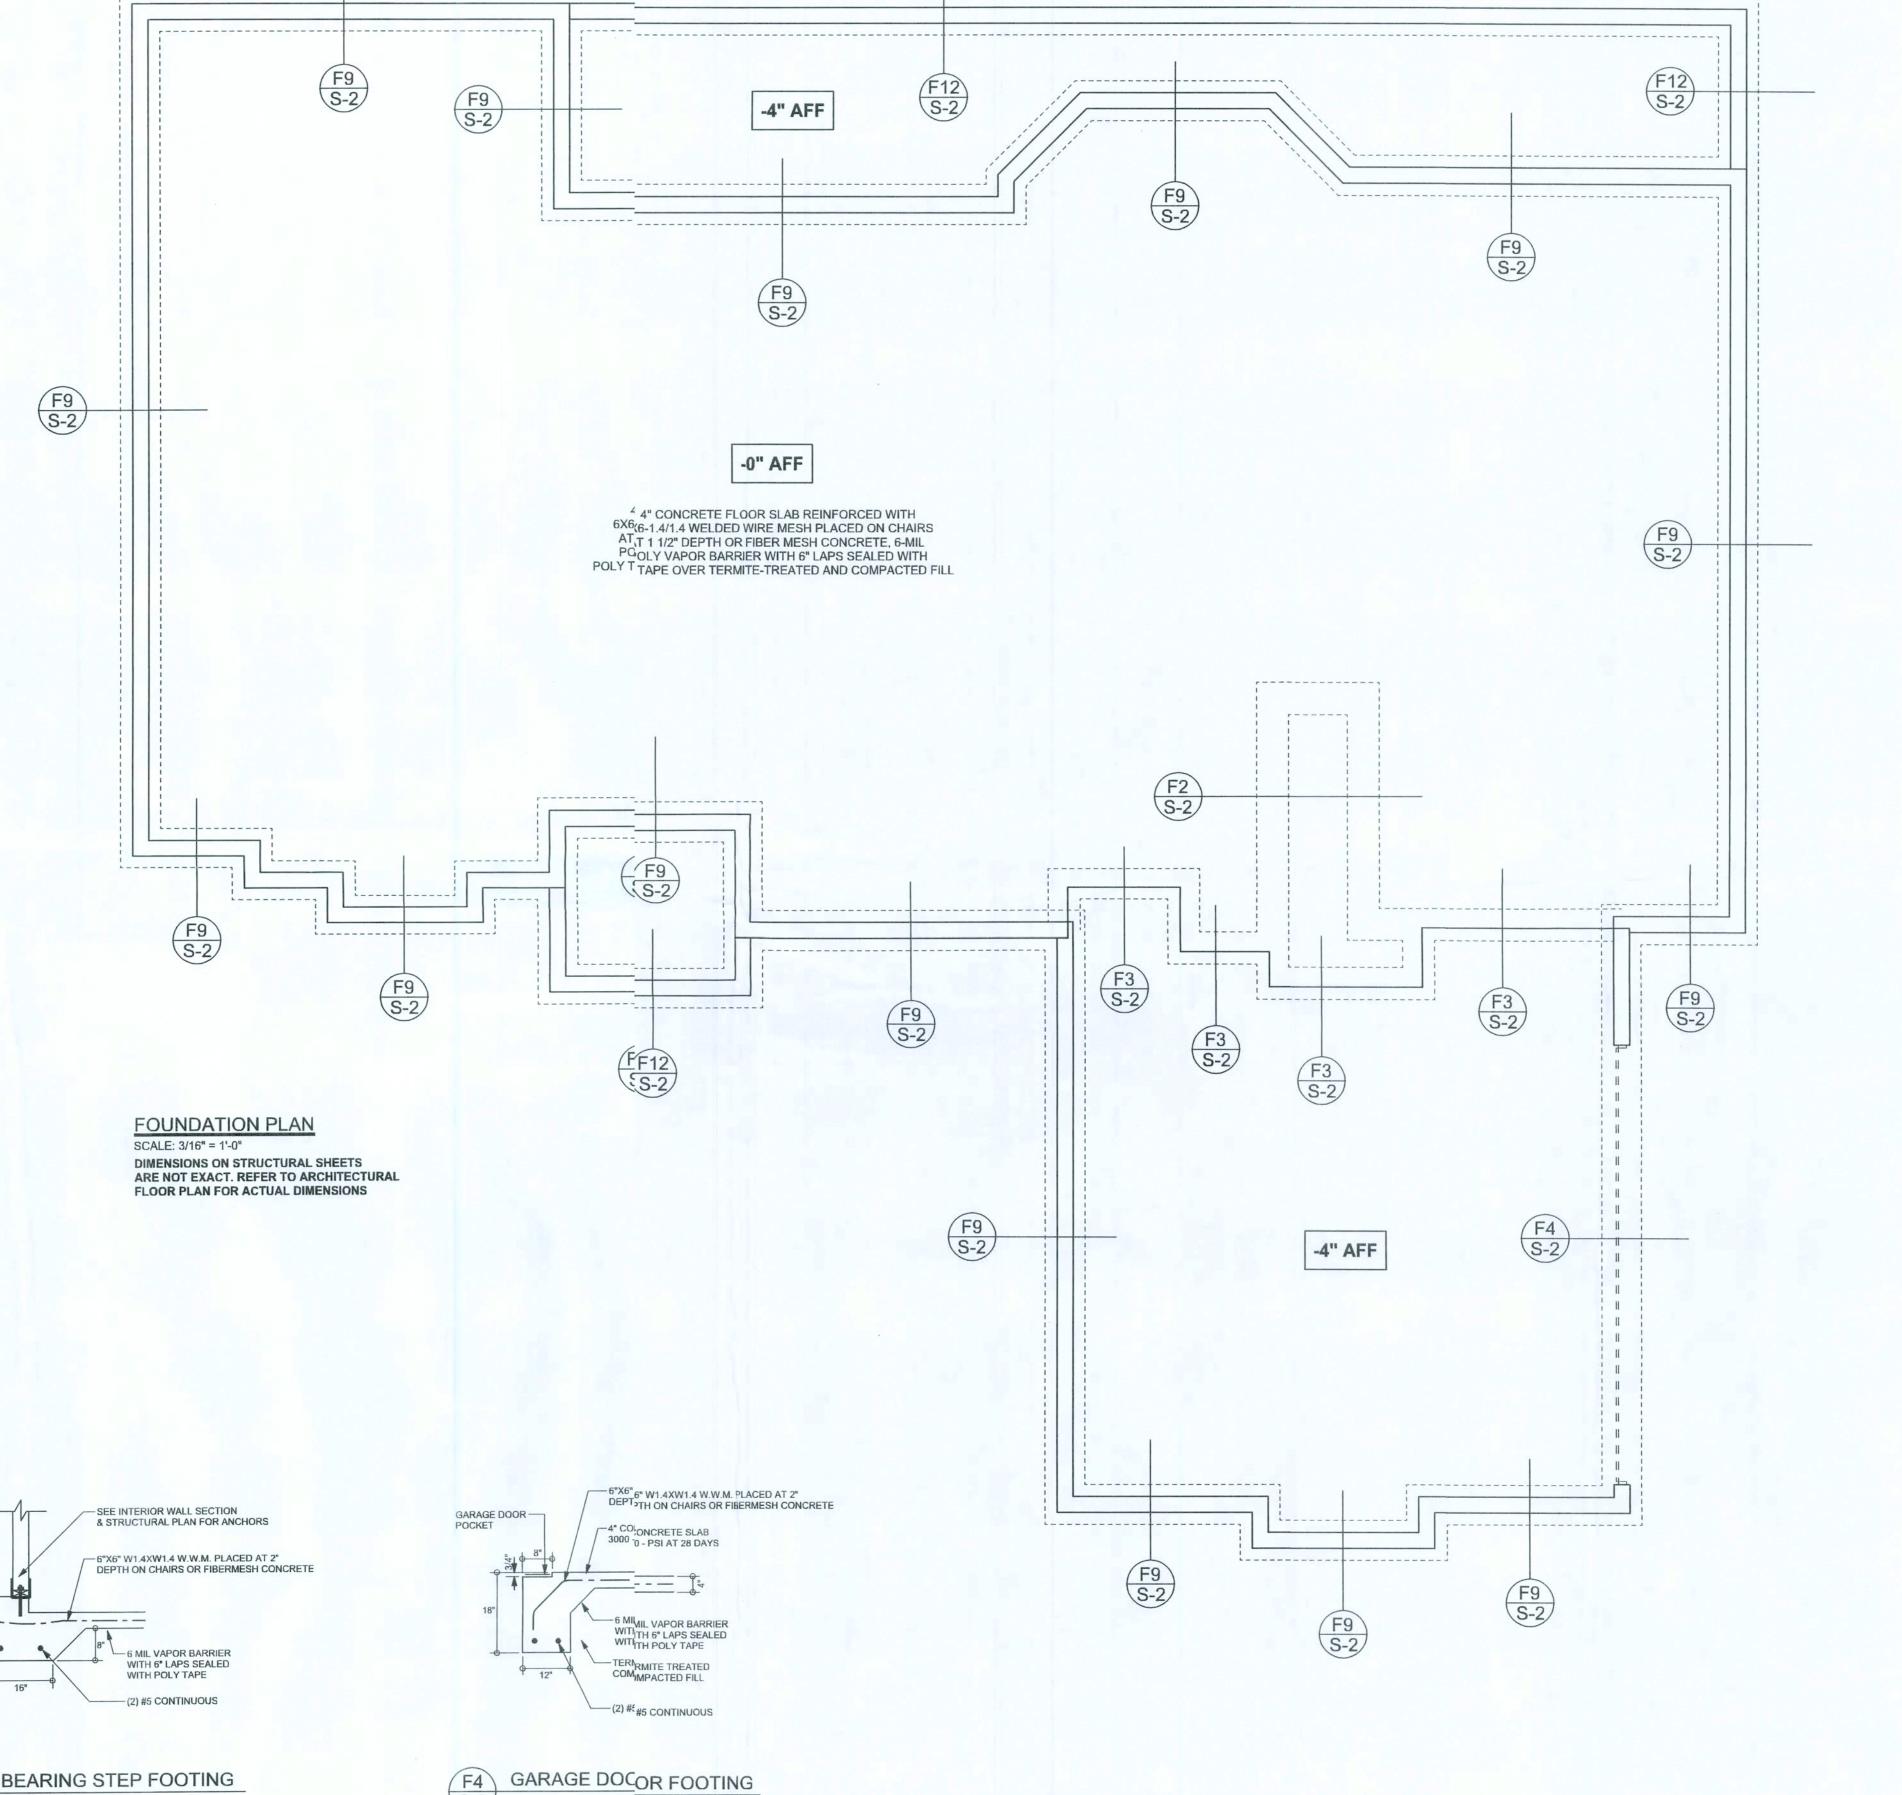

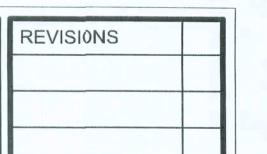

SCFTPLAN

Mark Disosway,PE No.53915, POB368, Lake City, FL 32056, 386-754-5419 DIMENSIONS: Stated dimensions supercede scaled dimensions. Rear all questions to Mark Disosway,P.E. for resolution.

COPYRIGHTS IND PROPERTY RIGHTS: Mark Disosway, P.E. hereby expressly reserves its common law copyrights and property right in hese instruments of service. This document i not to be reproduced, altered or copied in anyform or manner without first the express writen permission and consent of Mark Disoswy.

CERTIFICATIOI: I hereby certify that I have examined this pan, and that the applicable portions of the ran, relating to wind engineerin comply with section R301.2.1, florid: building code residential 2004 to the best of m knowledge. LIMITATION: The design is valid for one building, at specified location.

MARK DISOSWAY P.E. 53915

Matt & Kristy Stare Residence

ADDRESS: Columlia County, Florida

Mark Disosway P.E. P.J. Box 868 Lake Ciy, Florida 32056 Phone: 386) 754 - 5419 Fax: (386) 269 - 4871

> September 10, 2008 STRUCTURAL BY


> > David Disosway

FINALS DATE:

9Sep08 JOE NUMBER: 809012

DRAWING NUMBER **S-2**

OF 3 SHEETS

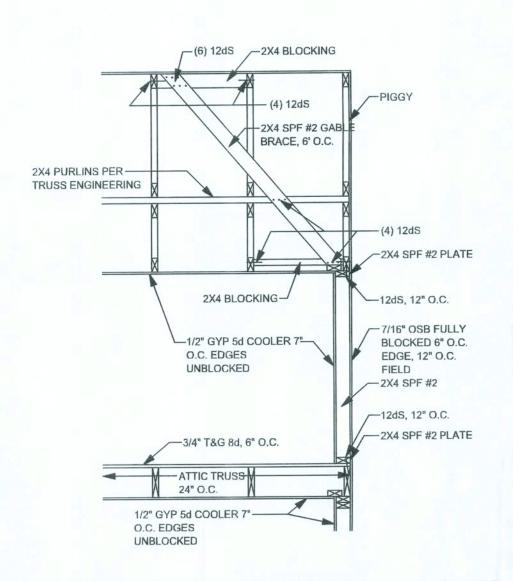

W67 - BONUS ROOM / GABLE END BRACNG
SCALE: 1/2"=1'-0"

