

PRODUCT CODE	R.O. SIZE	COUNT		
INT. DOOR SCHEDULE				
0 DBF	R.O. 62" X 82-1/2"	2		
68 R	R.O. 20" X 82-1/2"	. 1		
668 L	R.O. 20" X 82-1/2"	1		
068 R	R.O. 26" X 82-1/2"	1		
-68 L	R.O. 30" X 82-1/2"	2		
668 L	R.O. 32" X 82-1/2"	2		
668 R	R.O. 32" X 82-1/2"	2		
68L	R.O. 34" X 82-1/2"	1		
68R	R.O. 34" X 82-1/2"			

PRODUCT CODE	R.O. SIZE	COUNT
EXT. DO SMOOTH FIBER	OR SCHEDULI	
L 3-0 6PNL COL IN SWING	R.O. 38" X 82-1/2"	1
R 2-8 9 LITE COL OUT SWING	R.O. 34" X 81-1/2"	1
L 2-8 6PNL COL IN SWING	R.O. 34" X 82-1/2"	1

NOTE:B	UILDER	15	10	CONFI	27	
ROUGH	OPENIN	IGS	B	EFORE	FF/	MING.

		7
PRODUCT CODE	R.O. SIZE	COUNT
	SCHEDULE NE 2900 SERIES	
2830 COL.	R.O. 32-1/2" X 36-1/2"	1
2830 OBS COL	R.O. 32-1/2" X 36-1/2"	1
2830 OBS COL TEMP	R.O. 32-1/2" X 36-1/2"	1
3052 COL	R.O. 36-1/2" X 62-1/2"	3
3052 TWIN COL.	R.O. 72-1/2" X 62-1/2"	1
3052 TWIN COL. TEMP	R.O. 72-1/2" X 62-1/2"	1
6/0 SLIDING GLASS DOOR (R)	R.O. 74-5/8" X 80-9/16"	1
CHECK R/O SIZE ACCORD	ING TO MANUFACTURE S	SPECS

TRUSS DIESIGNER TO ALLOW FOR HYAC CLOSET (SPACE \*SEE FLOOOR PLAN


> NOTE: FLLOORING CHOICES TO BE DETERMINED BY BUYER

REV.# REV. DATE: D:DRAWN BY: DISCRIPTION OF REVISION

NOTE: **ALL INTERIOR DOORS** TO HAVE 82-1/2" R.O. HEIGHT FROM FINISHED

NOTE: ALL WINDOWS TO BE VINY

**ATTENTION FRAMER:** BLOCK FOR FAN IN ALL BEDROOMS

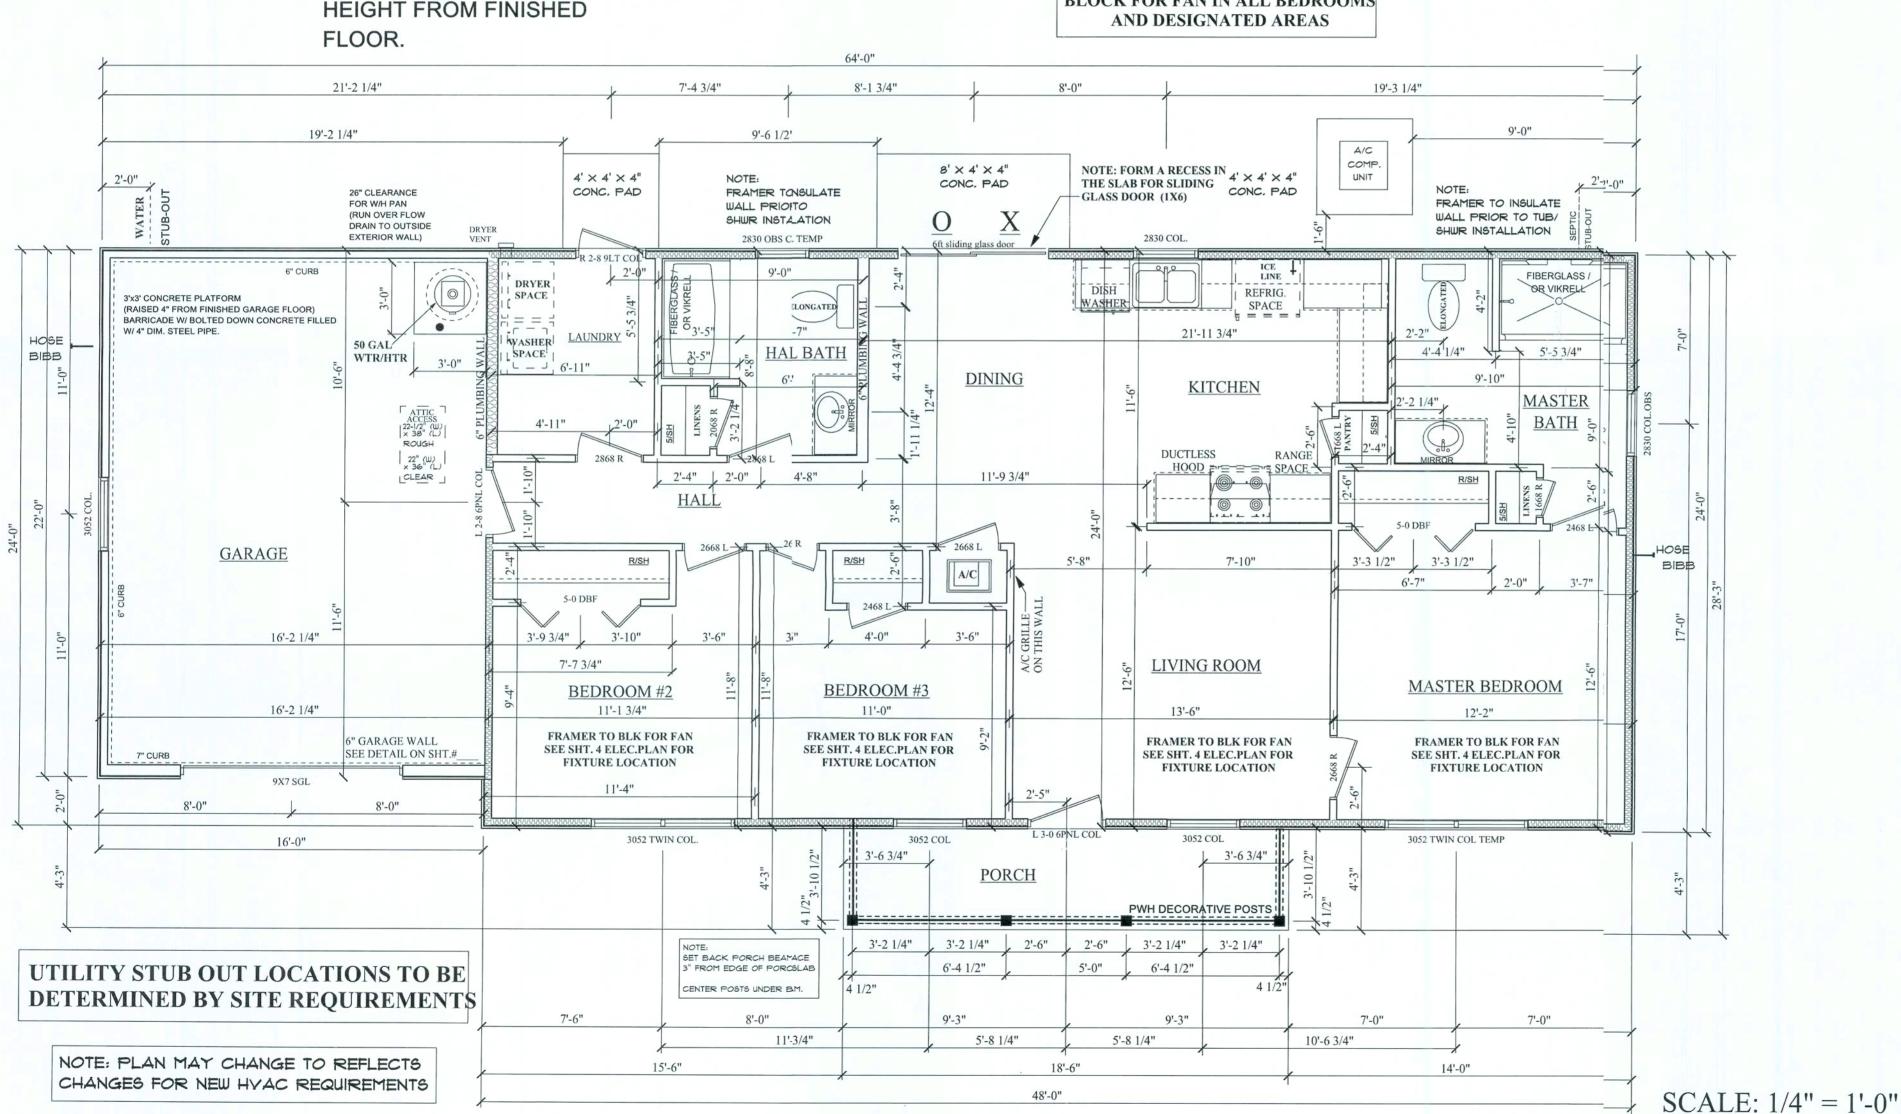

FLOOR PLAN

8' CEILINGS

THROUGHOUT HOUSE

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EXHIBIT "A"

PLAN: SANFORD B

CUSTOMER NAME:

A. HORMAZA & S. ABDULAAL HEATED LIVING AREA

GROUND FLOOR: 1152 SECOND FLOOR: N/A N/A

OTHER: TOTAL HEATED: 1152

> **NON-HEATED** LIVING AREA


PORCH: 72 352 GARAGE: OTHER: N/A TOTAL U/R 1576

IMPORTANT-PLEASE READ

**BELOW CAREFULLY** 

OUR SALES BROCHURES AND OTHER ADVERTISING LIT-ERATURE ARE INTENDED TO GENERALLY REFLECT AND DEPICT THE STYLES AND QUALITY OF HOMES WE BUILD THROUGHOUT A PORTION OF THE UNITED STATES. OUR SALES MODELS ARE DESIGNED AND BUILT TO GENERALLY CONFORM WITH A VARIETY OF LOCAL CUSTOMS, PRAC-TICES, AND BUILDING CODES PREVALENT OR IN EFFECT IN THE IMMEDIATE AREA SURROUNDING THE LOCATION OF THOSE MODELS. THIS SET OF PLANS IS AN ACTUAL PART OF OUR CONTRACT WITH YOU AND, AS SUCH, IS IN-TENDED TO TAKE PRIORITY OVER ANYTHING IN CONFLICT WITH IT CONTAINED IN OUR ADVERTISING LITERATURE, OUR SALES MODELS AND EVEN OUR ORAL SALES PRESEN TATION. NO CHANGE, MODIFICATION, OR REVISION OF THESE PRINTED PLANS SHALL BE BINDING ON THE PARTIES UNLESS SET FORTH ON THESE PLANS OR OTHER WISE REDUCED TO WRITING AND EXECUTED BY SAID PARTIES, PLEASE REVIEW THESE PLANS ALONG WITH "EXHIBIT B" OF YOUR CONTRACT CAREFULLY AND MAKE CERTAIN BEFORE YOU SIGN THEM THAT THEY ACCU-RATELY REPRESENT THE HOME YOU ARE PURCHASING ADDITIONALLY, P.W.H. HOMES INC. HEREBY RESERVES THE RIGHT TO SUBSTITUTE MATERIALS OF FOUIVALENT QUALITY AND/OR TECHNIQUES OF ASSEMBLY AND/OR CONSTRUCTION METHODS FROM THAT CONTAINED IN THESE PLANS OR SPECIFIED IN EXHIBIT "B" WHERE NEC-ESSARY TO ACCOMODATE DIFFERENCES IN LOCAL CODES GEOGRAPHIC CUSTOMS, OPTION SELECTION AND AVAIL-ABILITY OF MATERIALS. ALL MATERIALS (LUMBER, OR OTHER BUILDING SUPPLIES) DELIVERED TO JOBSITE WHICH ARE IN EXCESS OF THOSE REQUIRED TO CON-STRUCT THE HOUSE AS AGREED REMAIN THE PROPERTY OF P.W.H. HOMES INC

PENNYWORTH HOMES INC. RESERVES THE RIGHT TO ONLY MAKE CHANGES TO PLANS, REQUESTED BY BUYERS, THAT PENNYWORTH HOMES INC. DEEMS TO BE AESTHETICALLY, ARCHITECTURALLY, AND STRUCTURALLY SOUND.

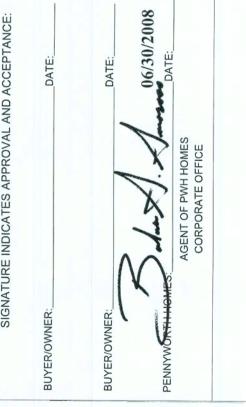


PENNYWORTH HOMES INC. RESERVES THE RIGHT TO MAKE MODIFICATIONS TO THIS PLAN AFTER THE BUYERS APPROVAL / SIGNATURE, DUE TO THE ENGINEER'S AND BUILDING DEPT. REVIEW. THE BUYER SHALL BE NOTIFIED OF THESE MODIFICATIONS TO THE PLAN VIA CHANGE ORDER.


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of 8






# KITCHEN CABINET ELEVATIONS

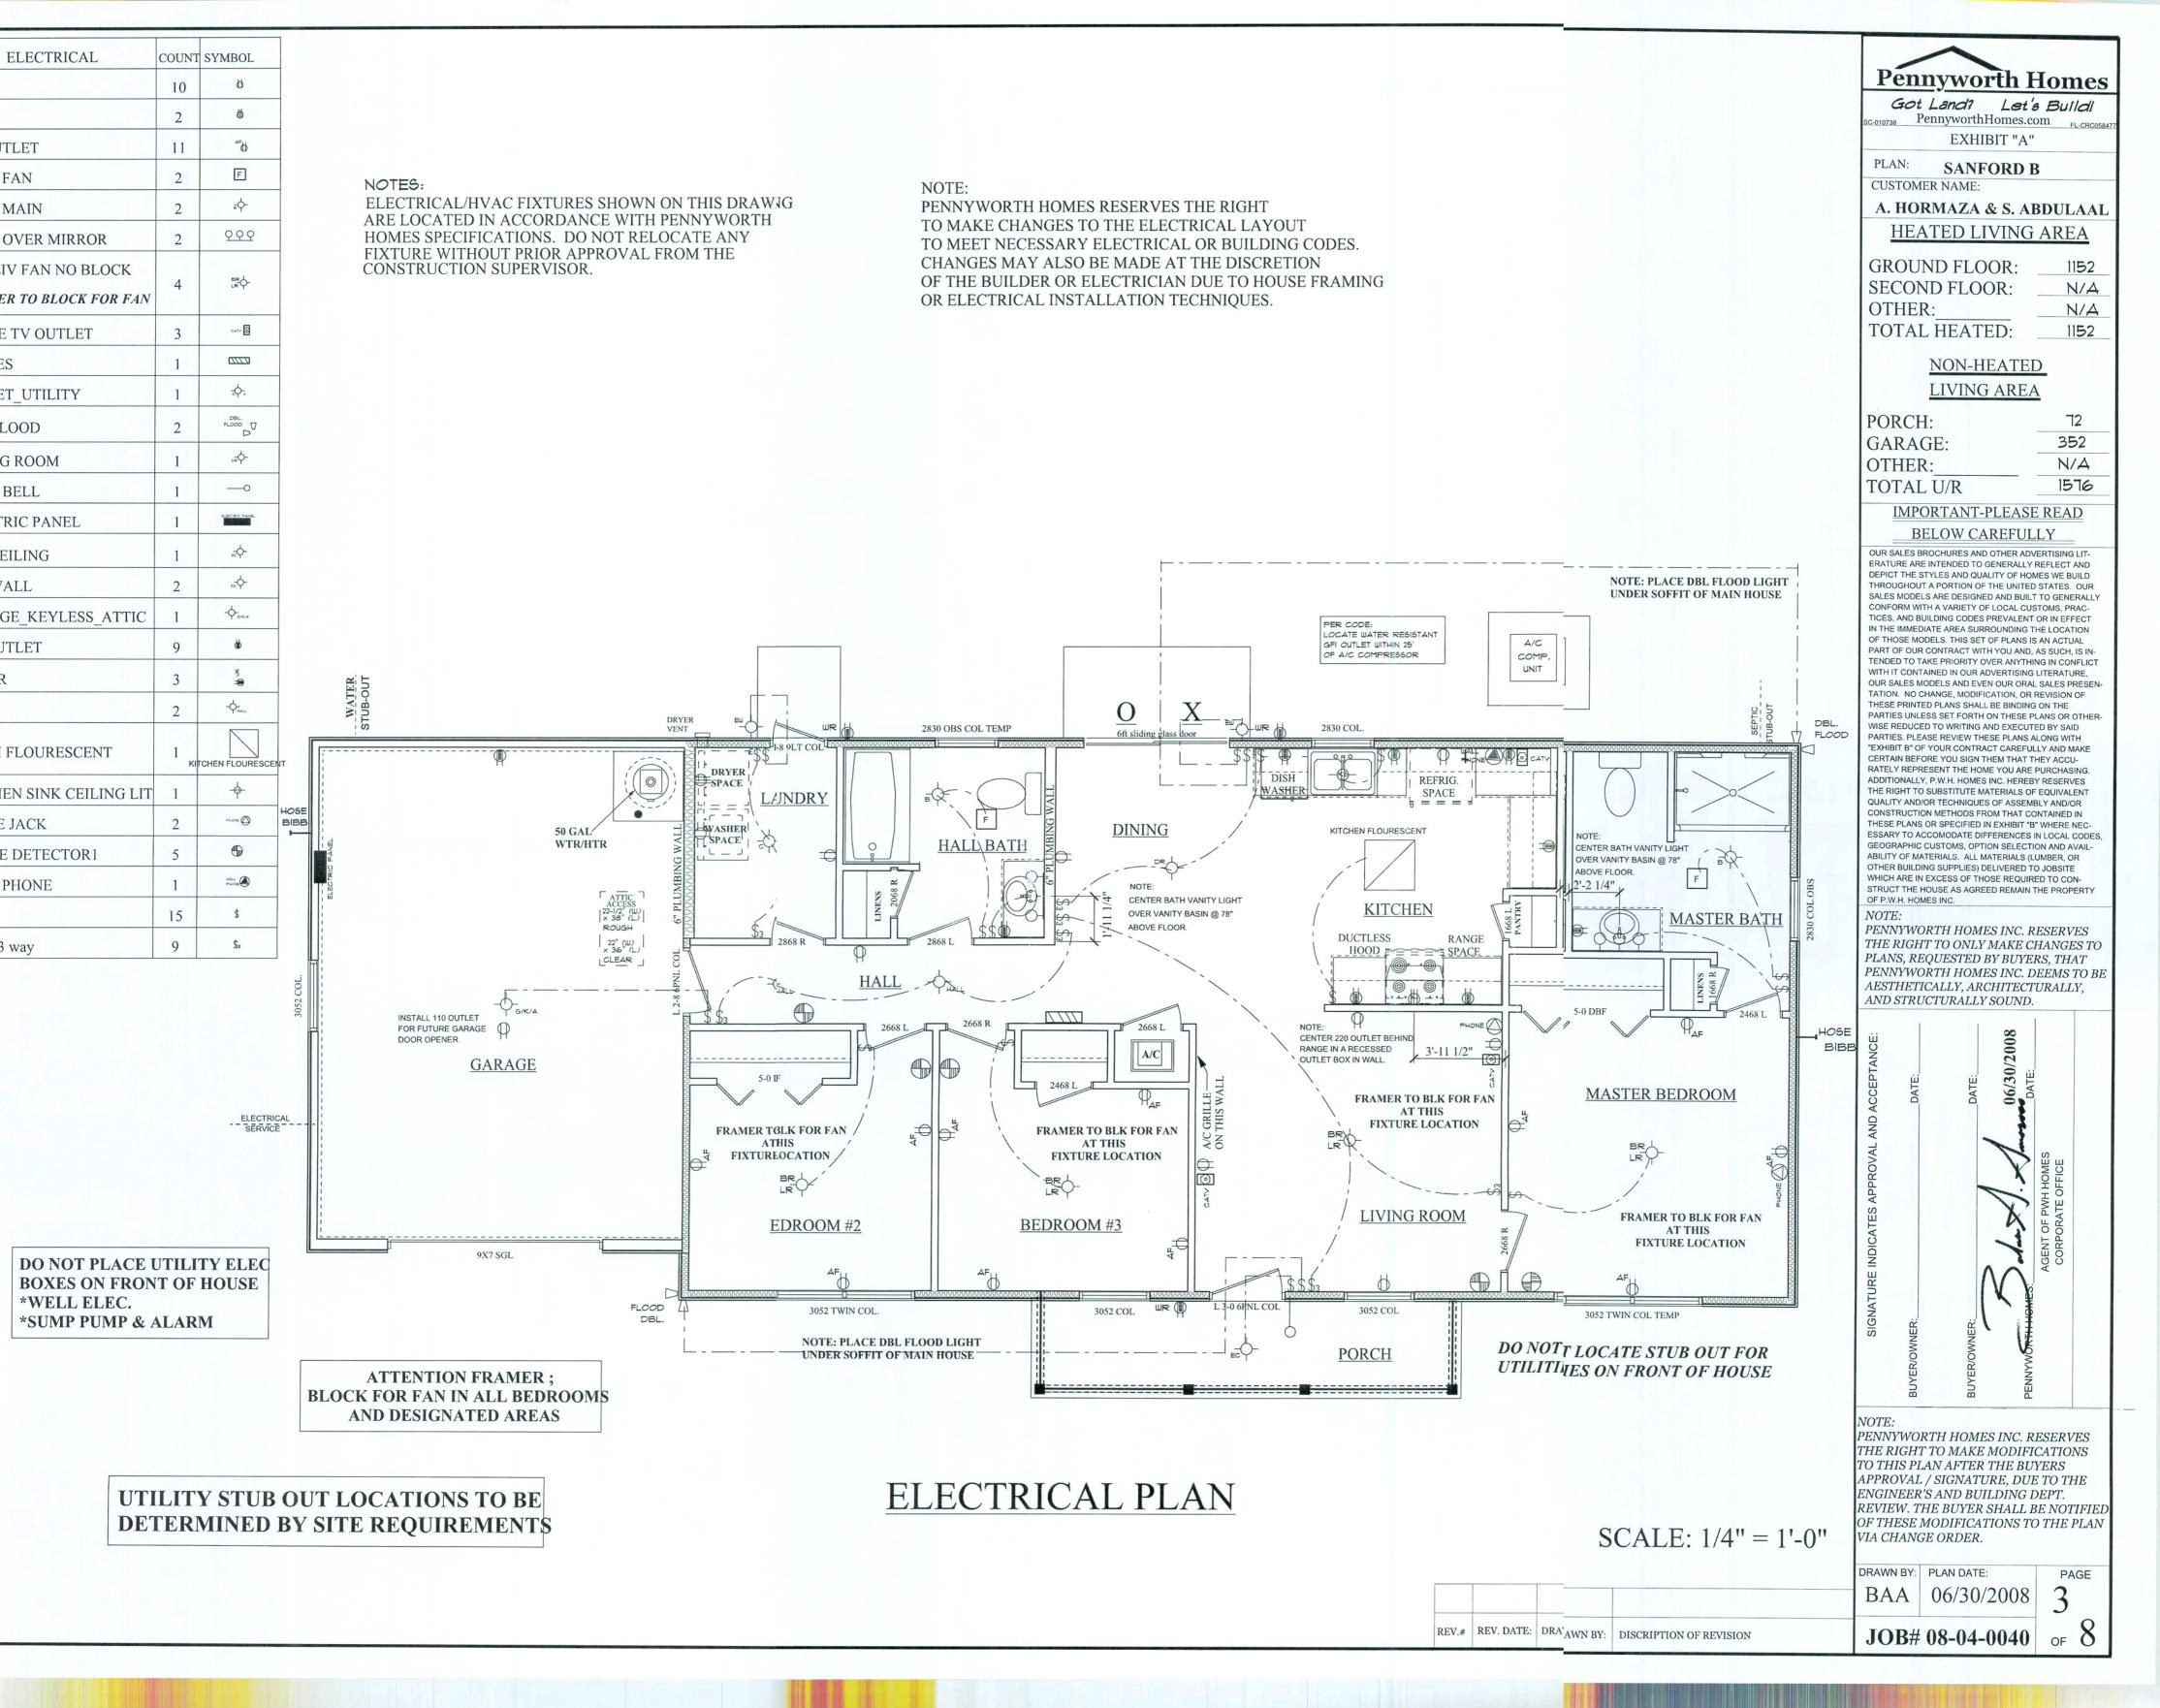CABINETS ARE SYMBOLIC, ACTUAL UNITS MAY YER! IN STYLE \*TO BE DETERMINED BY BUYER.

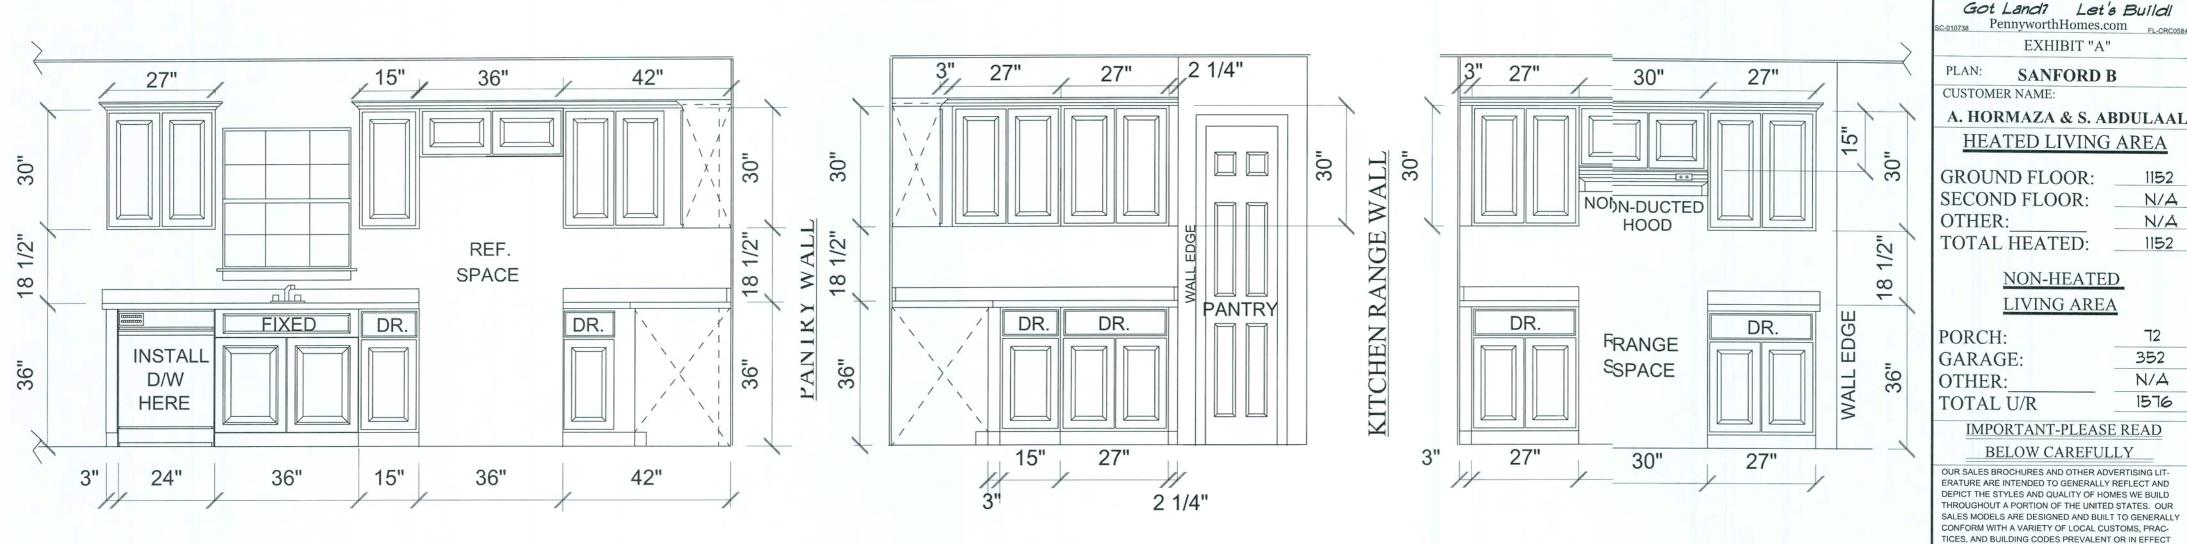INSTALL QUARTER ROUND MOLDING AROUND BOTTOM OF ALL BASE CABINETS & VANITIES.

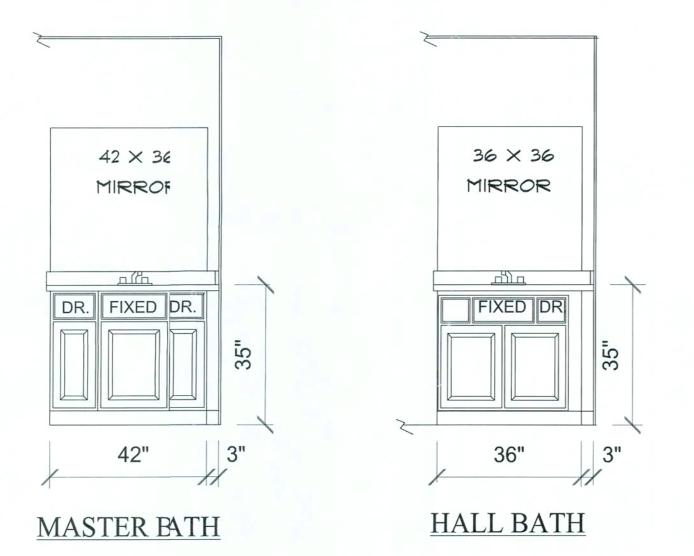

VANITY CABINET ELEVATIONS

INSTALL CROWN MOOLDING AROUND

TOP OF KITCHEN WIALL CABINETS.

**Pennyworth Homes** 

EXHIBIT "A"

SANFORD B

IN THE IMMEDIATE AREA SURROUNDING THE LOCATION OF THOSE MODELS. THIS SET OF PLANS IS AN ACTUAL PART OF OUR CONTRACT WITH YOU AND, AS SUCH, IS IN TENDED TO TAKE PRIORITY OVER ANYTHING IN CONFLICT

WITH IT CONTAINED IN OUR ADVERTISING LITERATURE, OUR SALES MODELS AND EVEN OUR ORAL SALES PRESEN TATION. NO CHANGE, MODIFICATION, OR REVISION OF

THESE PRINTED PLANS SHALL BE BINDING ON THE PARTIES UNLESS SET FORTH ON THESE PLANS OR OTHER-

WISE REDUCED TO WRITING AND EXECUTED BY SAID PARTIES. PLEASE REVIEW THESE PLANS ALONG WITH "EXHIBIT B" OF YOUR CONTRACT CAREFULLY AND MAKE

CERTAIN BEFORE YOU SIGN THEM THAT THEY ACCU-RATELY REPRESENT THE HOME YOU ARE PURCHASING.

ADDITIONALLY, P.W.H. HOMES INC. HEREBY RESERVES

THE RIGHT TO SUBSTITUTE MATERIALS OF EQUIVALENT QUALITY AND/OR TECHNIQUES OF ASSEMBLY AND/OR

CONSTRUCTION METHODS FROM THAT CONTAINED IN THESE PLANS OR SPECIFIED IN EXHIBIT "B" WHERE NEC-ESSARY TO ACCOMODATE DIFFERENCES IN LOCAL CODES GEOGRAPHIC CUSTOMS, OPTION SELECTION AND AVAIL-ABILITY OF MATERIALS. ALL MATERIALS (LUMBER, OR OTHER BUILDING SUPPLIES) DELIVERED TO JOBSITE WHICH ARE IN EXCESS OF THOSE REQUIRED TO CON-STRUCT THE HOUSE AS AGREED REMAIN THE PROPERTY

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AND STRUCTURALLY SOUND.

OF P.W.H. HOMES INC.

NOTE:

1152

N/A

N/A

1152

72

352

N/A 1576


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DRAWN BY: PLAN DATE: BAA | 06/30/2008


JOB# 08-04-0040

SCALE: 1/2" = 1'-0"

REV.# REV. DATE: DRAWN BY: DISCRIPTION OF REVISION

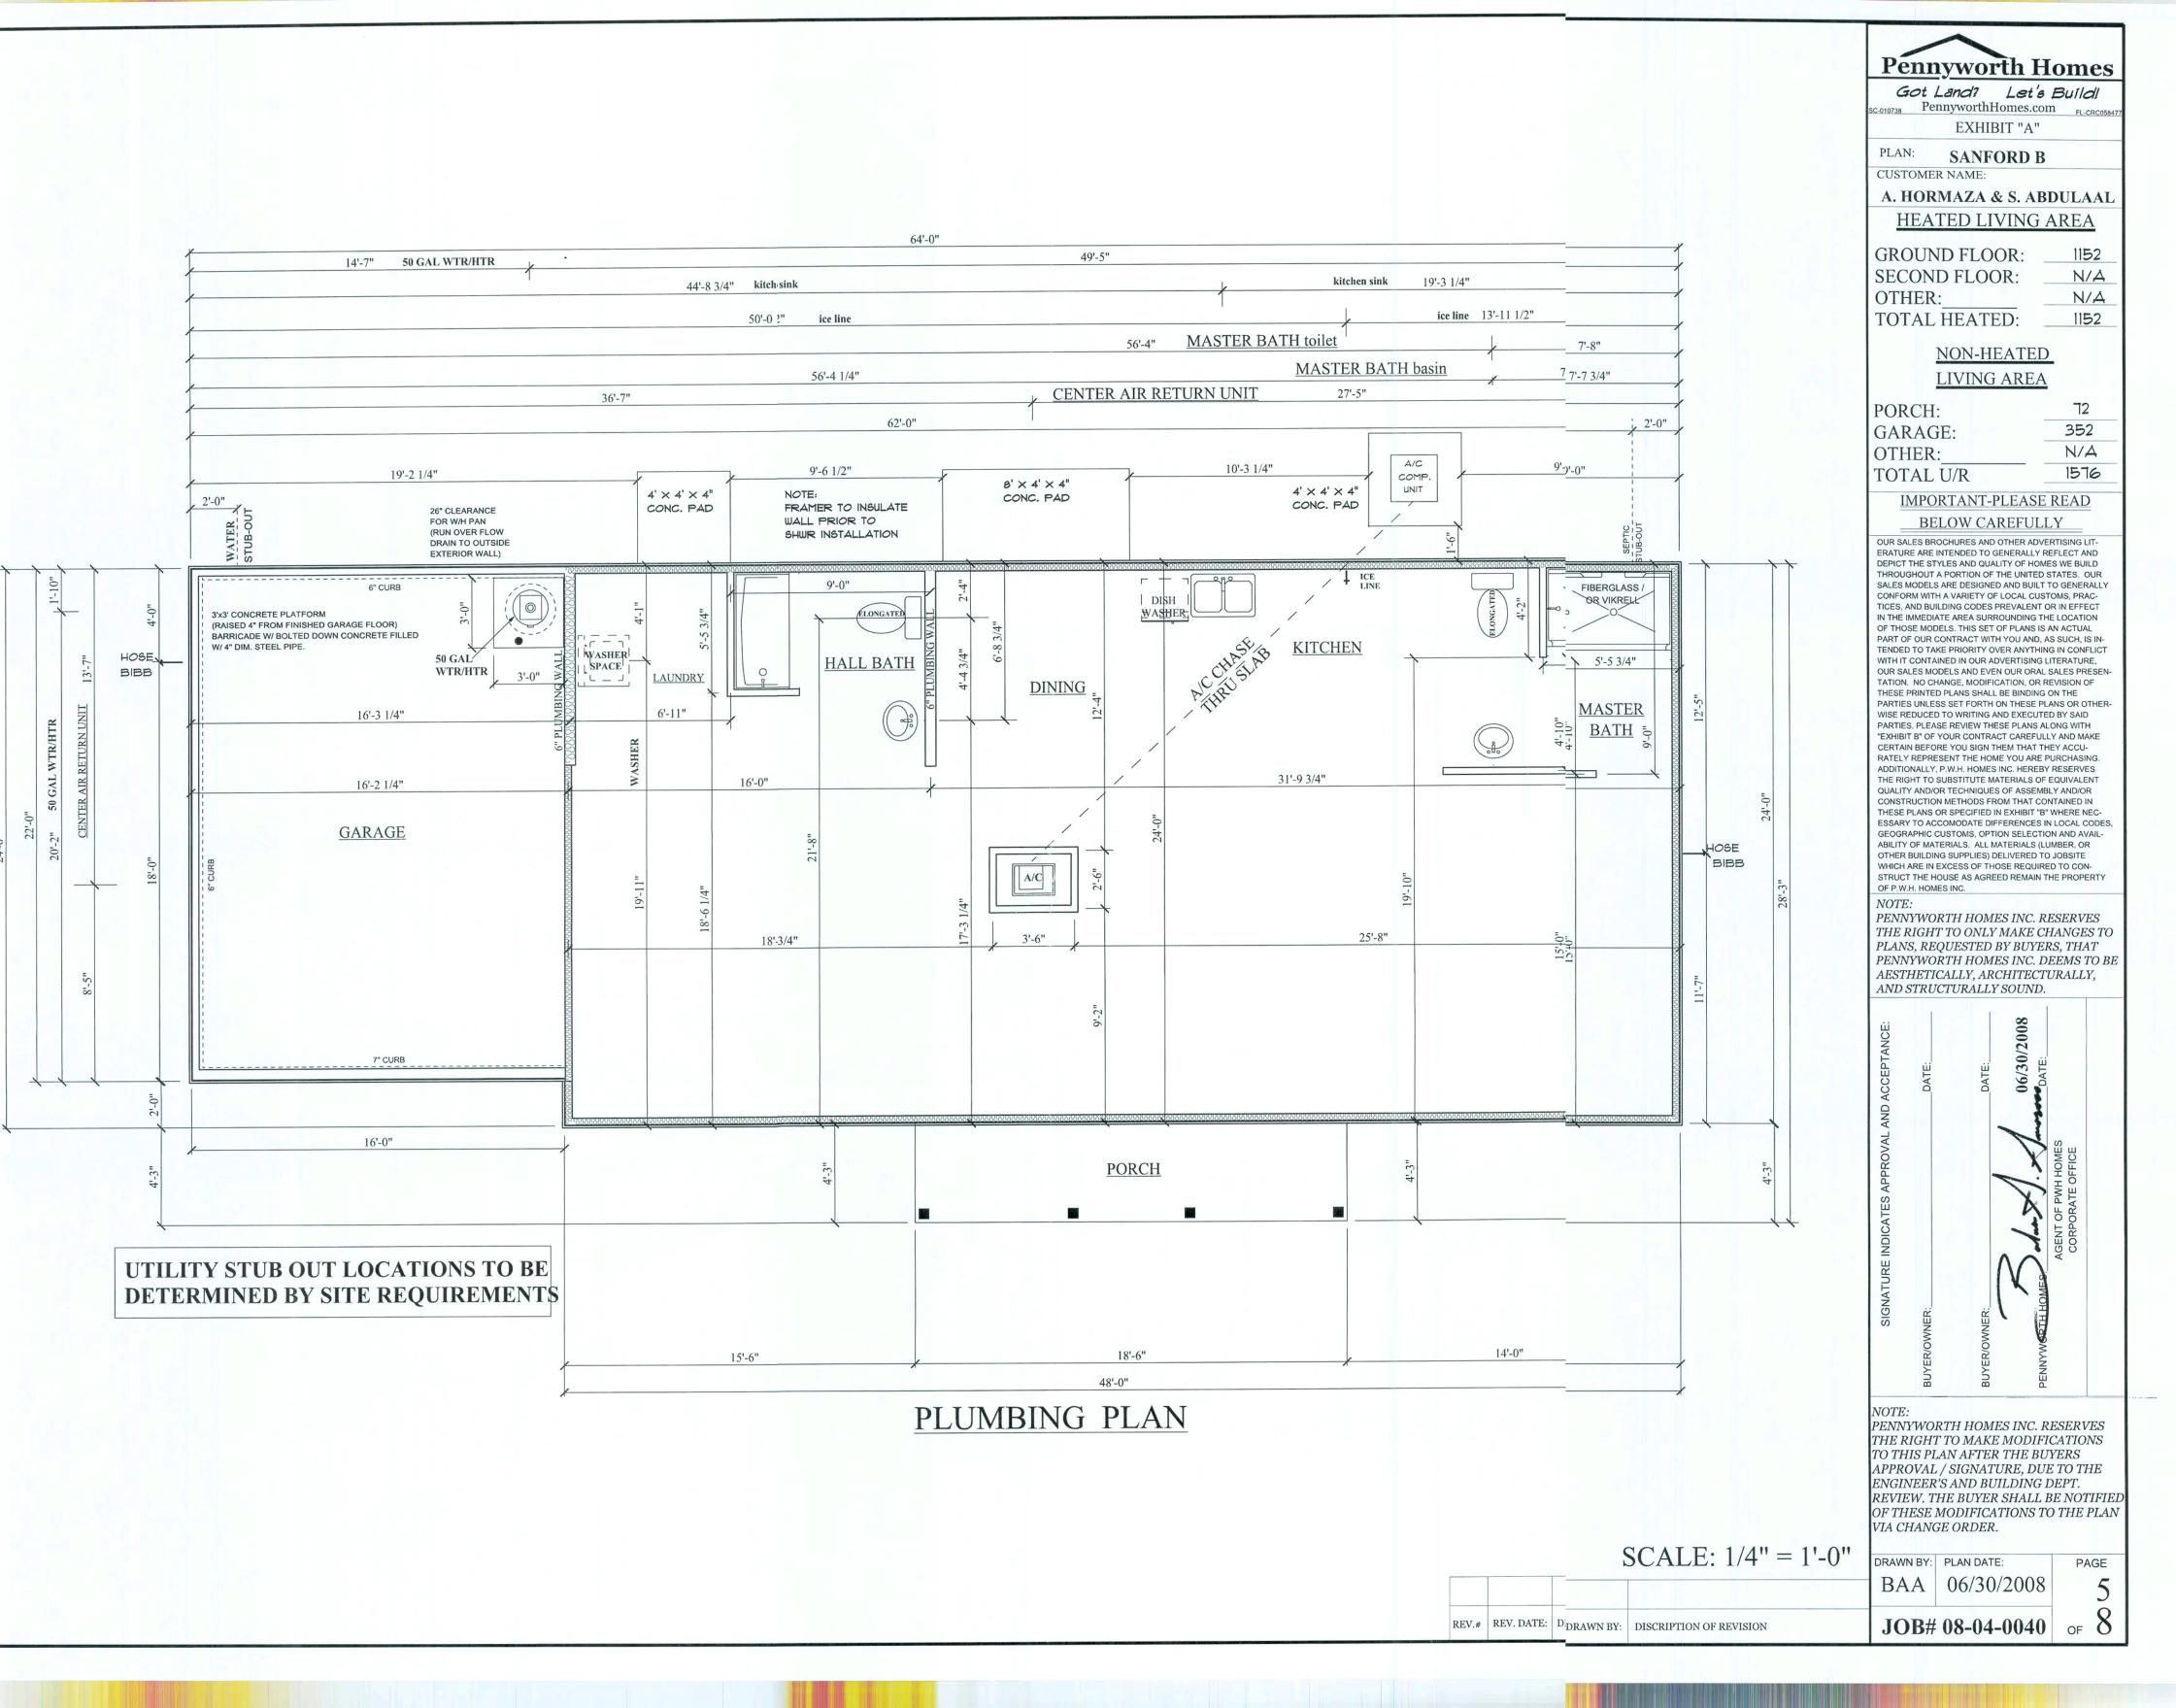

**ROOF PITCHES ABOVE 4/12 ARE REQUIRED** TO HAVE A MIN. OF (1) LAYER OF FELT PAPER PER FLORIDA BUILDING CODE **SECTION 1507.3.8.2** 

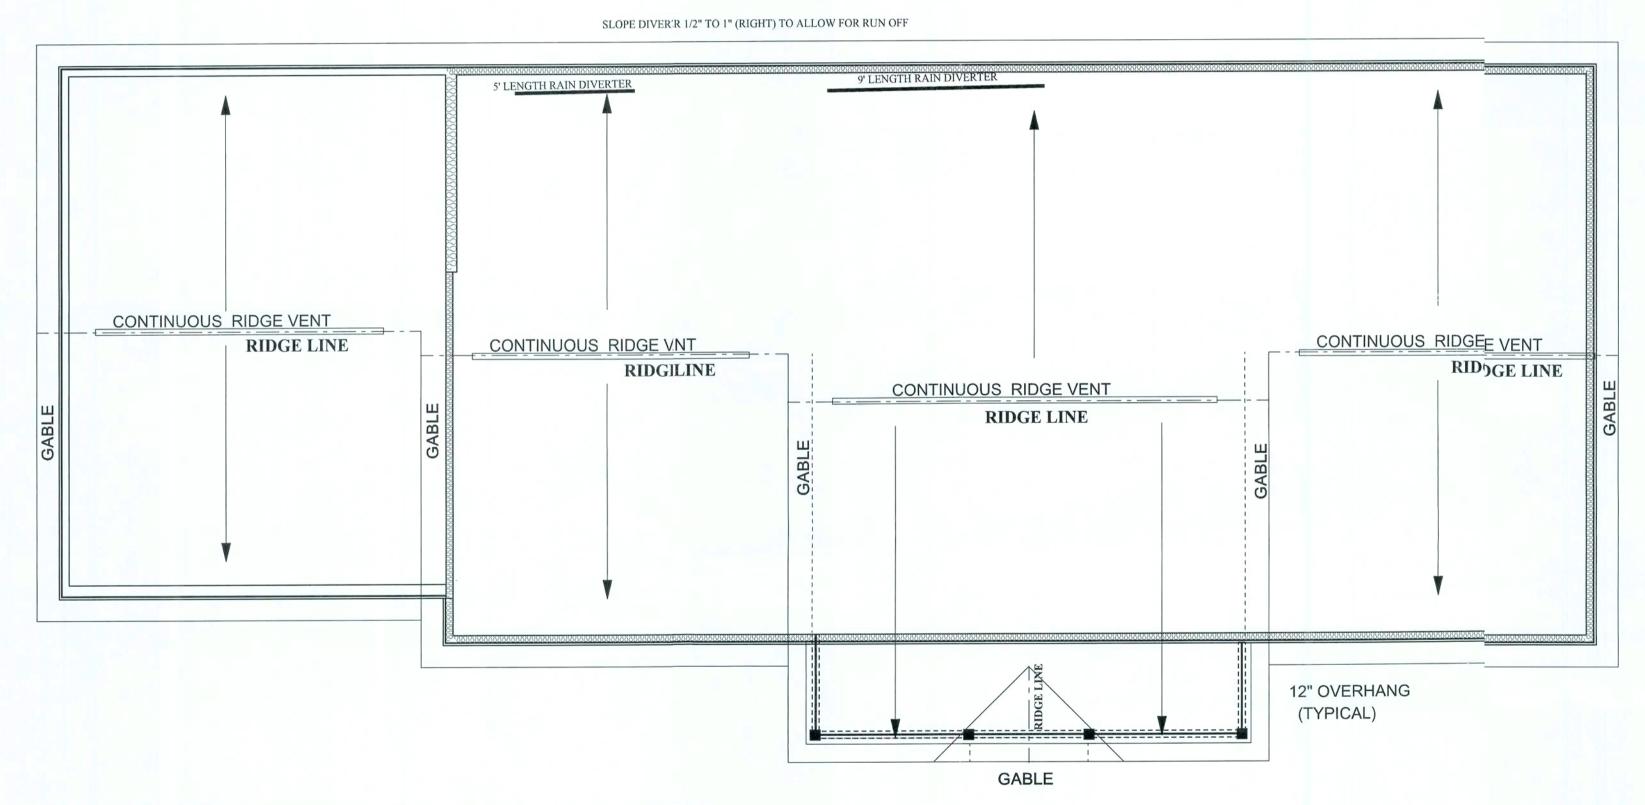

ALL ROOF PLANES SHOWN ARE @ 6 - 12 PITCH

# ROOF LAYOUT PLAN

BAA October 23, 2008 JOB# 08-04-0040 REV.# REV. DATE: . DRAWN BY: DISCRIPTION OF REVISION

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EXHIBIT "A"

PLAN: SANFORD B

CUSTOMER NAME: A. HORMAZA & S. ABDULAAL

**HEATED LIVING AREA** 

GROUND FLOOR: 1152 SECOND FLOOR: N/A OTHER: N/A

TOTAL HEATED: 1152

NON-HEATED

LIVING AREA

PORCH: 72 352 GARAGE: OTHER: N/A 1576 TOTAL U/R

**IMPORTANT-PLEASE READ** BELOW CAREFULLY

OUR SALES BROCHURES AND OTHER ADVERTISING LIT-ERATURE ARE INTENDED TO GENERALLY REFLECT AND DEPICT THE STYLES AND QUALITY OF HOMES WE BUILD THROUGHOUT A PORTION OF THE UNITED STATES. OUR SALES MODELS ARE DESIGNED AND BUILT TO GENERALLY CONFORM WITH A VARIETY OF LOCAL CUSTOMS, PRAC-TICES, AND BUILDING CODES PREVALENT OR IN EFFECT IN THE IMMEDIATE AREA SURROUNDING THE LOCATION OF THOSE MODELS. THIS SET OF PLANS IS AN ACTUAL PART OF OUR CONTRACT WITH YOU AND AS SUCH IS IN-TENDED TO TAKE PRIORITY OVER ANYTHING IN CONFLICT WITH IT CONTAINED IN OUR ADVERTISING LITERATURE, OUR SALES MODELS AND EVEN OUR ORAL SALES PRESEN-TATION. NO CHANGE, MODIFICATION, OR REVISION OF THESE PRINTED PLANS SHALL BE BINDING ON THE PARTIES UNLESS SET FORTH ON THESE PLANS OR OTHER-WISE REDUCED TO WRITING AND EXECUTED BY SAID PARTIES. PLEASE REVIEW THESE PLANS ALONG WITH "EXHIBIT B" OF YOUR CONTRACT CAREFULLY AND MAKE CERTAIN BEFORE YOU SIGN THEM THAT THEY ACCU-RATELY REPRESENT THE HOME YOU ARE PURCHASING. ADDITIONALLY, PENNYWORTH HOMES INC. HEREBY RESERVE THE RIGHT TO SUBSTITUTE MATERIALS OF EQUIVALENT QUALITY AND/OR TECHNIQUES OF ASSEMBLY AND/OR CONSTRUCTION METHODS FROM THAT CONTAINED IN HESE PLANS OR SPECIFIED IN EXHIBIT "B" WHERE NEC-ESSARY TO ACCOMODATE DIFFERENCES IN LOCAL CODES, GEOGRAPHIC CUSTOMS, OPTION SELECTION AND AVAIL-ABILITY OF MATERIALS. ALL MATERIALS (LUMBER, OR OTHER BUILDING SUPPLIES) DELIVERED TO JOBSITE WHICH ARE IN EXCESS OF THOSE REQUIRED TO CON-STRUCT THE HOUSE AS AGREED REMAIN THE PROPERTY OF PENNYWORTH HOMES INC.


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SCALE: 1/4" = 1'-0"

### GARAGE DOOR WALL OPENING DETAIL **OUTSIDE** S.Y.P. 2X4 GARAGE DOOR **OPENING** 2X6 WALL / S.Y.P. 2X8 S.Y.P. 2X6 INSIDE P.T. (BORATE TREATED ) 2X4 BOTTOM 12" TO BE P.T. BORATE TREATED (2) 2X4 S.Y.P. 2X6 SITS APROX /4" FROM GROUND (2)P.T. (BORATE TREATED ) 2X4

# BEAM SUBJECT TO CHANGE ACCORDING TO REQUIRED ENGINEERING SP'ECIFICATIONS




### NOTE:

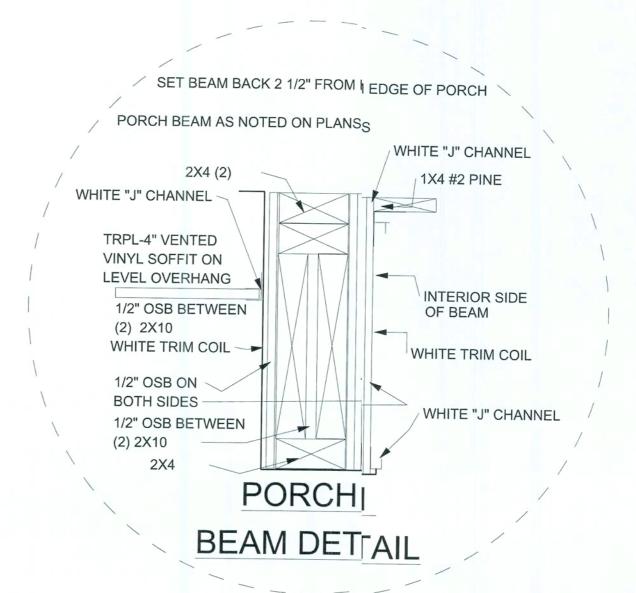
ALL METAL PRODUCTS USED ON PRESSURE TREATED LUMBER MUST BE HOT DIPPED GALVANIZED TO PREVENT DETERIORATION.

# PENNYWORTH HOMES TYPICAL WALL SECTION FOR MONOLITHIC SLAB

NOTE: SEE ENGINEERED FOUNDATION PLAN FCR FOUNDATION SPECIFICATIONS.

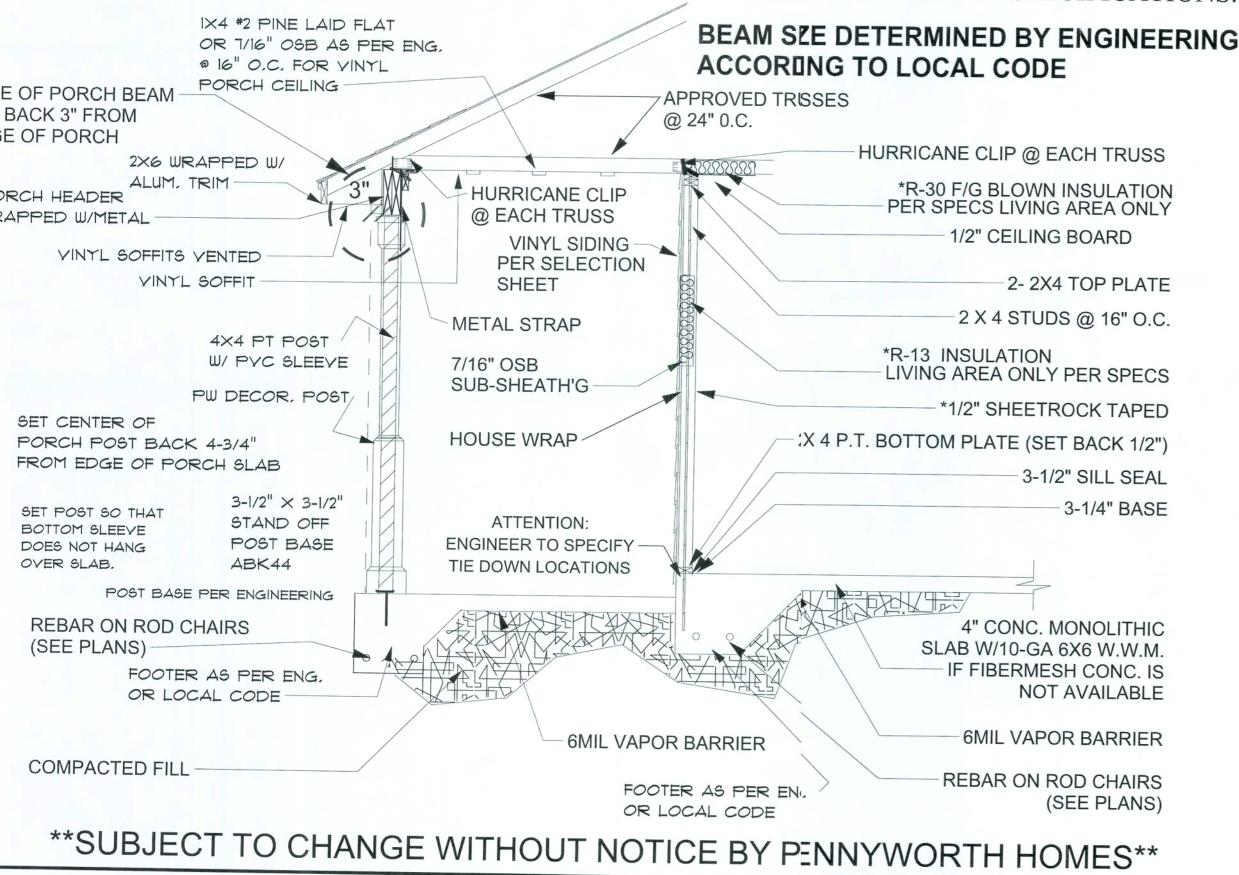

## GARAGE DOOR STRAPPING & FOUNDATION SECTION

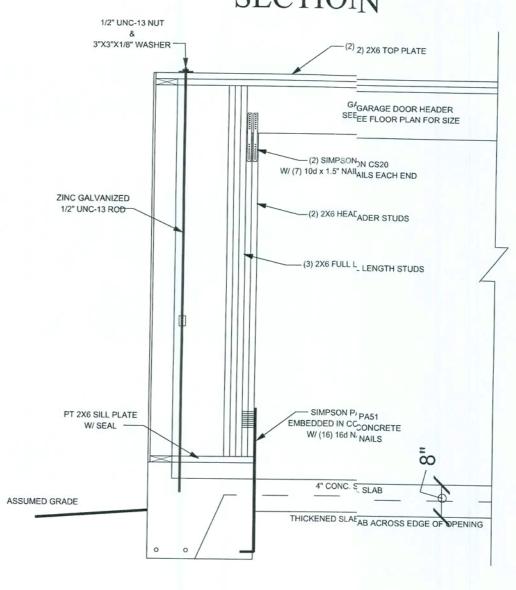

REV.# REV. DATE: DRAVAWN BY: DISCRIPTION OF REVISION

8

DRAWN BY: PLAN DATE: PAGE BAA | October 23, 2008 of 8

NOT TO SCALE

JOB# 08-04-0040

CUSTOMER NAME: A. HORMAZA & S. ABDULAAL HEATED LIVING AREA GROUND FLOOR:

N/A

OTHER: N/A TOTAL HEATED: 1152

SECOND FLOOR:

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o10738 PennyworthHomes.com

EXHIBIT "A"

SANFORD B

PLAN:

### NON-HEATED LIVING AREA


PORCH: 72 GARAGE: 352 OTHER: N/A TOTAL U/R 1576

### **IMPORTANT-PLEASE READ** BELOW CAREFULLY

PEPICT THE STYLES AND QUALITY OF HOMES WE BUILD ROUGHOUT A PORTION OF THE UNITED STATES. OUR TICES, AND BUILDING CODES PREVALENT OR IN EFFECT IN THE IMMEDIATE AREA SURROUNDING THE LOCATION F THOSE MODELS. THIS SET OF PLANS IS AN ACTUAL /ITH IT CONTAINED IN OUR ADVERTISING LITERATURE, OUR SALES MODELS AND EVEN OUR ORAL SALES PRESEN ATION. NO CHANGE, MODIFICATION, OR REVISION OF GEOGRAPHIC CUSTOMS, OPTION SELECTION AND AVAIL-WHICH ARE IN EXCESS OF THOSE REQUIRED TO CON-STRUCT THE HOUSE AS AGREED REMAIN THE PROPERTY OF PENNYWORTH HOMES INC.


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# H S

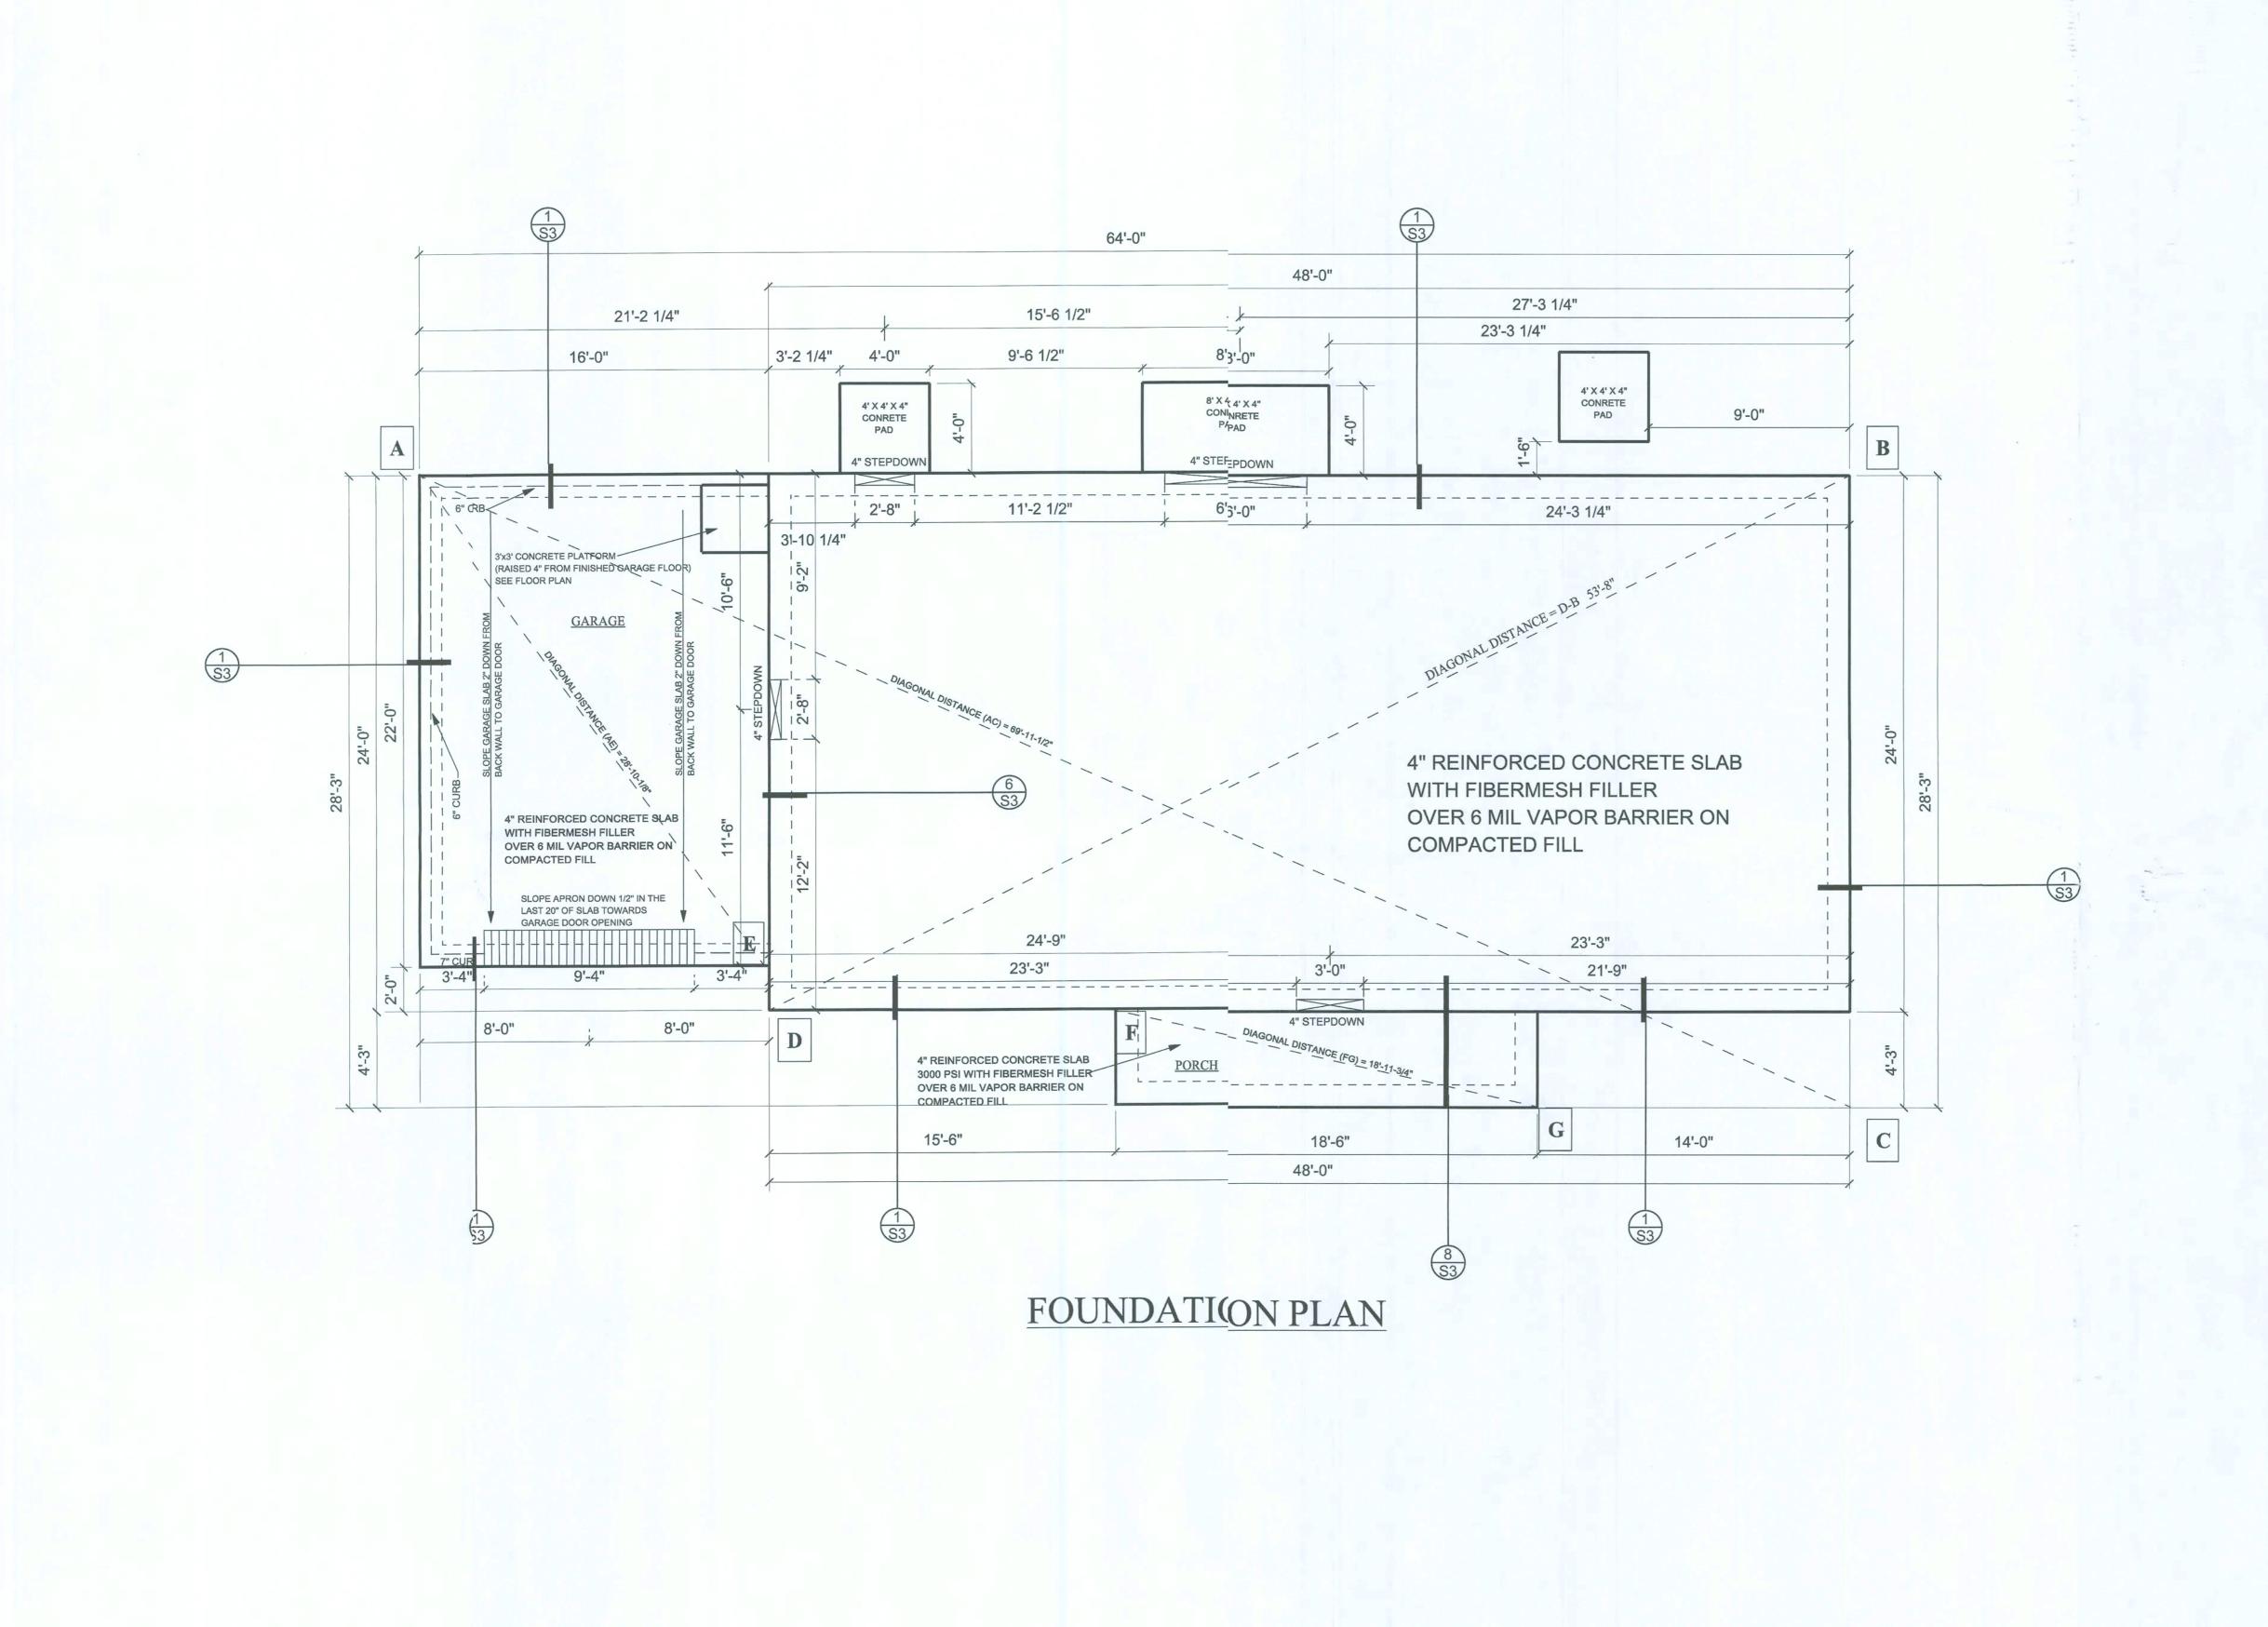

Engineering, ructural Engineering
William E. Douglas P.E., President

STRUCTURAL ONLY THOMAS E. BEITELMAN LICENSE #51870 Sheet S1 of 4 No. 08S-068

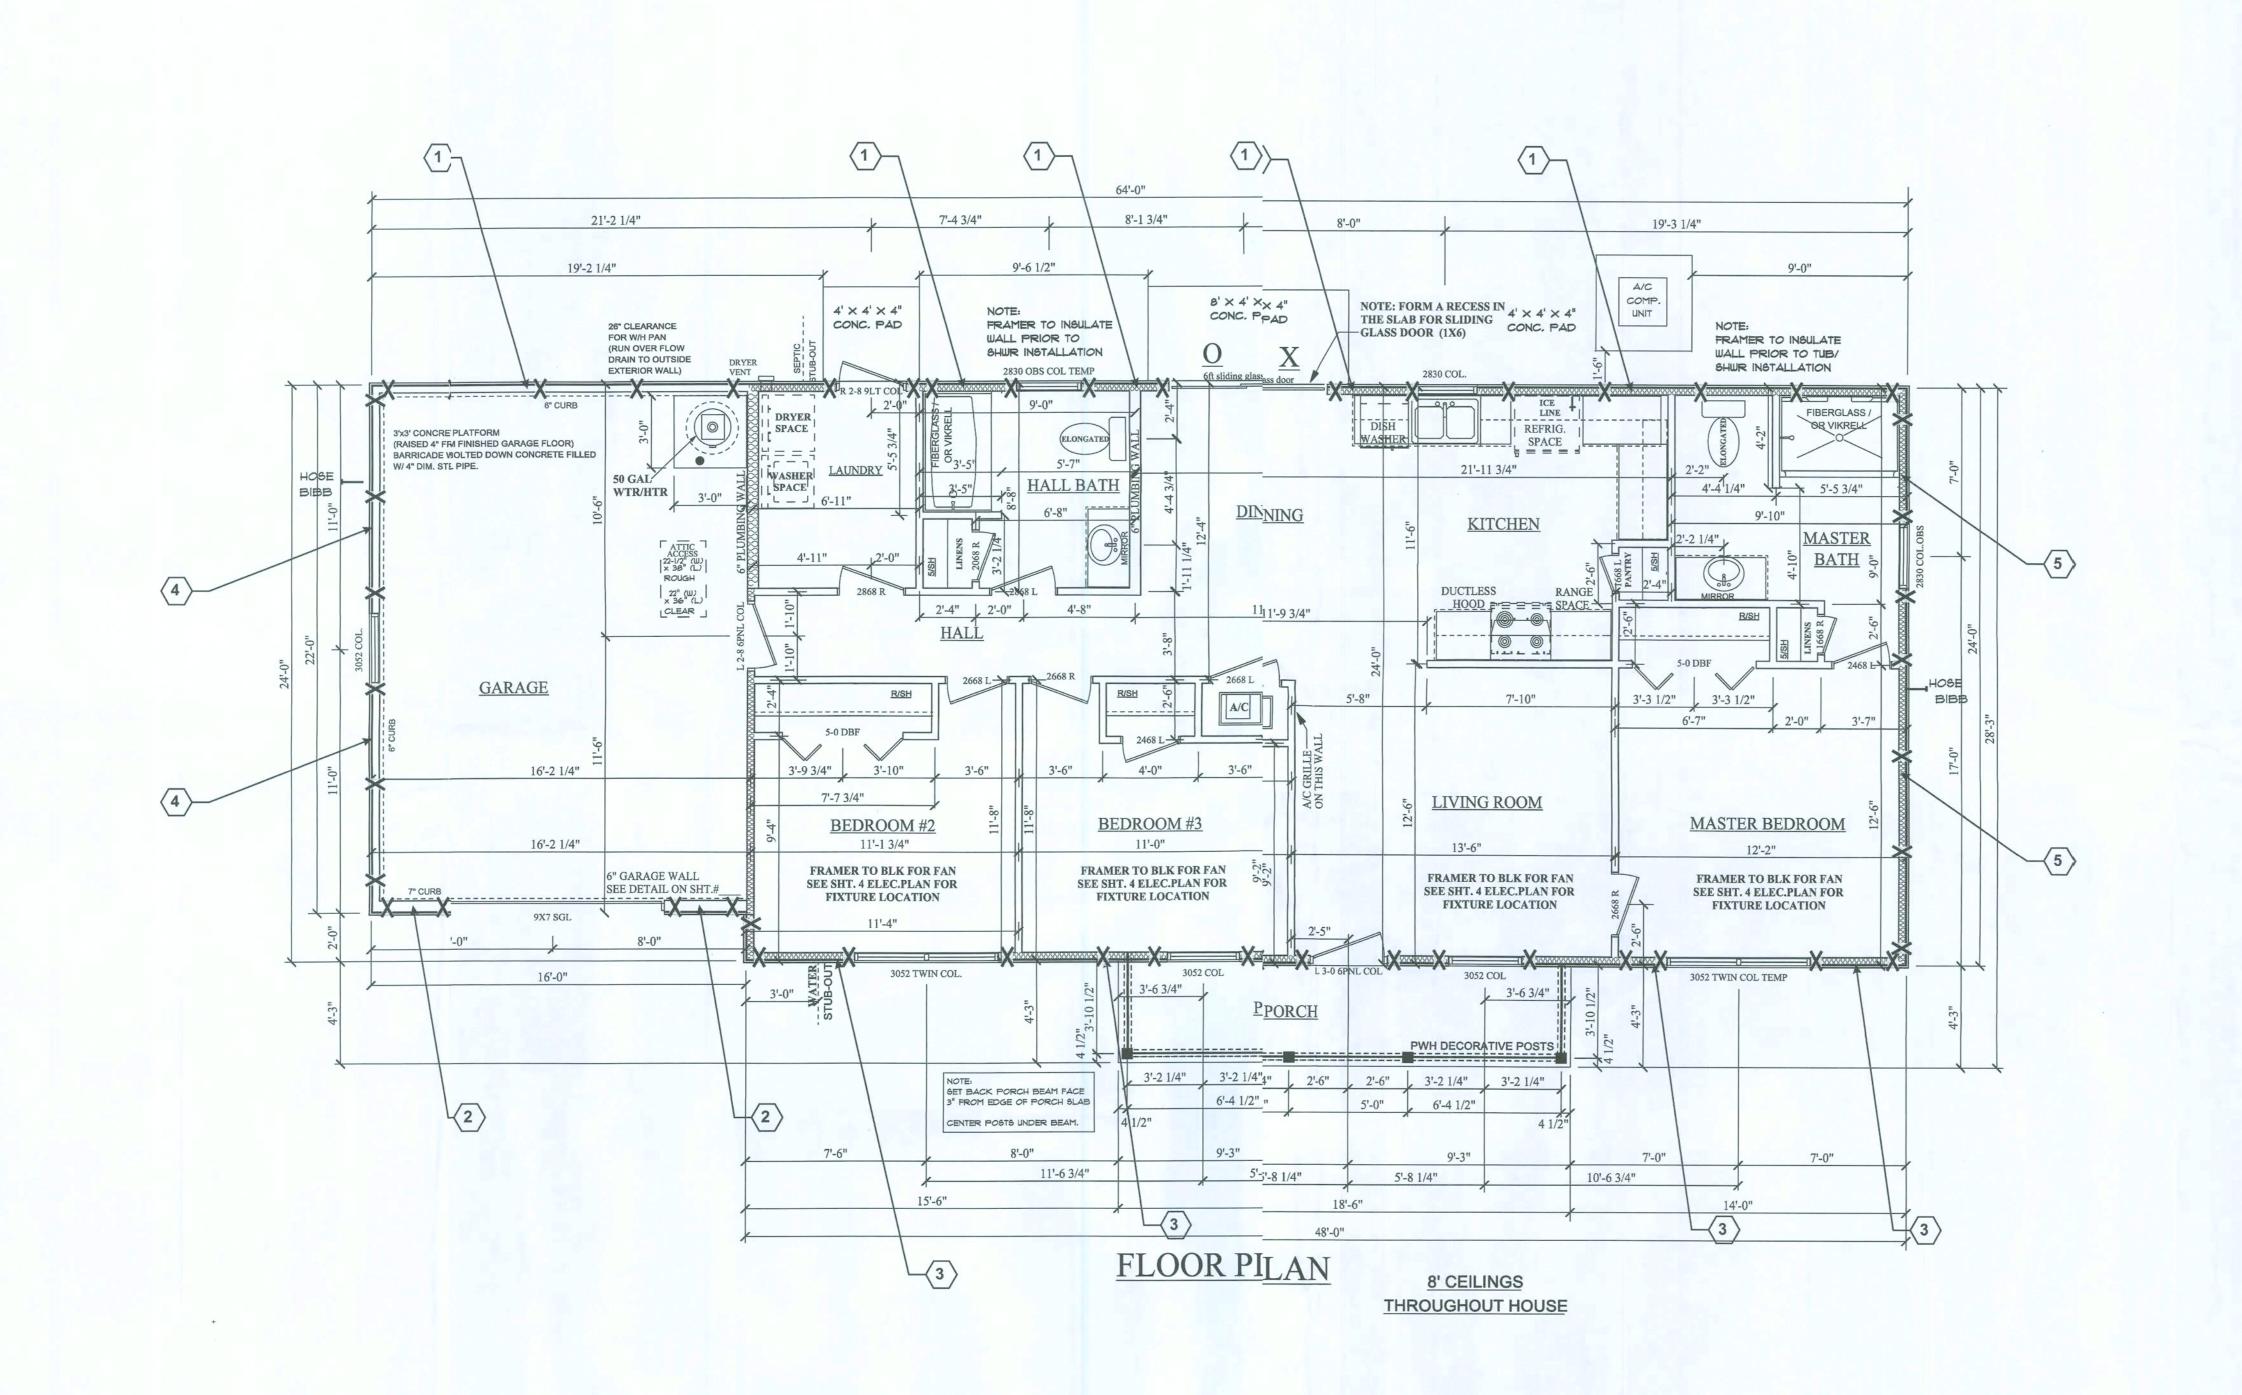


tructures Engineering,
Structural Engineering
William E. Douglas P.E., President no S

STRUCTURAL ONLY THOMAS E. BEITELMAN LICENSE #51870

Shear-Wall Identification Number See Sheet S4 for specifications


X — Approximate location of ½" dia. tie-rods

Sheet S2 of 4 No. 08S-068

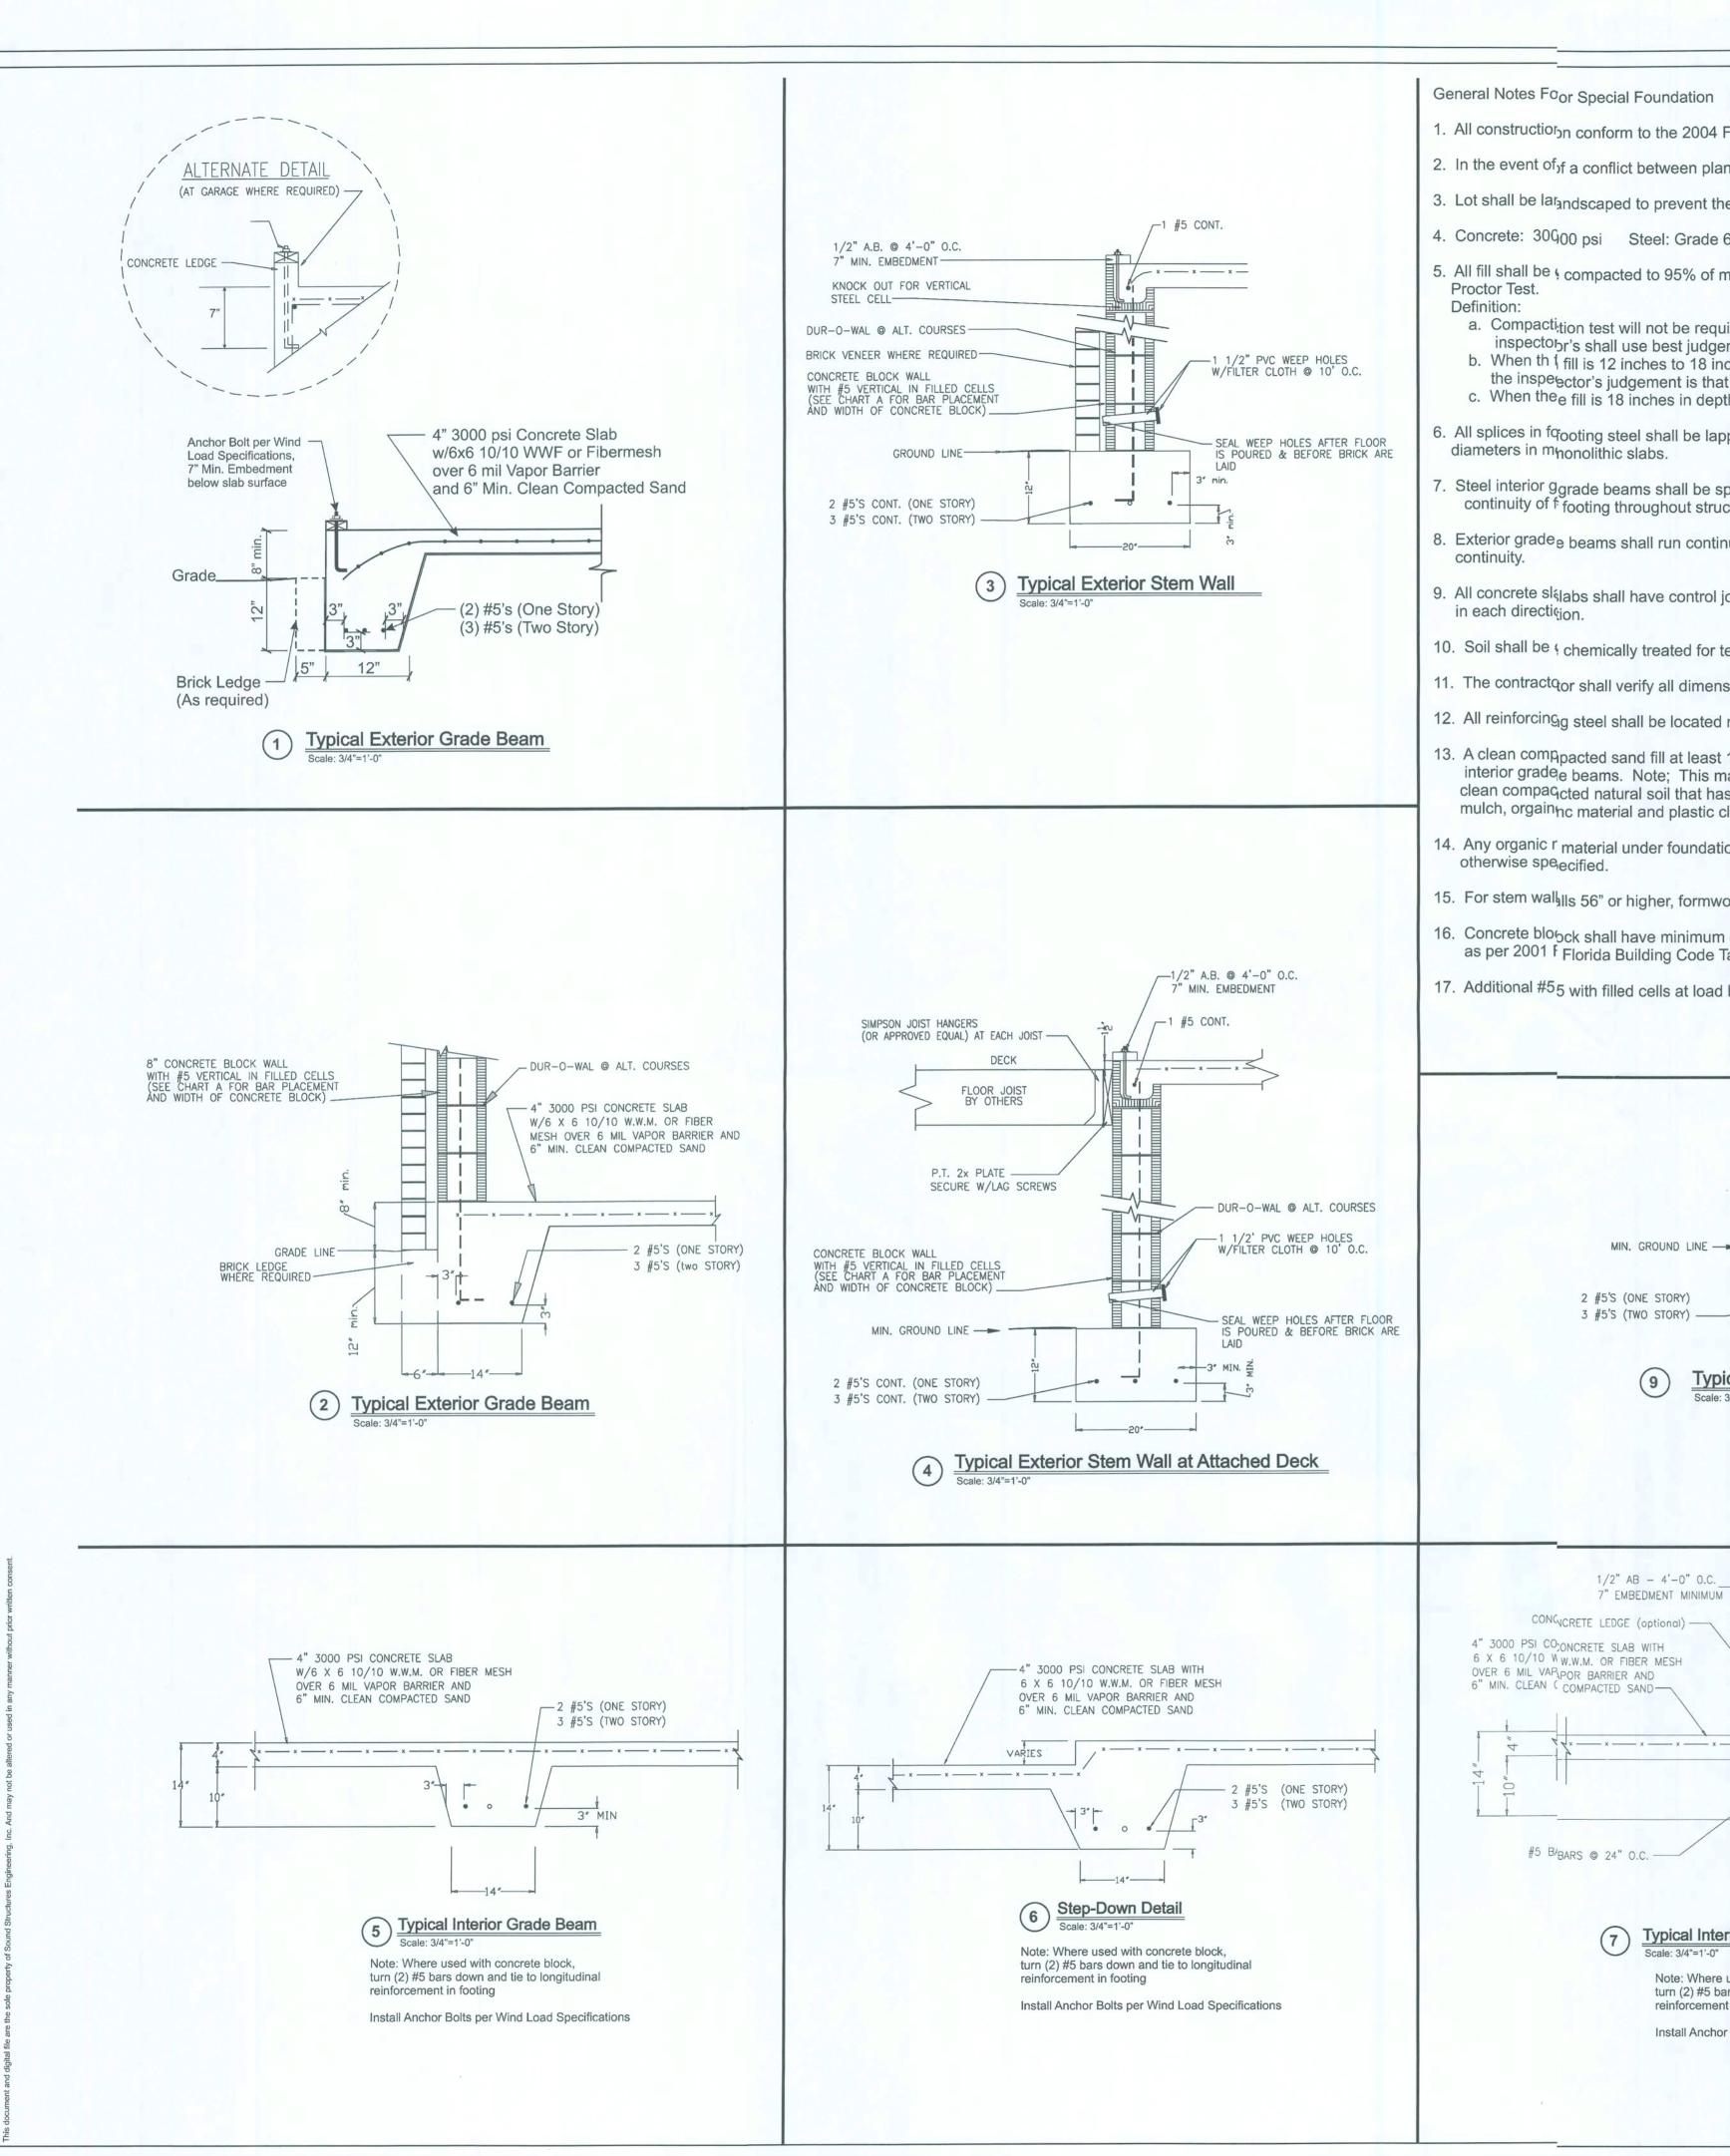

General Notes Foor Special Foundation

- 1. All construction conform to the 2004 Florida Building Code with 2006 revisions.
- 2. In the event of a conflict between plans and the codes, the codes shall govern.
- 3. Lot shall be larandscaped to prevent the detention of surface water.
- 4. Concrete: 30000 psi Steel: Grade 60
- 5. All fill shall be compacted to 95% of maximum dry density as determined by the Modified
- a. Compactition test will not be required when the fill is less than 12 inches in depth, the inspectobr's shall use best judgement.
- b. When th fill is 12 inches to 18 inches in depth, compaction test will be required only if the insperent is judgement is that the compaction is questionable.
- c. When thee fill is 18 inches in depth or more, compaction test will be required.
- 6. All splices in footing steel shall be lapped 40 bar diameters in concrete block and 30 bar diameters in mnonolithic slabs.
- 7. Steel interior ggrade beams shall be spliced to steel in exterior grade beams to assure continuity of f footing throughout structure.
- 8. Exterior gradee beams shall run continuous around the perimeter of the structure to assure
- 9. All concrete sligabs shall have control joints to control cracking spaced maximum of 15 feet
- 10. Soil shall be chemically treated for termites.
- 11. The contractor shall verify all dimensions at the site prior to beginning construction.
- 12. All reinforcingg steel shall be located ma min. 3" from concrete surface.
- 13. A clean compacted sand fill at least 18 inches thick shall be placed under all exterior and interior grade beams. Note; This may be omitted in areas that have at least 30 inches of clean compacted natural soil that has minimum bearing capacity of 2000 psf and is free of mulch, orgain nc material and plastic clays and consist of at least 50% sand (ext.)
- 14. Any organic r material under foundation shall be removed prior to construction, unless
- 15. For stem walls 56" or higher, formwork shall be braced before backfilling.
- 16. Concrete bloock shall have minimum compressive strength of 1500 psi (Grade N-1 or better) as per 2001 F Florida Building Code Table 2106.2.
- 17. Additional #55 with filled cells at load bearing points on walls.

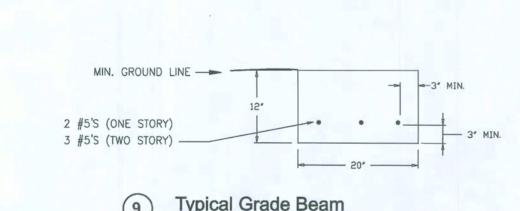

Typical Interior Grade Beam With Optional Curb

Note: Where used with concrete block,

reinforcement in footing

turn (2) #5 bars down and tie to longitudinal

Install Anchor Bolts per Wind Load Specifications

- 2 #5'S (ONE STORY)

3 #5'S (TWO STORY)

### VERTICAL BAR PLACEMENT FOR **BLOCK WALL WITH CONCRETE FLOOR SLAB OR JOIST DESIGN**

For floor joist design use bond beam with (1) #5 reinforced bar continuous for slab floor, pour into block with welded wire mesh. (See chart below)

\*\*In all cases vertical bars shall be placed at either side of openings in wall and at each corner. Vertical bars shall be bent 24" into slab, each reinforced cell shall be filled with concrete.\*\*


\*\*\*Floor system to be placed before backfilling

H (Height of wall)	Width of Block	Vertical Bar Spacing	
H <= 32"	8"	No. 5 @ 72" O.C.	
32 < H <= 56	8"	No. 5 @ 48" O.C.	
56 < H <= 72	8"	No. 5 @ 32" O.C.	
72 < H <= 88	12"	No. 5 @ 32" O.C. with bond beam with (1) #5 at mid-height	
	8"*	No. 5 @ 32" O.C.  *(8" block may be used only if neither side of wall has soil bearing pressure. A bond beam with (1) #5 shall be provided at mid-height.	
88 < H <= 120	12"	No. 5 @ 24" O.C. with bond beam with (1) #5 at mid-height	
	8"*	No. 5 @ 24" O.C.  *(8" block may be used only if neither side of wall has soil bearing pressure. A bond beam with (1) #5 shall be provided at mid-height.	
96 < H <= 120	12"	No. 5 @ 16" O.C. (All cells filled with 3000 psi concrete) with bond beam with (1) #5 at mid-height	
	8"*	No. 5 @ 24" O.C.  *(8" block may be used only if neither side of wall has soil bearing pressure. A bond beam with (1) #5 shall be provided at mid-height.	
120 < H <= 132	12"	No. 5 @ 8" O.C. (All cells filled with 3000 psi concrete) with bond beam with (1) #5 at mid-height	
	8"*	No. 5 @ 24" O.C.  *(8" block may be used only if neither side of wall has soil bearing pressure. A bond beam with (1) #5 shall be provided at mid-height.	


### CHART B **PHYSICAL PROPERTIES OF MASONRY CEMENTS**

Masonry Cement Type	N	*S	*M
Time of setting Initial set, minimum, hr. Final set, maximum, hr.	2 24	1 ½ 24	1 ½ 24
Compressive strength (average of 3 cubes, min.) 7 days, (psi) 28 days (psi)	500 900	1300 2100	1800 2900

\*For the purpose of these plans, use grade "S" or "M"

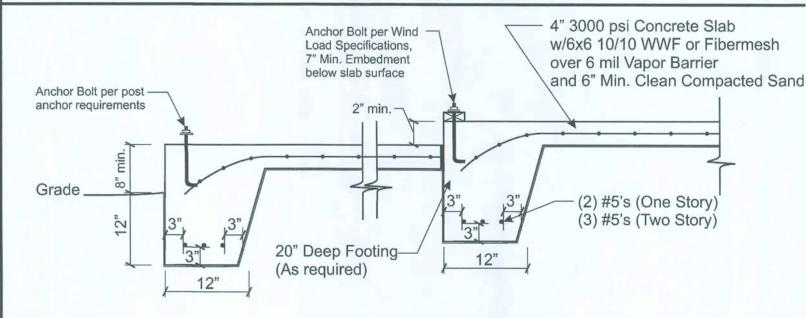

8 Typical Exterior Grade Beam

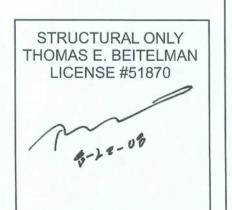

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Sheet | S3 of | 4 | 088-068


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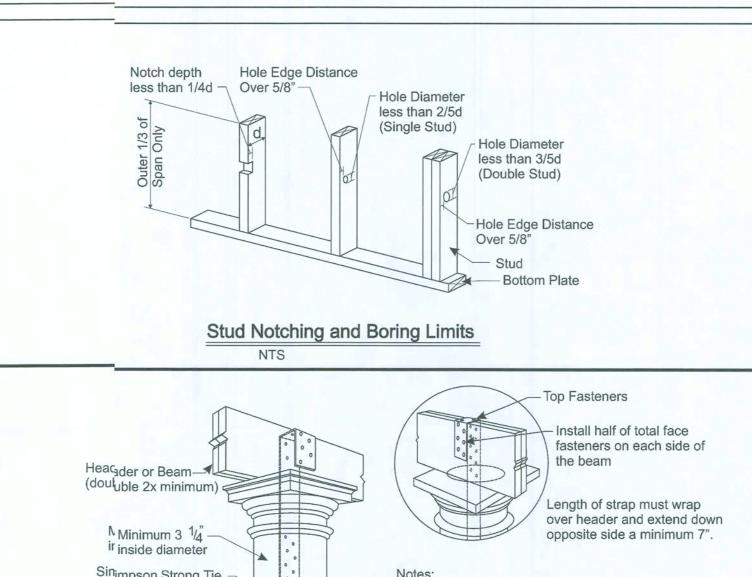
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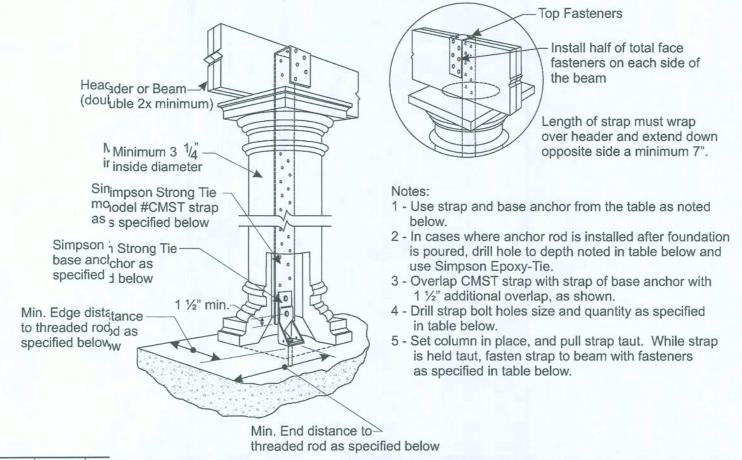
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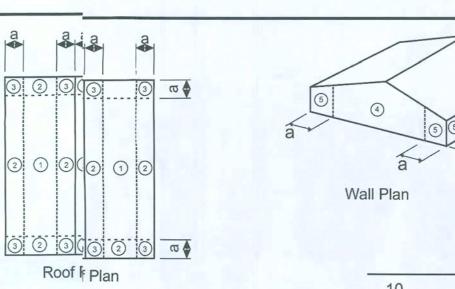






Hollow Post Uplift Connection - Conventional Strapping

Anchor Min. Min. Min. Edge Strap Strap Bolts Drill Bit Fasteners Uplift
Drill Bit Embed. Anchor Dist. Dist. Model
Dia. (In.) (In.) Length (in.) (In.) (In.) (In.) No. Qty. Dia. (Strap) (Total) Top 100 1

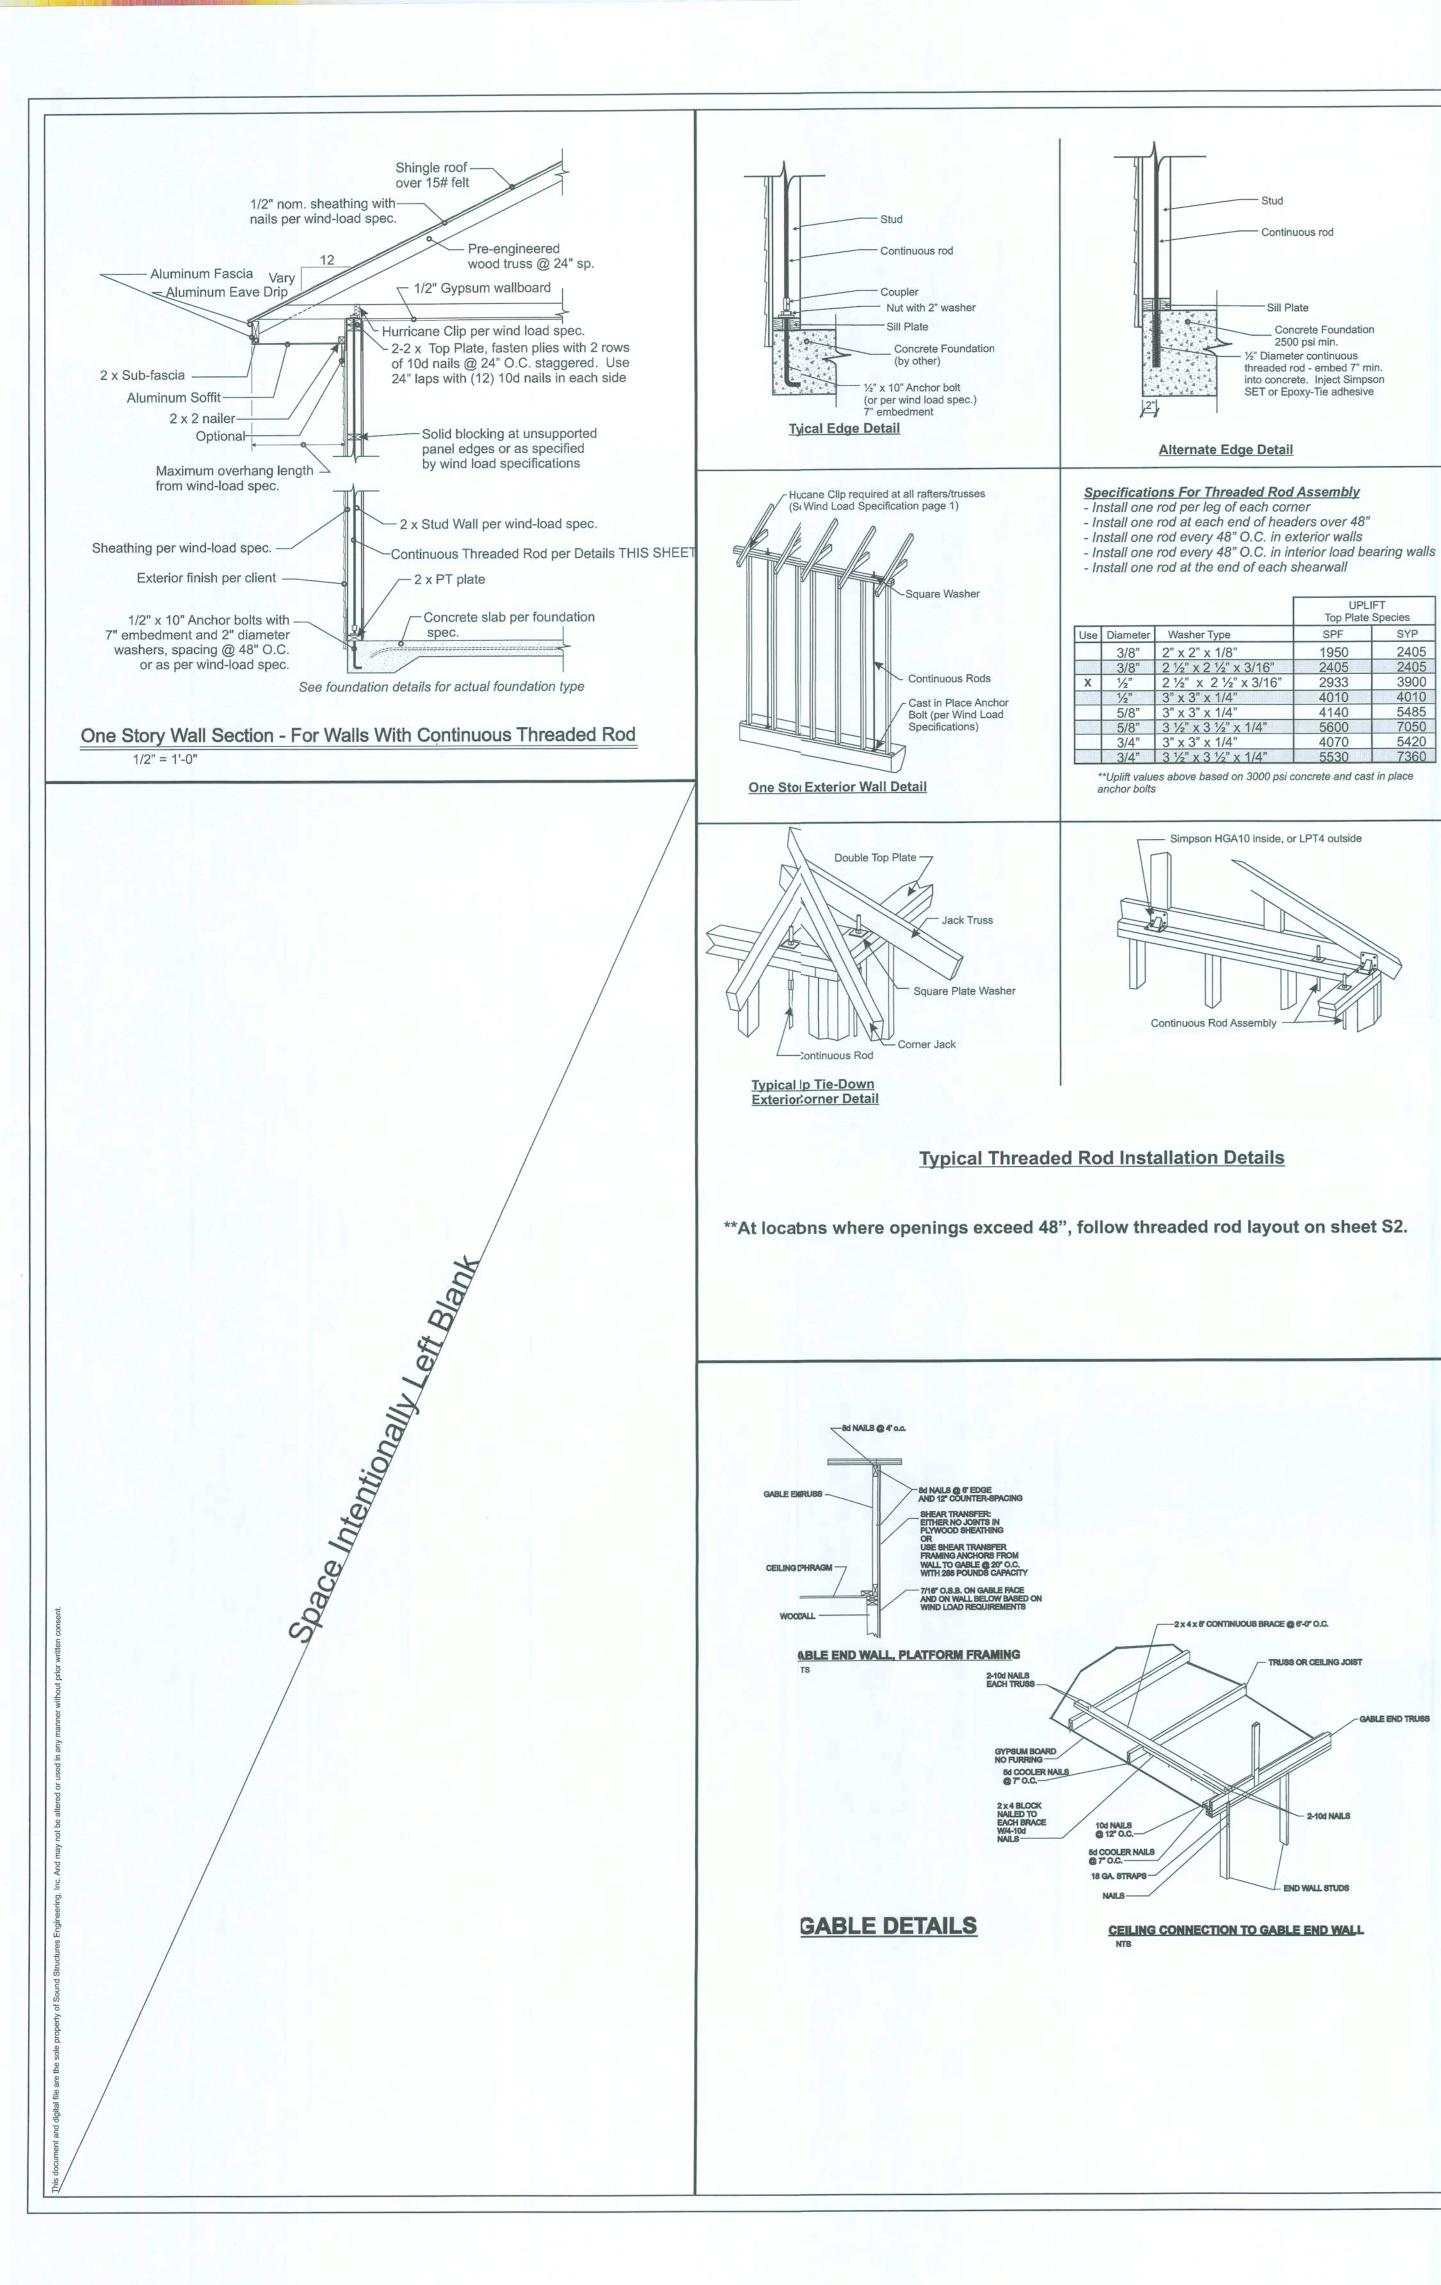

	Area (ft²)		
	10	100	500
Zone	Pressure (psf)		
1	-25.9	-21.5	-21.5
2 and 3	-30.3	-25.9	-25.9
1,2 and 3	23.7	21.5	21.5
2 and 3 (Overhang)	-47.9	-43.5	-43.5
4	-28.1	-24.1	-21.5
5	-34.7	-27.0	-21.5
4 and 5	25.9	22.0	19.3

Component and Cladding Design Pressures (Worst Case Only)



### WIND ANALYSIS - 110 MPH, 3 Second Gust Wind Velocity

ROOF SHEATHING MATERIAL:

NAILING

NAILING

Fastener 8d Ring Shank

WALL BRACING:

Prepared By:	Thomas E. Beitelman		Design Professional FL L	.ic. #:	51870
Importance factor: 1 Internal Pressure Coefficie	Building Category: 0.18	II	Wind Exposure (s):		Exposure B
	ster plan by the above contractor:	Yes	or No (circle one)	Initials:	TEB
Mean Roof Height:	12.8 ft		Stud Species:	SPF or	☐ SYP
Species for Top Plate:	SPF or SYP		Max. Stud Ht. (excluding	gable end):	8'
End Zone Length:	6.0 ft		Stud Spacing:	_	16"
Roof Slope:	6 : 12		Max. Overhang Length (e	excluding po	rches): 12
HURRICANE CLIPS (H	C)		Model # @ End	N	fodel # @
Brand:	Truss Span or Location		Zone	Int	terior Zone
Simpson Strong-Tie	All Truss Location	ons	2 - H10	1	l - H2.5A

### Wind Load Analysis Results

### **First Story Level**

Wall Number	Length (ft)	Unit Shear (plf)	Capacity (lbs)	Actual Load (lbs)	% Used	Location
		Lo	ongitudinal Wa	lls		
1	50.0	75.1	14910.0	3753.0	25.2	Exterior
2	7.0	87.6	2087.4	613.3	29.4	Exterior
3	21.0	92.5	6262.2	1942.8	31.0	Exterior
		7	ransverse Wall	's		
4	19.0	252.3	5665.8	4792.9	84.6	Exterior
5	21.3	250.7	6361.6	5347.4	84.1	Exterior

### Wall Bracing Panel Specifications:

Pa	anel Code:	Shear Walls
	Stud Spacing	16" O.C.
e e	Exterior Panel Grade	OSB Sheathing
Face	Minimum Panel Thickness (inch)	7/16
Outside	Minimum Nail Penetration in Framing	g (indh) 1/2
uts	Nail Type	8d common
$\circ$	Edge Nail Spacing	6"
	Intermediate Nail Spacing	12"
	Interior Panel Grade	Gypsum Wallboard
Face	Thickness of Material	1/2"
F	Wall Construction	Unblocked
Inside	Nail Spacing - Edge	7" O.C.
In	Nail Spacing - Intermediate	12" O.C.
	Minimum Nail Size	5d cooler or wallboard
	Total Panel Shear Capacity	298.2 plf

### General Notes: PLEASE READ!

- 1 Roof sheathing will be a minimum of 7/16" in thickness with a nailing pattern specified **above**.
- 2 Exterior wall sheathing will be a minimum of 7/16" in thickness with the nailing pattern specified above, and locations referenced from the attached sheets.
- 3 All exterior load-bearing and shear walls will have a stud spacing specified at 16" O.C. except as noted below. 4 All load bearing and shear walls will be framed with 2 x 4 No. 2 grade SPF studs or better.
- 5 Alternative hurricane clips are acceptable, provided they meet the minimum specification for those specified on
- 6 Bearing wall and shear wall door and window headers are to be 2-2 x 10 SYP with 1/2" CDX fletch for lengths under 6 ft unless otherwise specified on plans..
- 7 Simpson Strong Tie HH4 Header Hanger or equivalent should be provided on bearing wall and shear wall door and window openings over 6 ft.
- 8 Simpson Strong Tie model #HD5A hold downs are acceptable alternatives to the specified PHD2-SPS3.
- 9 4" x 4" Posts will require Simpson Strong Tie Post Bases model #ABU44 or better and double LSTA18 straps on each beam at top.
- 10 Place additional threaded rod anchors within 12" of ends of sill plates, but not closer than 3 1/2" from end of plate.

THOMAS E. BEITELMAN **LICENSE #51870** 

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CLIENT:

STRUCTURAL ONLY

No. 08S-068

Sheet S4 of 4