

Place Creek Lake City, FL 3202

SOFTPIAN

CONTRACTING, L FT-HAND) FOR:

F, Cannon

261 SW Arrowbend Drive, 1 GIBRALTAR
LIC# 1259633 HIGH SF 261 763 (LEF MODEL 17
Lot
Property Ac

© VM DEJGN &
A550CIATE5, NC.
426 SW COMMERCE DR, STE 130
LAKE CITY, F. 32025
(386) 7588406
will@willmyrs.net



JOB NUNBER 20200303

SHEET NUMBER

OF 3 SHEETS

1,771 S.F.

524 S.F.

50 S.F.

125 S.F.

2,470 S.F.

AREA SUMMARY


LIVING AREA

**GARAGE AREA** 

TOTAL AREA

**ENTRY PORCH AREA** 

COVERED PORCH AREA

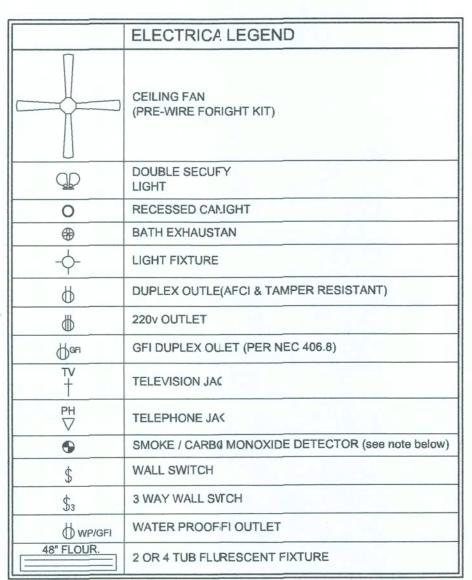


ALL INTERIOR RECEPTACLES SHALL E AFCI (ARC FAULT CIRCUIT INTERRUPT) PENEC 210.12 & TAMPER RESISTANT PER

ALL SMOKE DETECTORS BE A COMBISMOKE & CARBON MONOXIDE DETECTOR AND SHALL HAVE BATTERY BACKUP DWER AND ALL WIRED TOGETHER SO IF ANONE UNIT IS ACTUATED THEY

ALL ACTIVATE. THE ELECTRICAL SERVICE OVERCURENT PROTECTION DEVICE SHALL BE INSTALLED ON THE EXTERIOR OF STUCTURES TO SERVE AS A DISCONNECT MEANS.

CONDUCTORS USED FROM THE EXTRIOR DISCONNECTING MEANS TO A PANEL OR SUB PANEL SHALL HAVE FOUR-WIRE CONUCTORS, OF WHICH ONE CONDUCTOR SHALL BE USED AS AN EQUIPMENT GOUND.

IT IS THE LICENSED ELECTRICAL COPRACTORS RESPONSIBILITY TO INSURE THAT ALL WORK PERFORMED AND EQUIPMENT/NSTALLED MEETS OR EXCEEDS THE NFPA70 2011 NATIONAL ELECTRIC CODE AND ALL OTHER LOAL CODES AND ORDINANCES.

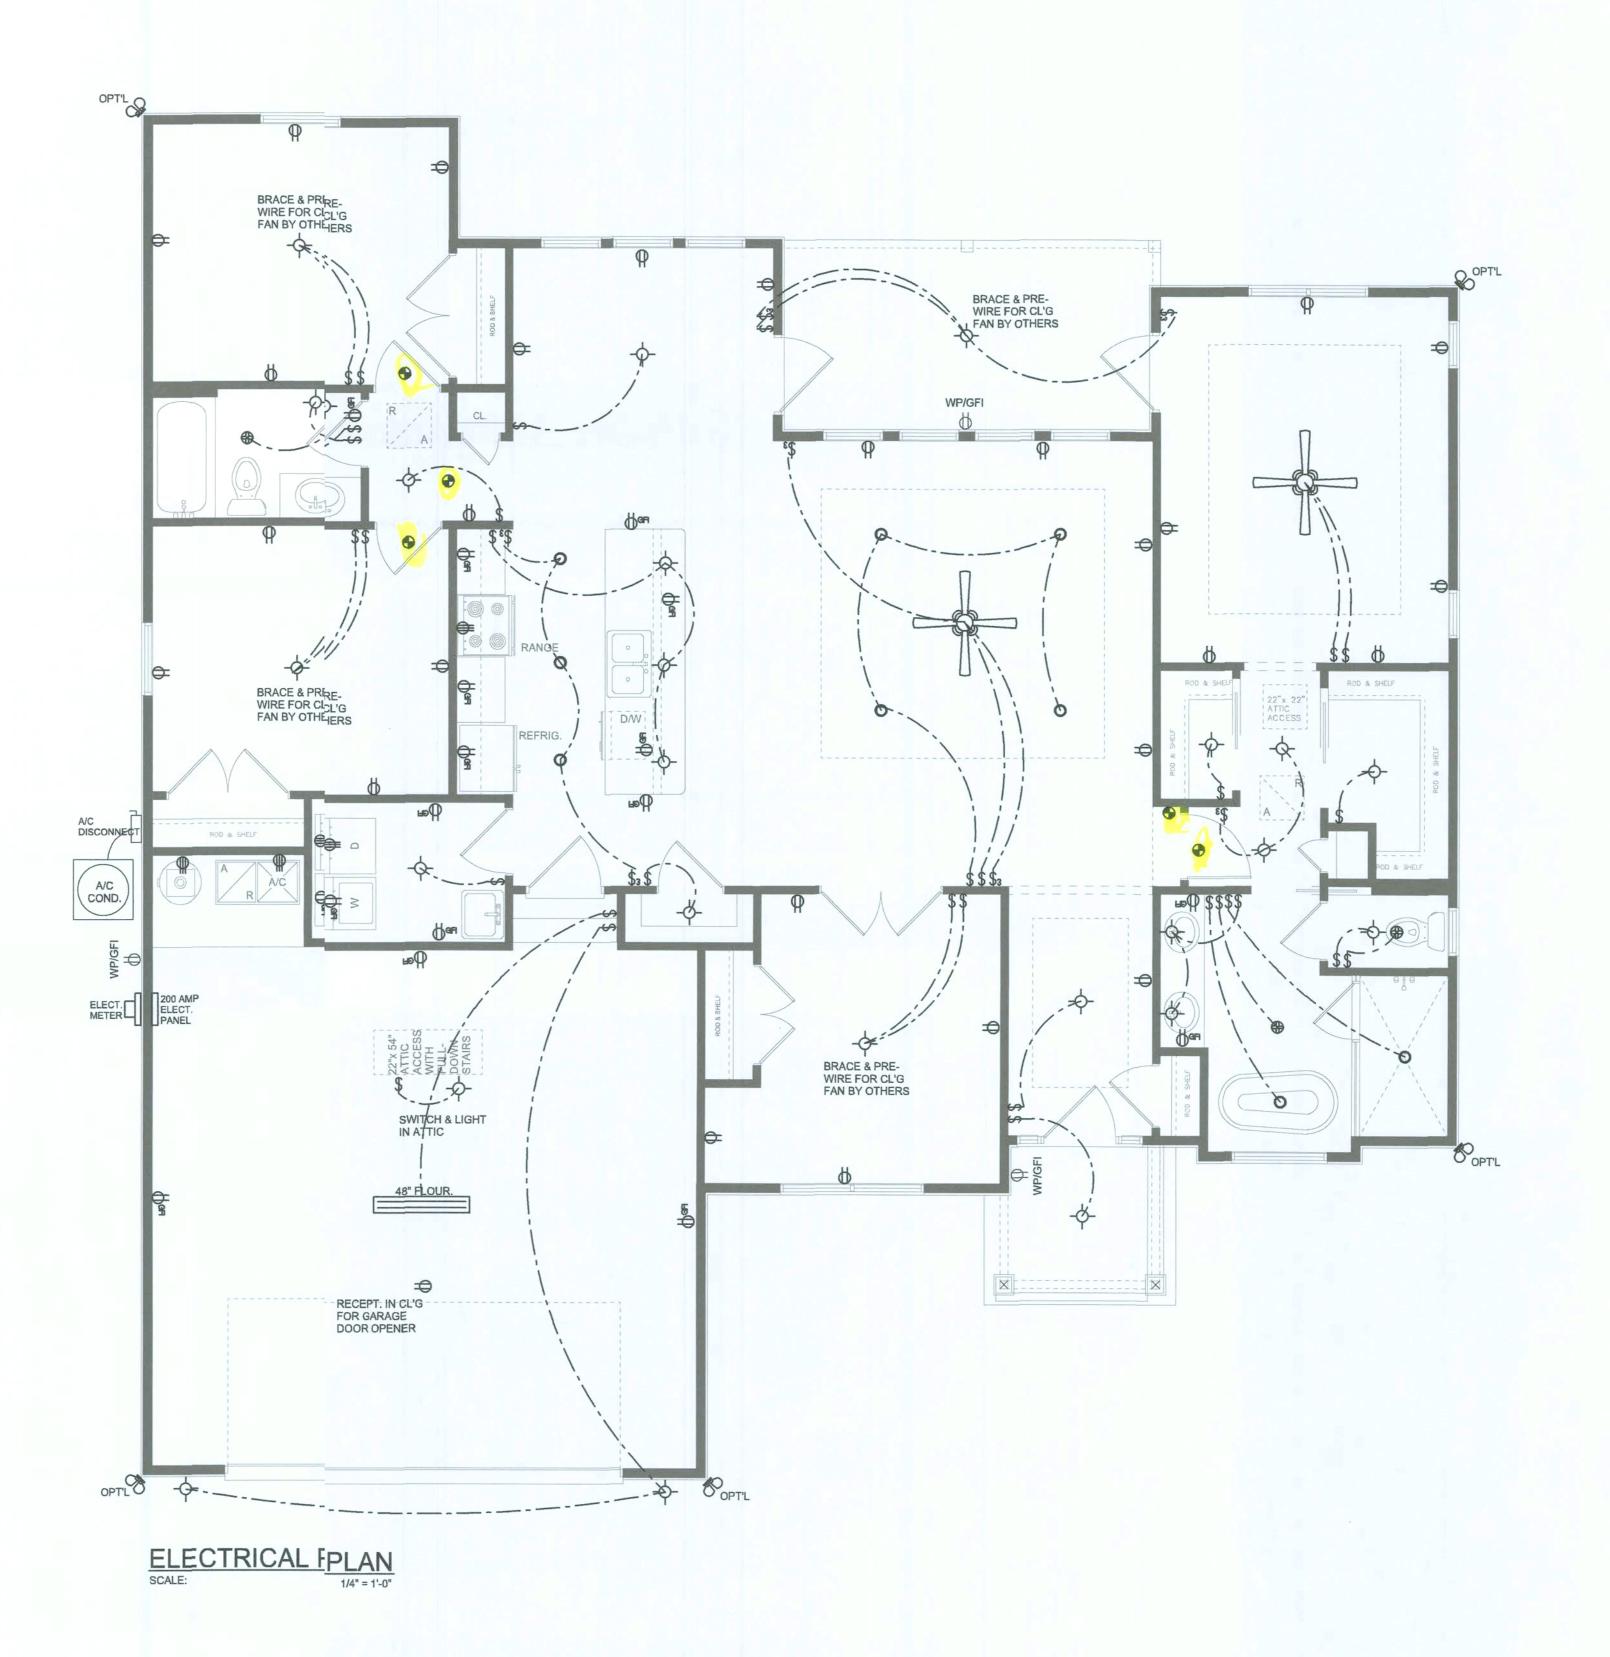

SOFTPXN ARCHITECTURAL DEICH SCETTURAL

AN = 1'-0"

Place ACTING, CONTRA FT-HAND) FOR:

Ly Cannon

Ly Cann **GIBR**/LIC# 12596;

3 NDICID MV/ © A550CIATE.5, NC. 426 SW COMMERCE DR, STE 130 LAKE CITY,FL 32025 (386) 753-8406 will@willnyers.net

MODEL 17


Lot
Property A




JOB NUMBER 20200603


SHEET NUMBER

OF 3 SHEETS

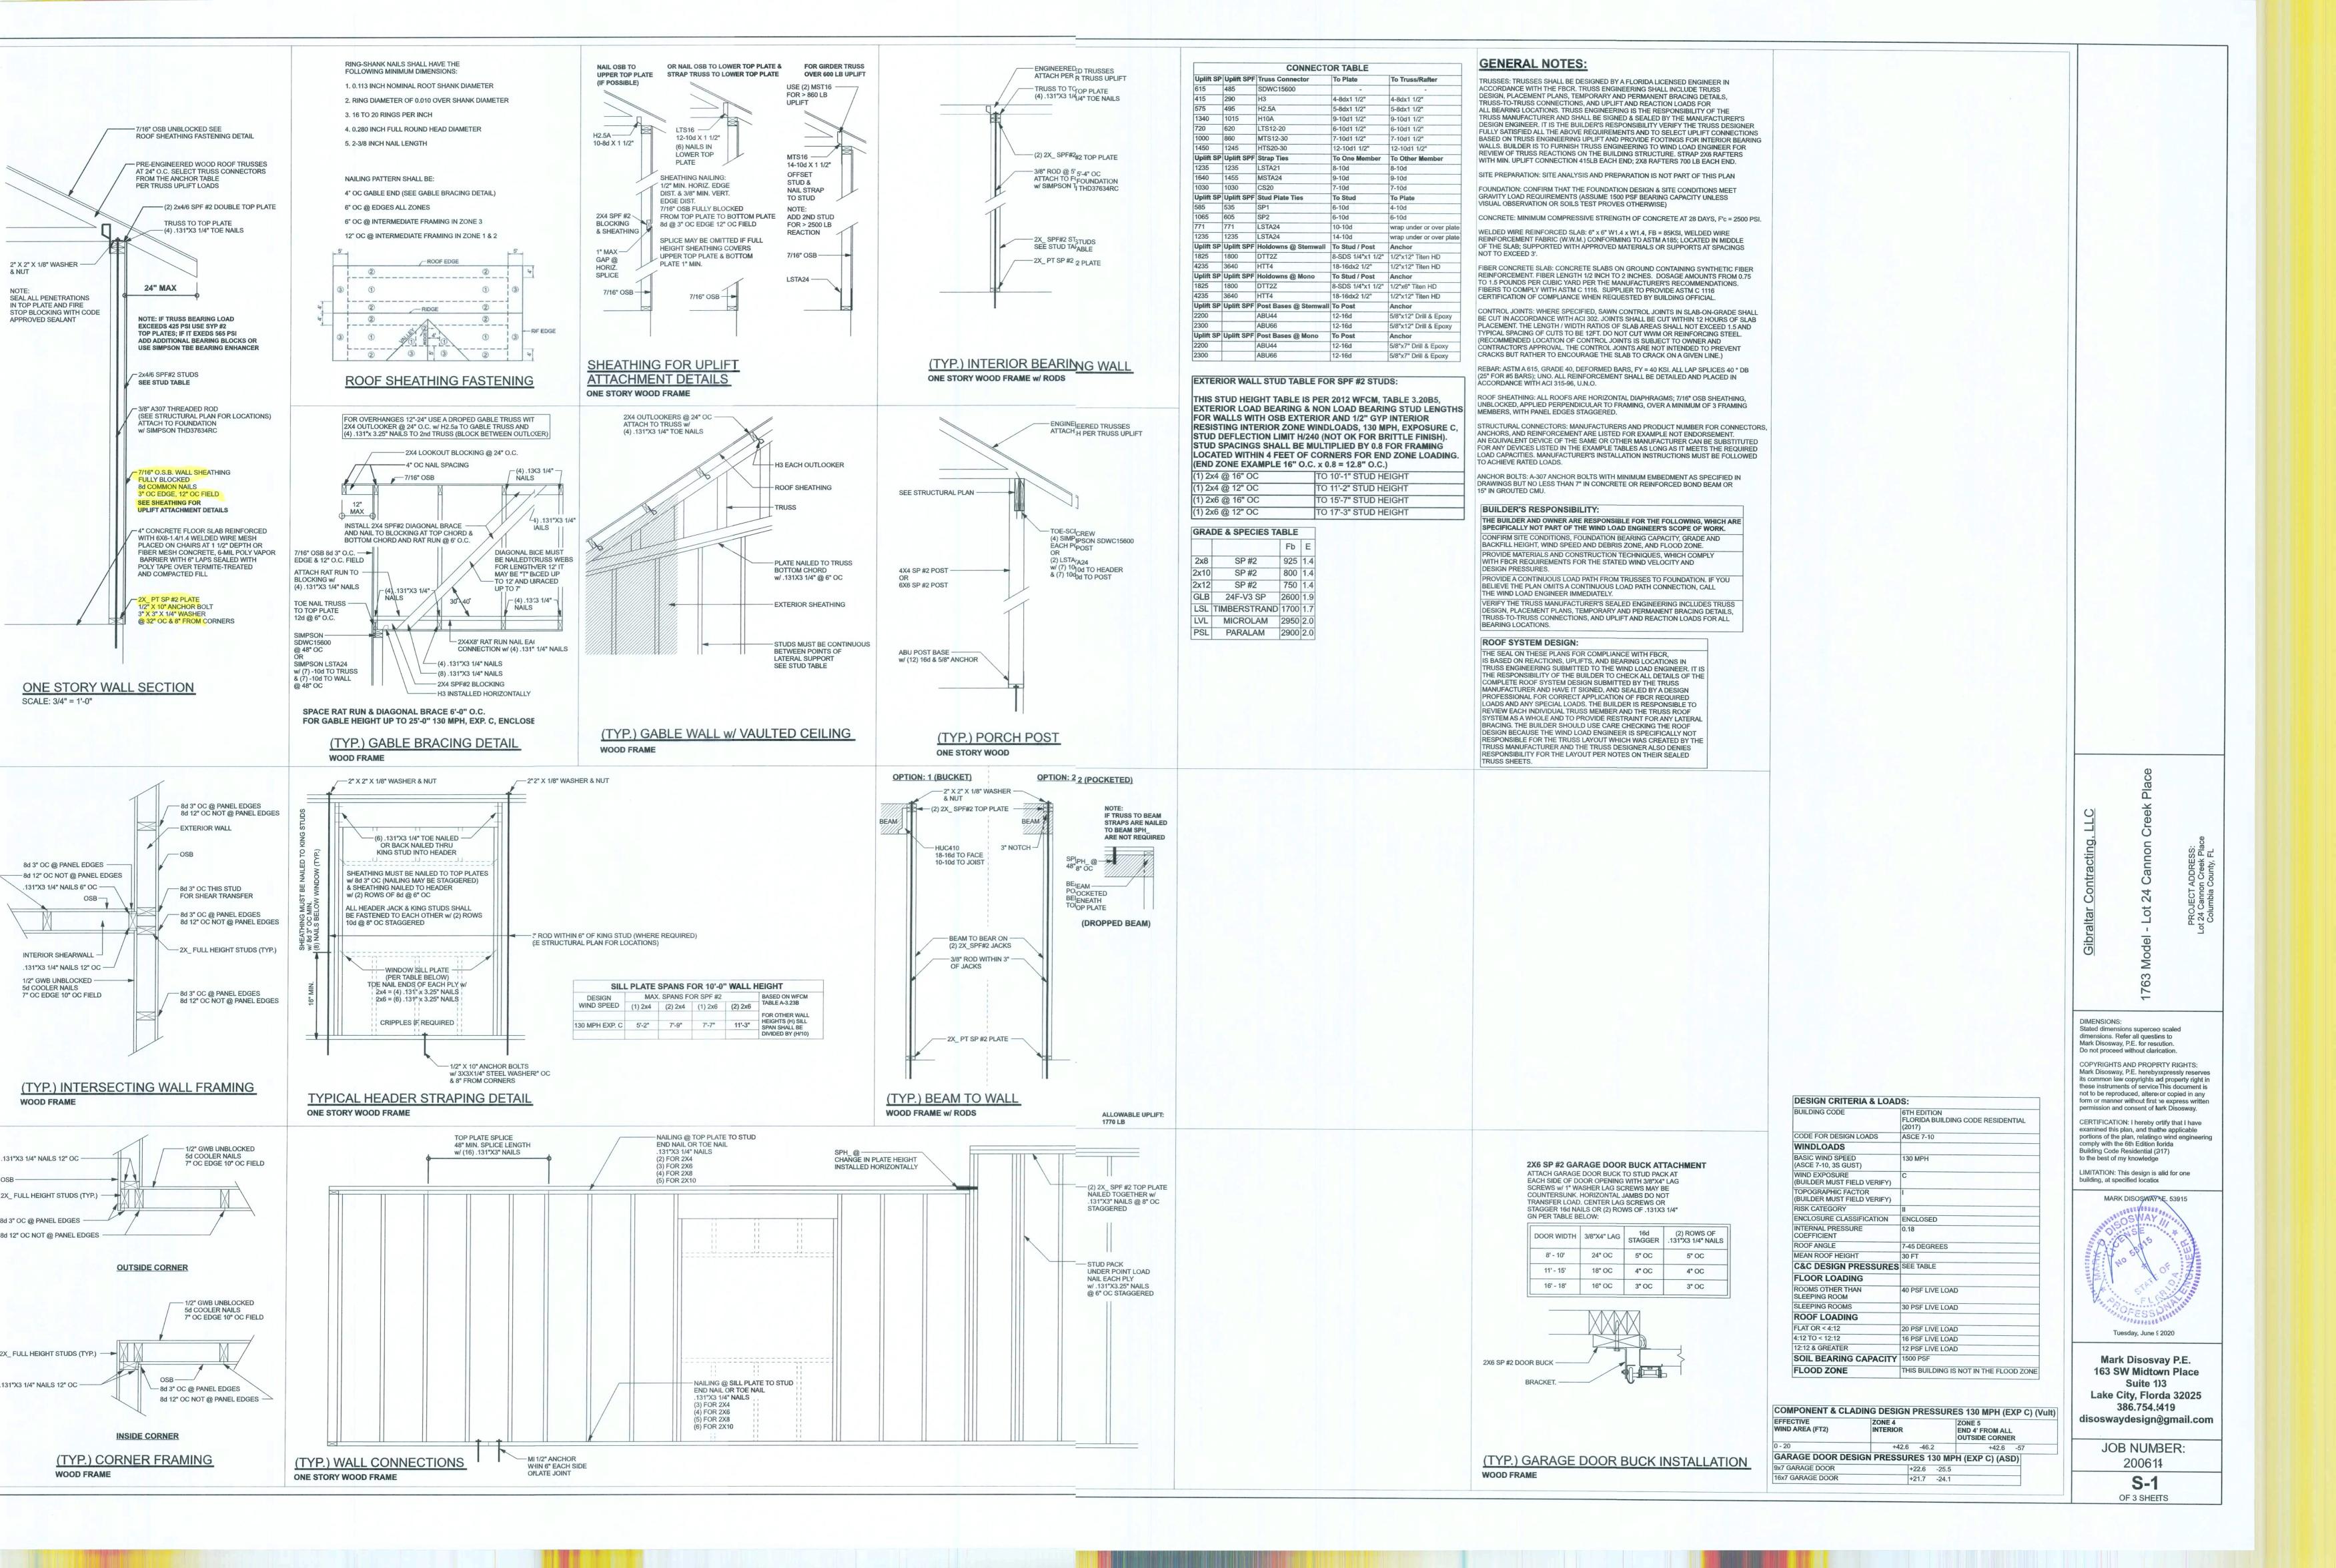

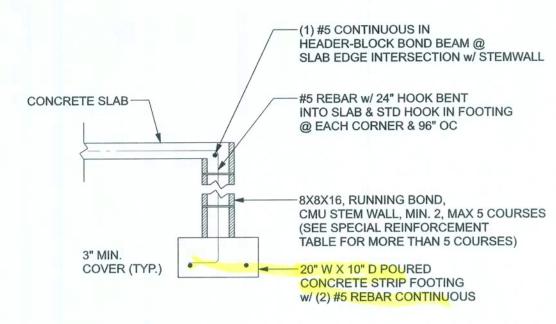


#### OPTIONAL STEM WALL FOOTING S-2 SCALE: 1/2" = 1'-0"

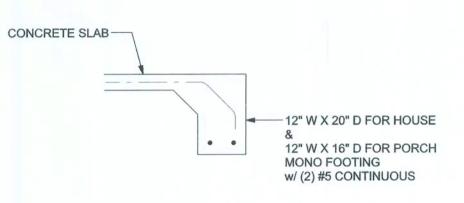


### MONOLITHIC FOOTING


SCALE: 1/2" = 1'-0"

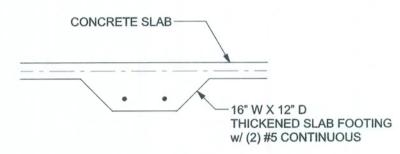


## F2 INTERIOR BEARING FOOTING S-2 SCALE: 1/2" = 1'-0"

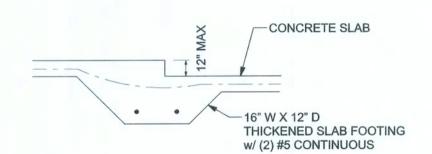

### F3 INTERIOR BEARING STEP FOOTING S-2 SCALE: 1/2" = 1'-0"

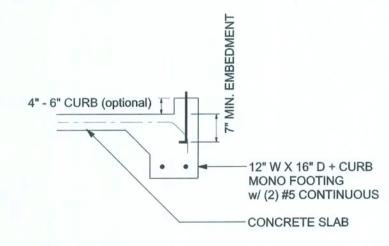

#### MONOLITHIC CURB FOOTING SCALE: 1/2" = 1'-0"

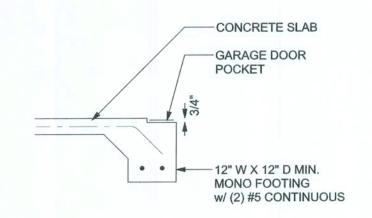

GARAGE DOOR POCKET FOOTING SCALE: 1/2" = 1'-0"

Te table ass rnforced sla GU wall (aw iever 8' high bam with 1#	b at the top. T yay from the s , add Durowa 5 continuous	reinforcing bars with 6" hook in the retrical steel is to be placed to oil pressure, within 2" of the extent ladder reinforcement at 16"OC at mid height. For higher parts of the table below.	toward the tension side of the prior side of the wall). If the wall evertically or a horizontal bond
	INBALANCED	VERTICAL REINFORCEMENT	VERTICAL REINFORCEMENT
JEIGHT	BACKELL	FOR 8" CMILSTEMWALL	FOR 12" CMU STEMWALL


EMWALL (EIGHT (FEET)	UNBALANCED BACKFILL HEIGHT	VERTICAL REINFORCEMENT FOR 8" CMU STEMWALL (INCHES O.C.)			VERTICAL REINFORCEMENT FOR 12" CMU STEMWALL (INCHES O.C.)		
		#5	#7	#8	#5	#7	#8
3.3	3.0	96	96	96	96	96	96
4.0	3.7	96	96	96	96	96	96
4.7	4.3	88	96	96	96	96	96
5.3	5.0	56	96	96	96	96	96
6.0	5.7	40	80	96	80	96	96
6.7	6.3	32	56	80	56	96	96
7.3	7.0	24	40	56	40	80	96
8.0	7.7	16	32	48	32	64	80
8.7	8.3	8	24	32	24	48	64
9.3	9.0	8	16	24	16	40	48

ASO SALI DR N TE C ROC ETW AY E	L CONFORM TO ALL REQU MASONRY STRUCTURES" CONTRACTOR AND MASON EEDING, NOTIFY THE ENG EEN ACI 530.1-02 AND THI	D MATERIALS FOR THIS PROJECT JIREMENTS OF "SPECIFICATION (ACI 530.1/ASCE 6/TMS 602). M MUST IMMEDIATELY, BEFORE GINEER OF ANY CONFLICTS ESE DESIGN DRAWINGS. -02 MUST BE APPROVED BY
	ACI530.1-02 Section	Specific Requirements
1A	Compressive strength	8" block bearing walls F'm = 1500 psi
2	Mortar	ASTM C 270, Type N, UNO
2	Grout	ASTM C 476, admixtures require approval
2	CMU standard	ASTM C 90-02, Normal weight, Hollow, medium surface finish, 8"x8"x16" running bond and 12"x12" or 16"x16" column block
2	Clay brick standard	ASTM C 216-02, Grade SW, Type FBS, 5.5"x2.75"x11.5"
2	Reinforcing bars, #3 - #11	ASTM 615, Grade 40, Fy = 40 ksi, Lap splices min 40 bar dia. (25" for #5)
F	Coating for corrosion protection	Anchors, sheet metal ties completely embedded in mortar or grout, ASTM A525, Class G60, 0.60 oz/ft2 or 304SS
F	Coating for corrosion protection	Joint reinforcement in walls exposed to moisture or wire ties, anchors, sheet metal ties not completely embedded in mortar or grout, ASTM A153, Class B2, 1.50 oz/ft2 or 304SS
3E.2	Pipes, conduits, and accessories	Any not shown on the project drawings require engineering approval.
3E.7	Movement joints	Contractor assumes responsibility for type and location of movement joints if not detailed on project drawings.

	\
BOTTOM OF EXTERIOR FOOTINGS SHALL BE A MINIMUM O	F
12" BELOW UNDISTURBED SOIL OR ENGINEERED FILL	
PER FBC 2014-RES. SECTION R403.1.4	
	~

NOTE: GARAGDOOR OPENINGS MUST H/E LATERAL SUPPOR(FLOOR OR PERPENCULAR WALL)	(1) #5 CONTINUOUS IN HEADER-BLOCK BOND BEAM
@ TOP CRETAINING WALL WITHIN 3" OF OPENING  CONCREE SLAB	#5 VERT. REBAR w/ STD HOOK IN FOOTING @ EACH CORNER & 48" OC
1.717	8X8X16, RUNNING BOND, CMU STEM WALL
3" MIN. COVER (TYP.)	20" W X 10" D POURED CONCRETE STRIP FOOTING W/ (2) #5 REBAR CONTINUOUS

F4 OPTIONAL STEM WALL CURB FOOTING
S-2 SCALE: 1/2" = 1'-0"

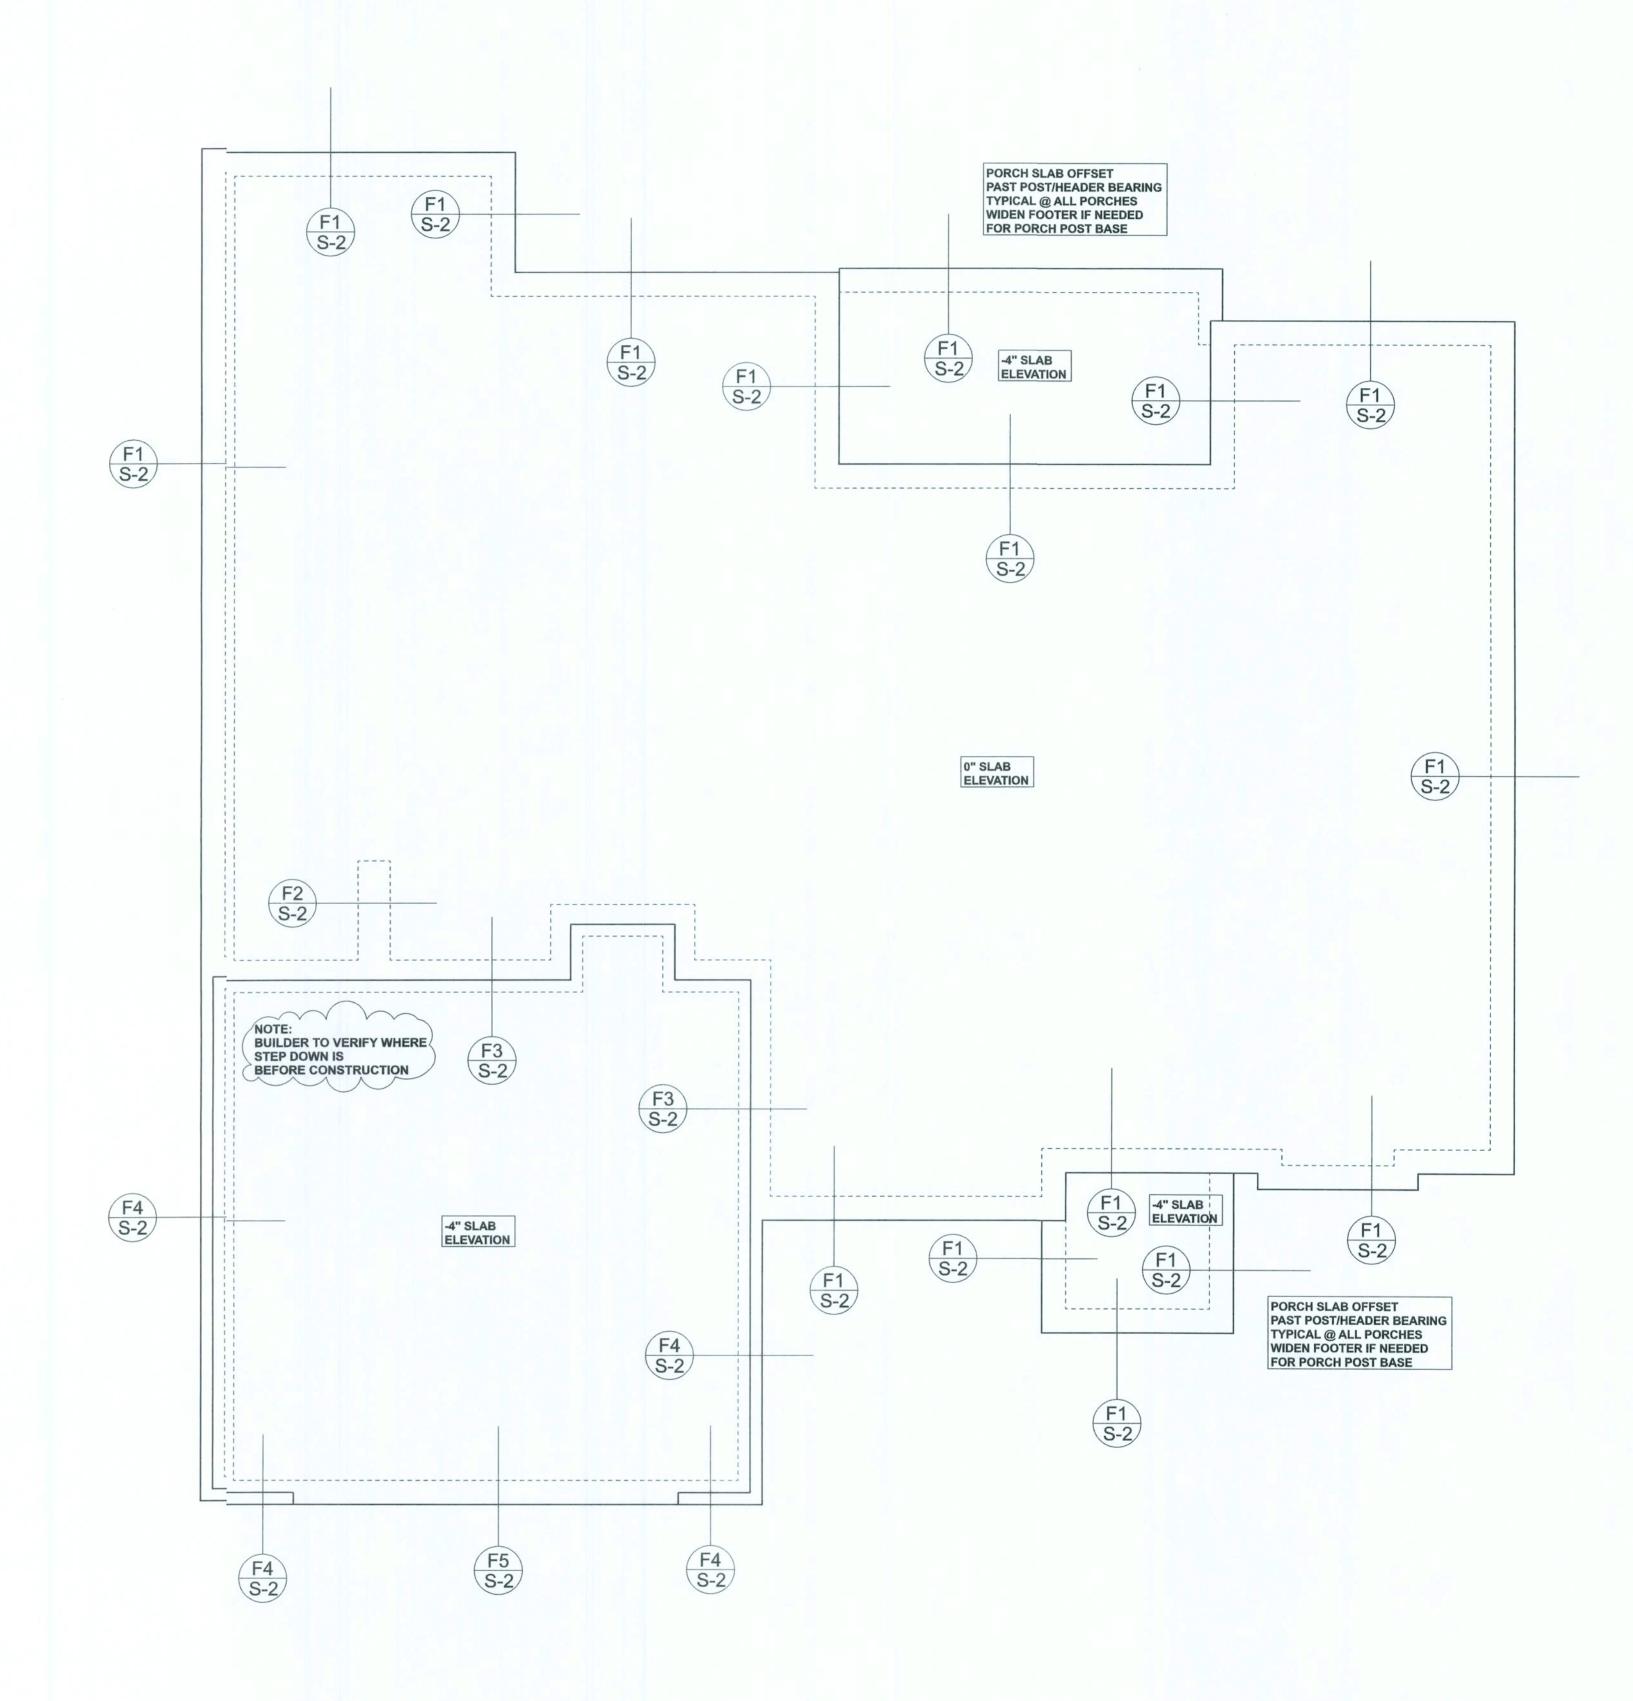

DIMENSIONS: Stated dimensions supercde scaled dimensions. Refer all quesions to Mark Disosway, P.E. for reolution. Do not proceed without claffication.

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CERTIFICATION: I herebycertify that I have examined this plan, and thit the applicable portions of the plan, relating to wind engineering comply with the 6th EditiorFlorida Building Code Residential 2017) to the best of my knowlede. LIMITATION: This design i valid for one building, at specified location.




Tuesday, Jun€9, 2020

Mark Disosway P.E. 163 SW Midbwn Place Suite 103 Lake City, Florida 32025 386.7545419 disoswaydesigi@gmail.com


> JOB NUMBER: 200614 **S-2**

> > OF 3 SHIETS

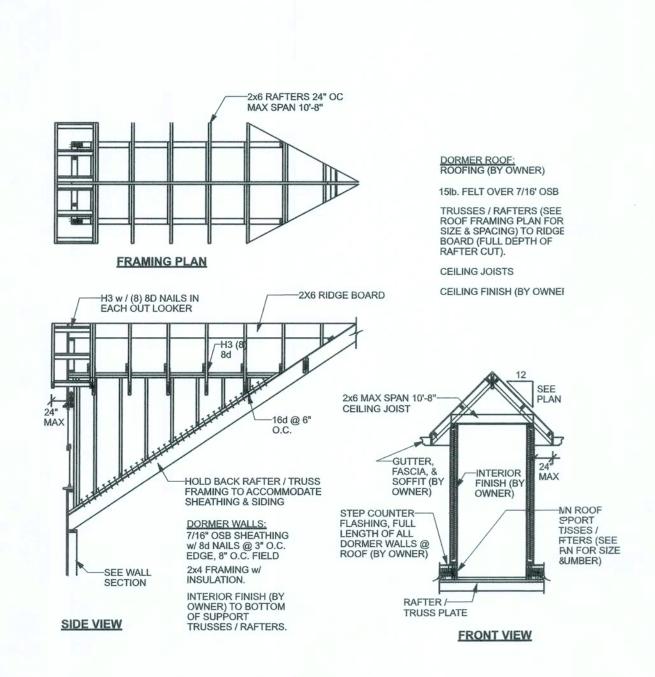

DORMER ANCHORING DETAIL (ON ROOF)

SCALE: N.T.S.

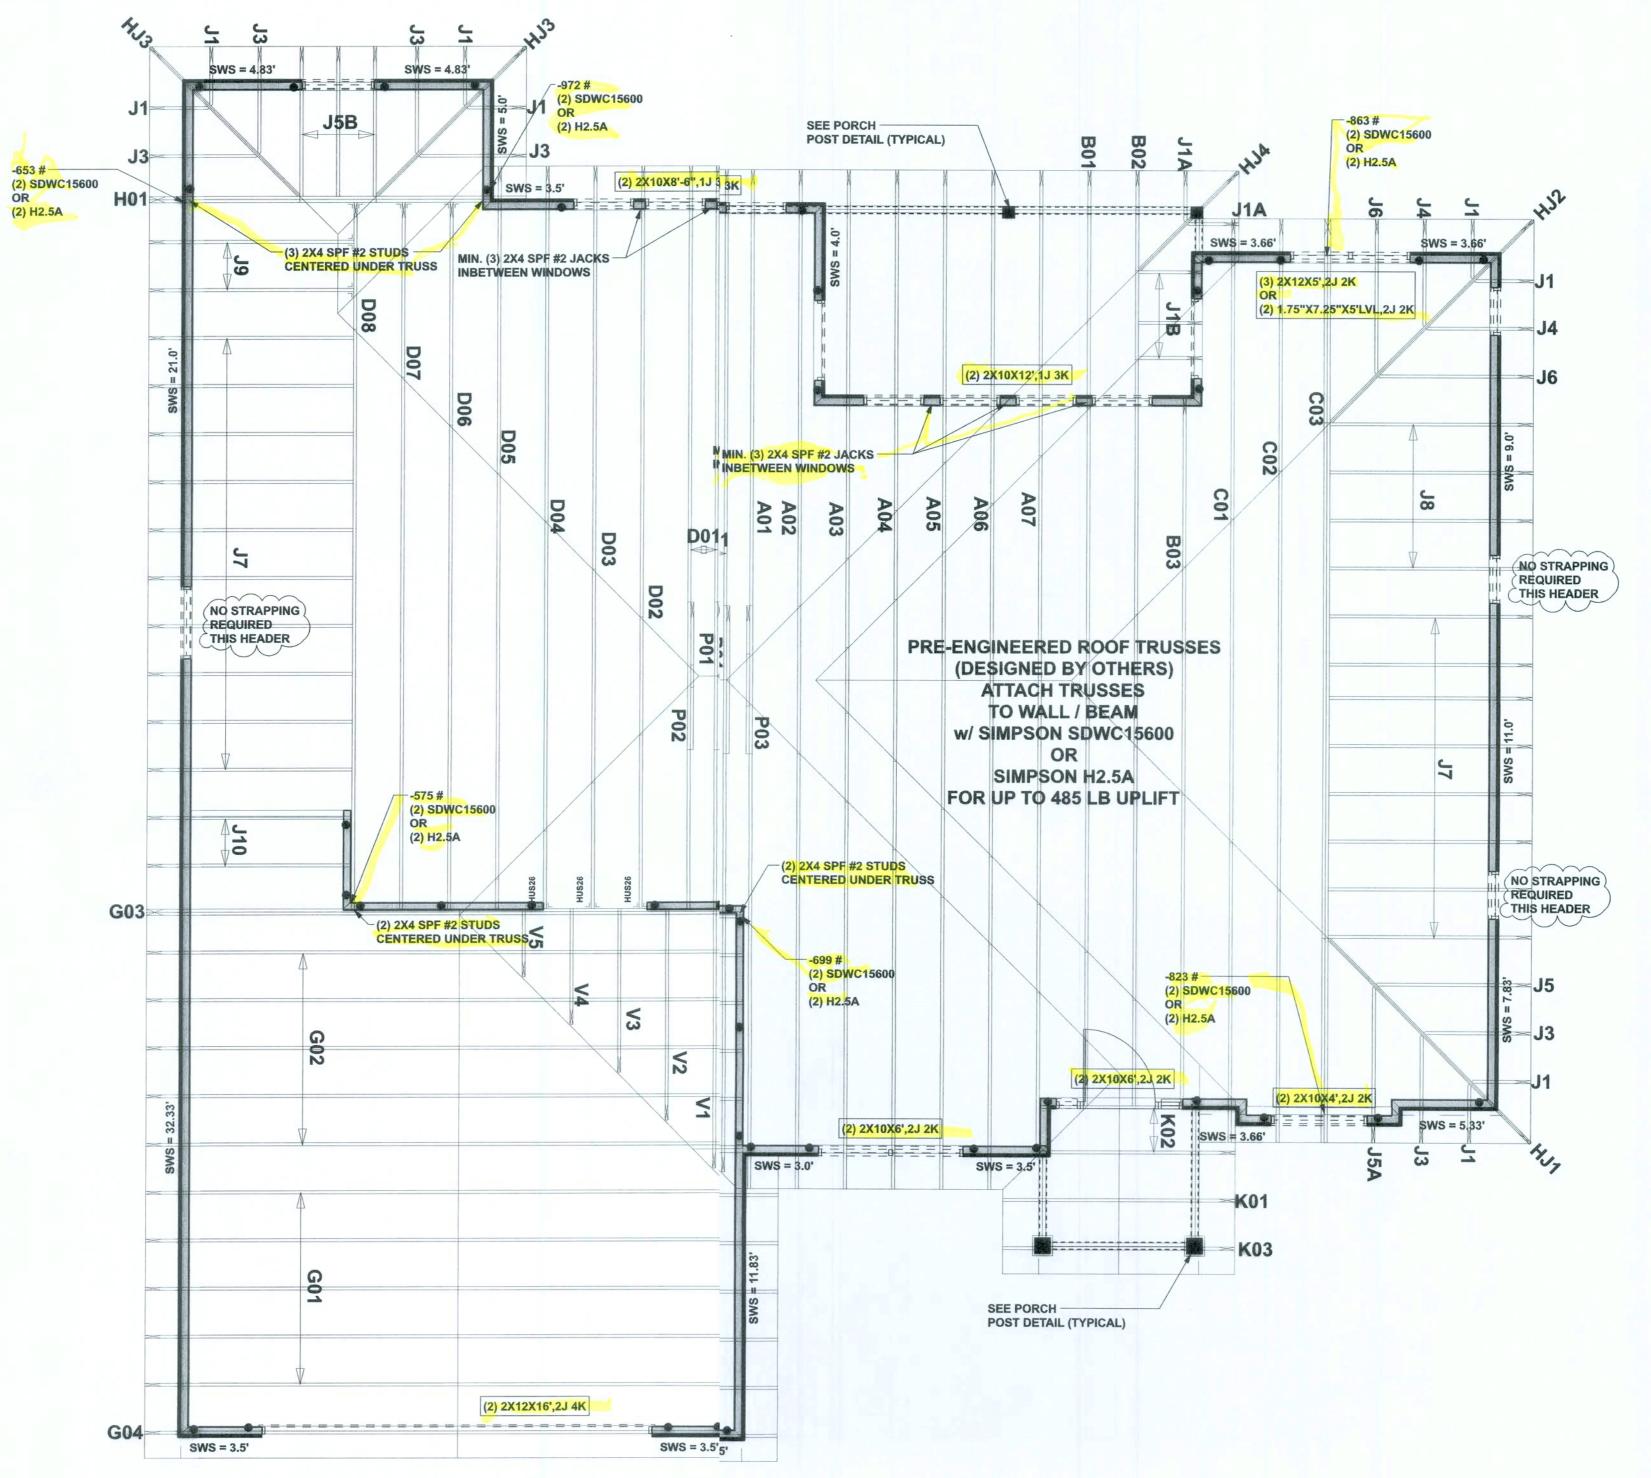

STRUCTURAL PLAN
SCALE: 1/4" = 1'-0"

#### STRUCTURAL PLAN NOTES

SN-1 ALL LOAD BEARING FRAME WALL & PORCH HEADERS SHALL BE A MINIMUM OF (2) 2X10 SP #2 (U.N.O.)

SN-2
ALL LOAD BEARING FRAME WALL HEADERS
SHALL HAVE (1) JACK STUD & (1) KING STUD
EACH SIDE (U.N.O.)

SN-3 USE ONE JACK STUD GIRDER SUPPORT PER 2500 LB LOAD


SN-4 DIMENSIONS ON STRUCTURAL SHEETS ARE NOT EXACT. REFER TO ARCHITECTURAL FLOOR PLAN FOR ACTUAL DIMENSIONS

SN-5

PERMANENT TRUSS BRACING IS TO BE INSTALLED AT LOCATIONS AS SHOWN ON THE SEALED TRUSS DRAWINGS.

LATERAL BRACING IS TO BE RESTRAINED PER BCSI1-03, BCSI-B1, BCSI-B2, & BCSI-B3. BCSI-B1, BCSI-B2, & BCSI-B3 ARE FURNISHED BY THE TRUSS SUPPLIER, WITH THE SEALED TRUSS PACKAGE

#### HEADER LEGEND

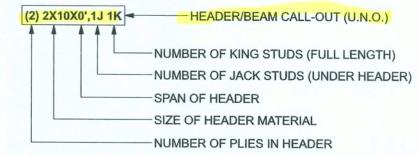

#### THREADED ROD LEGEND

REQUIRED 15031 LBF



— INDICATES LOCATION OF: 3/8" A307 ALL THREADED ROD

12593 LBF

# ACTUAL vs REQUIRED SHEARWALL TRANSVERSE LONGITUDUNAL ACTUAL 26174 LBF 14190 LBF

763 Model - Lot 24 Cannon Creek Place

DIMENSIONS:
Stated dimensions supercedescaled dimensions. Refer all questions to Mark Disosway, P.E. for resoltion.
Do not proceed without clarification.

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CERTIFICATION: I hereby ceiffy that I have examined this plan, and that te applicable portions of the plan, relating twind engineering comply with the 6th Edition Flrida Building Code Residential (207) to the best of my knowledge.

LIMITATION: This design is viid for one building, at specified location.



Mark Disoswıy P.E. 163 SW Midtovn Place Suite 1® Lake City, Florila 32025 386.754.5i19 disoswaydesign@gmail.com

JOB NUMBER:

OF 3 SHEE'S

S FROM TRUSS ENGINEERING
W.B. HOWLAND TRUSS CO.

JOB NUMBI
200614

S-3

CONNECTIONS, WALL, & HEADER DESIGN IS BASED ON REACTIONS & UPLIFTS FROM TRUSS ENGINEERING FURNISHED BY BUILDER. W.B. HOWLAND TRUSS CO. JOB #19-3670