
· (1)	ABBRE	VIATIONS	REFERENCE SII	MBOLS	GENER
	1HR 1 HOUR 2HR 2 IHOUR ACC AC:CESSIBLE ACT ACIOUSTICAL ADJ AD.JUSTABLE AFF ABOVE FINIS AL ALUMINUM (COINSTRUCT ALUM ALLUMINUM APPROX APIPROXIMA BLKG BLOCKING BOB BOTTOM OF BLDG BUILDING CAB CABINET CLG CEILING CLR CLEIAR/CLEA	HR HOUR HORZ HORIZONTAL HW HOT WATER HAVAC HEATING VENTILATING AIR CONDITIONING E IF INSIDE/INTERIOR FACE INSULATION STOREFRONT ID INSIDE DIAMETER LL LANDLORD AIR MAX MAXIMUM INFO INFORMATION MECH MECHANICAL MIN MINIMUM MC MECHANICAL CONTRACTO MLDG MOULDING MTL METAL ARANCE MASONRY UNIT MAT NATURAL MFG MANUFACTURER NR NOT RATED NIC NOT IN CONTRACT OA OVER ALL OC ON CENTER NL NIGHT LIGHTING OF OUTSIDE FACE PLYWD PLYWOOD PT PAINT PC PLUMBING CONTRACTOR R RADIUS PD PRODUCTION DESIGNER REF REFERENCE PLYWD PLYWOOD PT PAINT PC PLUMBING CONTRACTOR R RADIUS PD PRODUCTION DESIGNER REF REFERENCE REQ('D) REQUIRE(D) PLAM PLASTIC LAMINATE PM PROJECT MANAGER REV REVISED/REVISION RESP RESPONSIBILITIES CONTRACTOR SC SC SULD CORE STIL STEEL STIL SHEET SIM SIMILAR SOL SOLID OT QUARRY TILE SQ SQUARE STIL STEEL STIC STORAGE SPECS SPECIFICATION(S) VOWER LEEV SF SQUARE FEET SIM SIMILER SOL SOLID OT TEMP TEMPORARY TYP TYPICAL INSTALLED UON UNLESS OTHERWISE NOTED VONNER VERT VERIFICAL VO VERIFUL INSTALLED UON UNLESS OTHERWISE NOTED VONNER VERT VERIFICAL VO VENDOR DIRECT VERTICAL VIN TEMPERED TILE VO VENDOR DIRECT VENTCAL VEN	NORTH ARROW O'-O" BENCHMARK SECTION NUMBER SECTION SHEET NUMBER DETAIL NUMBER DETAIL BUBBLE SHEET NUMBER	PXXX FINISH SCHEDULE REVISION DATUM POINT AFF HEIGHT TAGS DXXX DOOR NUMBER XXXX EQUIPMENT TAG WALL TYPE TAG APPLIED WALL TREATMENT TAG CENTER LINE COLUMBIA COUNTY BUILDING CODE EXISTING (FBC) COLUMBIA COUNTY BUILDING CODE EXISTING (FBC) COLUMBIA COUNTY BUILDING DEPARTMENT 135 NE HERNANDO AVE, SUITE B-21 LAKE CITY, FL. 32055 PHONE: (386) 758-1008 ALL CORRESPODENCE COORDINATED THRO THE ABCHITECT 2010 FLORIDA FIRE PREVENTION CODE ADA(ADAAG) 2010 FBC CHAPTER 11 ACCESSIBILITY 2008 NATIONAL ELECTRICAL CODE 2010 FLORIDA PLUMBING CODE 2010 FLORIDA PLUMBING CODE 2010 FLORIDA PLUMBING CODE	Architect: Electrical Engineer: Plumbing Engineer:
	HM2 HOLLOVW METAI	L SINGLE RABBET L DOUBLE RABBET	VICINITY MAP		SITE LOCA
		SWIPOUTDETONO?	SWHoveligd SWHoweligd RyFalls	To the state of th	DONC WOM FRINGS STATUS TOTAL SEA STATUS ST

			FIRE RATING	EXITING LEGEND	GENERAL NOTES	REVISIO
	ROOM AREA RATE LOAD	FIRE NOTES	NOTES	EXIT DIRECTION OF TRAVEL	REFER TO SHEET A0.0 FOR COMPLETE CODE SUMMARY	
ILLUMINATION NOTES	OPC 2499 100 25	INTER	RIOR CORRIDORS - 1 HR.		INFORMATION.	
ANS OF EGRESS ILLUMINATION (IBC 1006)	TRAINING RIM 281 20 16	INTER	RIOR CORRIDORS - TTIK	PATH OF TRAVEL	2. EXIT DISCHARGE OCCURS AT LEVEL	
2 ILLUMINATION LEVEL. THE MEANS OF EGRESS ILLUMINATION LEVEL SHALL NOT BE LESS THAN 1 FOOT-CANDLE (11 LOX) AT	110			LIGHTED EXIT SIGN LOCATION	1. ALL EXIT ROUTES ARE ACCESSIBLE ROUTES.	
WALKING SURFACE LEVEL.			TOTAL TOTAL	LIGHTED EXIT SIGN W/ DIRECTIONAL ARROW	3. ALL ELECTRICAL BATTERY TYPE	
6.4 PERFORMANCE OF SYSTEM. EMERGENCY LIGHTING FACILITIES SHALL BE ARRANGED TO PROVIDE INITIAL ILLUMINATION OUT IS AT LEAST AN AVERAGE OF 1 FOOT-CANDLE (11 LUX) AND A MINIMUM AT ANY POINT OF 0.1 FOOT-CANDLE (1 LUX) OUT IS AT LEAST AN AVERAGE OF 1 FOOT-CANDLE (11 LUX) AND A MINIMUM AT ANY POINT OF THE PROPERTY OF THE PROPERTY.	LS4 OCCUPANCY LOAD CALCULATIONS REF:		WALL LEGEND	1907-1077 (494-007-00-007-00-00-00-00-00-00-00-00-00-0	EXIT SIGNS AND EMERGENCY LIGHTING TYPE FIXTURES SHALL BE	
CLIDED ALONG THE PATH OF EGRESS AT LOOK LEVEL TO CALLY AT THE END OF THE EMERGENCE	CONTRACTIOR SHALL PROVIDE A COMPLETE PROFESSION OF THE PROFESSION	JNAL ENGINEER AS NEEDED ! S.	1 HOUR FIRE-RATED WALL	F AUDIBLE / VISUAL FIRE ALARM	CONNECTED TO CONSTANT NORMAL ROOM LIGHTING BRANCH CIRCUIT OF AREA SERVED (i.e.,	
OT-CANDLE (6 LUX) AVERAGE AND A MINIMUM AT ANY POINT OF 0.06 FOOT-CANDLE (0.6 LOX) AT THE END OF THE EXCEEDED. HTING TIME DURATION. A MAXIMUM-TO-MINIMUM ILLUMINATION UNIFORMITY RATIO OF 40 TO 1 SHALL NOT BE EXCEEDED.	AND OPERABLE FIRE ALARM SYSTEM AS REQUIRED BY THE LOCAL AUTHORITY LOCAL AUTHORITY	THORITIES HAVING JURISDICTION.	2 HOUR FIRE-RATED WALL	EMERGENCY LIGHTS	CIRCUIT OF AREA SERVED (i.e., LOAD SIDE OF BREAKER, LINE SIDE OF ANY SWITCHING/CONTROLLING DEVICES) IN ACCORDANCE WITH	
	HAVING ILIRISDICTION COMPLETE FIRE	NOTE:	ICRETE STRUCTURAL BEARING	FIRE EXTINGUISHER CABINET	DEVICES) IN ACCORDANCE WITH NEC 700-12.	
T SIGNS (IBIC 1011) 1.2 ILLUMINIATION. EXIT SIGNS SHALL BE INTERNALLY OR EXTERNALLY ILLUMINATED.	ALARM SYSTEM SHALL BE INSTALLED IN ACCORDANCE WITH THE LATEST	ELEMI	MENTS TO BE 3 HR FIRE RATED MPLIANT PER TBL. 60Z.		4. FIRE EXTINGUISHER FEC, TYPE	
1.5.2 EXIT SIGN ILLUMINATION. THE FACE OF AN EXIT SIGN ILLUMINATED FROM AN EXTERNAL SOURCE SHALL HAVE AN	GOVERNING EDITIONS OF NFPA 72 AND 101 AND THE FLORIDA BUILDING CODE.	00.00			4. FIRE EXTINGUISHER TEO, THE '2A-10 B:C' SEMI-RECESSED CABINET, MOUNT TOP OF CABINET @ 60" A F.F. L. OCATE @ MAX.	
-NOITY OF NOT LESS THAN 5 FOUT-CANDLES (04 EOX).	A STOR CHALL INCLUDE IN HIS BID				@ 60" A.F.F. LOCATE @ MAX. SPACING, NOT TO EXCEED 75'.	
1.5.3 POWER SOURCE. EXIT SIGNS SHALL BE ILLUMINATED AT ALL TIMES. TO ENSURE ILLUMINATION FOR A DURATION OF NO SS THAN 90 MINUTES IN CASE OF PRIMARY POWER LOSS, THE SIGN ILUMINATION MEANS SHALL BE CONNECTED TO AN SS THAN 90 MINUTES IN CASE OF PRIMARY POWER LOSS, THE SIGN ILUMINATION MEANS SHALL BE CONNECTED TO AN	COMPLETE INSTALLATION DRAWINGS					
SS THAN 90 MINUTES IN CASE OF PRIMARY POWER LOSS, THE SIGN ILUMINATION MEANS STALL BE OF SENERATOR. JERGENCY POWER SYSTEM PROVIDED FROM STORAGE BATTERIES, UNIT EQUIPMENT OR AN ON-SITE GENERATOR.	SIGNED AND SEALED BY A REGISTERED			CONTROLS LEGEND	LS3 NOTES	
		LS1	FIRE RATING WALL LEGEND	LS2 SYMBOLS LEGEND	REF:	

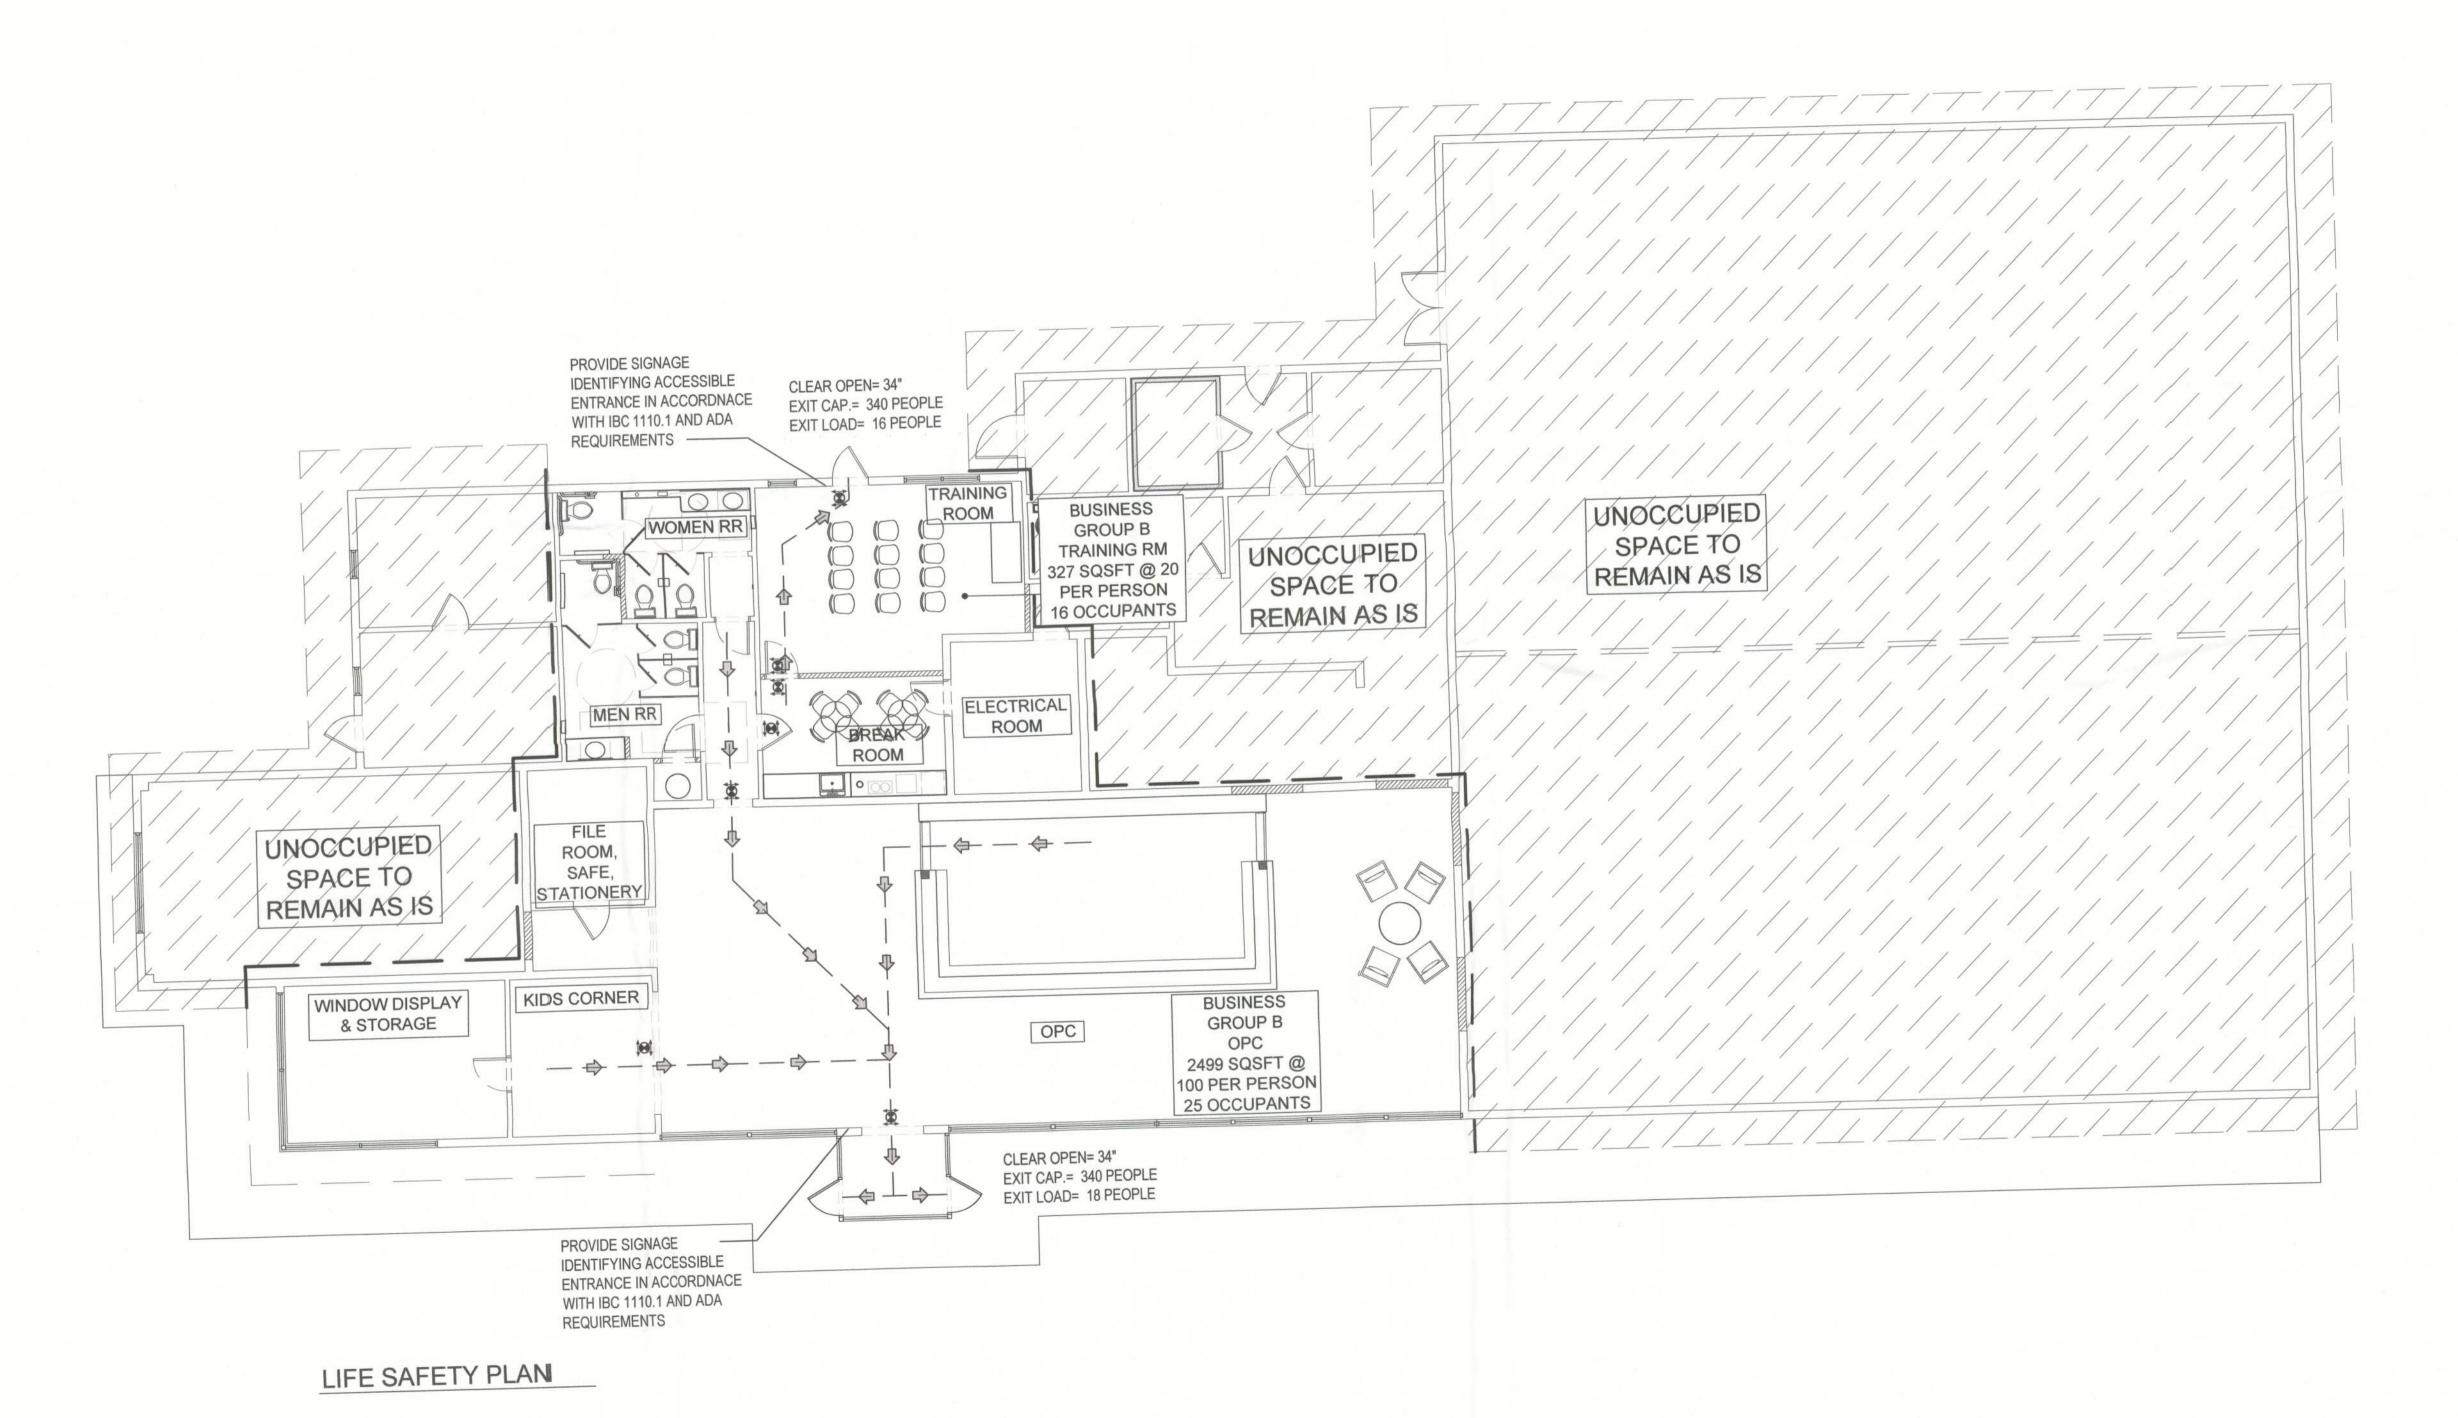

PROJECT OWNER:



5601 Windhover Drive Orlando, Florida 32819

PROJECT:

WESTGATE **RESORTS** LAKE CITY (OPC) 131 SW WEBBS GLEN LAKE CITY, FL. 32024

Alma Smailbegovic

FL.REG. #AR94885

407.351.3350 (X. 322)

5601 WINDHOVER DRIVE ORLANDO, FLORIDA. 32819




DATE: 12.11.2013

SCALE: 1/8" = 1'-0"

SHEET TITLE LIFE SAFETY PLAN


SHEET NUMBER

LS1.0

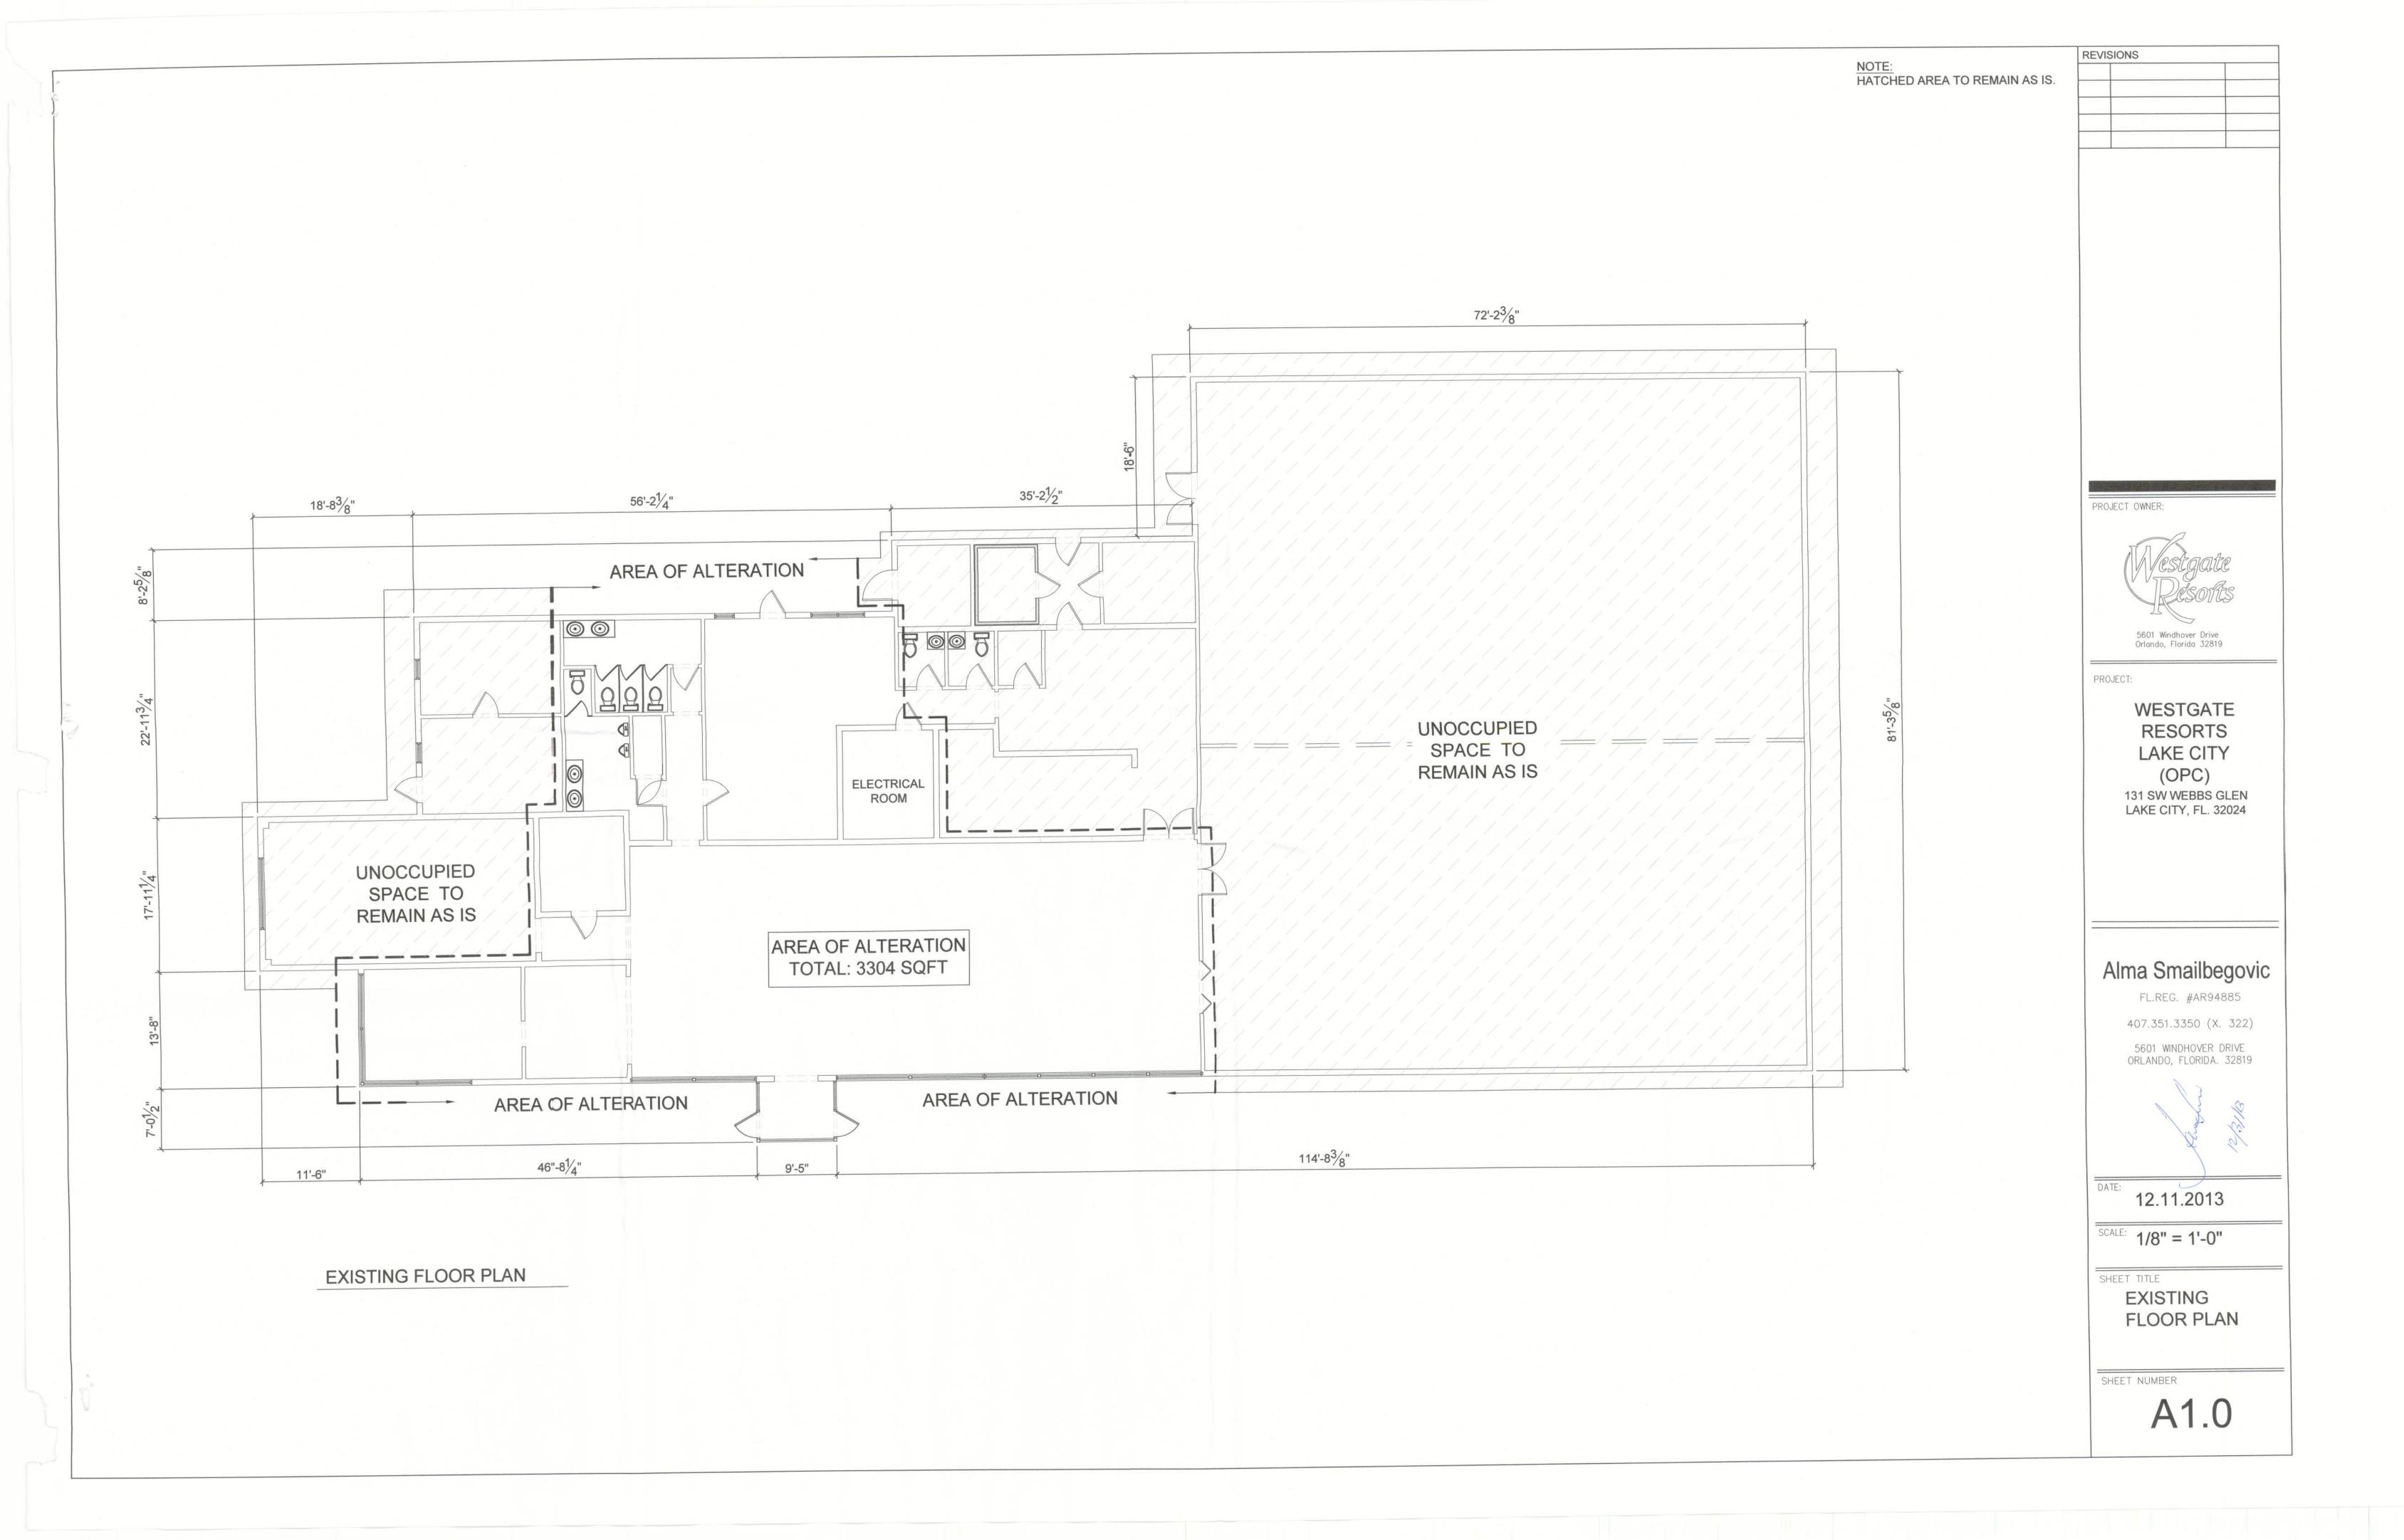

ALTA/ACSM LAND TITLE SURVEY

IN SECTION 3
TOWNSHIP 6 SOUTH, RANGE 17 EAST
COLUMBIA COUNTY, FLORIDA

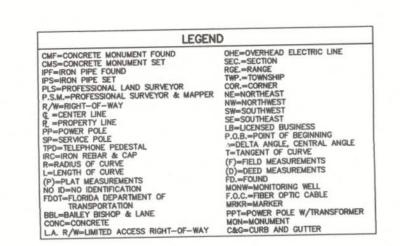

TOWNSHIP 6 SOUTH — RANGE 17 EAST
SECTION 3: COMMENCE at the Southwest corner of the NE 1/4, Section 3, Township 6 South, Range 17 East, Columbia County, Florida and run SECTION 3: COMMENCE at the South line of said NE 1/4, 1162.43 feet to the West Right—of—Way line of State Road No. 25; thence N 00°53′26″ thence N 87°25′54″ E along the South line of said NE 1/4, 1162.43 feet to the West Right—of—Way line, 102.50 feet to the POINT OF W along said West Right—of—Way line, 373.51 feet; thence N 06°24′06″ W along said West Right—of—Way line, 102.50 feet to the POINT OF BEGINNING; thence North 86°18′58″ West a distance of 40.48 feet; thence South 84°02′49″ West a distance of 35.86 feet; thence South 76°29′31″ BEGINNING; thence North 86°18′58″ West a distance of 108.91 feet; thence South 87°17′19″ West a distance of 376.35 feet; West a distance of 120.78 feet; thence South 86°24′48″ West a distance of 237.93 feet to a point on the Southwesterly thence North 00°20′21″ East a distance of 747.80 feet; thence North 89°56′48″ East a distance of 237.93 feet to a point on the Southwesterly Right—of—Way line of State Road 93 (Interstate 75); thence South 47°51′00″ East along said Southwesterly Right—of—Way line of State Road 93 (Interstate 75) and the beginning of the Westerly Right—of—Way line of State Road 25 (U.S. Highway 41); thence South 06°19′43″ East along said Westerly Right—of—Way line of State Road 25 (U.S. Highway 41) a distance of 60.69 feet to the POINT OF BEGINNING.


AND ALSO COMMENCE at the Southwest corner of the NE 1/4, Section 3, Township 6 South, Range 17 East, Columbia County, Florida and run thence N 87°25'54" E along the South line of said NE 1/4, 1162.43 feet to the West Right—of—Way line of State Road No. 25; thence N 00°53'26" thence N 8/725.54 E along the South line of said NE 1/4, 1162.45 feet to the West Right-of-Way line of State Road No. 25; thence N 00.55.26 W along said West Right-of-Way line, 163.19 feet; thence N 06.14.3 W still was along said West Right-of-Way line, 163.19 feet; thence N 06.14.3 W still was along said West Right-of-Way line, 87.63 feet to the beginning of the Limited Access Right-of-Way line of State Road 93 (I-75) and the point of curve of a curve concave to the West having a radius of 437.59 feet and a central angle of 44.13.17; thence Northwesterly along the arc of said curve, being also the Southwesterly Right-of-Way line of State Road 93 (Interstate 75), a distance of 337.74 feet to the end of said curve; thence curve, being also the Southwesterly Right-of-Way line of State Road 93 (Interstate 75), a distance of 372.50 feet to the POINT OF North 47'51'00" West along said Southwesterly Right-of-Way line of State Road 93 (Interstate 75), a distance of 372.50 feet to the POINT OF BEGINNING; thence South 89'56'48" West a distance of 14.99 feet; thence North 47'51'00" West along a line 10 feet Southwesterly of and parallel to the Southwesterly Right-of-Way line of State Road 93 (Interstate 75) a distance of 631.47 feet to a point on a curve concave to the Northeast having a radius of 3024.79 feet and a central angle of 02"20"37"; thence Northwesterly along the arc of said curve and still along said parallel line a distance of 123.73 feet to the end of said curve; thence S 59"18"37" W, 135.13; thence N 30"41"23" W, 10.00 feet; thence N 59"18"37" E, 141.79 feet to a point on the Southwesterly Right-of-Way line of State Road 93 (Interstate 75), said point also being a point on a curve concaver to the Northeast having a radius of 3014.79 feet and a central angle of 02°28'59"; thence Southeasterly along the arc of said curve, being also said Southwesterly Right-of-Way line of State Road 93 (1-75), a distance of 130.66 feet to the end of said curve; thence S 47°51'00" E still allong said Southwesterly Right-of-Way line of State Road 93 (Interstate 75) a distance of 643.26 feet to the POINT OF BEGINNING.

ALTOGETHER Containing 9.31 acres, more or less.

IRON ROD & CAP SET - LB7042 FIELD DATA R=3014.79' L=130.66' A=2'28'59"				
H 58 18 51 (F) IRON REBAR &	CAP FD.			FIRST AMERI EFFECTIVE
ELECTRONIC BILLBOARD L=123.73 L=123.73 L=220.37"			ITEM#	RECORDING DATA
CONC. SLAB IRON ROD & CAP SET - LB7042	G ADAD		7-K	O.R.B. 261, PG. 271
CONC. SLAB IRON ROD & CAP SET - LB7042	TO A OAD ACCESS FIRST RATE TO STATE TO		7-L	O.R.B. 812, PG. 84
PARCEL B	No HIGHERST		7-M	O.R.B. 739, PG. 296
0.21 ACRES	14 1 1 1 1 1 1 1 1 1 1 1 1 1 1 1 1 1 1		7-N	O.R.B. 723, PG. 175
	Recording to the state of the s		7-0	O.R.B. 741, PG. 1665
	13th Marie M		7-P	O.R.B. 733, PG. 345
	No. of the last of		7-Q	O.R.B. 824, PG. 4
	CMF 14.99	O.B. PARCEL B IC., MON. FD. ., LB6685	7-R	O.R.B. 808, PG. 1218
105	CMF BRITT N 89'56'48" E FENCE	CONC. MON. FD. BBL, LB6685	7-S	O.R.B. 1234, PG. 132
O SO 100	DARCEL A 9.10 ACRES PAGE 1218 PAGE 1218 PAGE 1218 PAGE 1218 PAGE 1218 O.R.B. 739, P.O. N.B. 808, P.O. N.B. 739, P.O. N.B. 739, P.O. N.B. 808, P.O. N.B. 739, P.O. N.B. 808, P.O. N.B. 739, P.O. N.B. 739, P.O. N.B. 808, P.O. N.B. 739, P.O. N.B. 808, P.O. N.B. 739, P.O. N.	IRON REBAR & FDOT CONC. MON. W.C. HALE, O.2'E, O.4'S ASEMENT AGE 296 AGE	PLS S FIELD DATA R=437.59' L=244.78' Δ=32'02'55' CONC. MC W.C. HALE REIN CONC. MA Solution (0) Solution	9" ON. FOUND E, PLS LD DATA 437.59' 92.96' 12'10'18" ION. FOUND LE, PLS IN L.A. R/W 1-75

ERICAN TITLE CO. #1062-3077431 VE DATE: DECEMBER 02, 2013 COMMENTS DESCRIPTION Affects parcels described. Ingress/Egress Easement Plotted on survey. Affects parcels described. Ingress/Egress Easement Affects parcels described. Ingress/Egress Easement Plotted on survey. Affects parcels described. Utility Easement to AT&T Affects parcels described. Utility Easement to Clay Plotted on survey. Affects parcels described. Utility Easement to Clay Plotted on survey. Affects parcels desicribed. Ingress/Egress Easement Plotted on survey. and Water Retention 18 Ingress/Egress Easement Affects parcels described. Affects parcels described. Water/Sewer Easement Plotted on survey.

- 1.) Monumentation is as shown and designated on the face of the plat.
- 2.) Boundary based on instruction from client, monumentation found in place, description furnished by client, Florida Department of Transportation Right-of-Way maps, prior surveys by Bailey, Bishop & Lane; W.C. Hale & Associates, and this Company.
- 3.) Bearings projected from Westerly Right-of-Way line of Interstate 75 and based on above referenced Florida Department of Transportation Right-of-Way
- 4.) Interior improvements were located by field ties.
- 5.) Underground encroachments, if present, were not located with this survey.
- 6.) This survey was made without benefit of a title search. There may be additional easements, restrictions, etc. not shown hereon but found in the Public Records. Issues regarding title, land use & zoning, easements & other encumberances are not a part of the scope of a Boundary Survey and can only be revealed with a title search.
- 7.) Date of field survey completion: November 22, 2013.
- 8.) Examination of the Flood Insurance Rate Maps (FIRM) for Columbia County shows that, per said maps, the described parcel lies within Flood Zone "X", which according to said maps is outside of the 0.2% chance floodplain (ref: Map No. 12023C0505C).

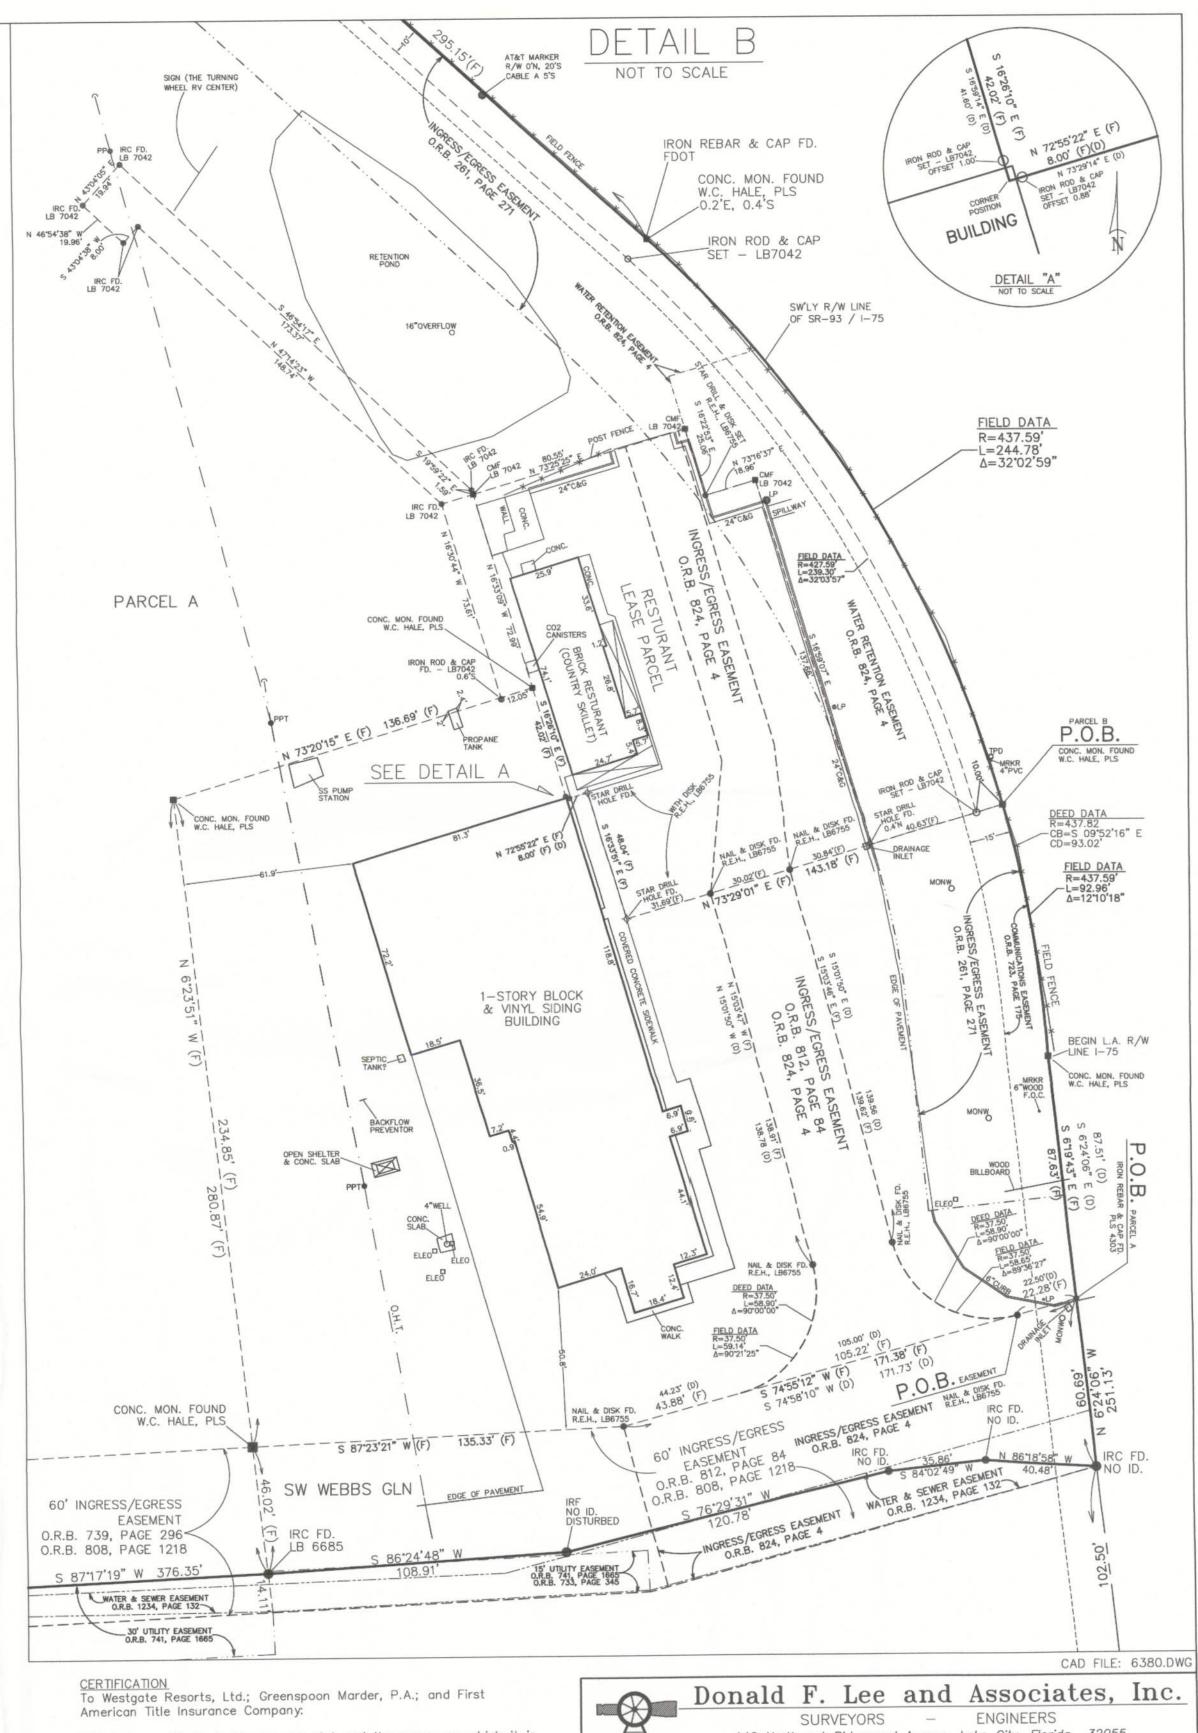

This is to certify that this map or plat and the survey on which it is based were made in accordance with the 2011 Minimum Standard Detail Requirements for ALTA/ACSM Land Title Surveys, jointly established and adopted by ALTA and NSPS, and includes Items 1, 3, 4, 7a, 8, 11a and 14 of Table A thereof. The field work was completed on Novermber 22, 2013.

NOT VALID WITHOUT THE SIGNATURE AND ORIGINAL RAISED SEAL OF A FLORIDA REGISTERED PROFESSIONAL SURVEYOR AND MAPPER

Timothy A. Delbene, P.L.S. Florida Reg. No. 5594 DATE: ___/2013

140 Northwest Ridgewood Avenue, Lake City, Florida 32055 Phone: (386) 755-6166 FAX: (386) 755-6167 Certificate of Authorization # LB 7042

Date: 12/11/2013 Drafting: A V G Computations: A V G Checked: T A D

RESORTS

Scale: 1"=100' Field Book: 13-607 Work Order: 13-6380 File: B-31-25

PROJECT OWNER: 5601 Windhover Drive Orlando, Florida 32819

PROJECT:

REVISIONS

WESTGATE **RESORTS** LAKE CITY (OPC) 131 SW WEBBS GLEN


LAKE CITY, FL. 32024


DATE: 12.18.2013


SCALE: N.T.S.

SHEET TITLE SITE PLAN

SHEET NUMBER

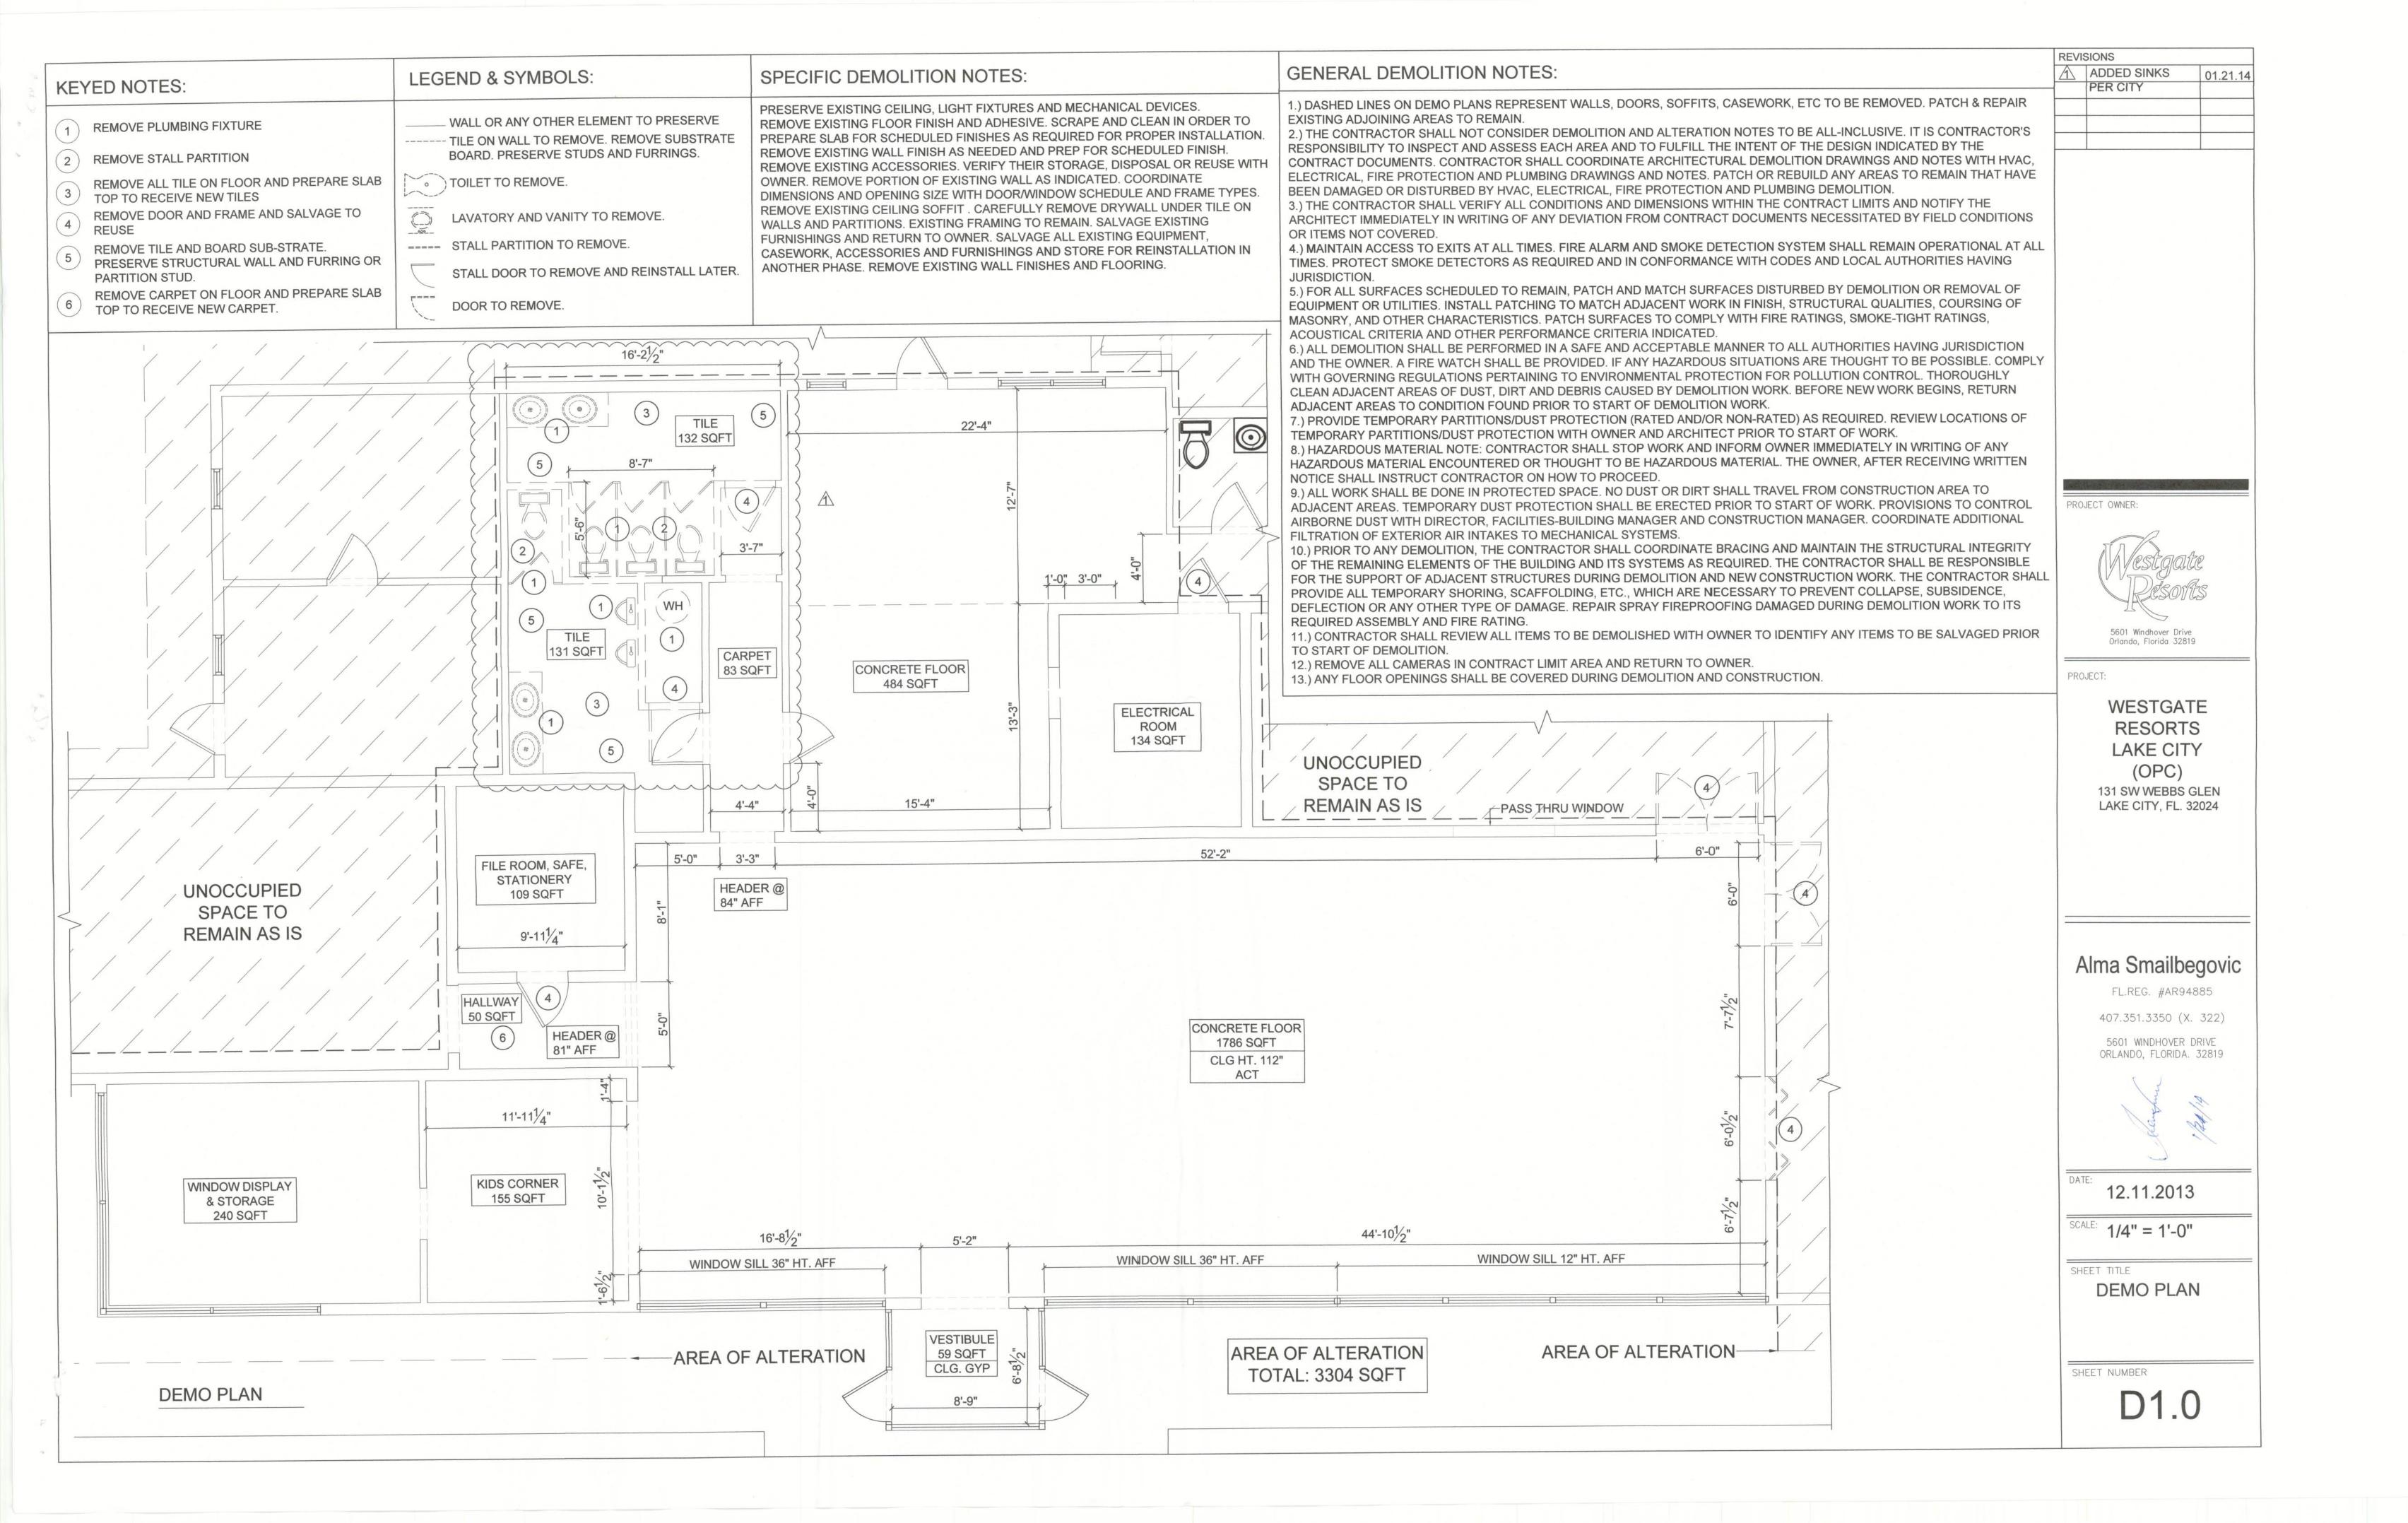

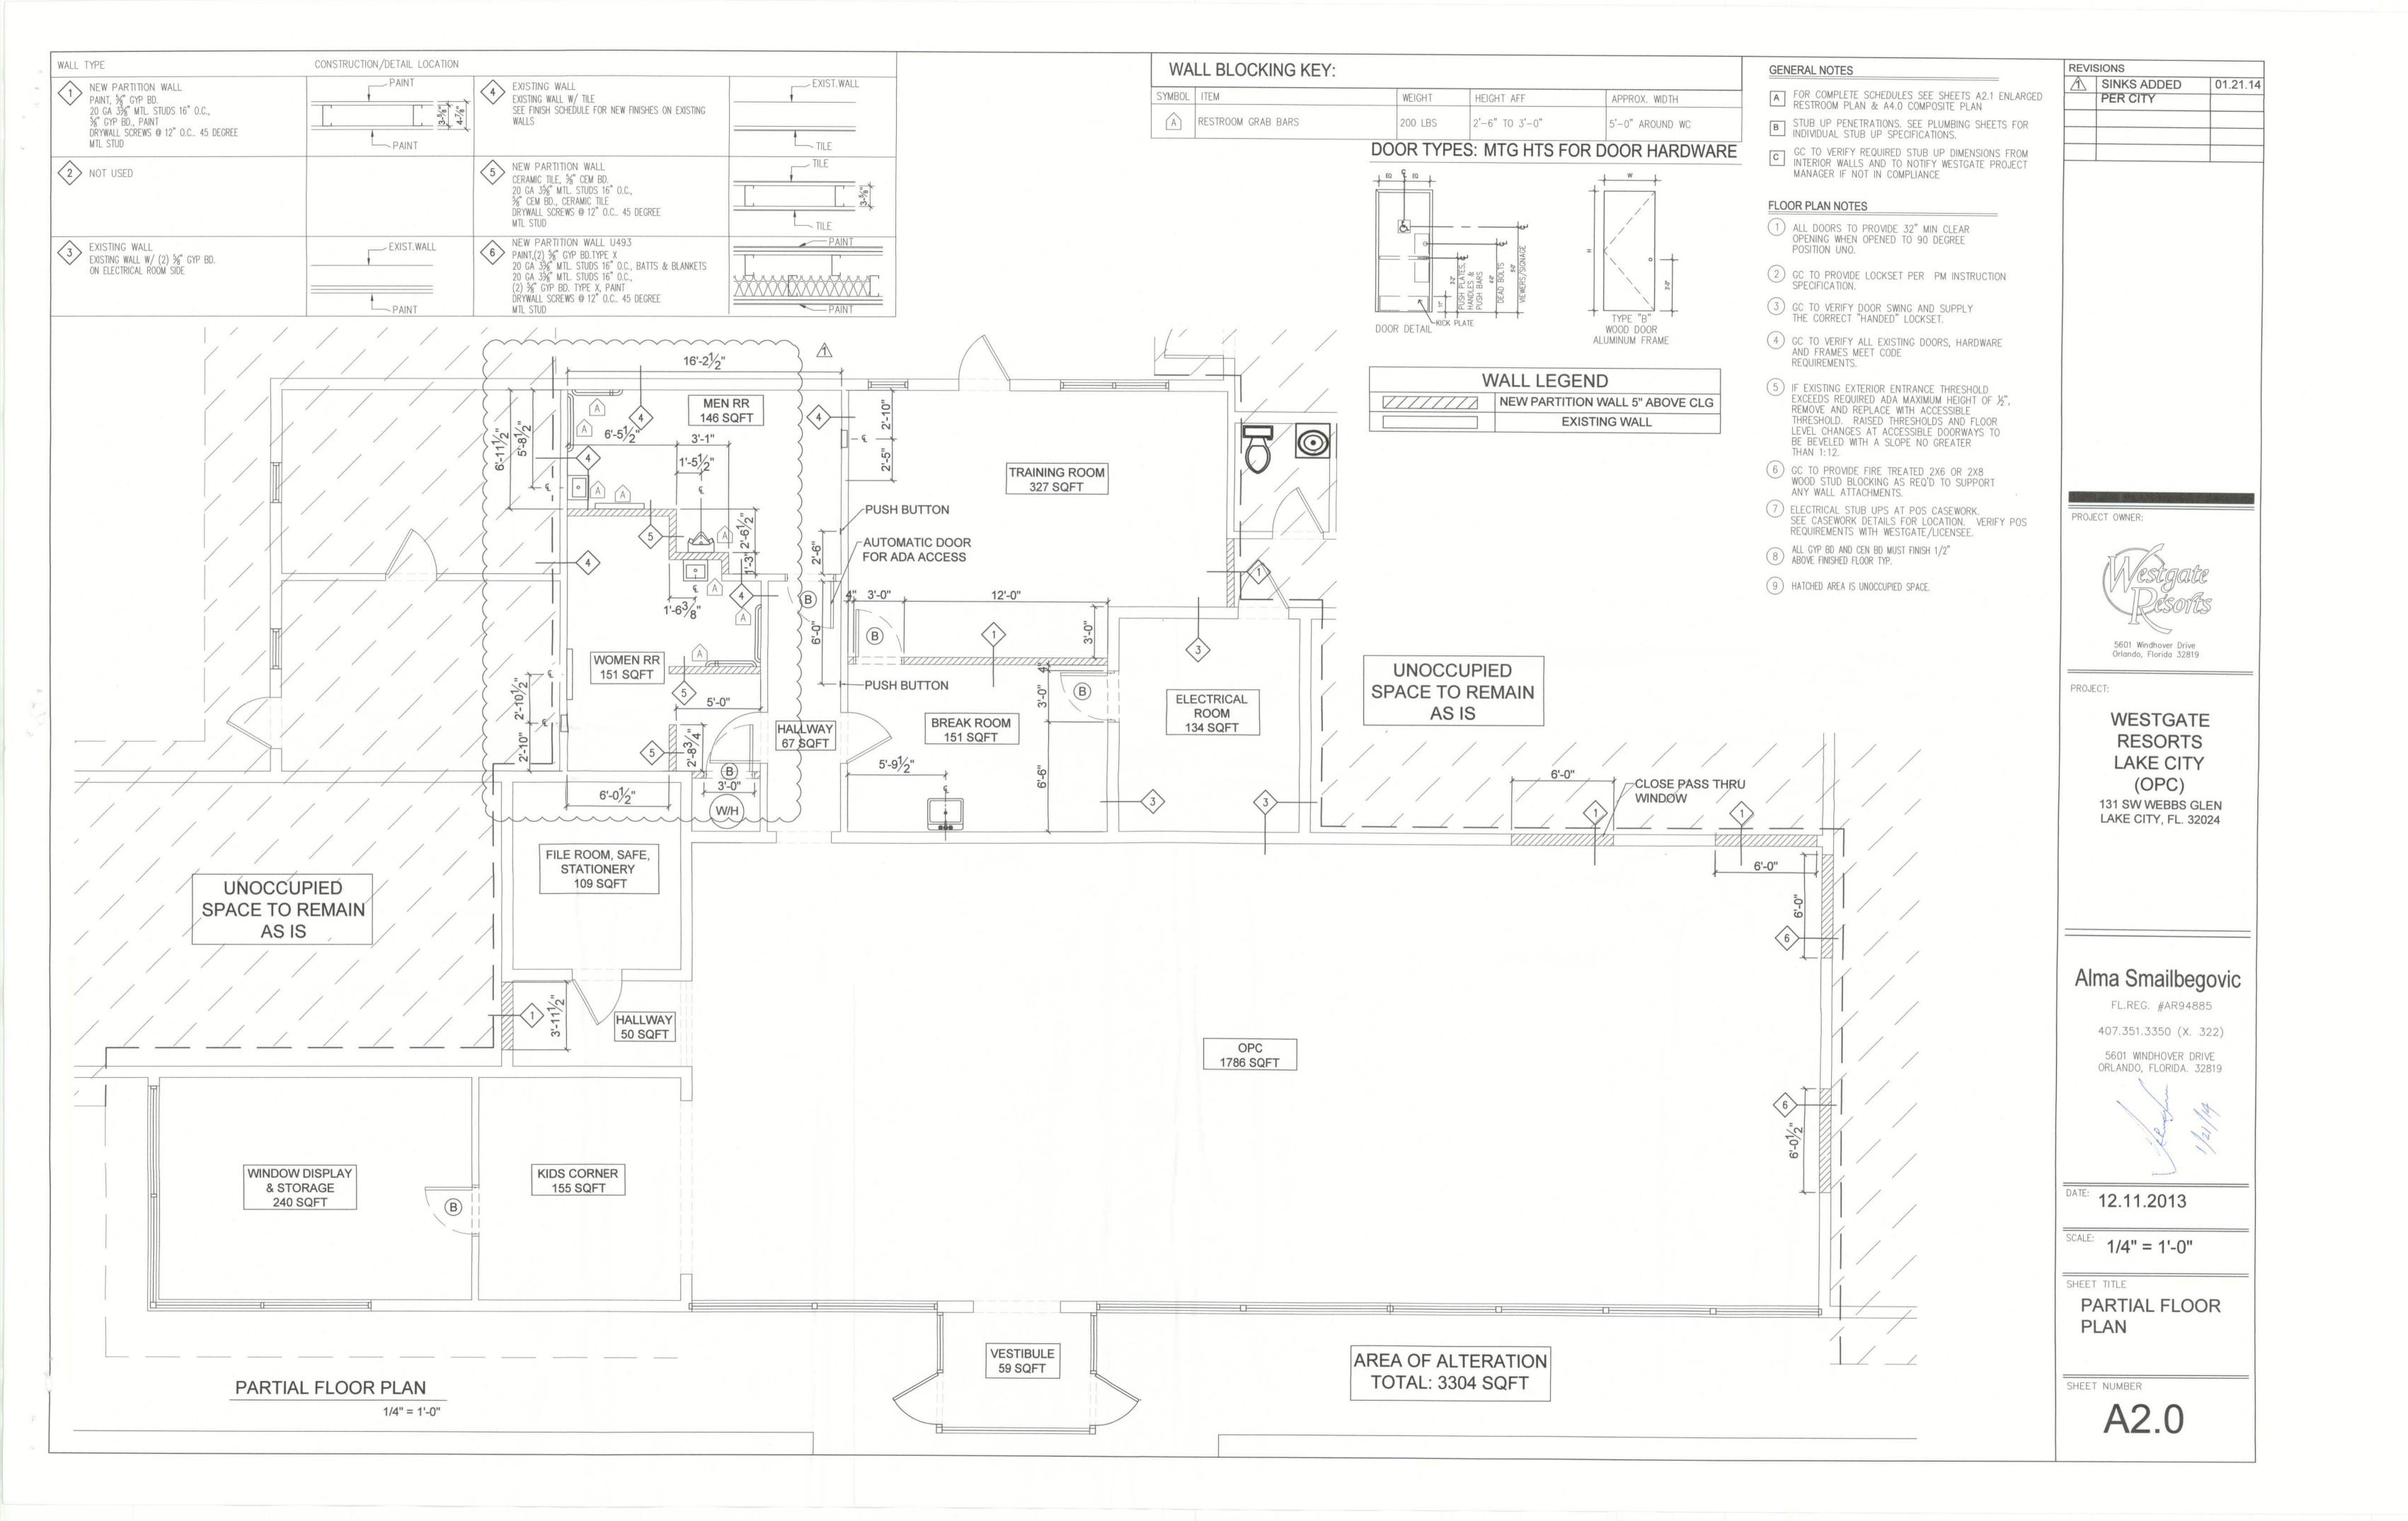

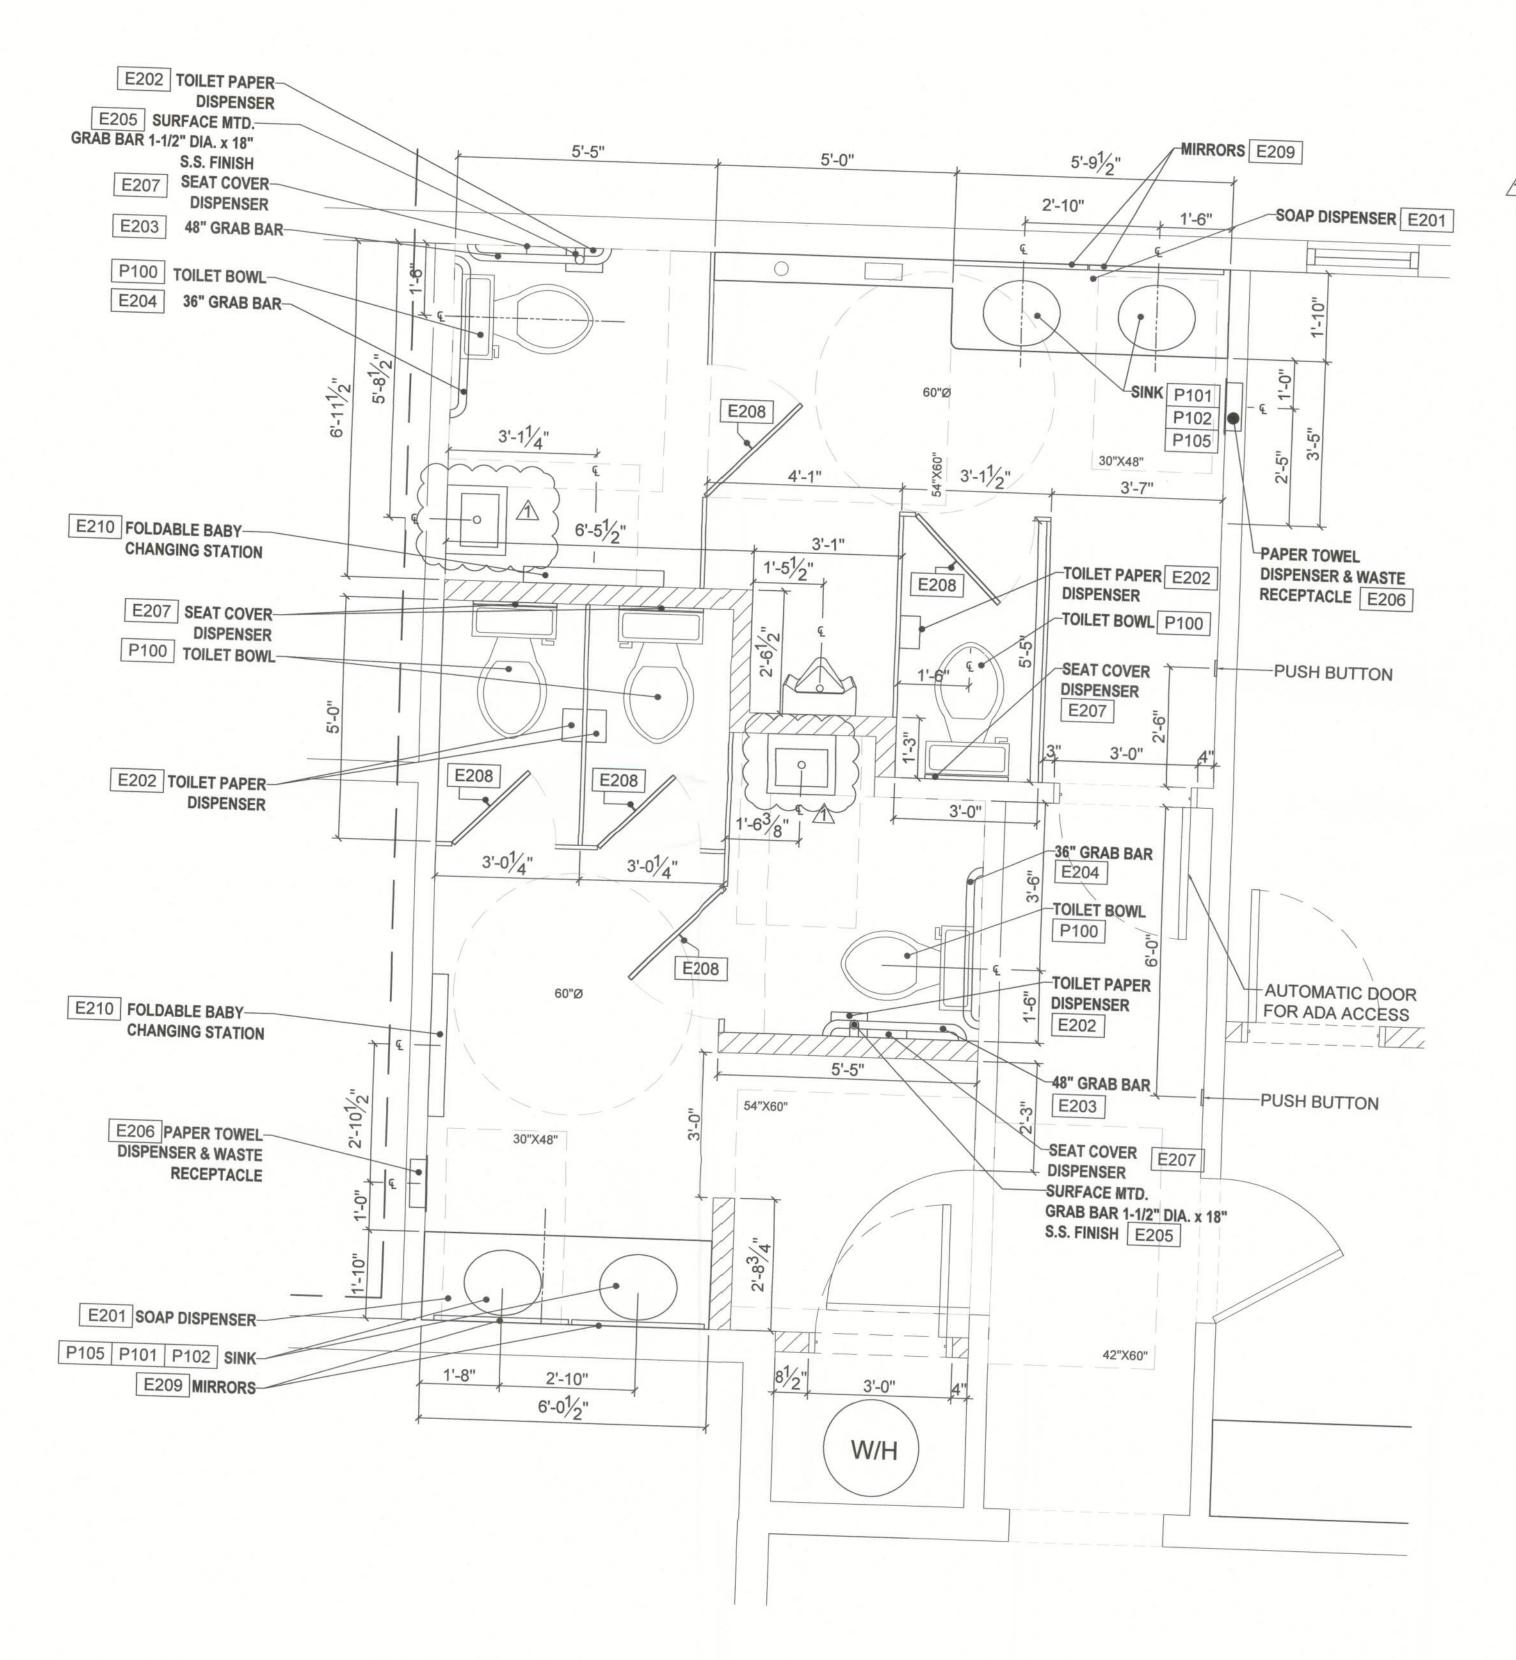

ENLARGED RESTROOM PLAN


1/2" = 1'-0"


PLUMBING SCHEDULE:


ITEM#	QTY	DESCRIPTION	MANUFACT
P100	5	TOILET BOWL -	KOHLER
P101	4	SINK - STD FOR RESTROOM	KOHLER
P102	4	FAUCET HANDSINK	AMERICAN S
P103	1	SINK BREAK ROOM	ELKAY NEPT
P104	1	FAUCET BREAK ROOM	DELTA
P105	4	PIPE INSULATION RESTROOM SINKS	
P106	1	URINAL	
P107	2	ADA RESTROOM HANDSINK	


RESTROOMS SCHEDULE:


ITEM#	QTY	DESCRIPTION	MANUFACTU
E201	2	SOAP DISPENSER WALL MOUNTED	
E202	5	TOILET PAPER DISPENSER	BRADLEY
E203	2	GRAB BAR 1-1/4" X 48IN	LOCKNET LLC
E204	2	GRAB BAR 1-1/4" X 36"	LOCKNET LLC
E205	2	GRAB BAR 1-1/4" X 18"	LOCKNET LLC
E206	2	PAPER TOWEL & WASTE RECEPTACLE	BRADLEY
E207	5	SEAT COVER DISPENSER	LOCKNET LLC
E208	5	COAT HOOK SATIN NICKEL FINISH	AMARI
E209	4	RESTROOM MIRROR	
E210	2	BABY CHANGING STATION	KOALA KARE

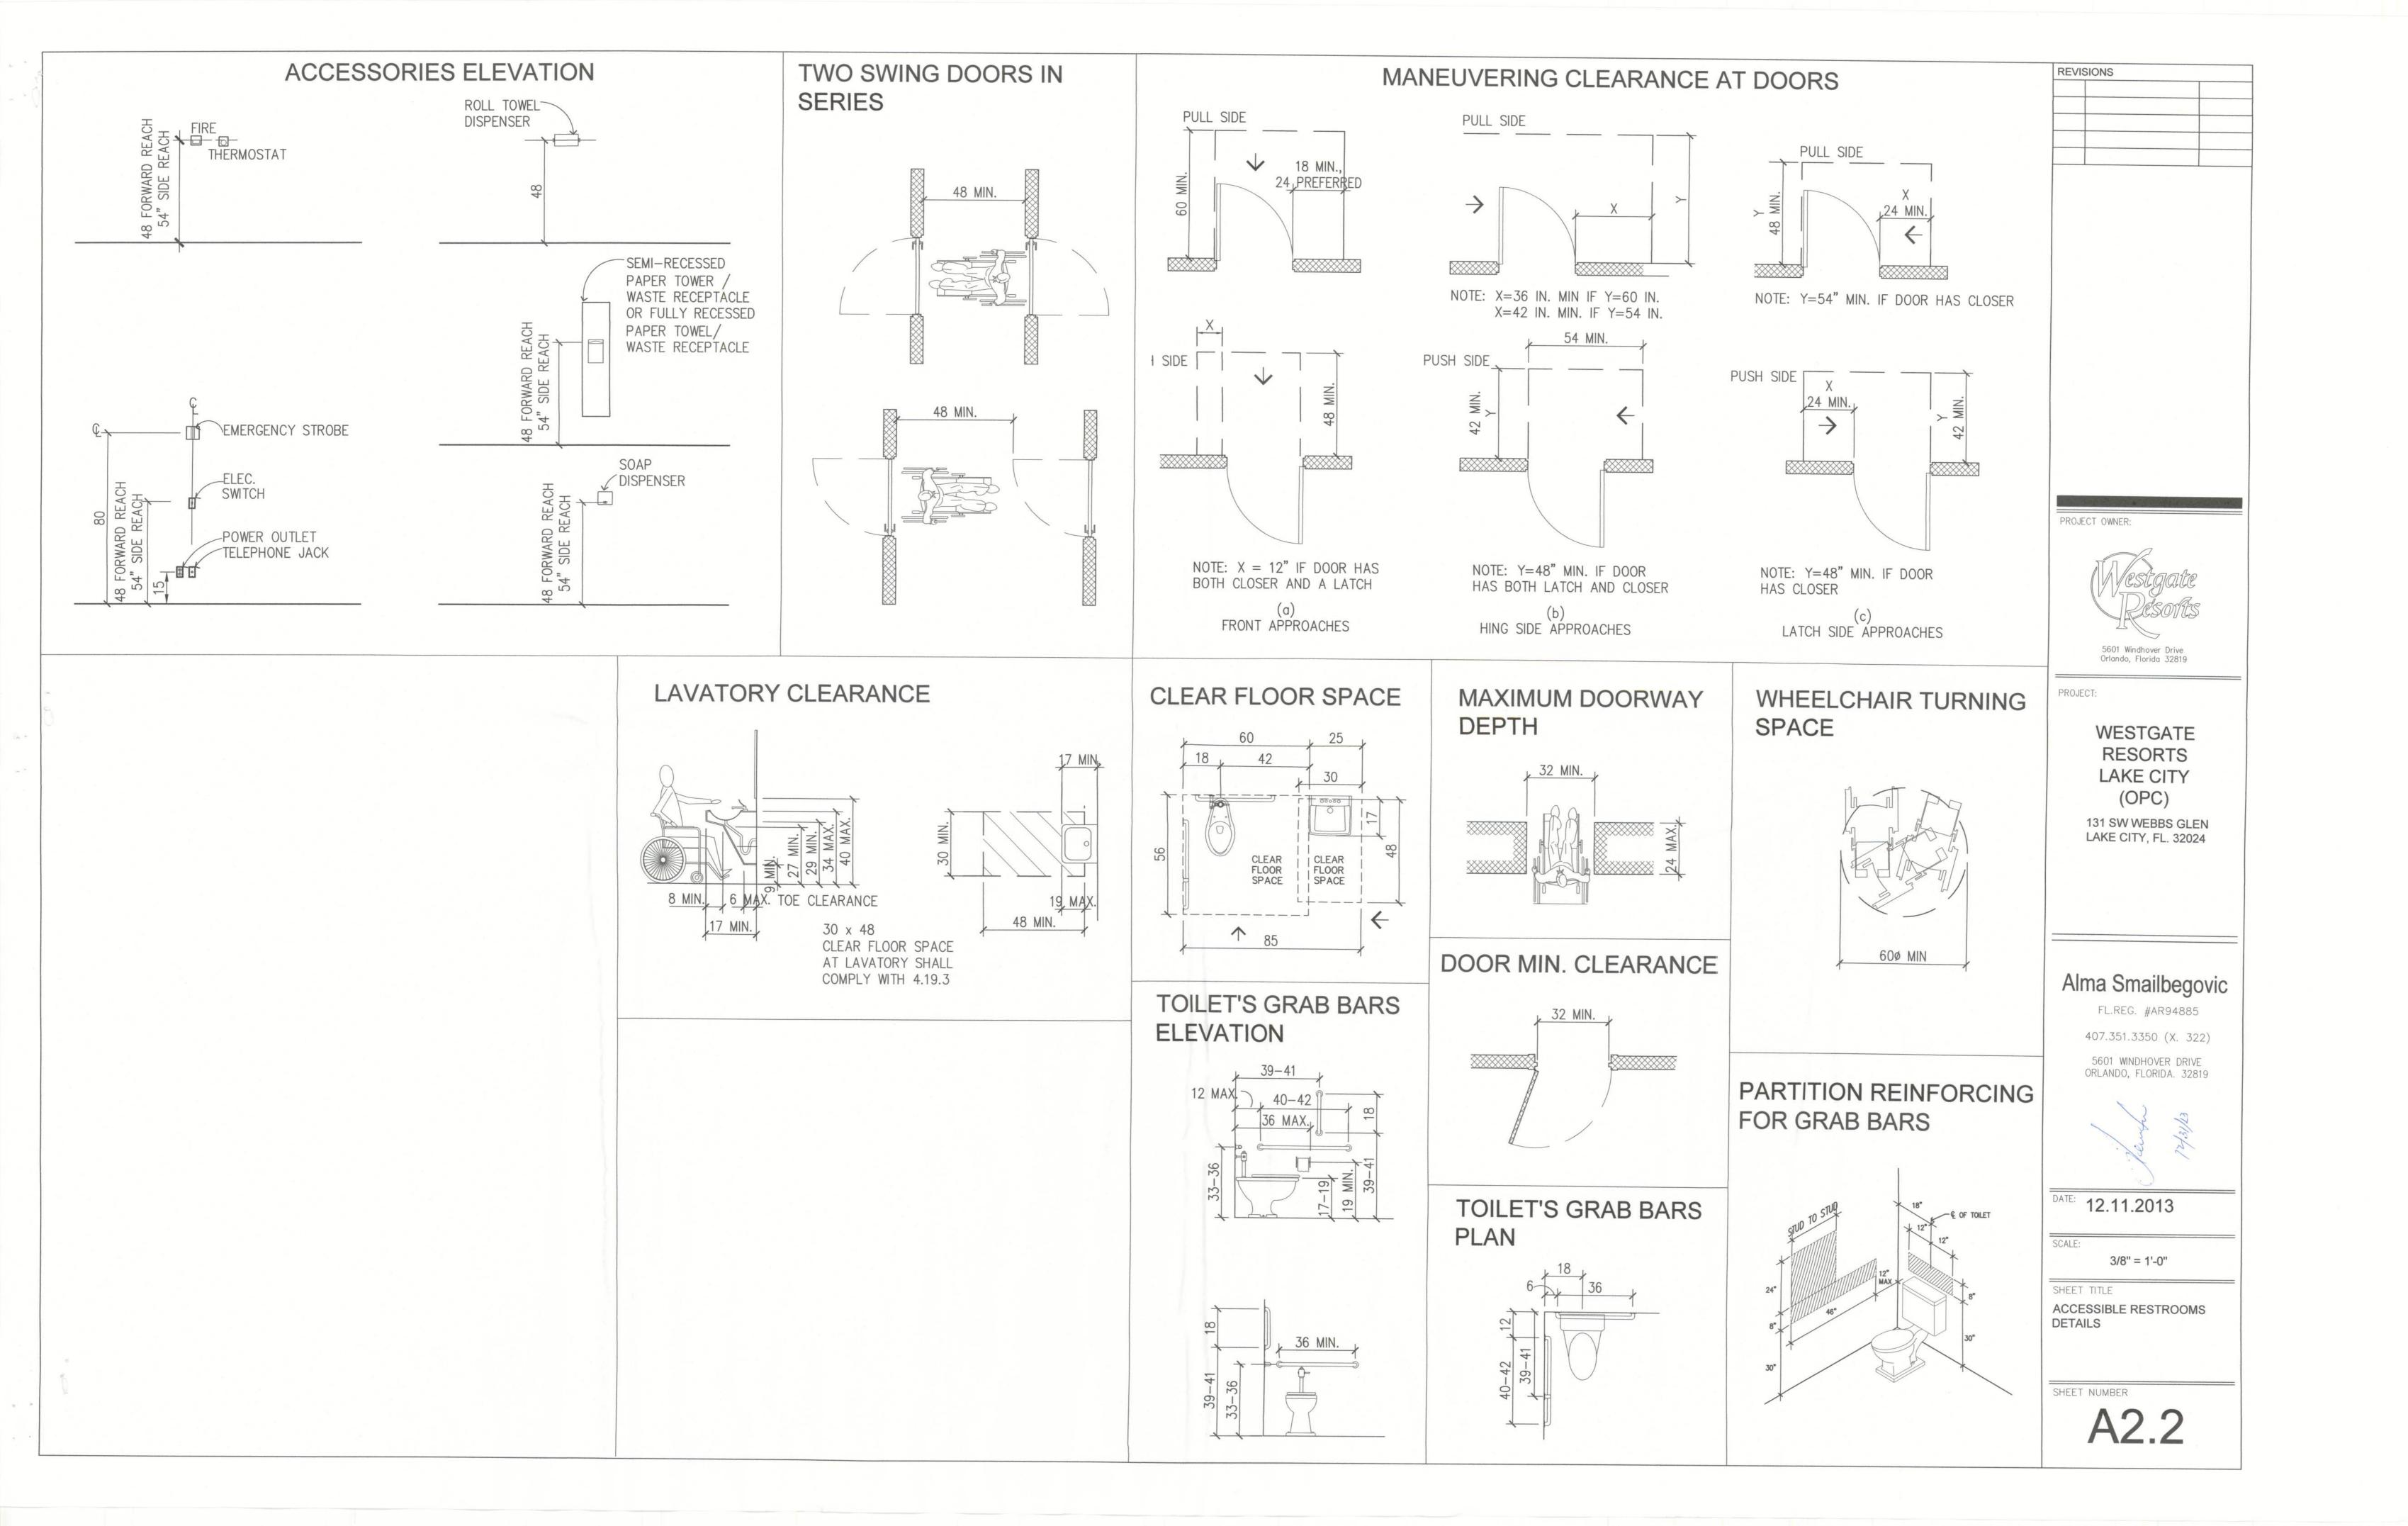


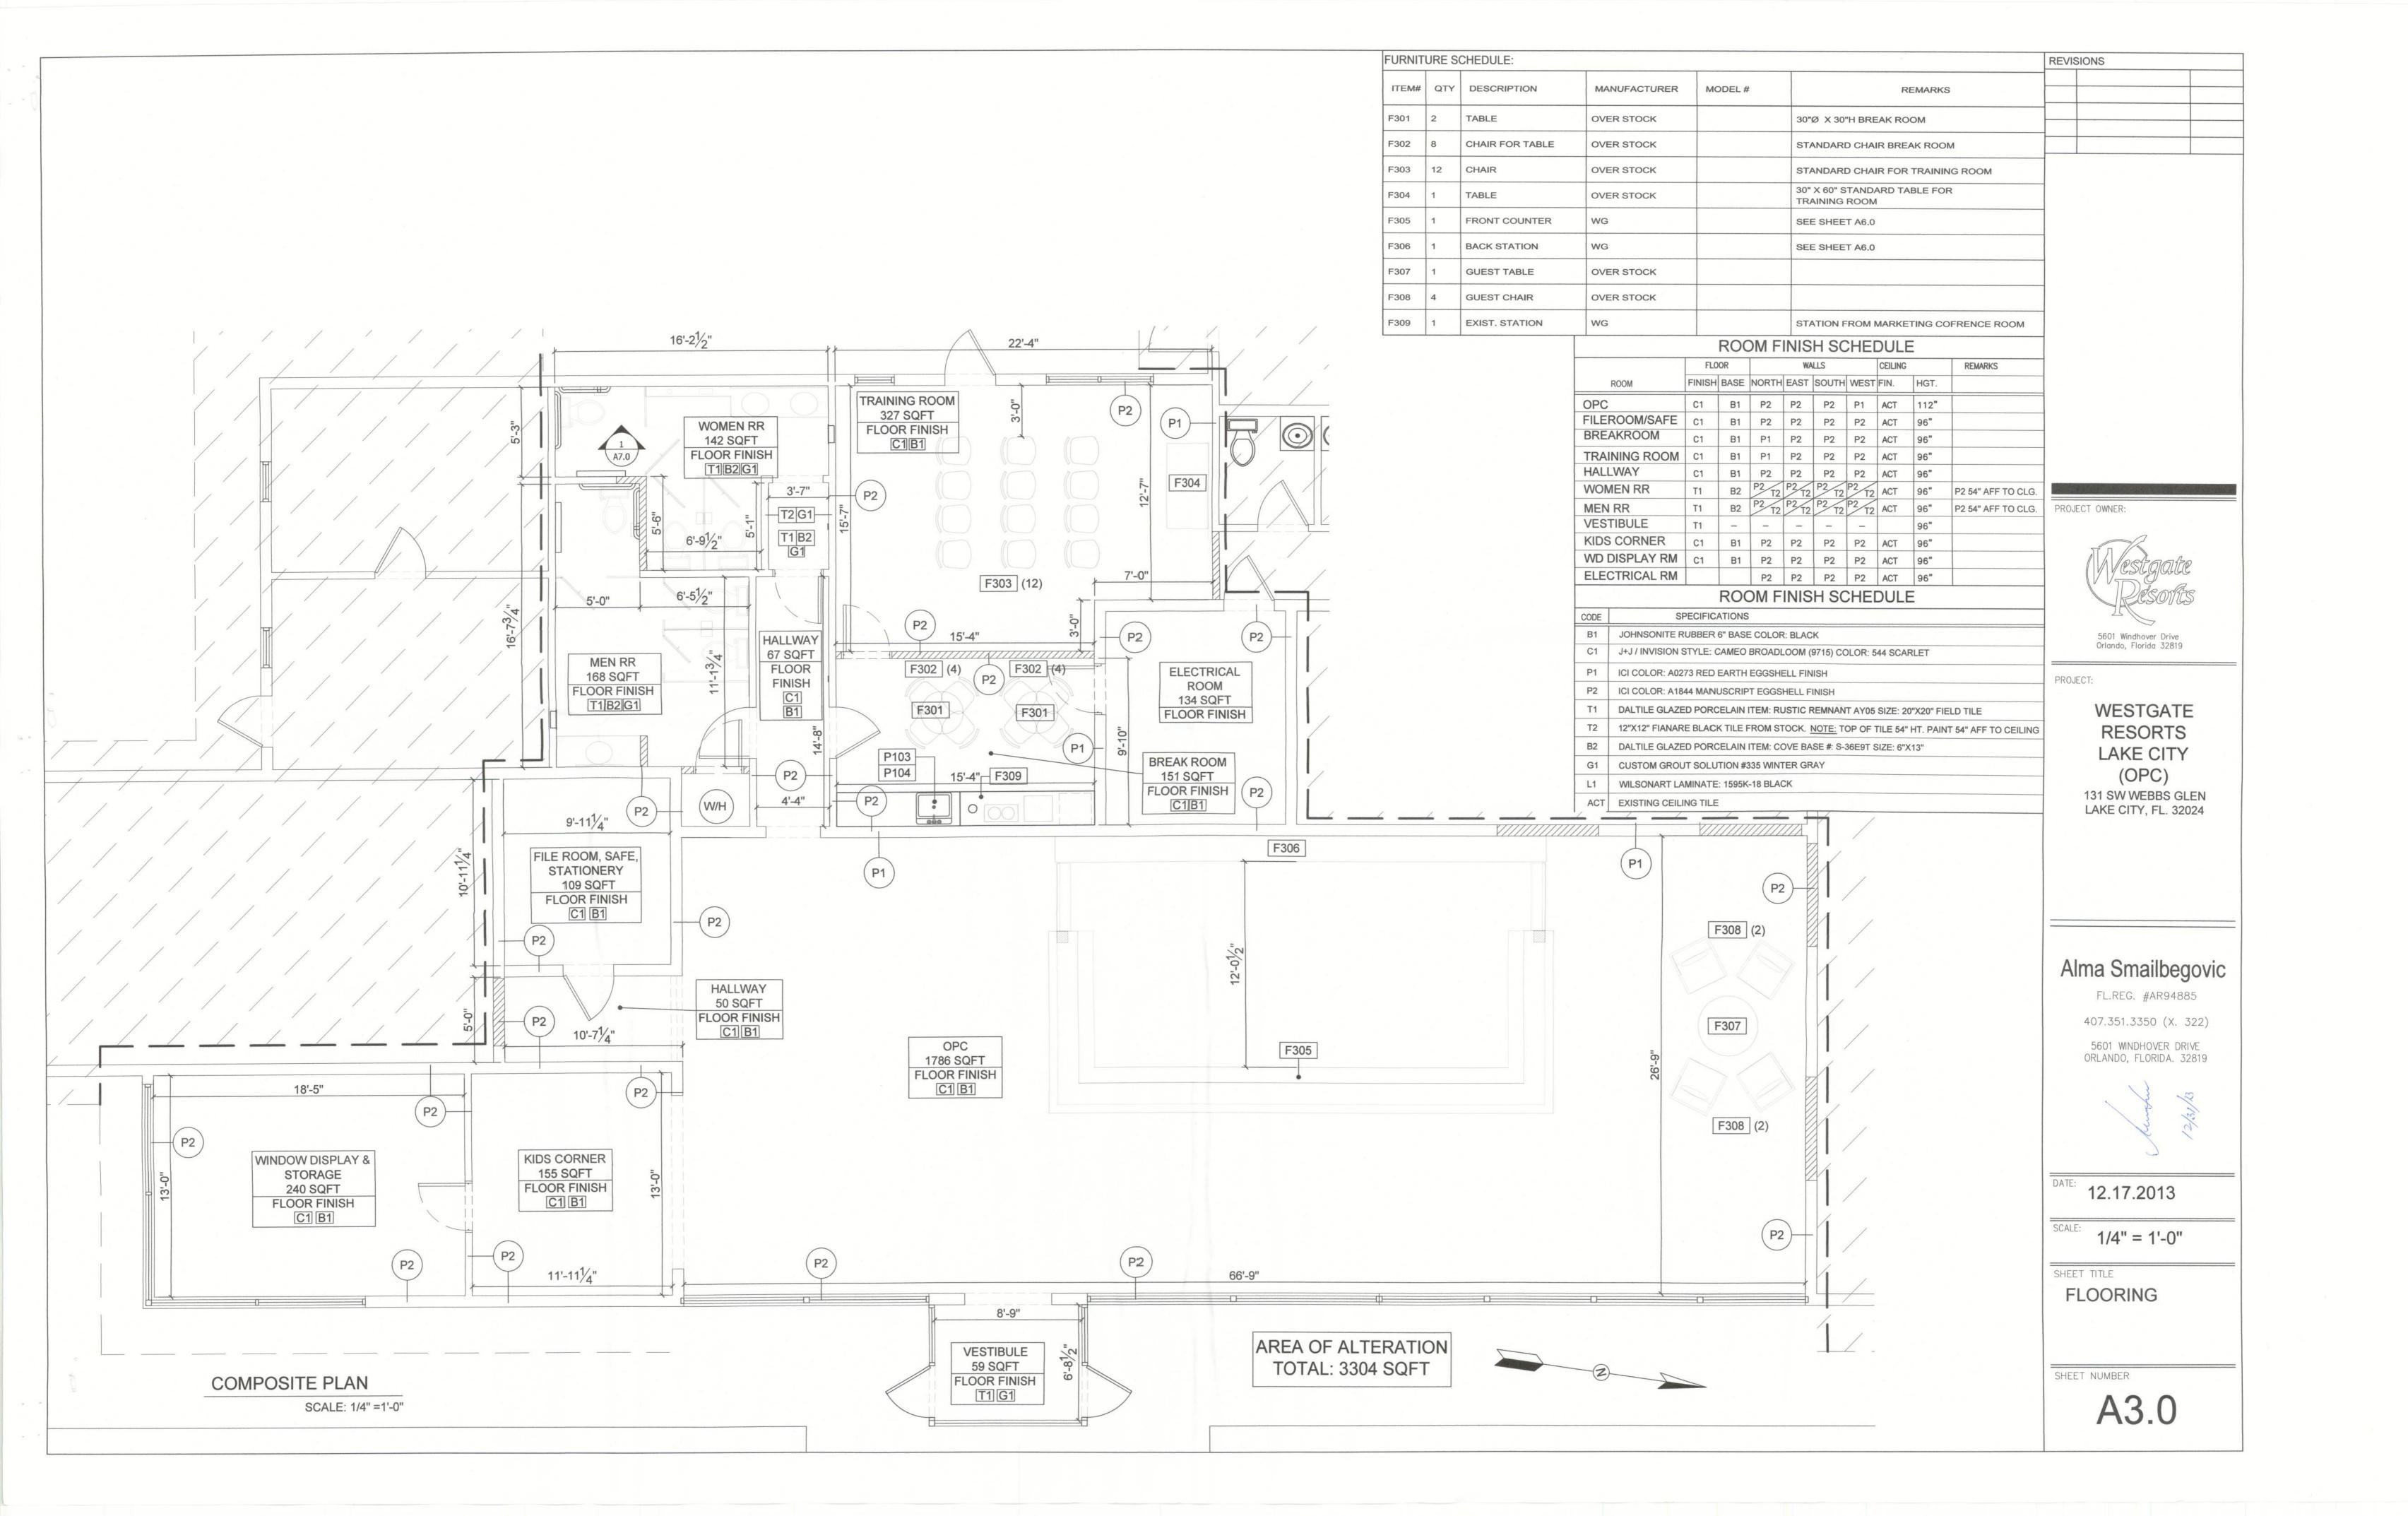

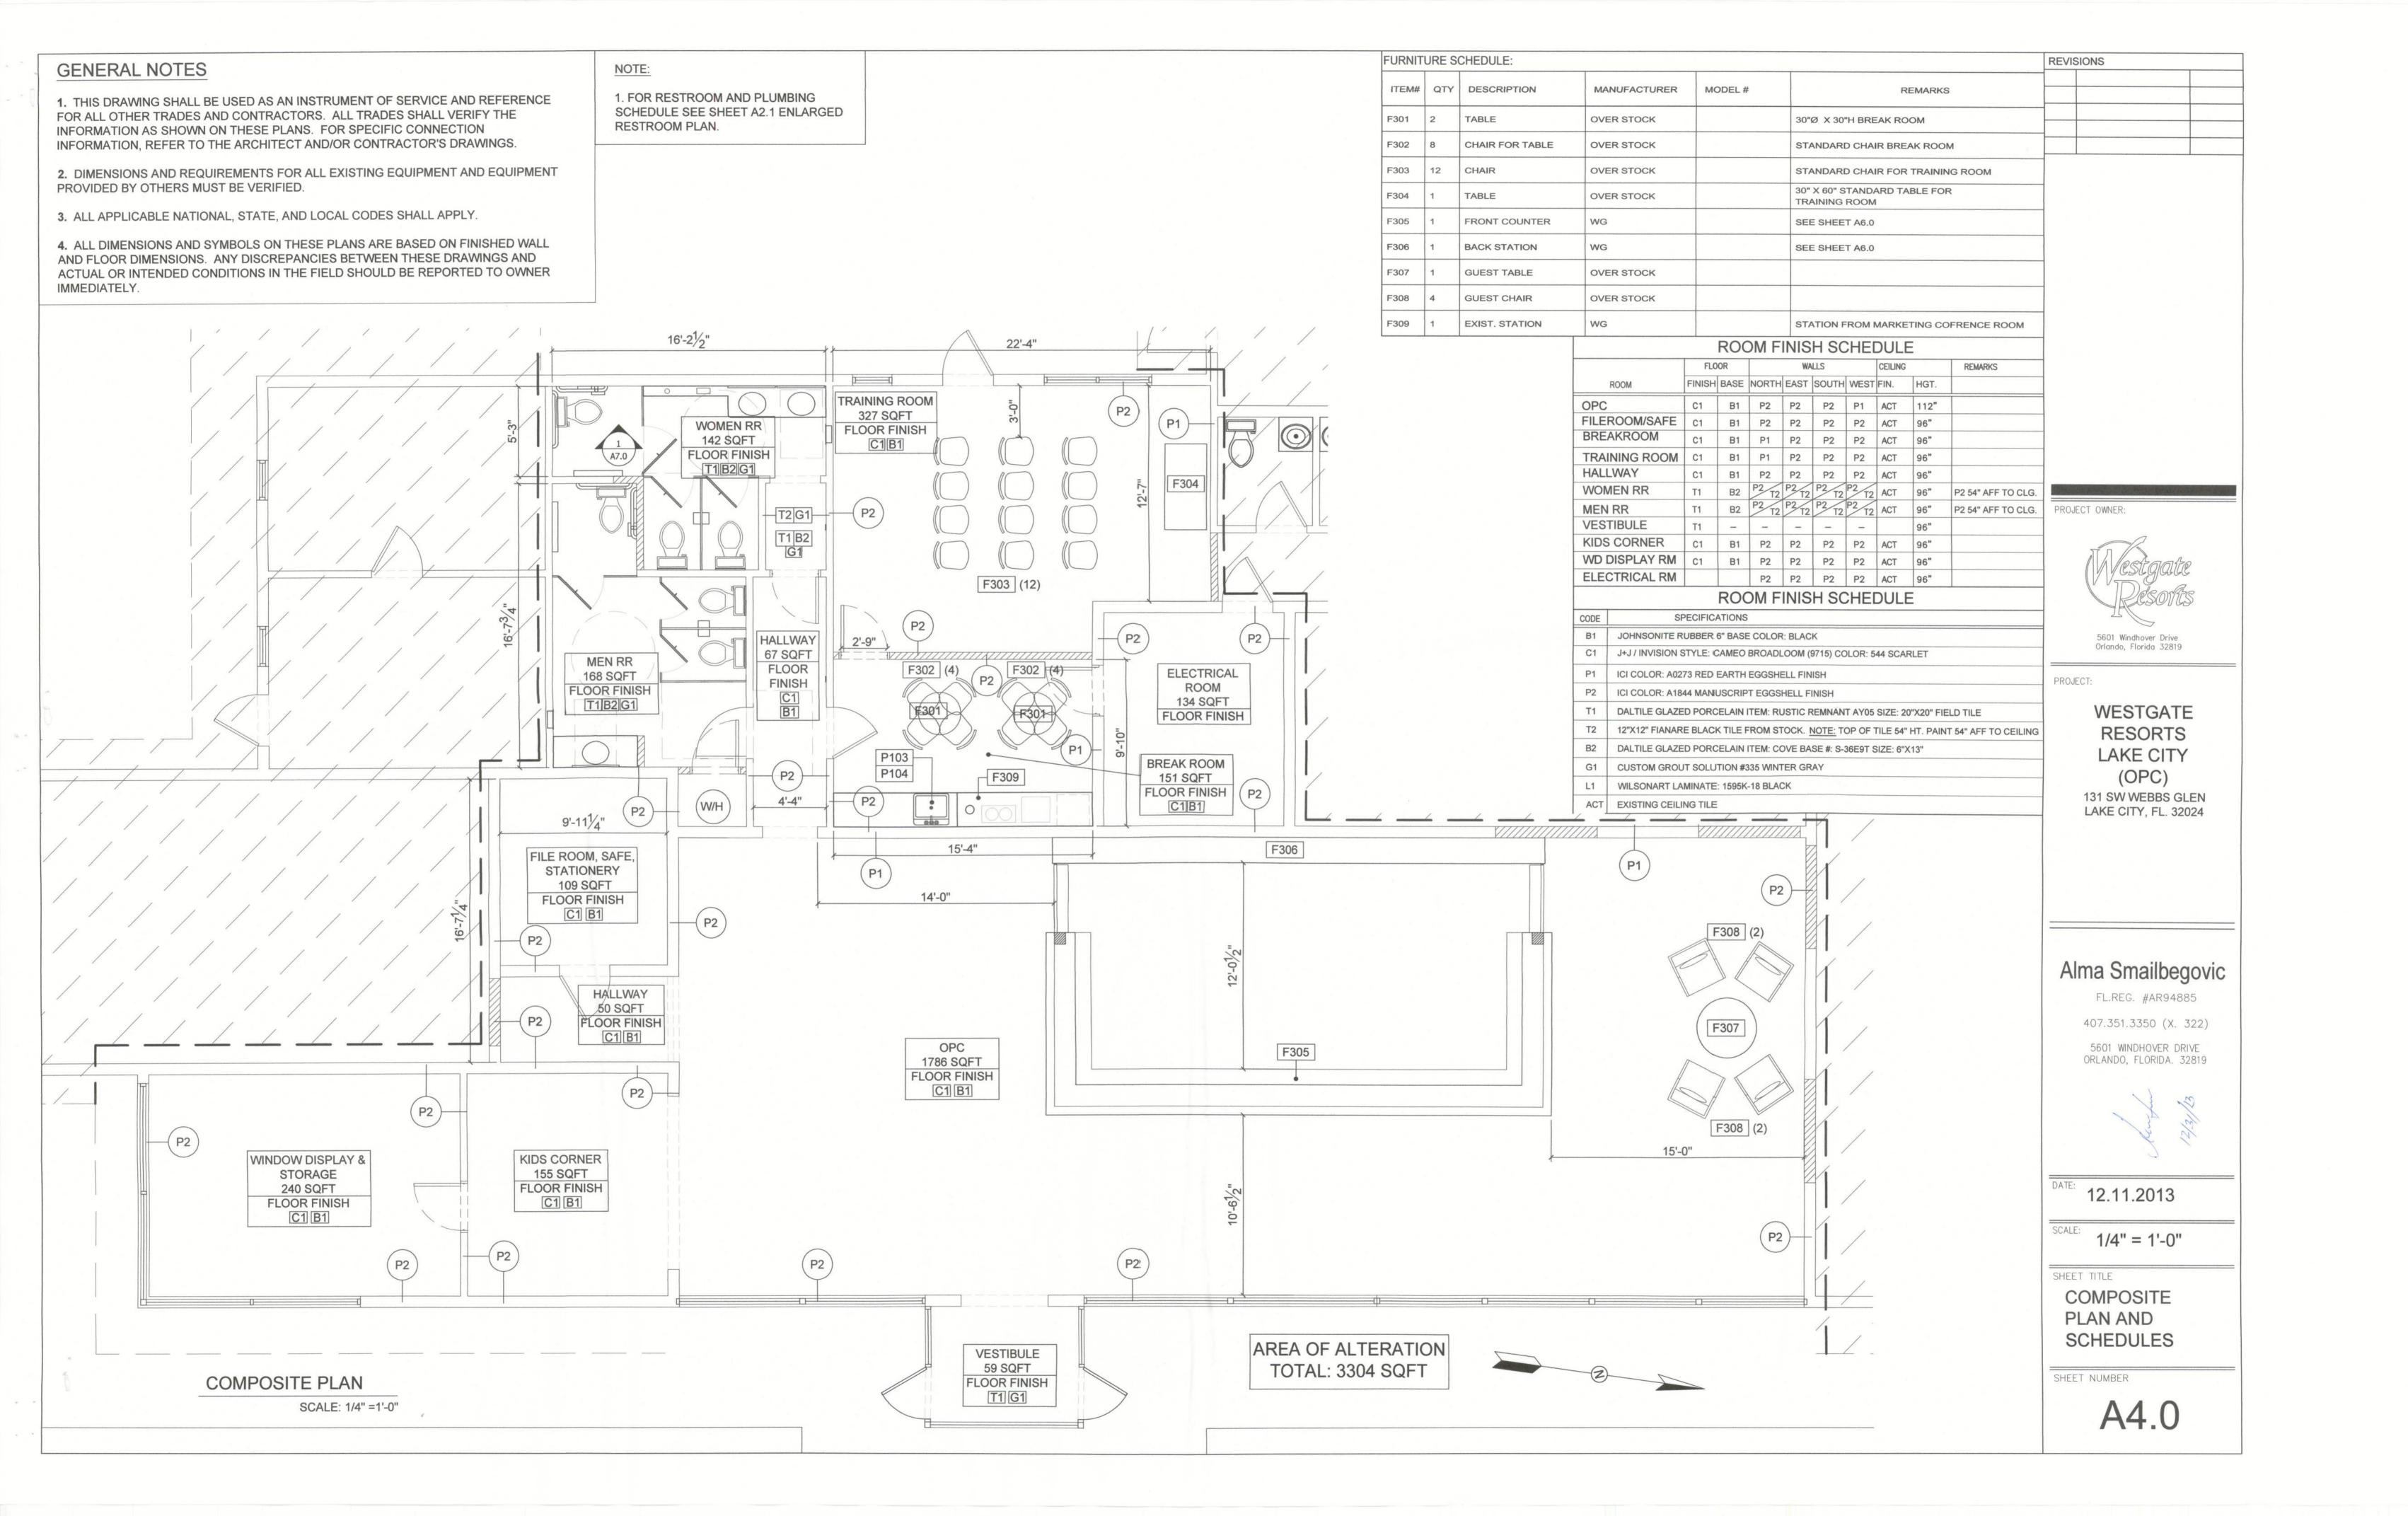

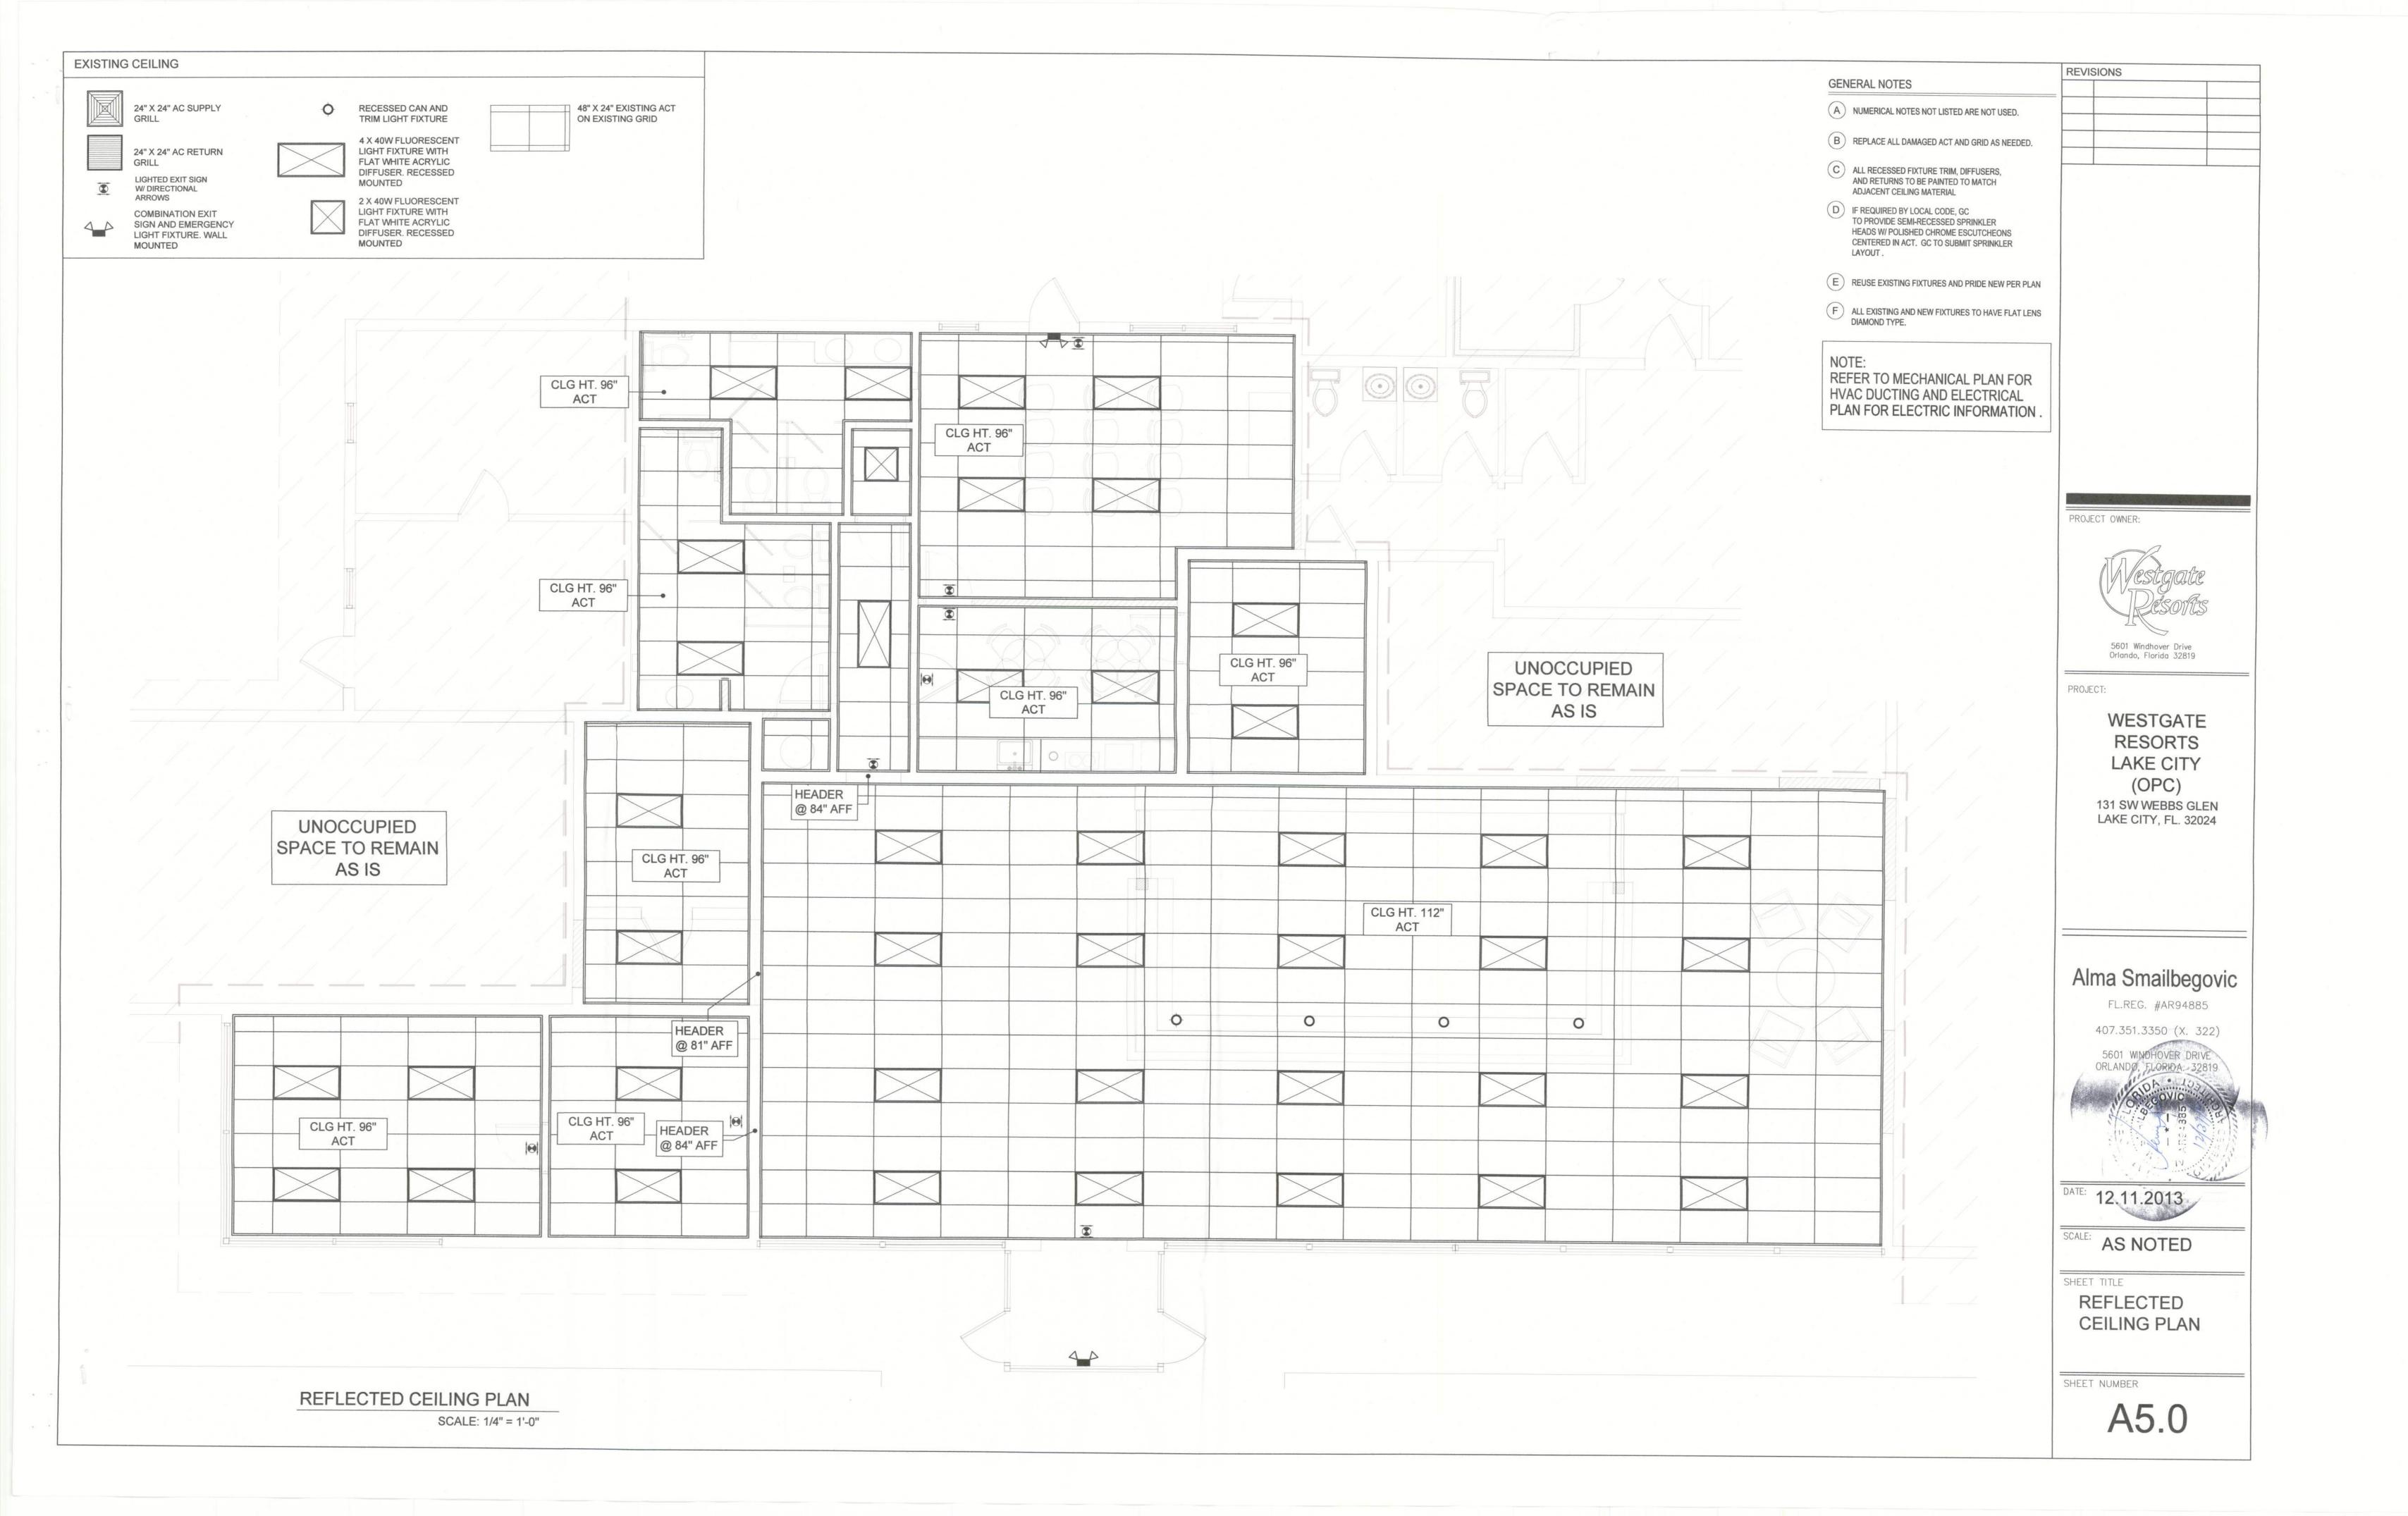

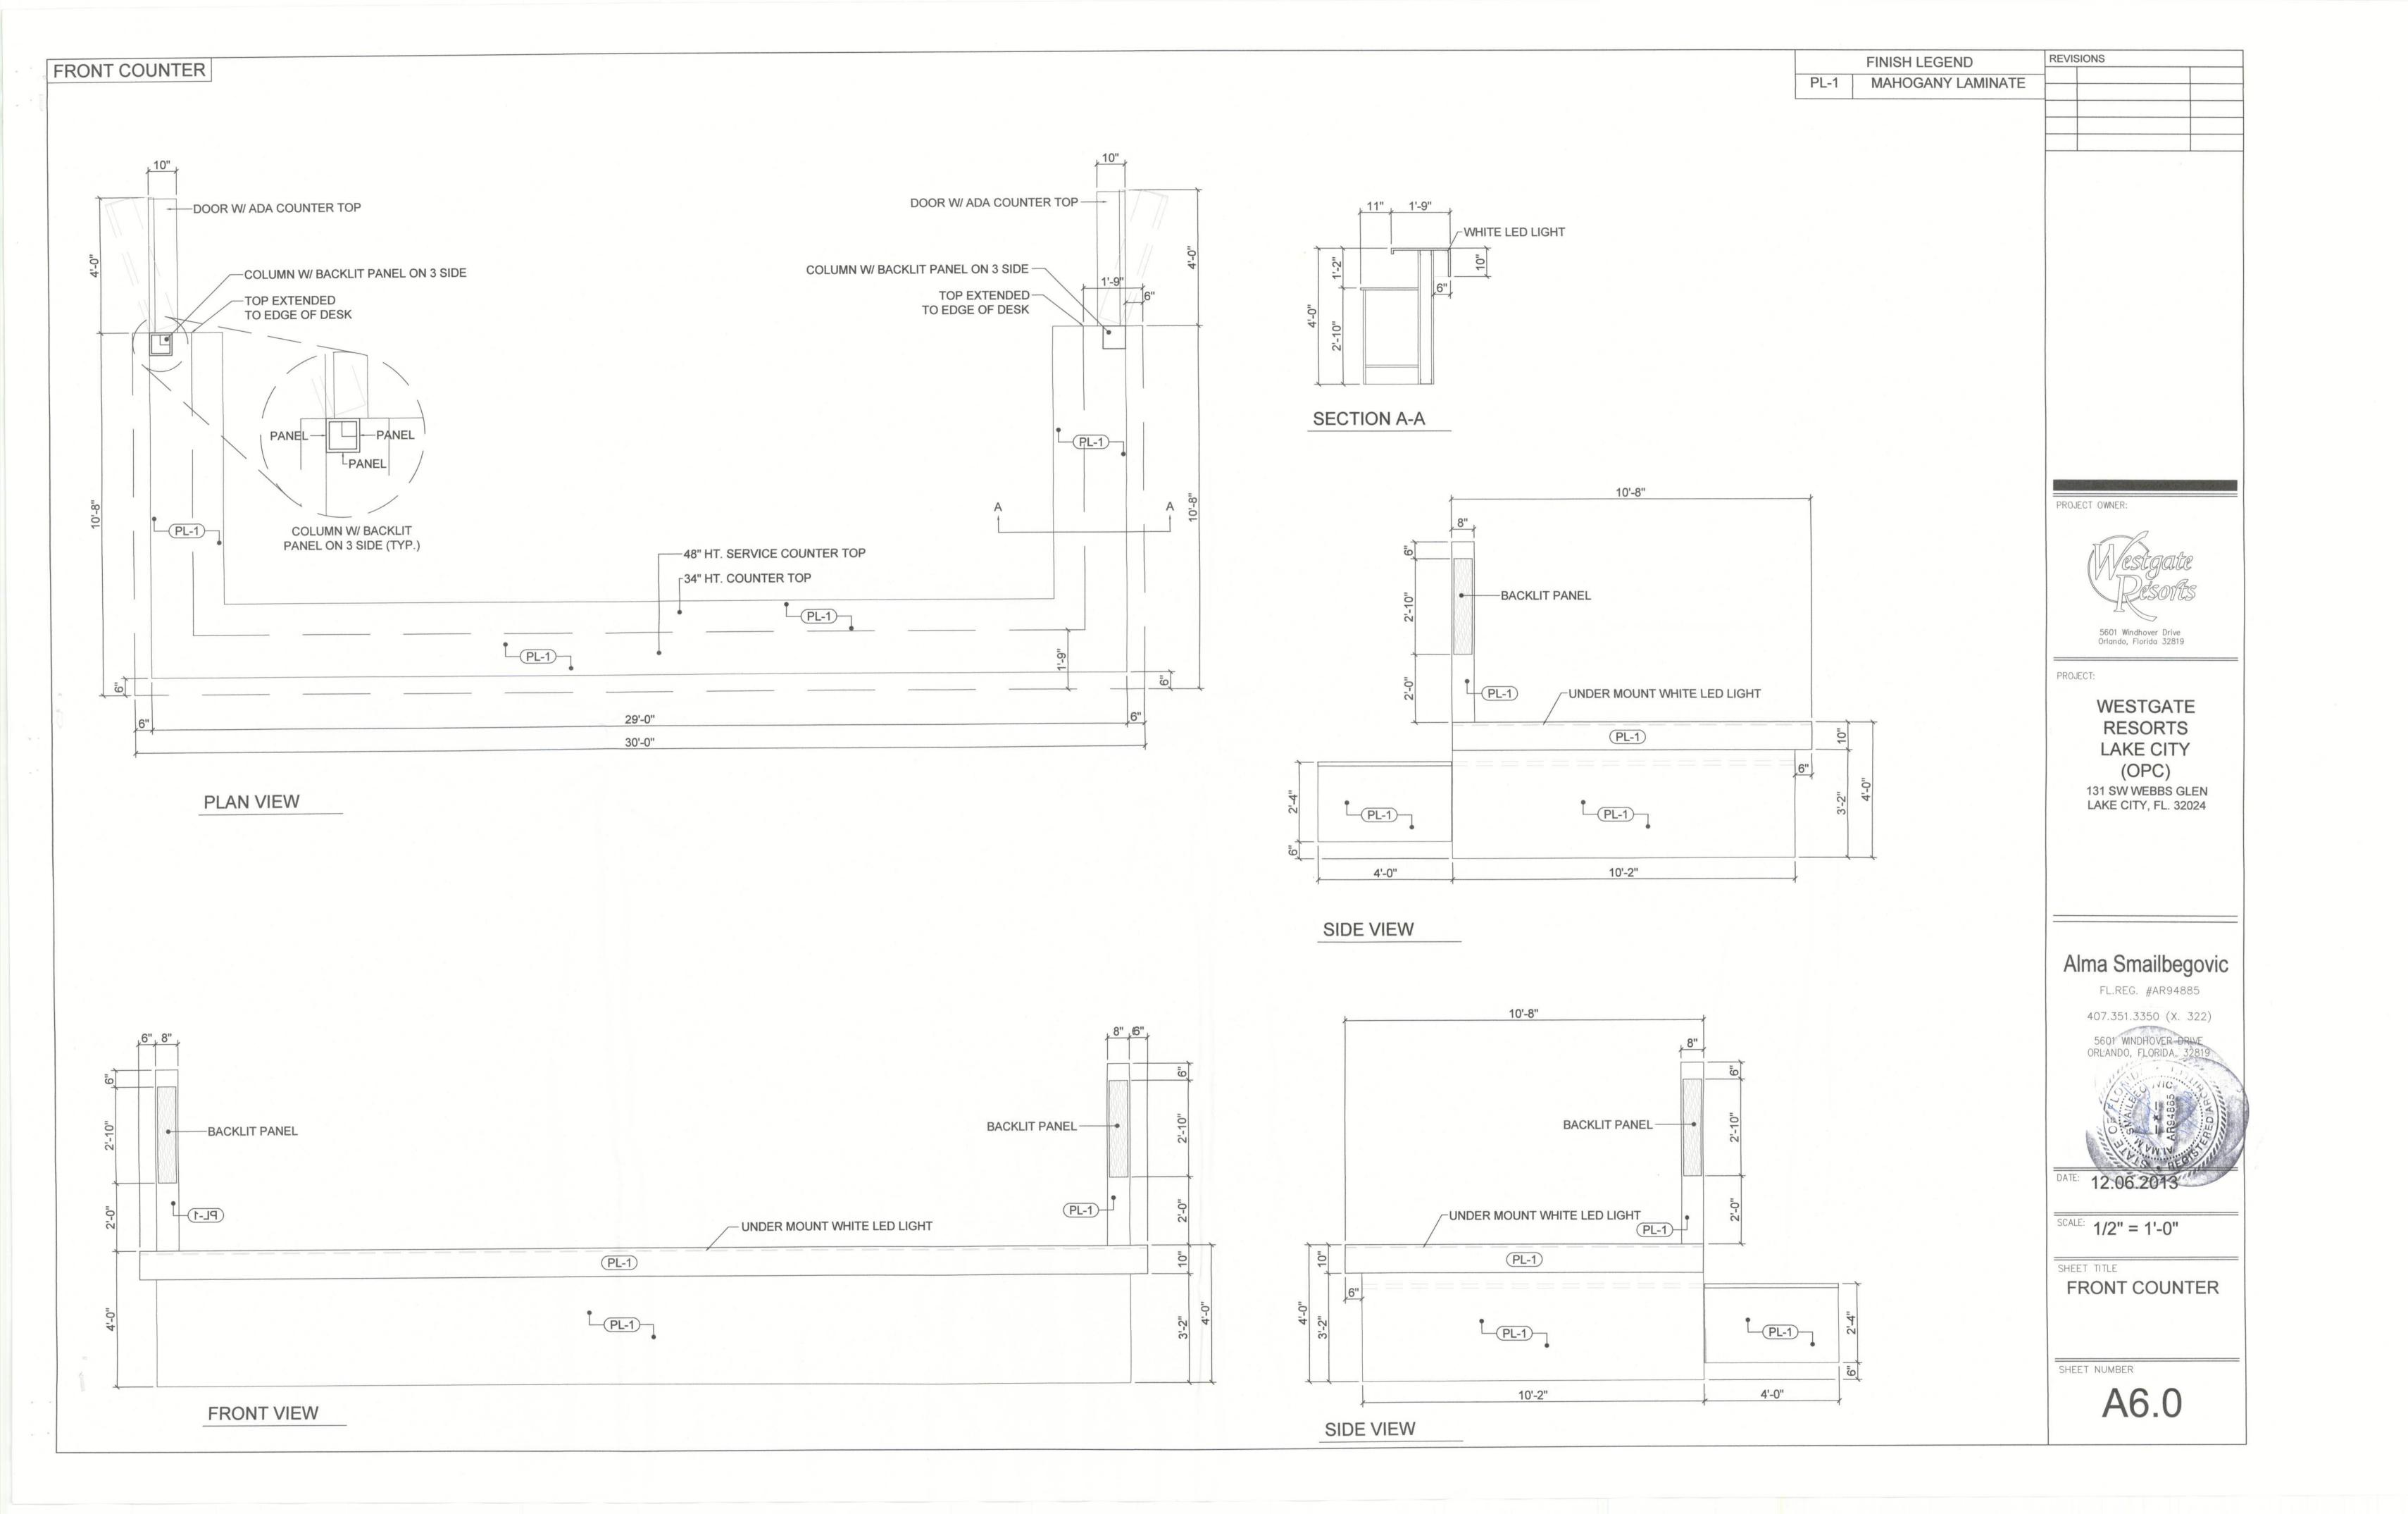

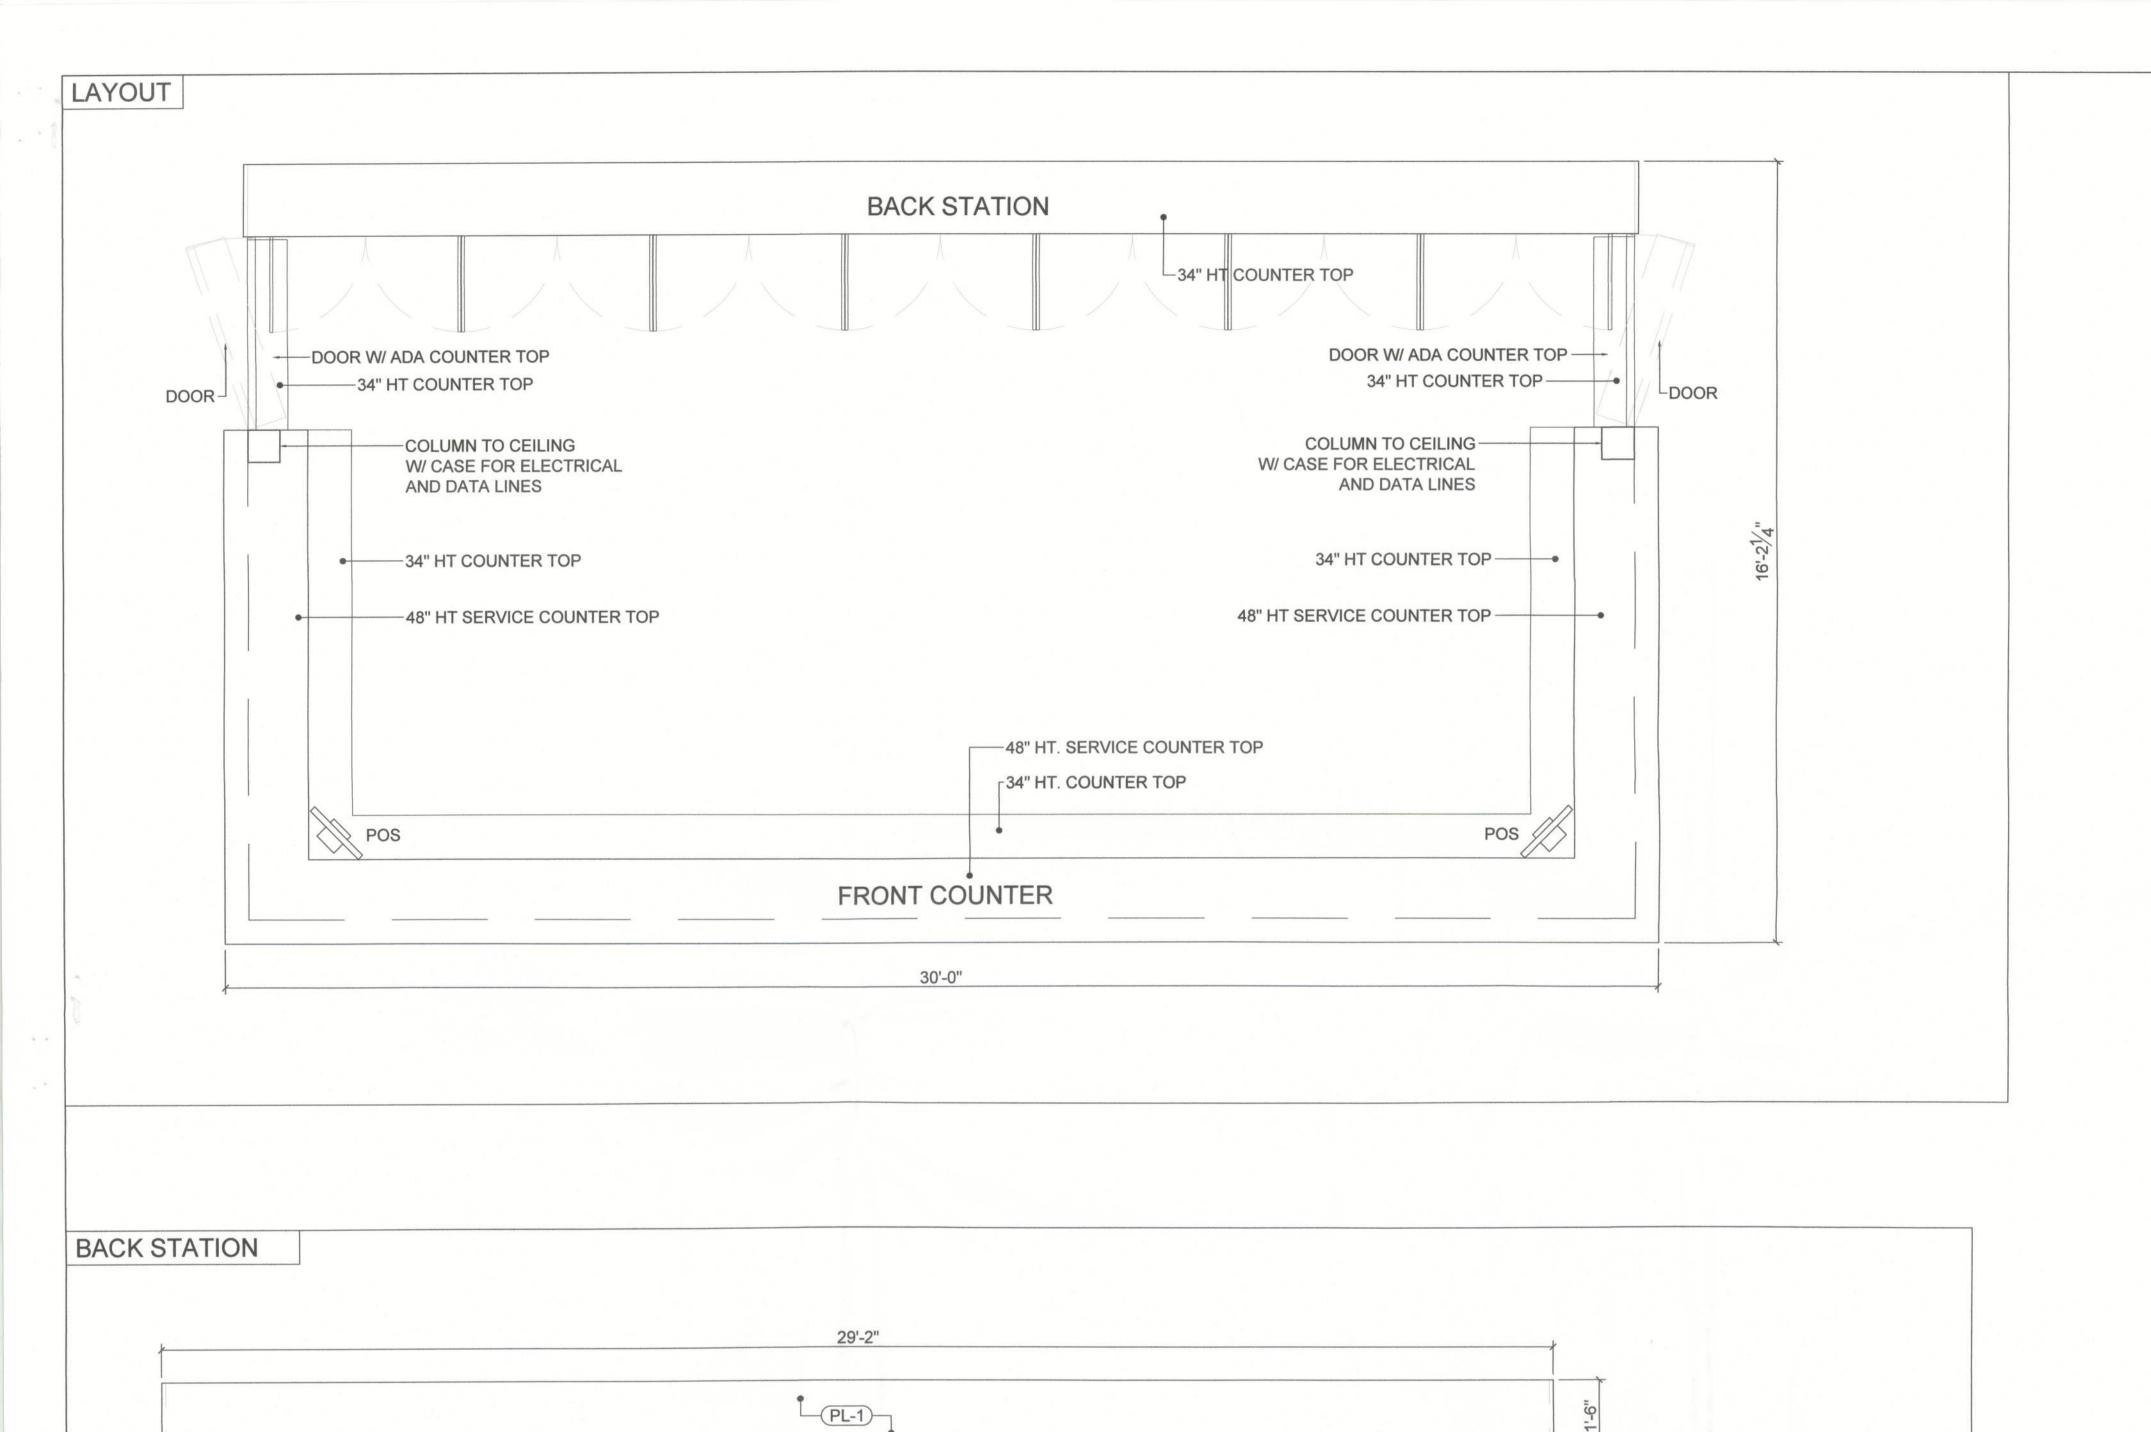

SHELF

SIDE VIEW

29'-2"

EQ.

PL-1

EQ.

EQ.

EQ.

EQ.

EQ.

EQ.

EQ.

PLAN VIEW


FRONT VIEW


EQ.

EQ.

EQ.

EQ.

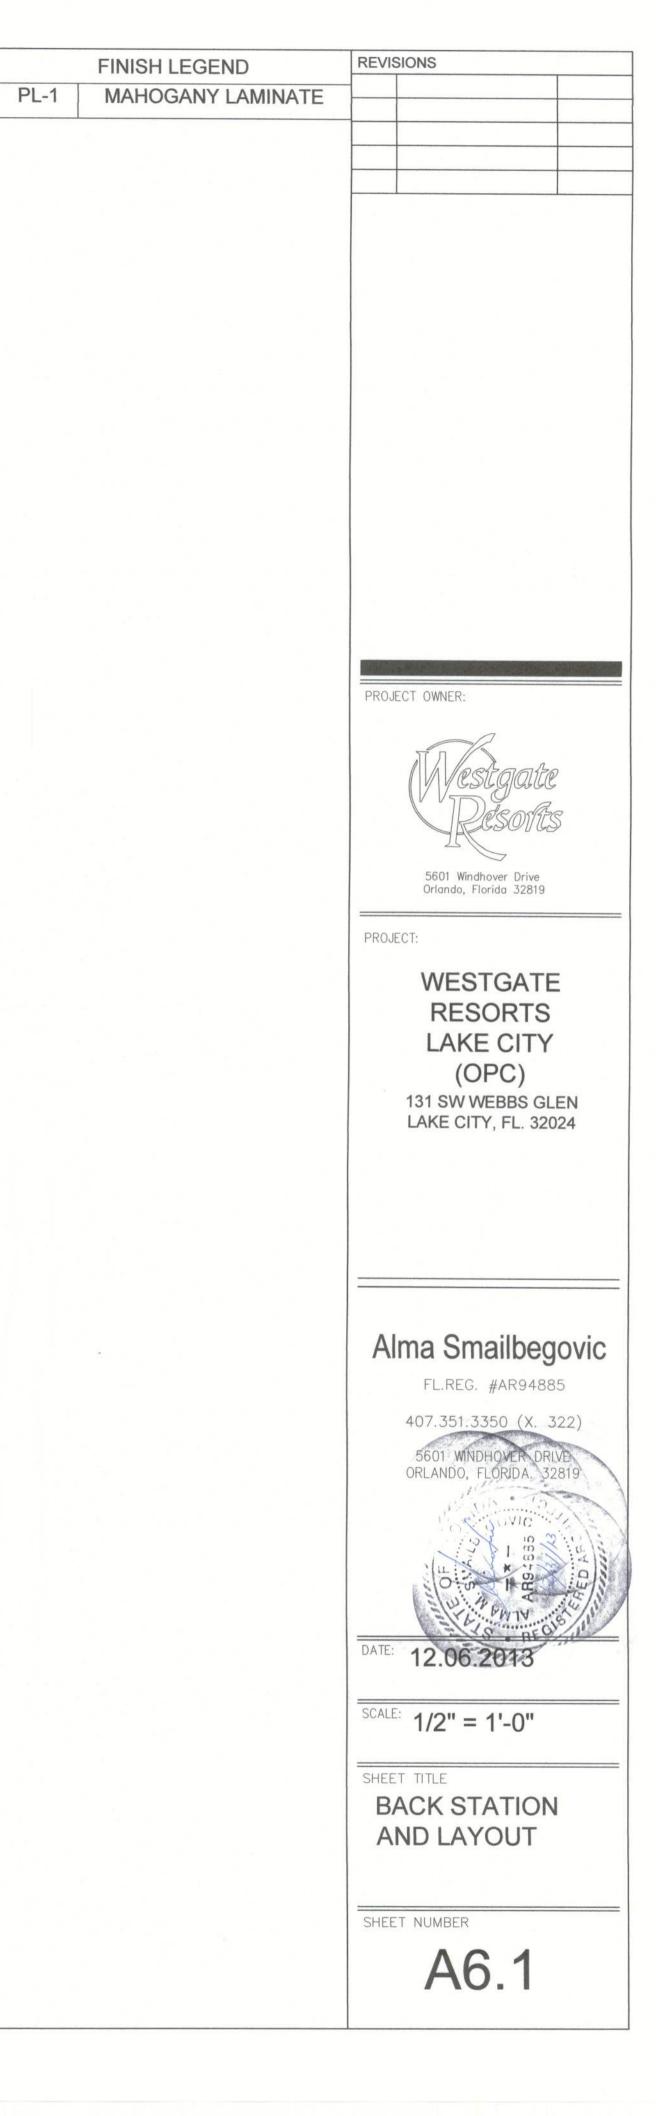

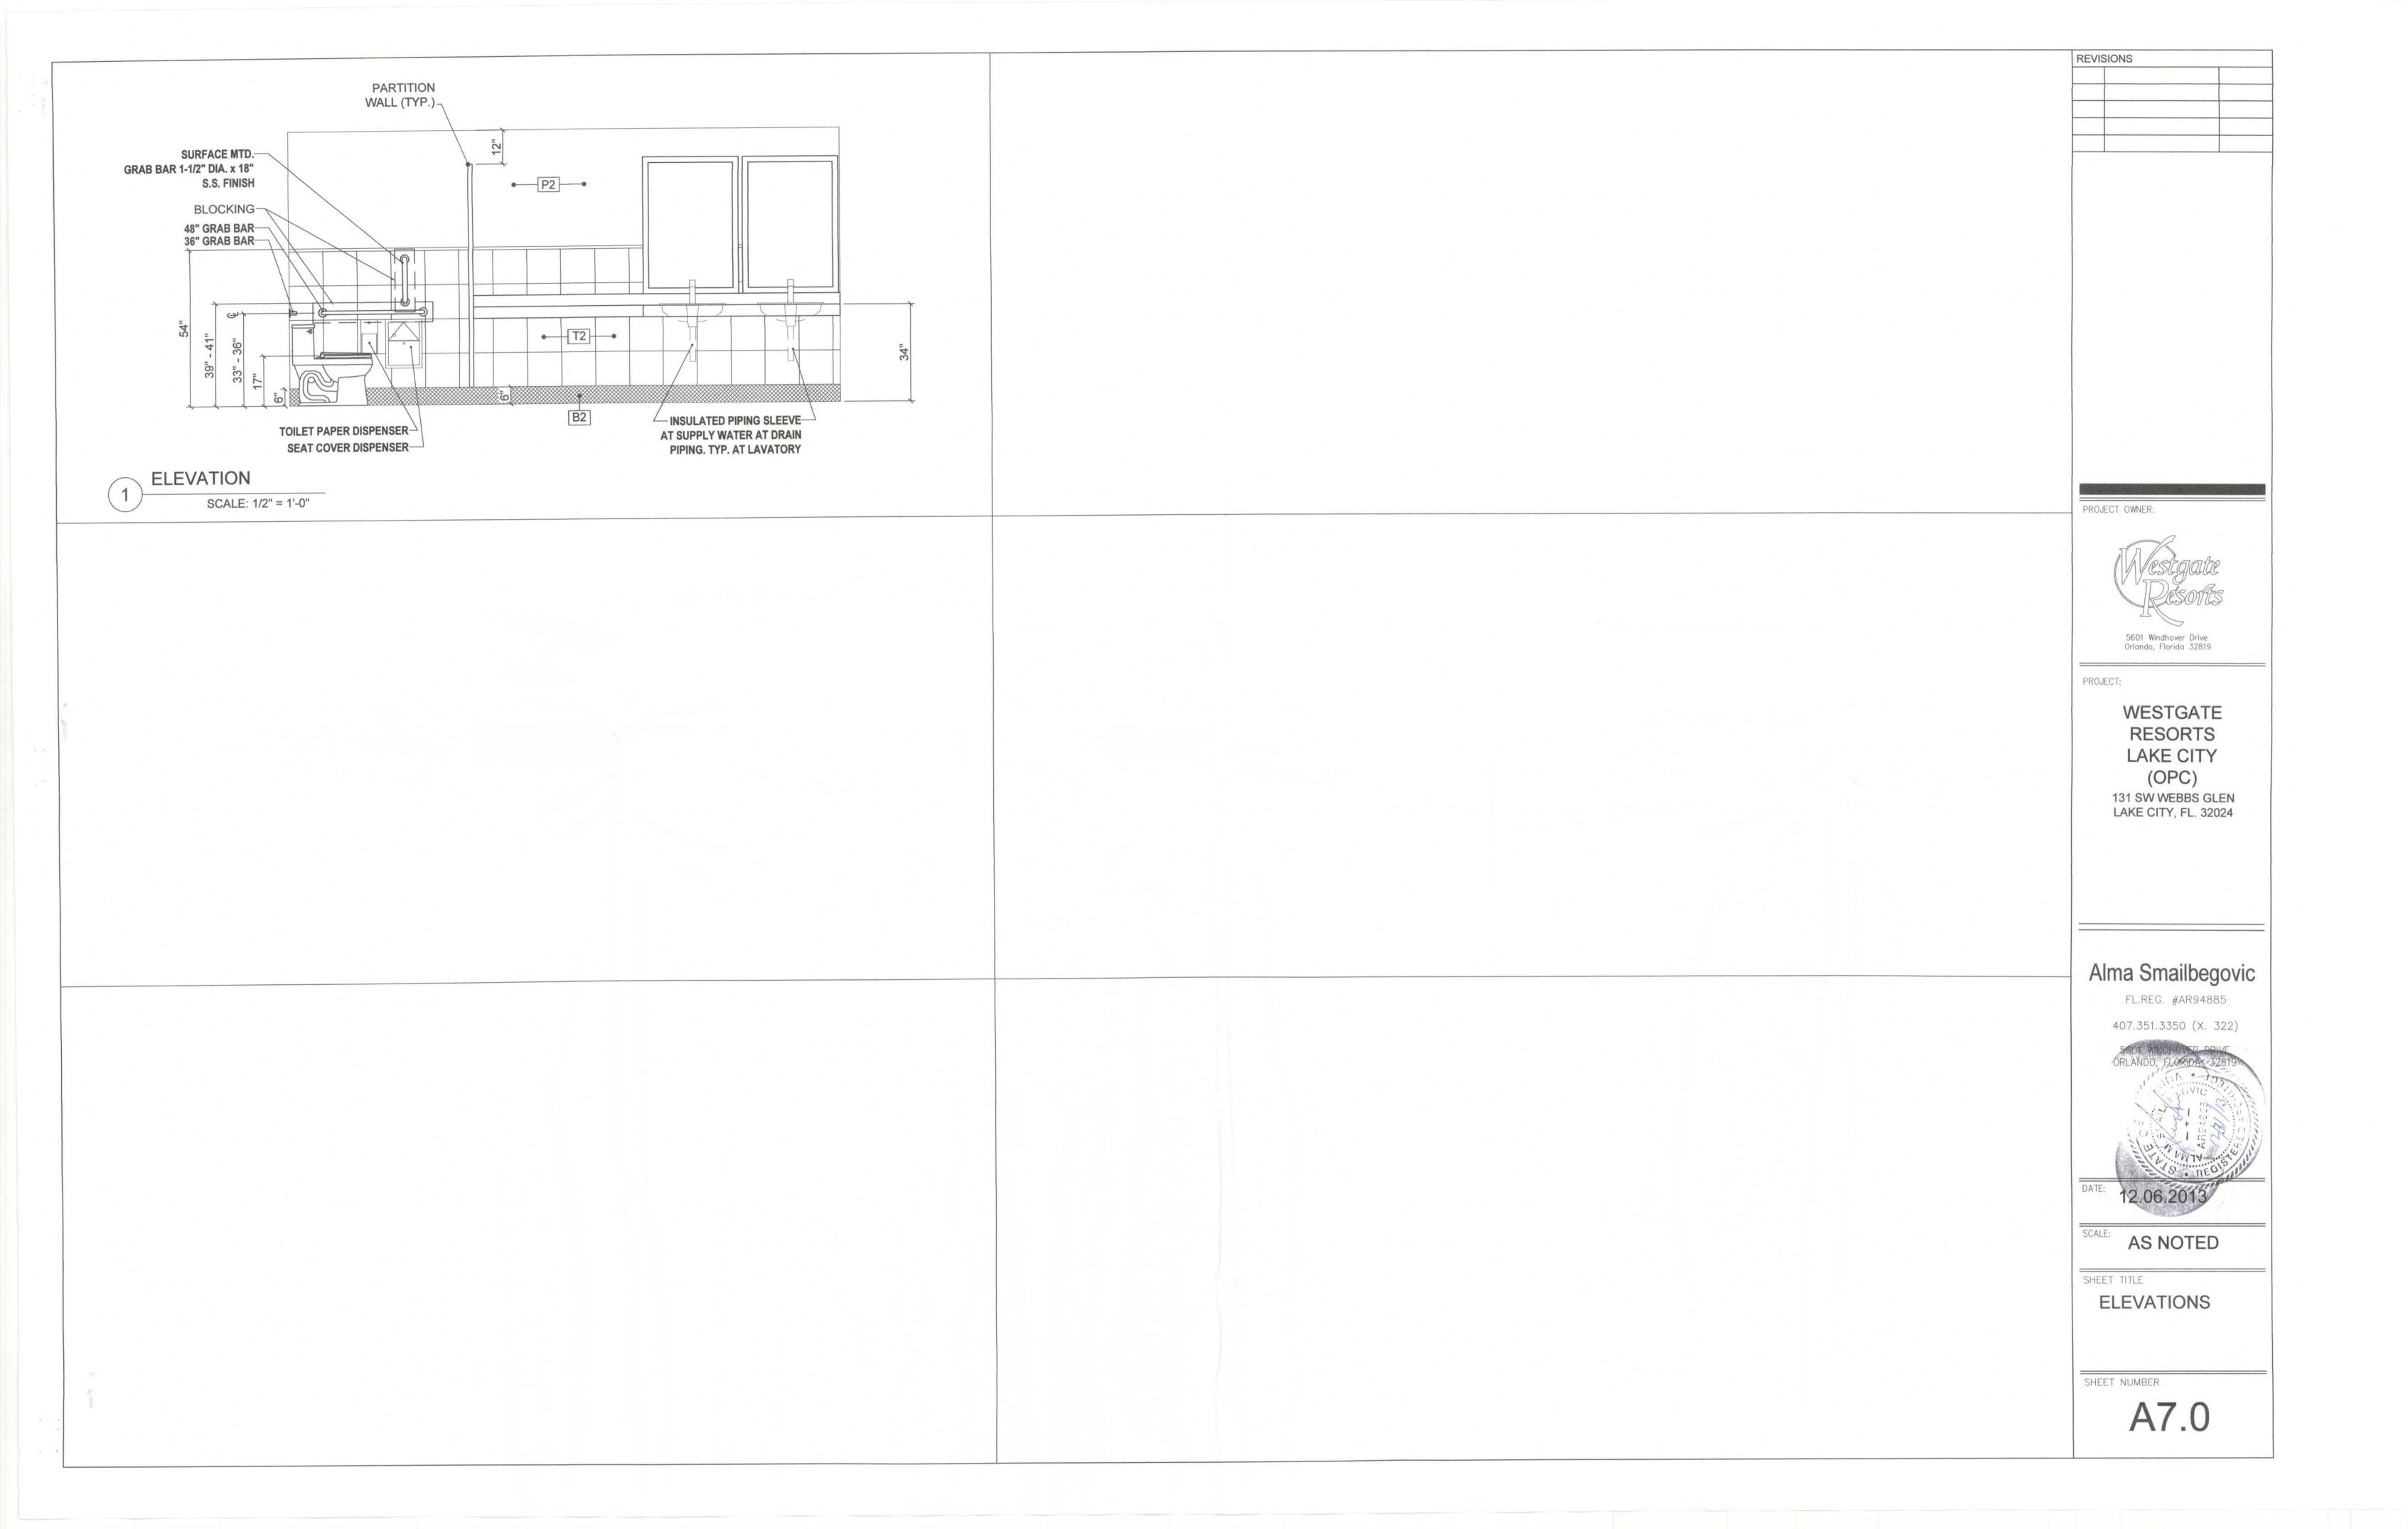

- ELECTRICAL SPECIFICATIONS

GENERAL

- 1. ALL WORK PERFORMED AND MATERIALS PROVIDED SHALL CONFORM TO THE LATEST EDITION OF THE NATIONAL ELECTRICAL CODE (NEC) AND ALL OTHER APPLICABLE STANDARDS, CODES AND LAWS. THE EDITION OR YEAR-DATE FOR ALL CODES AND STANDARDS SHALL BE THAT CURRENTLY ADOPTED BY THE MUNICIPALITY OR OTHER LOCAL AUTHORITY HAVING JURISDICTION.
- 2. COORDINATE ALL ELECTRICAL WORK WITH THAT OF OTHER TRADES.
- 3. INSPECTION: PRIOR TO ALL WORK OF THIS SECTION, CAREFULLY INSPECT THE INSTALLED WORK OF ALL OTHER TRADES AND VERIFY THAT ALL SUCH WORK IS COMPLETE TO THE POINT WHERE THIS INSTALLATION MAY PROPERLY COMMENCE.
- 4. INTERFERENCE: AVOID INTERFERENCE WITH STRUCTURE AND WITH WORK OF OTHER TRADES, PRESERVING ADEQUATE HEADROOM AND CLEARING ALL DOORS AND PASSAGEWAYS.
- 5. THE CONTRACTOR SHALL CONFIRM THE LOCATIONS OF ALL EXISTING UTILITIES. CONTRACTOR IS RESPONSIBLE FOR REPAIRING ANY DAMAGE TO EXISTING UTILITIES TO THE BUILDING.
- 6. BEFORE ORDERING ANY MATERIALS OR EQUIPMENT, THE CONTRACTOR SHALL SUBMIT ENGINEERING DATA FOR ALL MATERIALS AND EQUIPMENT HE PROPOSES TO USE AND FURNISH. THE CONTRACTOR SHALL BE RESPONSIBLE FOR CHECKING EQUIPMENT DIMENSIONS OF PROPOSED SUBSTITUTE EQUIPMENT AND SHALL BE RESPONSIBLE FOR ITS FITTING IN THE SPACES ALLOWED. THE COST OF ANY REDESIGNING CAUSED BY A SUBSTITUTION SHALL BE BORNE BY THE CONTRACTOR.
- 7. ALL ELECTRICAL MATERIALS AND EQUIPMENT SHALL BE UL LISTED. ALL MATERIALS AND EQUIPMENT SHALL BE NEW, NON-SECONDARY MARKET PRODUCTS. ANY EQUIPMENT RECONDITIONED AND/OR RE-PACKAGED WITHOUT FACTORY AUTHORIZATION IS UNACCEPTABLE.
- 8. THIS CONTRACTOR SHALL DO ALL CUTTING, DRILLING AND PATCHING REQUIRED BY HIS WORK. ALL REPAIRS TO FINISH SHALL MATCH THE EXISTING, LEAVING NO DISCERNIBLE SCARS. STRUCTURAL MEMBERS SHALL NOT BE CUT UNLESS APPROVED BY THE ARCHITECT.
- 9. THE CONTRACTOR SHALL PROVIDE A ONE-YEAR GUARANTEE FOR ITEMS FURNISHED THAT SHALL COVER:
- A: FAULTY OR INADEQUATE DESIGN BY CONTRACTOR.
- IMPROPER ASSEMBLY OR ERECTION. C: DEFECTIVE WORKMANSHIP AND MATERIALS.
- 10. CONTRACTOR SHALL PROVIDE/INSTALL ALL ELECTRICAL SYSTEMS REQUIRED BY THIS PROJECT. THIS INCLUDES ALL MISCELLANEOUS ITEMS AND ACCESSORIES REQUIRED FOR THE COMPLETE AND CORRECT OPERATION FOR THE ENTIRE SYSTEM, WHETHER OR NOT SUCH ITEMS ARE ILLUSTRATED IN THE PROJECT DOCUMENTS.
- 11. CONTRACTOR SHALL PROVIDE MATERIALS WITH TRIM WHICH IS SUITABLE FOR THE TYPES OF CEILINGS, WALLS, AND FLOOR FINISHES ACTUALLY INSTALLED. MODEL NUMBERS REFERENCED IN THESE DOCUMENTS ARE NOT INTENDED TO IDENTIFY THE REQUIRED TRIM.

DRAWINGS

- 1. THE DRAWINGS ARE DIAGRAMMATIC IN NATURE, BUT SHOW VARIOUS COMPONENTS OF THE SYSTEMS APPROXIMATELY TO SCALE AND ATTEMPT TO INDICATE HOW THEY ARE TO BE INTEGRATED WITH OTHER PARTS OF THE BUILDING, DETERMINE EXACT LOCATIONS BY REVIEW OF EQUIPMENT MANUFACTURERS DATA, BY JOB SITE MEASUREMENTS, BY CHECKING THE REQUIREMENTS OF OTHER TRADES, AND BY REVIEWING ALL CONTRACT DOCUMENTS. THE SIZE OF ELECTRICAL EQUIPMENT INDICATED ON THE DRAWINGS MAY BE BASED ON THE DIMENSIONS OF A PARTICULAR MANUFACTURER. WHILE OTHER LISTED MANUFACTURERS MAY BE ACCEPTABLE IT IS THE RESPONSIBILITY OF THE CONTRACTOR TO DETERMINE IF THE EQUIPMENT THAT CONTRACTOR PROPOSES TO FURNISH WILL FIT IN THE SPACE.
- 2. THE DRAWINGS ARE NOT INTENDED TO SHOW EXACT LOCATIONS OF CONDUIT, WIRE, OR TO INDICATE ALL WIRE TERMINATORS, CONNECTORS, CONDUIT FITTINGS, BOXES, OR SUPPORTS, BUT RATHER TO INDICATE DISTRIBUTION, CIRCUITRY, AND CONTROL.
- 3. THE VARIOUS PHASES OF WORK. THE WORK SHALL BE LAID OUT SO THAT IT WILL BE CONCEALED IN FURRED CHASES AND SUSPENDED CEILINGS, ETC., IN FINISHED PORTIONS OF THE BUILDING, UNLESS SPECIFICALLY NOTED TO BE EXPOSED. WORK SHALL BE INSTALLED TO AVOID CRIPPLING OF STRUCTURAL MEMBERS. ALL EXPOSED WORK SHALL BE INSTALLED PARALLEL OR PERPENDICULAR TO THE LINES OF THE BUILDING UNLESS OTHERWISE NOTED.
- 4. WHEN THE PLUMBING AND ELECTRICAL DRAWINGS DO NOT GIVE EXACT DETAILS AS THE THE ELEVATION OF PIPE, CONDUIT AND DUCTS, PHYSICALLY ARRANGE THE SYSTEMS TO FIT IN THE SPACE AVAILABLE. SPACES SHALL BE PRIORITIZED AS REQUIRED TO ALLOW FOR PROPER GRADES OF THE SYSTEMS INVOLVED.

GROUNDING

- 1. PROVIDE A COMPLETE EQUIPMENT SAFETY GROUND SYSTEM (GREEN WIRE GROUND) FOR THE ENTIRE ELECTRICAL SYSTEM AS REQUIRED BY ARTICLE 250 OF THE NEC, AND AS SPECIFIED HEREIN.
- 2. ALL GROUNDING WIRE, LUGS, JUMPERS AND BUS SHALL BE COPPER.
- 3. ALL FEEDER AND BRANCH CIRCUITS SHALL CONTAIN AN EQUIPMENT GROUND WIRE. NO METAL CONDUIT OF ANY KIND OR LENGTH SHALL BE USED AS THE EQUIPMENT GROUNDING CONDUCTOR.
- 4. EQUIPMENT GROUNDING CONDUCTORS AND STRAPS SHALL BE SIZED IN ACCORDANCE WITH NEC. REFER TO FEEDER SCHEDULES FOR GROUND WIRE REQUIREMENTS WHICH MAY BE EXCEED THE NEC. ALL EQUIPMENT GROUNDING CONDUCTORS SHALL BE PROVIDED WITH GREEN INSULATION EQUIVALENT TO THE INSULATION ON THE ASSOCIATED PHASE CONDUCTORS.
- 5. THE EQUIPMENT GROUNDING SYSTEM SHALL BE INSTALLED SO THAT ALL METALLIC STRUCTURES, ENCLOSURES, RACEWAYS, JUNCTION BOXES, OUTLET BOXES, CABINETS, MACHINE FRAMES AND PORTABLE EQUIPMENT FRAMES OPERATE CONTINUOUSLY AT GROUND POTENTIAL AND PROVIDE A LOW IMPEDANCE PATH FOR GROUND FAULT CURRENTS. THE SYSTEM SHALL COMPLY WITH THE NATIONAL ELECTRICAL CODE.
- 6. GROUNDING CONDUCTORS SHALL BE CONTINUOUS AND NO SPLICING SHALL BE ALLOWED.

WIRE AND CABLE

- 1. ALL WIRE SHALL BE COPPER WITH INSULATED RATED AT 600 VOLTS, 75 DEGREES CELSIUS MINIMUM.
- 2. MINIMUM WIRE SIZES SHALL BE #12 FOR POWER WIRING.
- 3. WIRE SHALL BE SOLID TYPE OR THHN/THWN UP TO SIZE 10 AWG AND STRANDED TYPE THWN OR XHHW FOR SIZE 8 AWG AND LARGER (UNLESS OTHERWISE NOTED).
- 4. MOLDED CONNECTORS (WIRE NUTS) MAY BE USED FOR SPLICING SIZE 10 AWG OR SMALLER WIRES ON LIGHTING AND RECEPTACLE CIRCUITS ONLY. ALL OTHER WIRING SHALL BE SPLICED ONLY WITH LUGS AND/OR TERMINAL
- 5. TERMINAL LUGS SHALL BE MECHANICAL CLAMP OR COMPRESSION TYPE UNLESS PART OF A CIRCUIT BREAKER OR SWITCH ASSEMBLY. SET SCREW TYPE LUGS IN WHICH THE SET SCREW BEARS DIRECTLY ON THE CONDUCTOR SHALL NOT BE USED.
- 6. SPECIAL LUGS MAY BE REQUIRED TO ACCOMMODATE CONDUCTOR SIZES SHOWN ON THE DRAWINGS. CONTRACTOR SHALL VERIFY LUG REQUIREMENTS FOR ALL CIRCUIT BREAKERS AND EQUIPMENT TERMINALS AND SHALL PROVIDE CORRECT LUGS AS REQUIRED.
- 7. UNDER NO CIRCUMSTANCES SHALL FEEDERS BE SPLICED.
- 8. COLOR CODE THE ENTIRE POWER WIRING SYSTEM IN ACCORDANCE WITH THE NATIONAL ELECTRICAL CODE, AND ALL STATE AND LOCAL CODES.
- 9 PROVIDE A COMPLETE CONTROL WIRING SYSTEM FOR ALL ELECTRICAL EQUIPMENT AND APPLIANCES, INCLUDING ALL OWNER-FURNISHED EQUIPMENT, EQUIPMENT FURNISHED UNDER OTHER DIVISIONS (MECHANICAL EQUIPMENT, ETC.) SHALL BE PROPERLY INSTALLED WITH ELECTRICAL CIRCUITS AND CONNECTIONS, DISCONNECTS, STARTERS, OPERATOR CONTROL PUSH-BUTTONS, ALARMS, ETC. AS SPECIFIED FOR EACH TYPE OF ITEM.
- 10. SMOKE CONTROL DAMPERS: PROVIDE FIRE ALARM MONITORED RELAYS AND SUPERVISED SIGNAL AND POWER WIRING TO PROVIDE SIGNAL OF FIRE ALARM CONDITION TO SMOKE CONTROL DAMPERS.
- 11. ALL SWITCHES FOR CONTROLS, SIGNALS, PILOTS, REMOTE TRIP OPERATORS, RAISE/LOWER SWITCHES, REMOTE START/STOP MOTOR CONTROL STATIONS, AND ANY OTHER DEVICES THAT ARE REQUIRED BY THE SYSTEM SHALL BE PROVIDED AND INSTALLED BY THE CONTRACTOR.
- 12. CONTRACTOR IS RESPONSIBLE FOR INTERCONNECTION AND PROGRAMMING OF ALL CONTACTORS, TIME SWITCHES, AND PHOTOELECTRIC CONTROL SYSTEMS.
- 13. GROUNDING CONDUCTORS: ALL GROUNDING ELECTRODE CONDUCTORS AND EQUIPMENT GROUNDING CONDUCTORS SHALL BE INSULATED COPPER (AS SPECIFIED AIBOVE) UNLESS INDICATED OTHERWISE.
- 14. BRANCH CIRCUITS MAY BE GROUPED IN SINGLE RACEWAYS AND SHARE A COMMON NEUTRAL PROVIDED THE FOLLOWING GUIDELINES ARE MET

AND/OR UNLESS THE DRAWINGS INDICATE OTHERWISE.

- A. DEDICATED CIRCUITS: PROVIDE A NEUTRAL PER PHASE CONDUCTOR FOR ALL DEDICATED CIRCUITS. PROVIDE DEDICATED HOMERUN RACEWAY FOR EACH DEDICATED CIRCUIT WHEN INDICATED ON DRAWINGS.
- B. THREE PHASE, FOUR WIRE, WYE SYSTEMS: PROVIDED A NEUTRAL CONDUCTOR FOR EACH GROUP OF TWO OR THREE SEQUENCE PHASED LINE CONDUCTORS.
- . SINGLE PHASE, THREE WIRE SYSTEMS: PROVIDE A NEUTRAL CONDUCTOR FOR EACH GROUP OF TWO SEQUENCED LINE CONDUCTORS.
- 15. ALL WIRE SIZES ON DRAWINGS REPRESENT COPPER WIRE UNLESS INDICATED TO BE ALUMINUM BY THE ABBREVIATION "AL" ON THE DRAWINGS
- 16. ALUMINUM OPTION: FOR COPPER CONDUCTORS AWG #1/O AND LARGER, AND "AL" IS NOT INDICATED ON DRAWINGS, ALUMINUM MAY BE PROVIDED AT THE REQUEST OF THE OWNER IF:
- A. THE SIZE OF THE FEEDER AND CONDUIT IS INCREASED TO PROVIDE A NEC-ACCEPTABLE INSTALLATION OF EQUAL (OR GREATER) AMPACITY AND EQUAL (OR LESS) VOLTAGE DROP TO THE COPPER SIZES SHOWN, AND
- B. ALUMINUM GROUNDING CONDUCTORS SHALL BE SIZED PER NEC TABLE 250-95, AND
- C. ALUMINUM WIRE SHALL NOT BE TERMINATED AT FIRE PUMPS. GENERATORS, MECHANICAL EQUIPMENT, MOTOR CONTROLLERS OR TERMINALS OF CONTROL CIRCUIT DEVICES UNLESS APPROVED IN WRITTEN INSTALLATION INSTRUCTIONS BY THAT EQUIPMENT MANUFACTURER, AND
- D. ALL LUGS SHALL BE PROPER UL-LISTED DUAL-RATED
- COPPER-ALUMINUM LUGS. E. ALUMINUM CONDUCTORS SHALL BE ALUMINUM ASSOCIATION 8000
- SERIES ELECTRICAL-GRADE ALUMINUM ALLOY. F. ALUMINUM CONDUCTORS SHALL HAVE COMPACT STRANDING AS DEFINED IN NEC CHAPTER NINE TABLES 5A AND 5B.
- 17. METAL-CLAD CABLE AND ARMORED CABLE (KNOWN BY TRADENAME BX) SHALL BE ALLOWED AT OWNERS APPROVAL.

BOXES

- 1. PROVIDE OUTLET BOXES FOR ALL SWITCHES, FIXTURES, RECEPTACLES AND BE SUBMITTED TO THE ENGINEER FOR APPROVAL. ALL OTHER OUTLET DEVICES.
- 2. JUNCTION AND PULL BOXES SHALL HAVE SCREW-ON COVERS OR LOCKING HINGED COVERS. NEMA 1 BOXES SHALL BE USED INDOORS. NEMA 3R BOXES WITH THREADED HUBS SHALL BE USED OUTDOORS.
- 3. BOXES SHALL BE SIZED IN ACCORDANCE WITH NEC ARTICLE 370.
- 4. INTERIOR BOXES SHALL BE ONE PIECE, GALVANIZED STEEL CONSTRUCTION, SUITABLE/LISTED FOR INTENDED USE. PROVIDE PLASTER-RINGS WHERE REQUIRED. INSTAILL "GANGED" BOXES WHERE DEVICES ARE INDICATED TO BE
- 5. EXTERIOR BOXES SHALL BE ONE PIECE PVC "UV PROTECTED".
- 6. ALL CONDUIT CONNECTORS AND ENTRY HUBS SHALL BE INSULATED OR HAVE INSULATED BUSHINGS.

RACEWAY

- 1. MINIMUM CONDUIT SIZES SHALL BE 1/2".
- 2. LOCATIONS OF CONDUITS SHALL COMPLY WITH THE NATIONAL ELECTRICAL CODE AND ALL LOCAL AND STATE REGULATIONS.
- 3. PROVIDE COMPLETE RACEWAY SYSTEMS FOR ALL WIRING UNLESS OTHERWISE NOTED. THIS INCLUDES FEEDERS, BRANCH CIRCUITS, CONTROL WIRING, AND SYSTEMS WIRING.
- 4. ALL CONDUIT BENDS SHALL BE MADE WITH AN APPROVED CONDUIT BENDER AND NO BEND SHALL HAVE A CENTERLINE RADIUS LESS THAN SIX TIMES THE DIAMETER OF THE CONDUIT.
- 5. TRANSITIONS FROM CONCRETE ENCASEMENT: WHERE PVC CONDUIT IS USED FOR RUNS UNDERGROUND OR IN SLABS, AS OUTLINED HEREIN, A CONVERSION TO RIGID STEEL "ELL" SHALL BE USED TO EXIT EARTH OR ENCASEMENT. PROVIDE SWEEPING ELBOWS WITH LARGEST POSSIBLE RADIUS FOR ALL CHANGES OF DIRECTION.
- 6. PROVIDE AN INSULATED-THROAT METALLIC OR ALL-PLASTIC BUSHING ON ALL EMT, IMC, AND RIGID METALLIC RACEWAY STUBS AND TERMINATION IN PANELS, SWITCHBOARDS, CABINETS, PULL BOXES, JUNCTIONS BOXES, GUTTERS, AND OTHER ENCLOSURES.
- 7. CEILING GRID SHALL NOT SUPPORT ANY CABLE OR RACEWAY.

WIRING DEVICES

- 1. PROVIDE A COMPLETE SYSTEM OF WIRING DEVICES PROPERLY WIRED, INCLUDING A SOLID GROUNDING CONNECTION.
- 2. UNDERWRITERS LABORATORIES: PROVIDE WIRING DEVICES WHICH ARE LISTED AND LABELED BY UL.
- 3. NATIONAL ELECTRICAL MANUFACTURER'S ASSOCIATION: WIRING DEVICES SHALL COMPLY WITH APPLICABLE NEMA STANDARDS.
- 4. DEVICE COLOR: WHITE UNLESS OTHERWISE NOTED.
- 5. ACCEPTABLE: THE FOLLOWING MANUFACTURERS WILL BE ACCEPTABLE PROVIDING THEY MEET THE PROJECT SPECIFICATIONS: COPPER WIRING DEVICES, ARROW-HART, HUBBELL, LEVITON, LUTRON, WOODHEAD INDUSTRIES.
- 6. STANDARD CONVENIENCE OUTLET: 20A/125V/2 POLE/3 WIRE DUPLEX NEMA 5-20R. DUPLEX RECEPTACLE. RECEPTACLE FACE SHALL BE HIGH-IMPACT RESISTANT. NYLON BODY SHALL BE THERMOPLASTIC POLYESTIER. MOUNTING STRAP SHALL WARP COMPLETELY AROUND RECEPTACLE BODY AND HAVE INTEGRAL, RIVETLESS GROUNDING CONTACTS. THE RECEPTACLE GROUNDING CONTACTS ARE FORMED DIRECTLY OUT OF THE BACKSTRAP METAL. THEY SHALL NOT BE SEPARATED PIECES AFFIXED TO THE BACKSTRAP.
- 7. GROUND FAULT CIRCUIT INTERRUPTERS: PROVIDE U.L LISTED GROUND FAULT CIRCUIT INTERRUPTER RECEPTACLES FOR PERSONNEL PROTECTION, WHICH OTHERWISE MEET THIS SPECIFICATION, WHERE REQUIRED.
- 8. WALL SWITCHES: 20A-120-277V AC CONTACTS. TOGGLE TYPE, QUIET ACTION WITH SEPARATED SCREW TERM FOR THE GROUND WIRE. SCREWLESS PUSH-IN WIRING TERM SHALL NOT BE USED. PROVIDE SINGLE POLE, SINGLE THROW, UNLESS DRAWINGS INDICATE 3-WAY, 4-WAY, DOUBLE POLE, KEY OPERATED, SPDT MOMENTARY, OR ANY OTHER SPECIAL FEATURES.
- 9. SWITCHES FOR SPECIAL PURPOSE: SPECIAL SWITCHES USED FOR DISCONNECTION PURPOSES (SMALL APPLIANCES, ETC.) SHALL BE RATED AS SPECIFIED OR REQUIRED.
- 10. PROVIDE WALL PLATES FOR ALL DEVICES. PROVIDE ONE-PIECE MULTI-GANG PLATES WHERE ADJACENTLY LOCATED OUTLET ASSEMBLIES OCCUR.

ENCLOSED SWITCHES

- 1. PROVIDE STANDARD DUTY TYPE ENCLOSED SWITCHES, SQUARE D, OR EQUIVALENT, SWITCHES SHALL HAVE EXTERNALLY OPERATED HANDLES WITH PROVISIONS FOR PAD LOCKING IN THE OFF OR ON POSITION. PROVIDE NEMA 3R OR 4X STAINLESS STEEL UNITS AS INDICATED ON THE DRAWINGS.
- 2. WHERE REQUIRED: PROVIDE ALL ENCLOSED DISCONNECT SWITCHES INDICATED ON THE DRAWINGS. WHERE A CIRCUIT SERVES A MOTOR, MOTIOR CONTROLLER, FIXED ELECTRIC SPACE HEATING UNIT, OR APPLIANCE AND A LOCAL DISCONNECT SWITCH IS NOT INDICATED ON THE DRAWINGS, PROVIDE A LOCAL DISCONNECT UNLESS ONE OF THE NEC EXCEPTIONS PERTAIN.

EQUIPMENT

- 1. THE CONTRACTOR IS RESPONSIBLE FOR THE COMPLETE INSTALLATION OF ALL EQUIPMENT SHOWN ON THE DRAWINGS. ALL MANUFACTURER'S SPECIFICATIONS SHALL BE FOLLOWED IN REGARDS TO THE INSTALLATION OF ALL EQUIPMENT. ANY SPECIAL MANUFACTURER'S REQUIREMENTS NECESSARY FOR PROPER OR SAFE INSTALLATION OF EQUIPMENT REGARDLESS OF WHETHER THE AFOREMENTIONIED SPECIAL REQUIREMENTS ARE INDICATED ON THE DRAWINGS, SHALL BE AT THE EXPENSE AND RESPONSIBILITY OF THE CONTRACTOR.
- 2. THE DIVISION 16 INSTALLER IS RESPONSIBLE FOR THE PURCHASE (OTHER THAN OWNER SUPPLIED EQUIPMENT), RIGGING, ERECTION, INSTALLATION AND FUNCTIONAL OPERATION OF ALL ELECTRICAL EQUIPMENT EXCEPT WHERE NOTED.
- 3. ALL LOCATIONS OF EQUIPMENT AND FIXTURES ARE APPROXIMATE AND MAY REQUIRE MINOR ADJUSTMENT TO SUIT FIELD CONDITIONS. ALL ADJUSTMENTS SHALL

IDENTIFICATIONS

- 1. COMPLY WITH GOVERNING REGULATIONS AND REQUESTS OF GOVERNING AUTHORITIES FOR IDENTIFICATION OF ELECTRICAL WORK.
- 2. PROVIDE NAMEPLATES/LABELS FOR ITEMS WHERE INDICATED AND/OR DESCRIBED IN THESE SPECIFICATIONS.
- 3. ALL ELECTRICAL DISTRIBUTION EQUIPMENT SHALL BE LABELED.
- 4. LABELS SHALL BE ENGRAVED PHENOLIC TAGS WITH MINIMUM .5" TEXT HEIGHT. DYMO (OR EQUIVALENT) LABELS SHALL NOT BE USED.
- 5. COLOR CODE: ALL POWER EQUIPMENT— BLUE FIELD WITH WHITE LETTERS.
- 6. TAGS SHALL BE PERMANENTLY AFFIXED WITH SCREWS, ADHESIVES ARE NOT ACCEPTABLE.
- 7. ALL POWER RECEPTACLES SHALL HAVE CIRCUIT ID LABEL. THIS LABEL SHALL BE A CLEAR LAMINATED MYLAR TYPE TAPE, WITH .25" BLACK LETTERING, LABEL SHALL BE APPLIED HORIZONTAL POSITION ON THE TOP OF RECEPTACLE FACEPLATE.

PANEL BOARDS

- 1. PANEL BOARDS ARE EXISTING.
- 2. ANY NEW BRANCH CIRCUIT BREAKERS SHALL BE BOLT-ON TYPE AND SHALL BE OF THE AMBIENT COMPENSATED, THERMAL MAGNETIC TYPE, WHICH WILL PROVIDE INVERSE TIME DELAY OVERLOAD AND INSTANTANEOUS SHORT CIRCUIT PROTECTION. VOLTAGE AND CURRENT RATINGS SHALL BE AS INDICATED ON THE DRAWINGS. NEW DEVICES SHALL BE SAME MANUFACTURER AS THE PANEL BOARD.
- 3. PROVIDE NEW TYPEWRITTEN DIRECTORY FOR EACH PANEL THAT HAS BEEN MODIFIED. PLACED INSIDE THE PANEL DOOR. DIRECTORIES SHALL BE INSTALLED IN A METAL DIRECTORY FRAME WITH CLEAR PROTECTIVE COVER. SPARES AND SPACES SHALL BE
- 4. CIRCUIT BREAKERS SHALL BE MANUFACTURED BY THE MANUFACTURER OF THE PANEL BOARDS. THERE SHALL BE NO EXCEPTION TO THIS.

DEVICE LOCATIONS

1. UNLESS SPECIFICALLY INDICATED ON THE DRAWINGS OR OTHERWISE INSTRUCTED BY THE ARCHITECT ELECTRICAL OUTLETS SHALL HAVE THE FOLLOWING MOUNTING HEIGHTS. DIMENSIONS ARE TO CENTER OF BOX UNLESS OTHERWISE NOTED:

WALL SWITCHES WALL CONVENIENCE RECEPTACLES WALL TELEPHONE OUTLETS WALL OUTLETS FOR WALL MTD. TELEPHONE * MANUAL FIRE ALARM PULL STATIONS FIRE ALARM SPEAKER/HORN

PUSH BUTTONS

ADA VISUAL ALARM

16" AFF TO BOTTOM OF BOX 16" AFF TO BOTTOM OF BOX

1'-0" BELOW CEILING, OR IN CEILING, AS REQUIRED INTERIOR BELLS, BUZZERS, HORNS 1'-0" BELOW CEILING, OR IN CEILING, AS REQUIRED SPECIAL PURPOSE WALL OUTLETS 16" AFF TO BOTTOM OF BOX (OR HIGHER AS REQUIRED TO SERVE EQUIPMENT)

> 80" AFF TO BOTTOM OF LENS OR 6" BELOW CEILING, WHICHEVER IS LOWER. ENTIRE LENS TO BE WITHIN 80" TO 96"

* TOP OF BOX SHALL BE 48" AFF MAX. FOR WHEELCHAIR FRONTAL APPROACH AND 54" AFF MAX. FOR SIDE APPROACH. VERIFY EXACT HEIGHT WITH ARCHITECT. AFF = ABOVE FINISHED FLOOR

2. UNLESS SPECIFICALLY INDICATED ON THE ELECTRICAL DRAWINGS, OUTLETS LOCATED AT COUNTERS AND CABINETS SHALL BE MOUNTED AS SHOWN ON ARCHITECTURAL DETAILS AND ELEVATIONS, OR AS DIRECTED

AFG = ABOVE FINISHED GRADE

3. COORDINATE MOUNTING HEIGHTS AND DETAILS OF ALL OUTLETS (POWER, SIGNAL, ETC.) WITH ARCHITECTURAL CASEWORK DRAWINGS PRIOR TO DIVISION 16 ROUGH-IN. OBTAIN APPROVAL FROM ARCHITECT BEFORE ELECTRICAL ROUGH-IN WHEN CONFLICTS ARISE.

BASIS OF DRAWINGS

THESE ELECTRICAL DRAWINGS HAVE BEEN PREPARED BASED UPON AS-BUILT INFORMATION FURNISHED BY OTHERS. WHILE THIS INFORMATION IS BELIEVED TO BE RELIABLE, THE ENGINEER CANNOT ASSURE ITS ACCURACY. THOSE RELYING ON THIS RECORD DOCUMENT ARE ADVISED TO OBTAIN INDEPENDENT VERIFICATION OF ITS ACCURACY BEFORE APPLYING IT FOR ANY PURPOSE.

PROJECT OWNER:

REVISIONS



Orlando, Florida 32819

PROJECT:

WESTGATE RESORTS LAKE CITY 131 SW WEBBS GLEN LAKE CITY, FL. 32024



Digitally signed by Brian Buholt DN: cn=Brian Buholtz, o=Buholtz Professional Engineering, Inc., o email=bbuholtz@buholtz.com, Date: 2013.12.31 11:40:41 -05'00'


12.27.2013


AS NOTED

SHEET TITLE

ELECTRICAL-**SPECIFICATIONS**

SHEET NUMBER

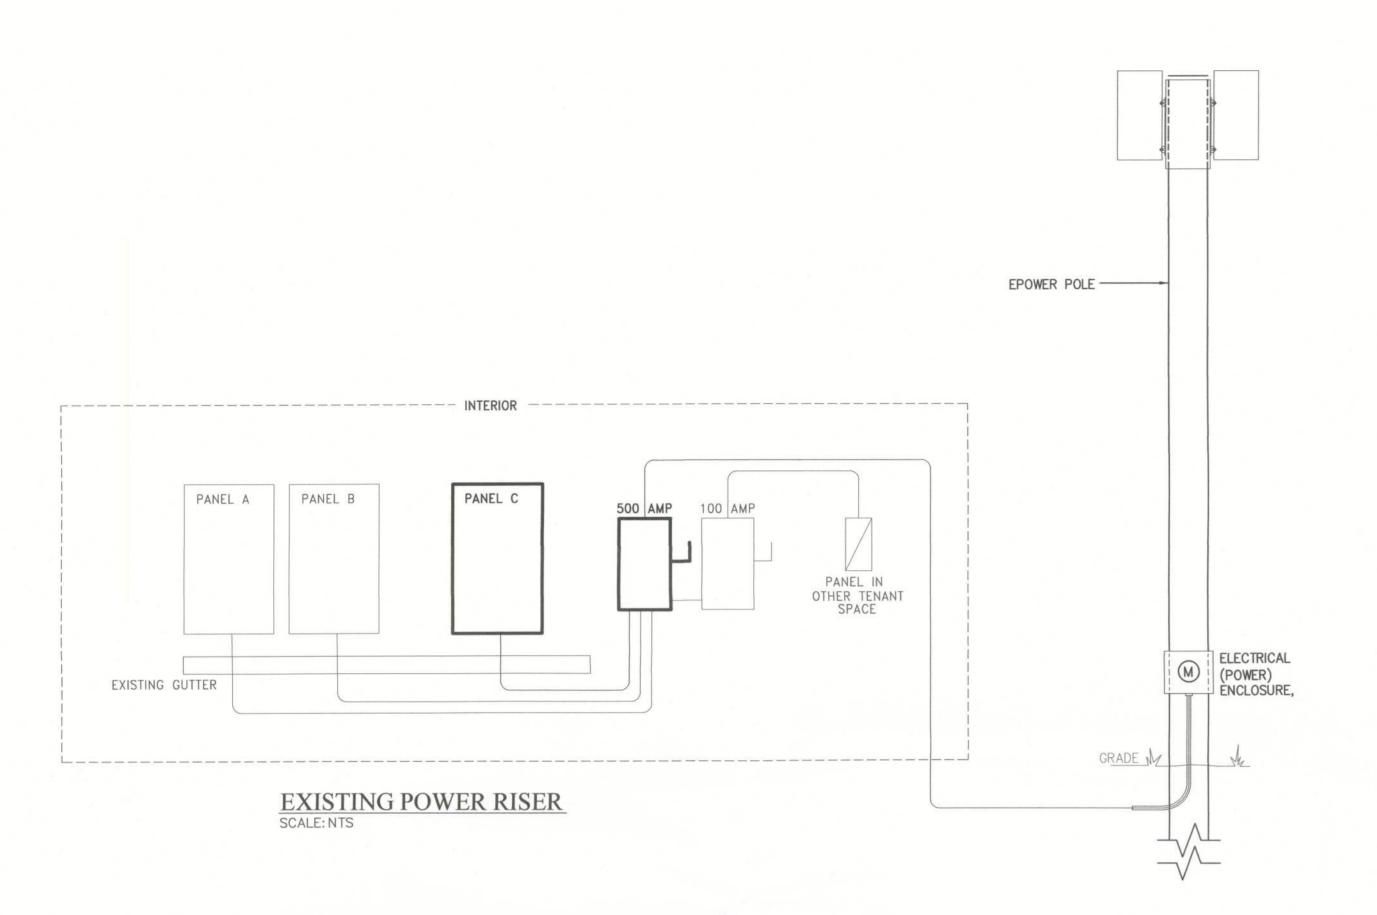

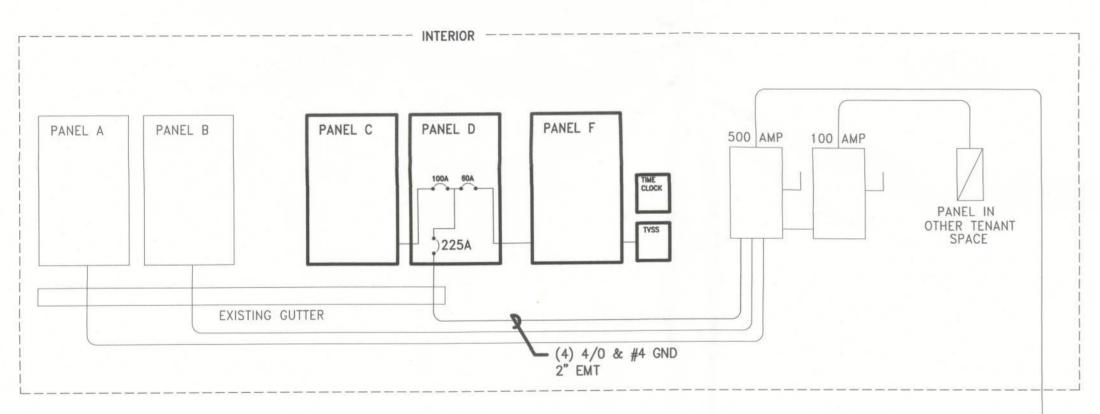

REVISED POWER RISER
SCALE: NTS

BUHOLTZ PROFESSIONAL ENGINEERING, INC.

110 S. MAGNOLIA AVE., SANFORD, FL 32771 Ph 407-330-4888 Fx 407-330-4888

CA 000009600

Brian Buholtz, PE CA 0000057979



5601 Windhover Drive Orlando, Florida 32819

PROJECT:

WESTGATE RESORTS LAKE CITY (OPC)

131 SW WEBBS GLEN LAKE CITY, FL. 32024

SEAL



Digitally signed by
Brian Buholtz
DN: cn=Brian
Buholtz, o=Buholtz
Professional
Engineering, Inc., ou,
email=bbuholtz@bu
holtz.com, c=US
Date: 2013.12.31
11:41:28 -05'00'

DATE: 12.27.2013


SCALE: AS NOTED


SHEET TITLE

ELECTRICAL-PARTIAL FLOOR PLAN

SHEET NUMBER

E0.02

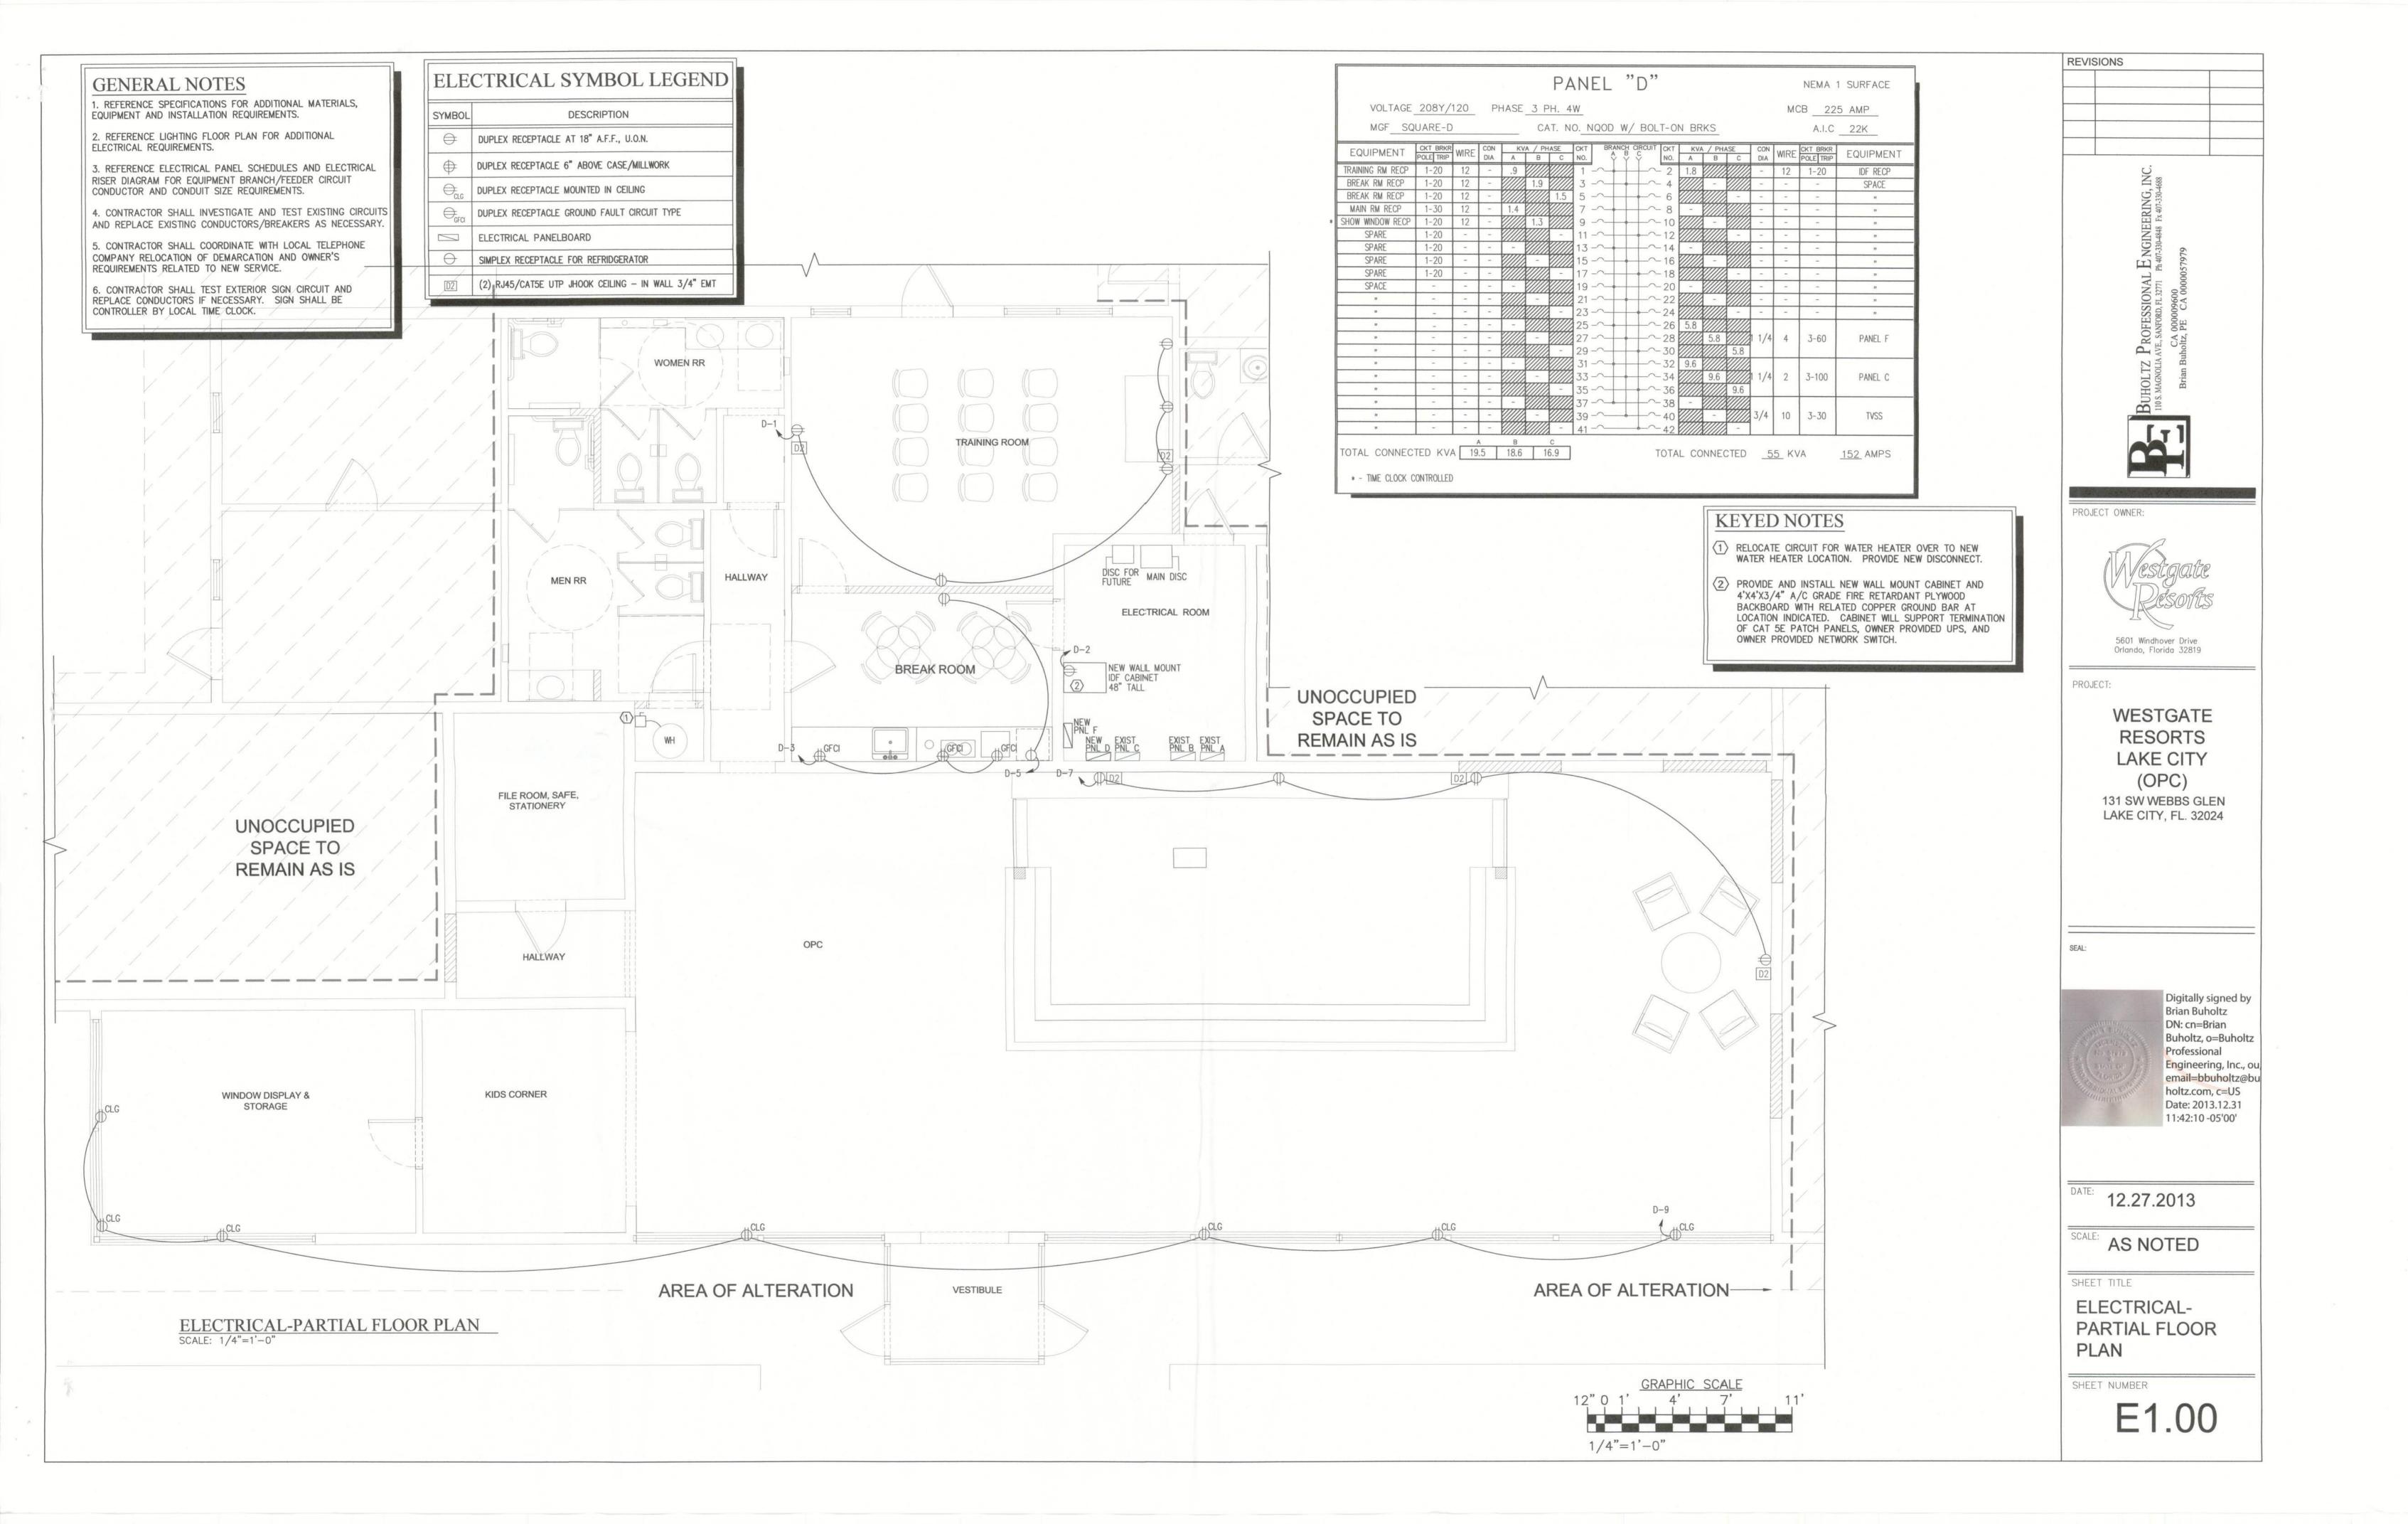

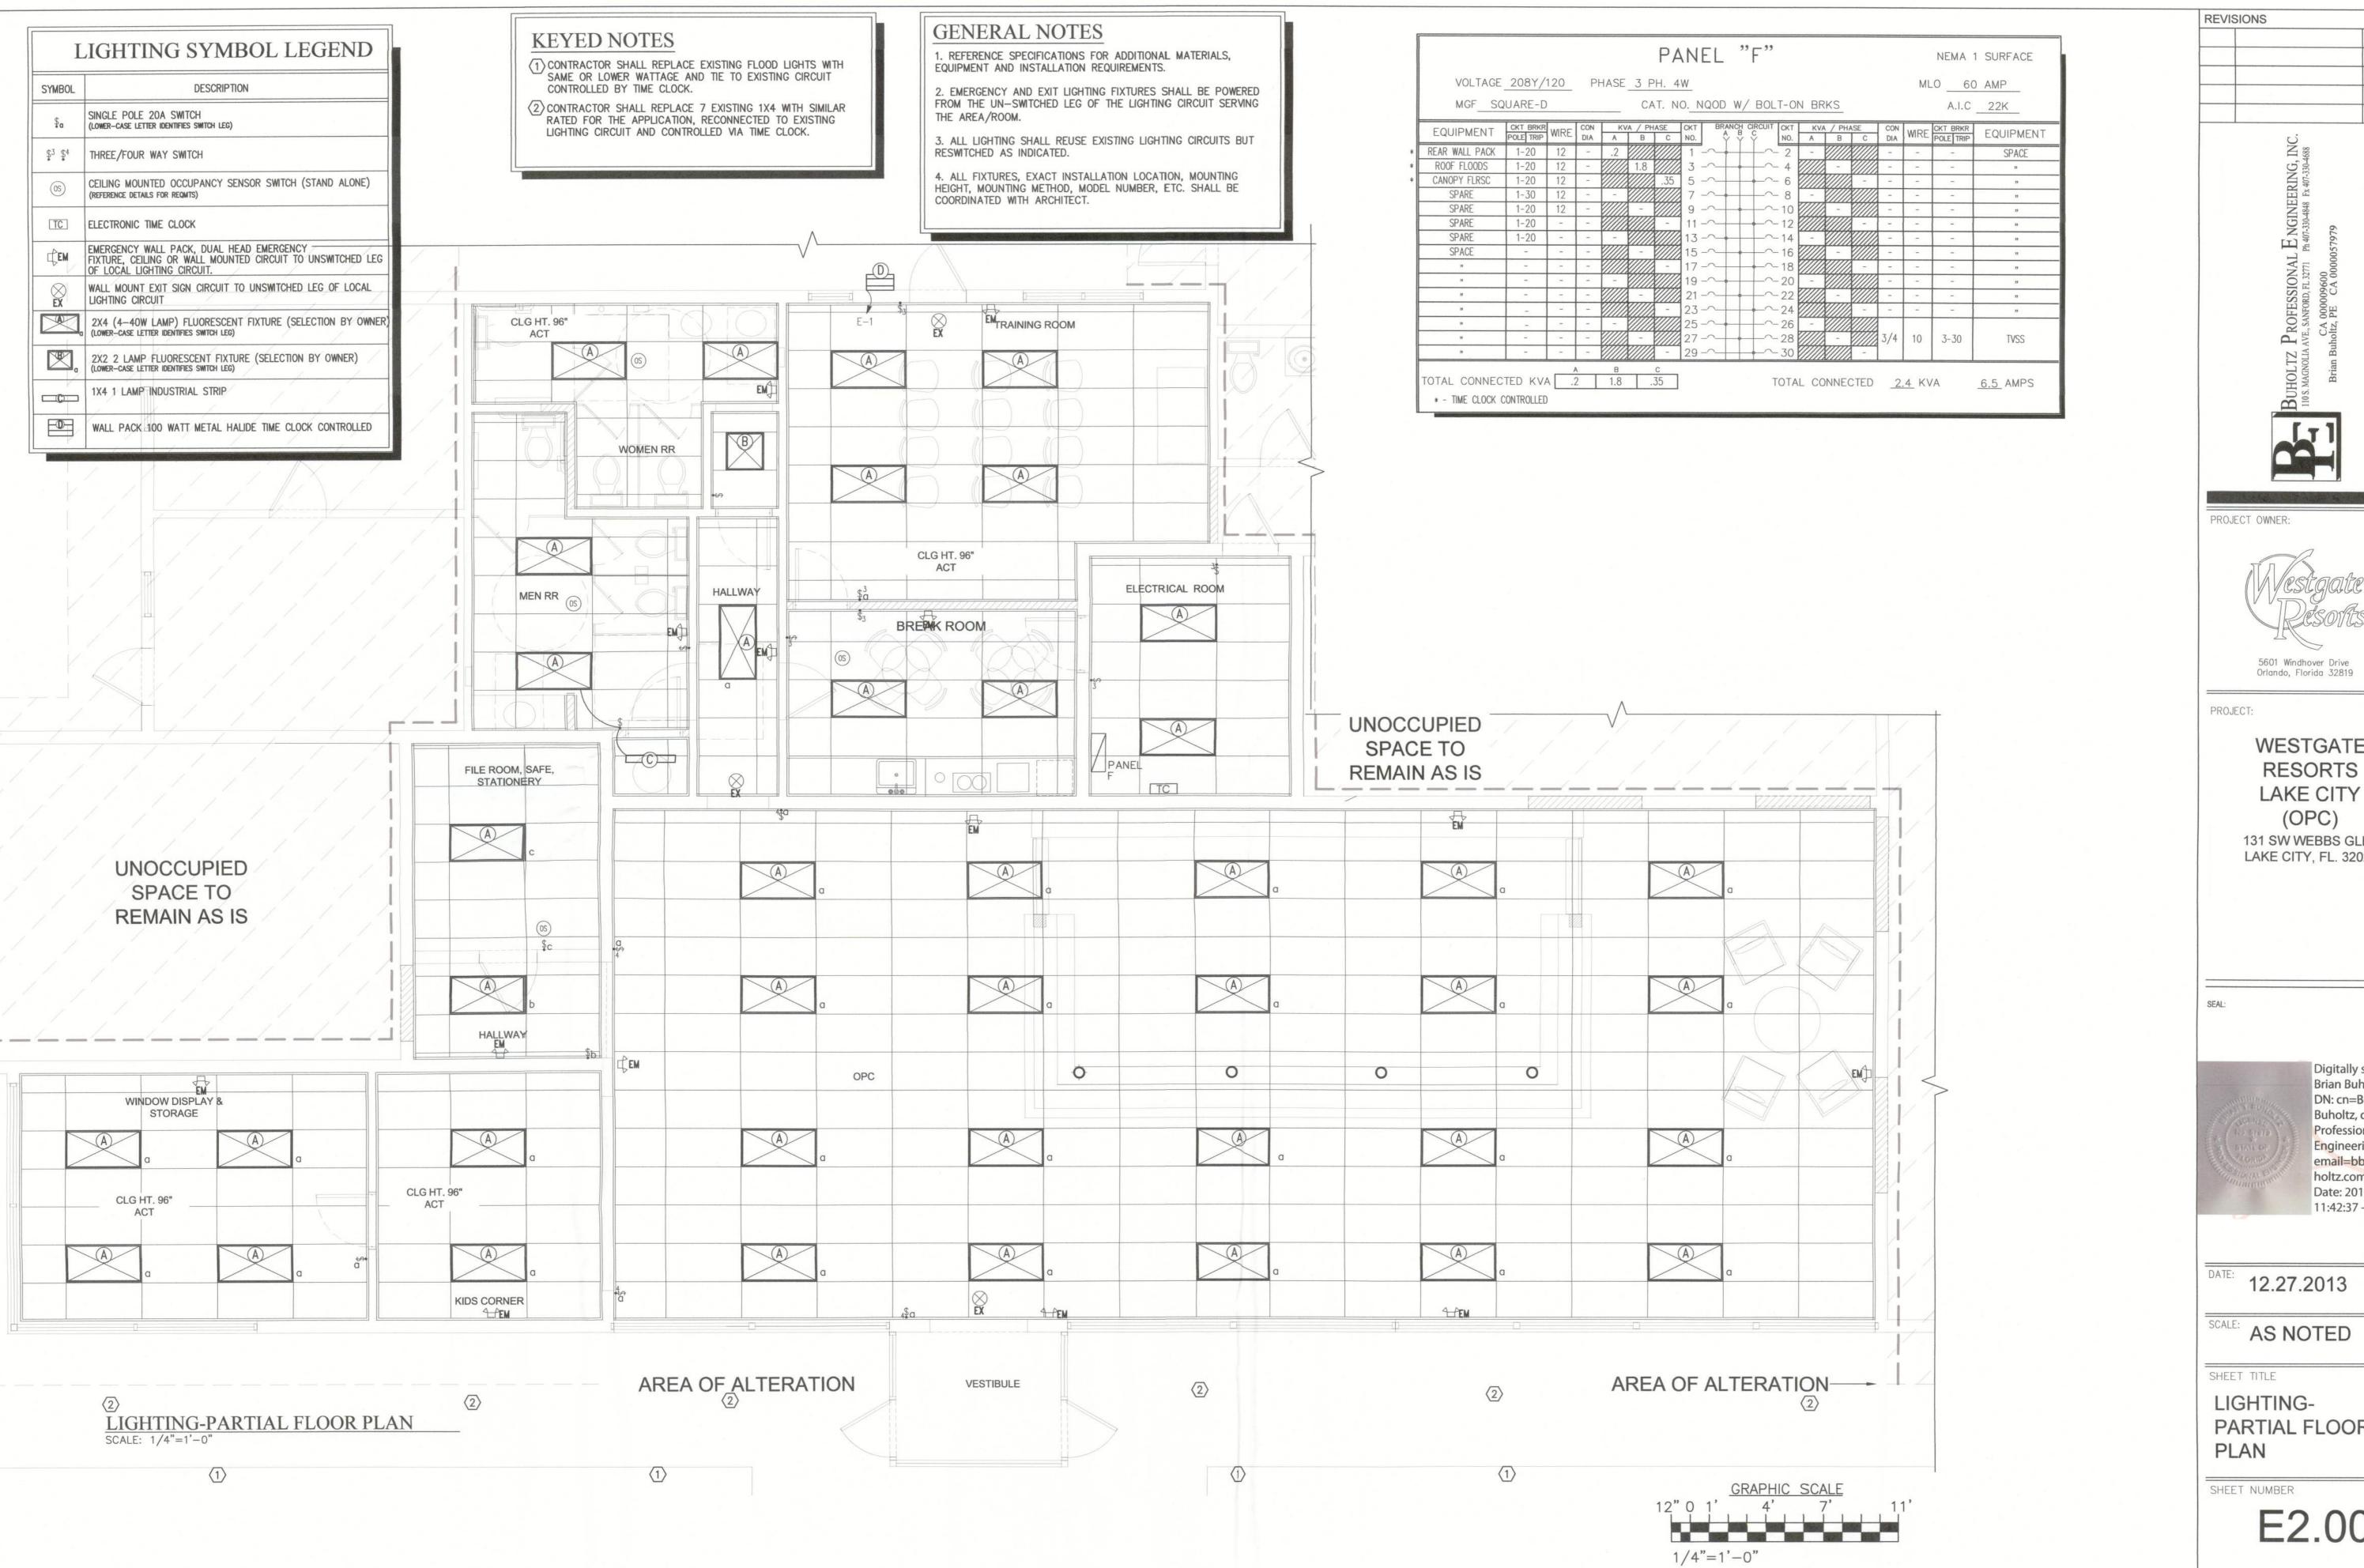

REVISIONS PROJECT OWNER: 5601 Windhover Drive Orlando, Florida 32819 WESTGATE **RESORTS** LAKE CITY 131 SW WEBBS GLEN LAKE CITY, FL. 32024




Digitally signed by Brian Buholtz DN: cn=Brian Buholtz, o=Buholtz Professional Engineering, Inc., ou email=bbuholtz@bu holtz.com, c=US Date: 2013.12.31 11:42:37 -05'00'

LIGHTING-PARTIAL FLOOR **PLAN**

SHEET NUMBER

E2.00

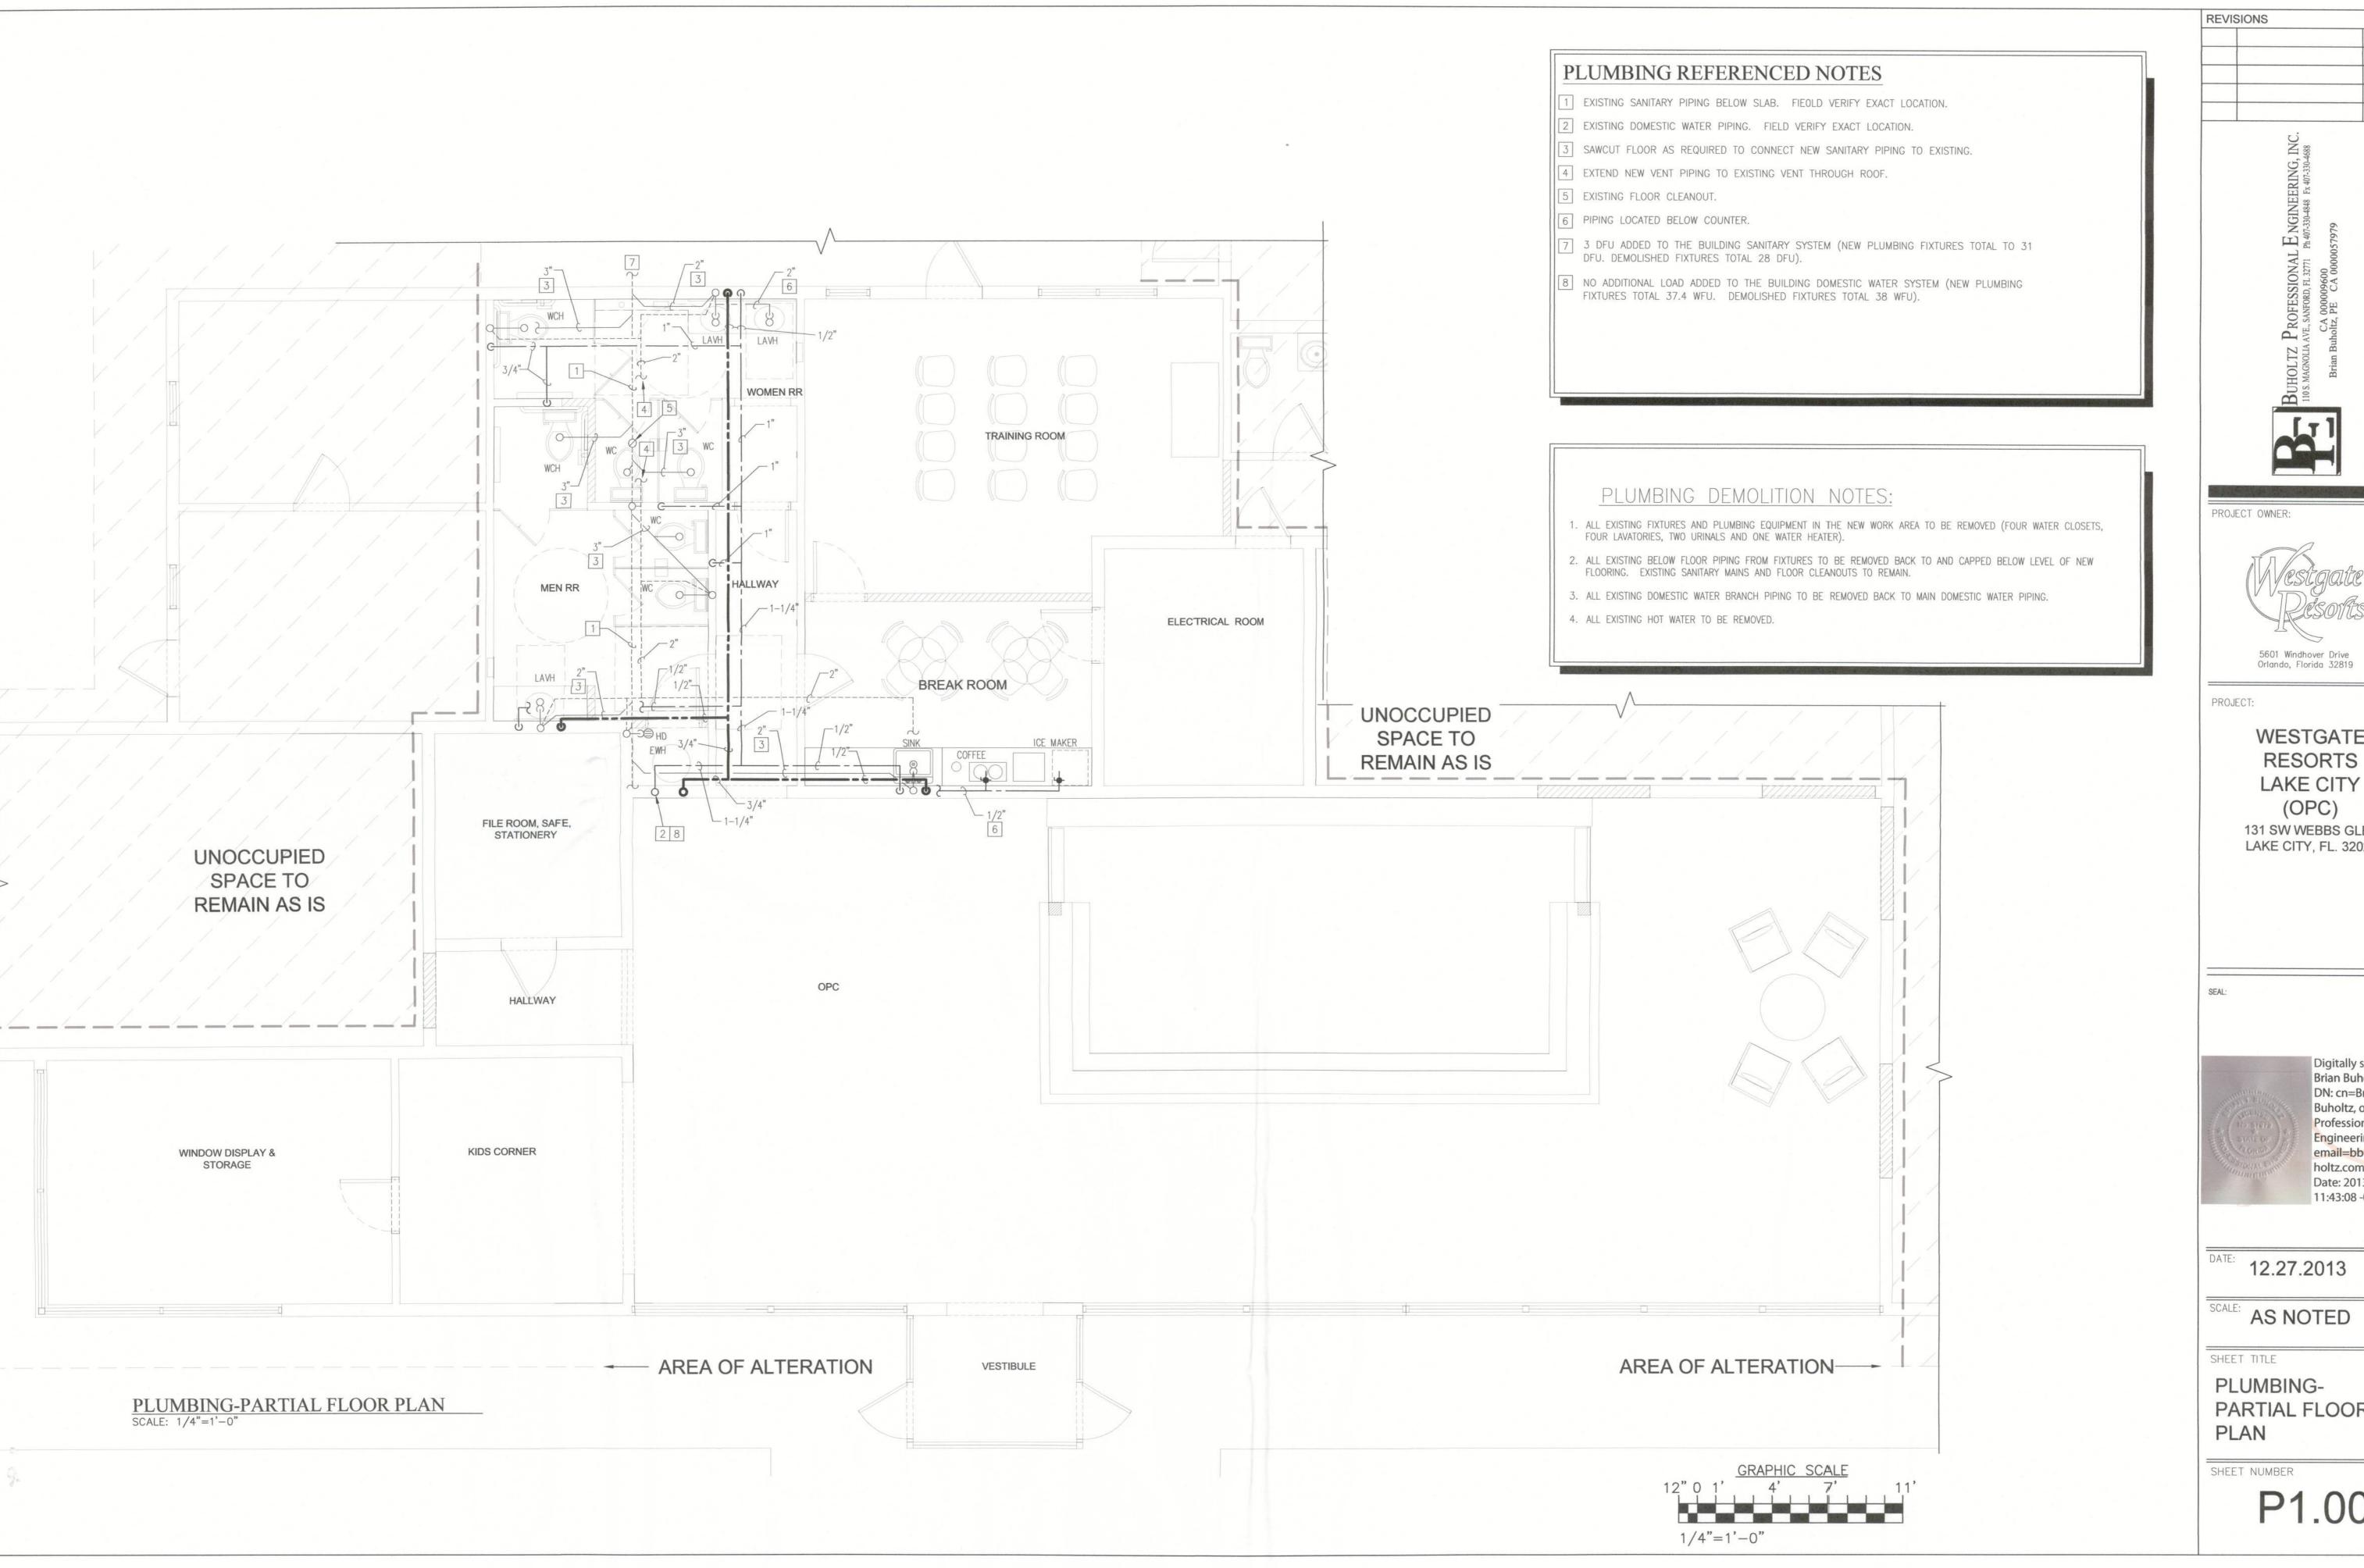



5601 Windhover Drive Orlando, Florida 32819

WESTGATE **RESORTS** LAKE CITY (OPC) 131 SW WEBBS GLEN LAKE CITY, FL. 32024



Digitally signed by Brian Buholtz DN: cn=Brian Buholtz, o=Buholtz Professional Engineering, Inc., ou email=bbuholtz@bu holtz.com, c=US Date: 2013.12.31 11:43:08 -05'00'

PLUMBING-PARTIAL FLOOR

P1.00

PLUMBING FIXTURES SCHEDULE

			WATER	SUPPLY			
MARK	DESCRIPTION	BRAN	NCH	FIXTU	JRE	TRAP	VENT
		COLD	НОТ	COLD	НОТ		
WC	WATER CLOSET (FLUSH TANK)	3/4"	-	1/2"	_	INTEGRAL	-
WCH	ADA WATER CLOSET (FLUSH TANK)	3/4"	-	1/2"	<u> </u>	INTEGRAL	-
LAVH	ADA LAVATORY	1/2"	1/2"	-	-	1 1/4"	

- WC: REFER TO ARCHITECTURAL PLANS FOR MAKE AND MODEL.
- WCH: REFER TO ARCHITECTURAL PLANS FOR MAKE AND MODEL.
- LAVH: REFER TO ARCHITECTURAL PLANS FOR MAKE AND MODEL. PROVIDE FULL ADA INSULATION KIT FOR WATER SUPPLY & P-TRAP.
- SINK: REFER TO ARCHITECTURAL PLANS FOR MAKE AND MODEL.
- EWH: ELECTRIC WATER HEATER, EQUIVALENT TO LOCHINVAR ETX040KD WITH 208V/3Ø, 4500 W ELEMENTS.

PLUMBING FIXTURE NOTES:

- 1. ALL PLUMBING FIXTURES SHOWN ON PLANS ARE TO BE FURNISHED AND INSTALLED BY PLUMBING CONTRACTOR (UNLESS NOTED OTHERWISE). FIXTURES SHALL BE COMPLETE WITH ALL PIPING & CONNECTIONS AND BE READY FOR OPERATION.
- 2. ALL FIXTURES SHALL BE PROVIDED WITH STOPS, PLACED IN AN ACCESSIBLE LOCATION.
- 3. THE HEIGHTS OF FIXTURES SHALL BE AS SCHEDULED AND/OR DIRECTED BY A/E PRIOR TO INSTALLATION. HANDICAPPED FIXTURES TO BE MOUNTED AT HEIGHTS ACCEPTABLE TO LOCAL CODES.
- 4. SUPPORTS SHALL BE PROVIDED BY PLUMBING CONTRACTOR FOR ALL WALL HUNG PLUMBING FIXTURES. COORDINATE INSTALLATION WITH OTHER TRADES.
- 5. SEAL JOINTS BETWEEN FIXTURES AND WALLS.
- 6. INSTALL PLUMBING FIXTURES IN STRICT ACCORDANCE WITH MANUFACTURER'S RECOMMENDATIONS.
- 7. PLUMBING CONTRACTOR SHALL SUBMIT SHOP DRAWINGS ON ALL PLUMBING FIXTURES, SUPPORTS AND ACCESSORIES TO A/E FOR APPROVAL.

)R	A 11	N1	0	0		1	ĺ
IK	All	V	71		-		

MARK	SELECTION BA			OUTLET SIZE	TOP	REMARKS
IVII SI SI S	MAKE	MODEL	DIM.	PIPE CONN.	MATERIAL	
HD	ZURN	#Z-415-S	5" ROUND	2"	NICKEL BRONZE	STRAINER WITH INTEGRAL BASKET

NOTES:

- 1. ALL FLOOR DRAINS CONNECTED TO THE SANITARY SYSTEM SHALL BE TRAPPED AND EQUIPPED WITH A TRAP GUARD.
- 2. CONTRACTOR SHALL SUBMIT SHOP DRAWINGS ON ALL DRAINS & DEVICES TO THE A/E FOR REVIEW AND APPROVAL.

WATER HAMMER ARRESTOR SCHEDULE

MARK	A	В	C	D	E	F
MAXIMUM FIXTURE UNITS	11	32	60	113	154	330
MAXIMUM PRESSURE RATING			65	PSI		

NOTES:


WHEN WORKING WATER PRESSURE EXCEEDS 65 PSI, USE NEXT LARGEST SIZE.
 MAXIMUM PIPING LENGTH COVERED BY ONE ARRESTOR SHALL BE 20 LINEAR FEET.
 SIZING AND PLACEMENT SHALL BE IN ACCORDANCE WITH PDI STANDARD PDI-WH 2011.
 FIELD FABRICATED AIR CHAMBERS ARE NOT ACCEPTABLE AS SHOCK ABSORBERS.

PLUMBING GENERAL NOTES:


- 1. VISIT AND CAREFULLY EXAMINE THOSE PORTIONS OF THE BUILDING AND SITE AFFECTED BY THIS WORK BEFORE SUBMITTING PROPOSALS, SO AS TO BECOME FAMILIAR WITH EXISTING CONDITIONS AND DIFFICULTIES THAT WILL AFFECT EXECUTION OF THE WORK. SUBMISSION OF A PROPOSAL WILL BE CONSTRUED AS EVIDENCE THAT SUCH EXAMINATION HAS BEEN MADE AND LATER CLAIMS FOR LABOR, EQUIPMENT OR MATERIALS REQUIRED BECAUSE OF DIFFICULTIES ENCOUNTERED WILL NOT BE RECOGNIZED.
- 2. ALL WORK SHALL COMPLY WITH APPLICABLE CODES AND STANDARDS.
- 3. PRIME CONTRACTOR IS RESPONSIBLE TO HAVE LICENSED AND QUALIFIED SUBCONTRACTORS PERFORMING ALL WORK.
- 4. VERIFY EXISTING CONDITIONS IN FIELD AND COORDINATE WITH ALL TRADES PRIOR TO FABRICATING OR INSTALLING EQUIPMENT.
- 5. ALL WORK SHALL BE CONSTRUCTED TO MEET THE PHASING REQUIREMENTS OF THE PROJECT AS OUTLINED IN THE DRAWINGS AND SPECIFICATIONS, OR AS DICTATED BY THE OWNER AND/OR ARCHITECT.
- PRIOR TO BID, CHECK LEAD TIMES OF ALL EQUIPMENT IN THE PROJECT. IF NECESSARY TO MEET THE PROJECT SCHEDULE, BID SHALL INCLUDE THE COST TO ACCELERATE DELIVERY OF CRITICAL MATERIALS AND EQUIPMENT. ALLOW TIME FOR NORMAL SHOP DRAWING PREPARATION AND REVIEW.
- 7. CONTRACTOR SHALL NOT CONCEAL ANY WORK UNTIL INSPECTED BY MECHANICAL INSPECTOR AND ENGINEER.
 CONTRACTOR SHALL NOTIFY ENGINEER OF A SCHEDULED INSPECTION TIME WITHIN 72 HOURS. GENERAL CONTRACTOR SHALL NOT CONCEAL WORK UNTIL APPROVED, REGARDLESS OF SCHEDULE.
- 8. ALL CHANGES MADE IN THE FIELD SHALL BE RECORDED BY THE CONTRACTOR(S) ON AS-BUILT DRAWINGS, SHOP DRAWINGS, AND IN MAINTENANCE MANUALS.
- 9. DRAWINGS ARE DIAGRAMMATIC IN NATURE. COORDINATE EXACT LOCATION OF ALL EQUIPMENT MOUNTED IN CEILING CAVITY SO ALL SERVICEABLE COMPONENTS CAN BE EASILY ACCESSED BY REMOVING CEILING TILES ONLY. REMOVAL OR RELOCATION OF LIGHTING FIXTURES FOR SERVICE ACCESS IS NOT ACCEPTABLE. THE CONTRACTOR SHALL REINSTALL EQUIPMENT THAT HAS INADEQUATE OR UNSAFE ACCESSIBILITY. LOCATE ALL EQUIPMENT WITH MANUFACTURER RECOMMENDED ACCESS FOR OPERATION AND MAINTENANCE.
- 10. PRIOR TO BID, COORDINATE ALL PLUMBING WORK WITH ELECTRICAL WORK AND OTHER TRADES.
- 11. WHERE CROWDED LOCATIONS EXIST OR WHERE THERE IS A POSSIBILITY OF CONFLICT BETWEEN TRADES, CONTRACTOR SHALL MAKE COMPOSITE DRAWINGS SHOWING THE EXACT LOCATION OF PIPES, DUCTS, CONDUIT AND EQUIPMENT. DRAWINGS SHALL BE BASED ON FIELD MEASUREMENTS AND, AFTER CONSULTATION AND AGREEMENT BETWEEN THE TRADES, SHALL BE APPROVED BY THE ENGINEER PRIOR TO INSTALLATION OF THE WORK.
- 12. NOTIFY ENGINEER OF ANY CONFLICTS PRIOR TO PURCHASING EQUIPMENT AND PRIOR TO CUTTING OPENINGS.
- 13. PROVIDE ACCESS PANELS IN WALLS AND CEILINGS WHERE REQUIRED FOR OPERATION, INSPECTION AND MAINTENANCE OF ALL EQUIPMENT AND VALVES.
- 14. SLEEVE ALL PIPES PASSING THRU FLOORS, WALLS & DECKS. SLEEVES PASSING THRU FIRE STOPS SHALL BE SEALED & CAULKED.
- 15. CONTRACTOR SHALL BE RESPONSIBLE FOR PROVIDING ALL NECESSARY FITTINGS AS REQUIRED BY ALL APPLICABLE CODES AND GOVERNING AUTHORITIES.
- 16. CONTRACTOR SHALL VERIFY AND CORRECT AS REQUIRED TO MEET ALL CODES AND REGULATIONS ANY POSSIBLE DISCREPANCIES BETWEEN TYPE AND SIZE OF CONNECTION SPECIFIED IN PLUMBING FIXTURE SCHEDULE AND FIXTURES ACTUALLY INSTALL ON THE SITE.
- 17. SANITARY PIPING 3" OR SMALLER SHALL BE SLOPED MINIMUM 1/4" PER FOOT, 4" AND LARGER SLOPED 1/8" PER FOOT.
- 18. VALVES AND FITTINGS SHALL BE OF SAME SIZE OF LINE ON WHICH THEY ARE LOCATED, UNLESS OTHERWISE INDICATED ON DRAWINGS
- 19. CONTRACTOR SHALL FIELD VERIFY ALL GIVEN MEASUREMENTS PRIOR TO LAYING AND CONNECTING ALL SANITARY AND WASTE PIPING AND NOTIFY ARCHITECT OF ANY DISCREPANCIES.
- 20. AIR CHAMBERS SHALL NOT BE CONSIDERED AN EQUAL TO WATER ARRESTORS AS SPECIFIED.
- 21. CONTRACTOR SHALL BE RESPONSIBLE FOR MAINTAINING FIRE RATING AND WEATHERPROOFING INTEGRITY OF ALL PIPING AND PENETRATIONS.
- 22. ALL WATER SUPPLY AND SANITARY LINES SHALL BE RUN AS CLOSE TO PLANS AS POSSIBLE WITH NO CHANGES IN
- 23. CONTRACTOR SHALL BE RESPONSIBLE FOR PROVIDING ALL NECESSARY SUPPORTING DEVICES FOR ALL FIXTURES INCLUDED IN CONTRACT OR HEREIN SPECIFIED OR OTHERWISE.
- 24. CHANGES IN THE DIRECTION OF SANITARY AND STORM DRAIN PIPING SHALL NOT BE MADE WITH FITTING'S WHICH WILL CAUSE EXCESSIVE REDUCTION IN THE VELOCITY OF FLOW OR CREATE ANY OTHER ADVERSE EFFECT UNILESS PHYSICALLY IMPOSSIBLE (I.E. USE OF SANITARY TEE IN A HORIZONTAL CONNECTION, USE OF A DOUBLE SANITARY TEE IN A VERTICAL STACK, IN GENERAL, USE OF A SHORT—RADIUS FITTINGS FOR BRANCH TO HOUSE DRAIN OR STACK CONNECTION).
- 25. CONTRACTOR SHALL GIVE 24 HOURS NOTICE TO APPLICABLE UTILITY COMPANY PRIOR TO PERFORMING WORK INVOLVING UTILITIES.
- 26. ALL SANITARY, STORM AND WATER SUPPLY LINES SHALL BE MARKED WITH THE SEAL OF APPROVAL OF THE NATIONAL SANITATION FOUNDATION.
- 27. ALL FLOOR DRAINS SHALL BE PROVIDED WITH DEEP SEAL TRAPS AND FITTINGS UNLESS NOTED OTHERWISE.
- 28. ROUTE ALL PIPING CONCEALED ABOVE CEILINGS, WITHIN WALLS, OR IN CHASES EXCEPT AS SPECIFICALLY NOTED, OR IN MECHANICAL ROOMS.
- 29. INSTALL WATER HAMMER SHOCK ARRESTORS AT EACH FIXTURE OR BATTERY OF FIXTURES WHERE REQUIRED.

 ARRESTORS SHALL BE FACTORY FABRICATED. INSTALL ARRESTORS AND SIZE PER PLUMBING AND DRAINAGE INSTITUTE

 STANDARD P.D.I. WH—201. ACCEPTABLE MANUFACTURERS: ZURN, JOSAM, JAY R. SMITH.
- 30. SEE ARCHITECTURAL DRAWINGS FOR EXACT PLUMBING FIXTURE LOCATIONS, MOUNTING HEIGHTS, AND DIMENSIONS.
- 31. CONTRACTOR SHALL INSTALL DIELECTRIC UNIONS AT CONNECTIONS OF DISSIMILAR METALS.
- 32. CONTRACTOR SHALL SUBMIT SHOP DRAWINGS (INCLUDING PIPE ROUTING AND EQUIPMENT LOCATIONS) TO ARCHITECT/ENGINEER FOR REVIEW PRIOR TO THE INSTALLATION OF PURCHASING OF ANY PIPING AND/OR EQUIPMENT.
- 33. COORDINATE EXACT LOCATION OF FLOOR DRAINS FOR HVAC EQUIPMENT WITH MECHANICAL CONTRACTOR!.
- 34. PROVIDE 1/2" C.W. SUPPLY WITH ANGLE STOP AND FLEXIBLE SUPPLY TO REFRIGERATORS WITH ICE MAKERS AT HEIGHT REQUIRED BY MANUFACTURER OF EQUIPMENT INSTALLED.

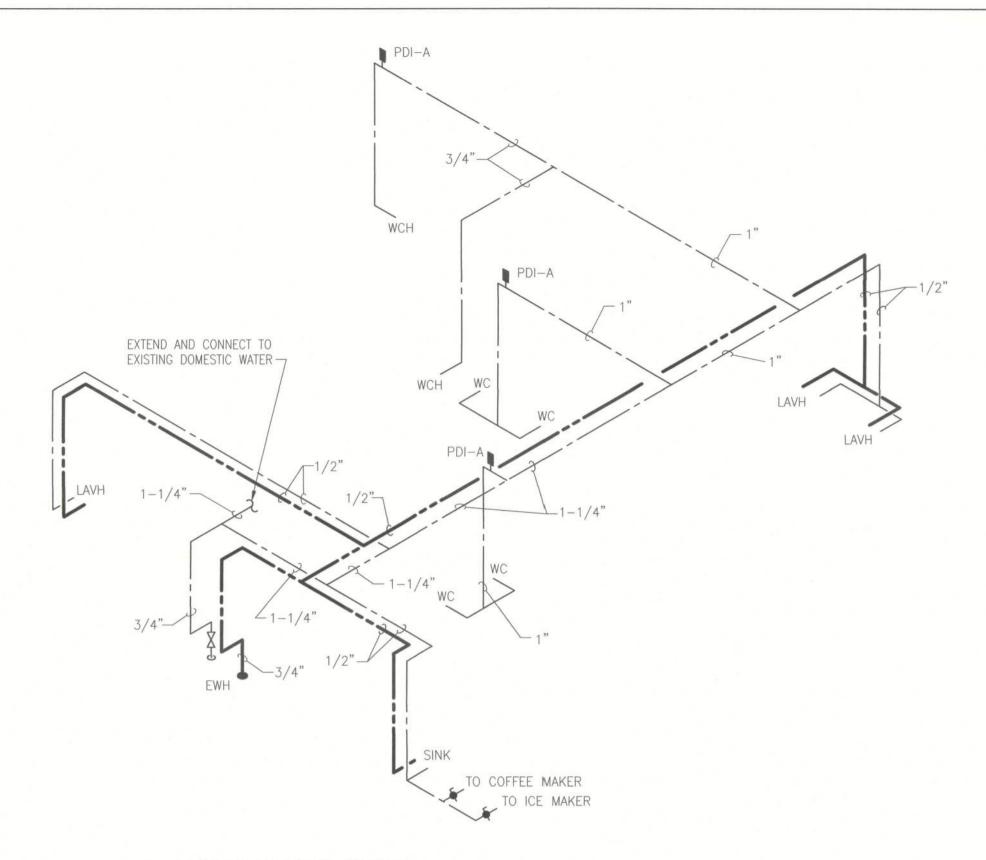

DOMESTIC WATER RISER SCALE: NO SCALE

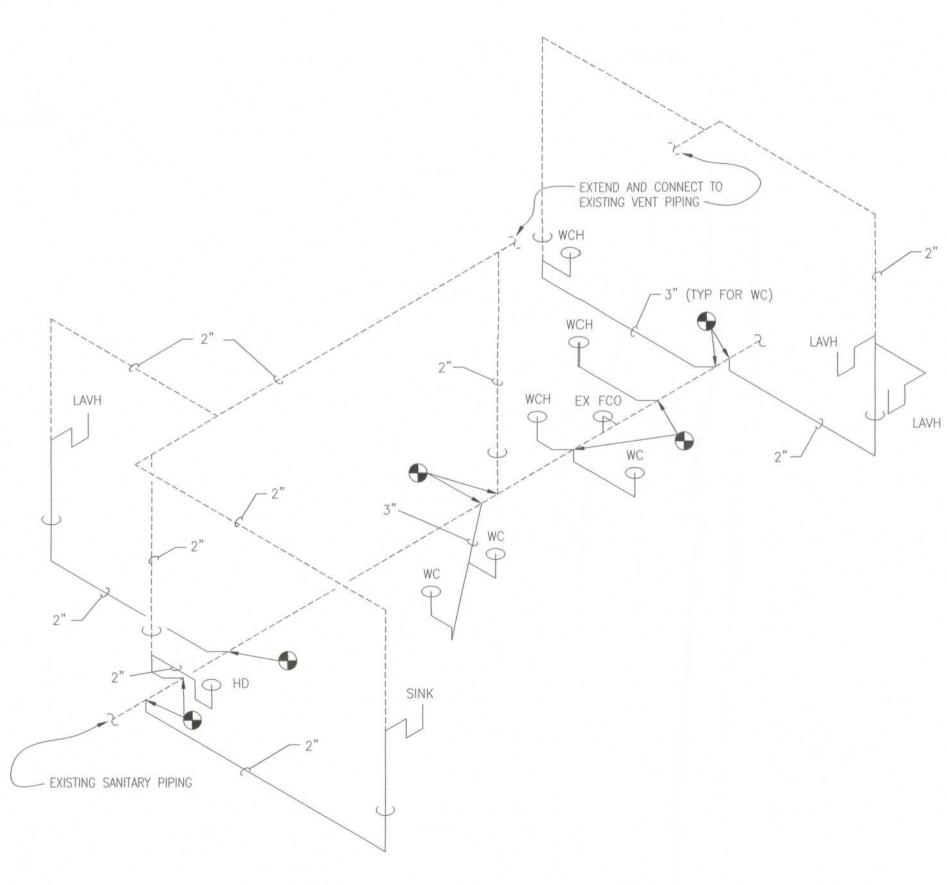

WASTE AND VENT RISER

REVISIONS

BUHOLTZ PROFESSIONAL E NGINEERIN
110 S. MAGNOLIA AVE., SANFORD, FL 32771 Ph 407-330-4848 Fx 407CA 000009600
Brian Buholtz, PE CA 0000057979

PROJECT OWNER:



5601 Windhover Drive Orlando, Florida 32819

PROJECT:

WESTGATE
RESORTS
LAKE CITY
(OPC)

131 SW WEBBS GLEN
LAKE CITY, FL. 32024

SEA



Digitally signed by
Brian Buholtz
DN: cn=Brian
Buholtz, o=Buholtz
Professional
Engineering, Inc., ou
email=bbuholtz@bu
holtz.com, c=US
Date: 2013.12.31
11:44:51-05'00'

12.27.2013

SCALE: AS NOTED

SHEET TITLE

PLUMBING-RISERS AND SCHEDULES

SHEET NUMBER

P2.00