ODE CRITERIA:

IE CONTRACTOR/MANUFACTURER SHALL COMPLY TH THE FOLLOWING CODES AND ALL APPLICABLE JENDMENTS/SUPPLEMENTS:

. FIRE PREVENTION CODE, 6TH EDITION

ROJECT NOTE

IS BUILDING IS NOT DESIGNED FOR HUMAN ABITATION AND DOES NOT HAVE WATER, SEWER, ECTRICAL OR HVAC SYSTEMS. THIS BUILDING IS SIGNED AS A MINOR STORAGE OCCUPANCY ONLY.

UILDING ADDRESSES: 3S PORTABLE BUILDINGS, LLC 555 SAILOR ROAD

REOLA, AL 36525

37 RELIHAN STREET SARSON, GA 31642 RACELAND PORTABLE BUILDINGS, LLC

ENERAL NOTES

DITION. TH THE 2017 FLORIDA BUILDING CODE, 6TH

ALL MATERIALS AND LABOR SHALL BE IN SCORDANCE WITH THE ABOVE CODE AND ALL OTHER PLICABLE LOCAL CODES AT THE TIME OF NUFACTURE

DRAWINGS SHALL MENSIONS. NOT BE SCALED FOR

STRUCTURES ARE CLASSIFIED AS "MINOR STORAGE CILITIES" (OCCUPANCY CATEGORY I) AND SHOULD DIE USED FOR HUMAN HABITATION.

IESE PLANS WERE DESIGNED IN ACCORDANCE TH THE 2017 FBC, 6TH EDITION FOR A IREE SECOND GUST OF 150 MPH

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SHEET APPROVAL STAMP

9. ALL TREATED. 5. STRUCTURES ARE DESIGNED FOR LOCATIONS THAT HAVE A 3 SECOND WIND GUST OF 150 MPH (MAX). STRUCTURES SHOULD NOT BE USED IN OTHER LOCATIONS. 11. ALL SIDING IS TO BE %" P.T. T-III PLYWOOD OR DURATEMP. 6. STRUCTURES ARE DESIGNED FOR LOCATIONS WITH A SURFACE ROUGHNESS CATEGORY B AND A TOPOGRAPHICAL FACTOR OF 1.0. STRUCTURES 12. 0 ALL STUDS, RAFTERS, COLLAR TIES, AND TRUSS CHORDS ARE SPF #2, U.N.O. SHINGLES. STRUCTURES SHOULD HAVE METAL ROOF OR OPTIONAL 25 YEAR RATED FIBERGLASS/ASPHALT SHOULD NOT BE USED IN OTHER LOCATIONS. GALVANIZED. ALL FLOOR JOISTS ARE TO BE P.T. SYP ALL ROOF DECKING IS TO ALL EXTERIOR NAILS ALL EXTERIOR WOOD IS TO BE PRESSURE #2, U.N.O. ARE 5 BE BE HOT DIPPED 76" O.S.B.

ALL FLOOR DECKING īS TO BE %" P.T. PLYWOOD

14.

GROUND CONTACT. ALL SKIDS ARE TO BE 4×6 P.T. SYP, RATED FOR

16. THE STRUCTURE HAS BEEN DESIGNED TO RESIS LOADS AS A COMPLETED STRUCTURE ONLY.
APPLICATION OF CONSTRUCTION LOADS TO THE PARTIALLY COMPLETED STRUCTURE SHALL BE CONSIDERED BY THE CONTRACTOR AND INCLUDED IN THE DESIGN OF SHORING, BRACING, FORM WORK, AN OTHER SUPPORTING ELEMENTS PROVIDED FOR CONSTRUCTION OF THE STRUCTURE. RESIST AND N

ENGINEER. 17. NO FIELD SUPERVISION OR CONSTRUCTION ADMINISTRATION HAS BEEN PROVIDED BY THE

DESIGN CRITERIA:

FL FIRE PREVENTION CODE, 6TH EDITION 2017 FLORIDA BUILDING CODE, 6TH EDITION

DEAD LOADS:

FLOOR: 10 PSF LOFT: 5 PSF ROOF: 10 PSF

LIVE LOADS: FLOOR: 40 PSF LOFT: 10 PSF ROOF: 20 PSF (REDUCIBLE)

SNOW LOADS

GROUND SNOW LOAD, Pg=25psf FLAT ROOF SNOW LOAD, Pf=20psf SNOW EXPOSURE FACTOR, Ce=1.2 SNOW LOAD IMPORTANCE FACTOR, I=0.8 THERMAL FACTOR, Ct=1.2

WIND LOADS: RISK CATEGORY = I BASIC WIND SPEED, V=150 ROOF-ZONE 1=23.3, -37.0 psf ROOF-ZONE 2=23.3, -64.5 psf ROOF-ZONE 3=23.3, -95.4 psf WALL-ZONE 4=40.5, -43.9 psf WALL-ZONE 5=40.5, -54.2 psf MPH

THIS STRUCTURE IS EXEMPT FROM SEISMIC DESIGN PER EXEMPTION 3 OF ASCE 7-10, SECTION 11.1.2 6 SEISMIC LOADS:

BY OTHERS

THE FOLLOWING ITEMS ARE NOT PROVIDED BY RAILROAD CONSULTANTS, PLLC AND ARE TO BE DESIGNED BY OTHERS IT APPLICABLE AND ARE TO BE SUPPLIED AND INSTALLED BY OTHERS. THESE ITEMS MAY BE SUBJECT TO LOCAL JURISDICTION APPROVAL. RAILROAD CONSULTANTS, PLLC IS NOT RESPONSIBLE THESE ITEMS.

RAMPS, STAIRS, AND GENERAL ACCESS

BUILDING SIZES:

10' WIDTH 10'x24' 12'x20' 12'x24' 12'x28' 12'x28' 12'x32' **NOTE:(11'-2 ACTUAL) *NOTE:(15'-0 ACTUAL)
16'x24'
16'x28'
16'x32'
16'x32'
16'x36'
16'x40' 14'x28' 14'x32' 14'x24 14'x40 14'x36 *NOTE:(13'-0 ACTUAL) 16' NOMINAL

S-10-PG S-11-PG S-3-PG S-5-PG S-6-PG S-7-PG G — COVER SHEET
G — FOUNDATION PLAN
G — UPLIFT ANCHORAGE
G — FRAMING PLAN
G — BUILDING SECTIONS
G — ELEVATIONS
G — NAIL PATTERN

DETAILS

RAILROAD CONSULTANTS, PLLC --V=150MPH SHEET NUMBER



CORIDA STATE OF 料


Plans Review: Victor C. Martin, PE FL PE #82379, LA PE #42017 LSUCCC #U02436, TN PE #120939

MURFREESBORO, TN 37129 PHONE: (615) 663-1142 213 UPTOWN SQUARE

200	S*		E	
PHONE: (866) 574-744	BARDWELL, KY 42023	6807 HWY 62 WEST	BUILDINGS, LLC	GRACELAND PORTABL

) PORTABLE IGS, LLC	PROJECT NO: DATE:	14017
GS, LLC	DATE:	12-2
62 WEST	DRAWN BY:	GG
, KY 42023	снескер ву: DBG	DBG
6) 574-7446 REVISION:	REVISION:	2

SCALE: 1/4"=1'-0

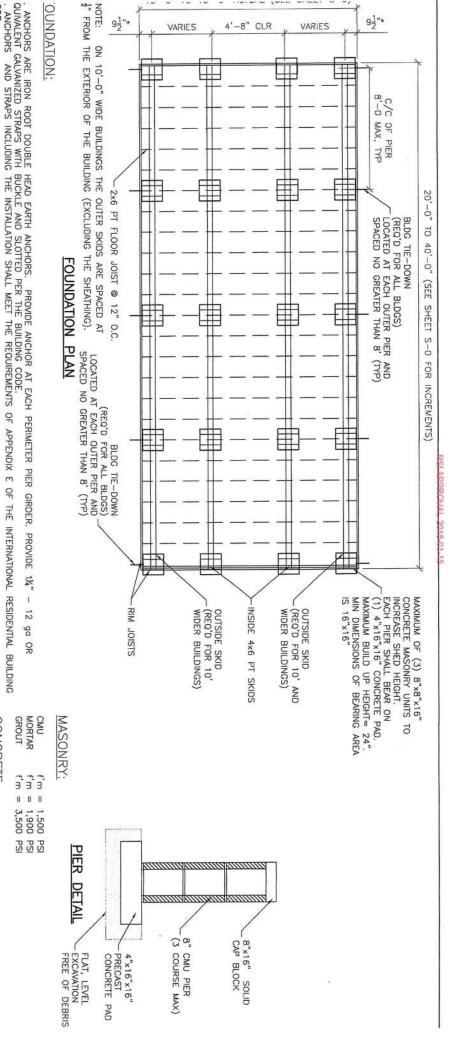



THE MINIMUM ALLOWABLE SOIL BEARING CAPACITY OF 2500 psf HAS BEEN ASSUMED FOR FOOTING DESIGN. CONTRACTOR TO HAVE THIS ERIFIED PRIOR TO CONSTRUCTION.

IF A MINIMUM ALLOWABLE SOIL BEARING CAPACITY OF 1500 psf IS USED, THEN THE PIER SPACING SHALL BE NO GREATER THAN 4'-O. FOOTINGS SHALL BE CARRIED TO AN ELEVATION LOWER THAN THOSE SHOWN ON THE DRAWINGS IF REQUIRED TO REACH SUITABLE SOIL. FOOTINGS SHALL BE PLACED ON SUITABLE SOIL THAT MEETS DESIGN ASSUMPTIONS.

CONTRACTOR TO HAVE THIS CAPACITY

CONCRETE:

MATERIALS (COMPRESSIVE STRENGTH AT 28 DAYS)

FOOTINGS AND EXTERIOR CONCRETE SHALL BE AIR-ENTRAINED

THESE PLANS WERE DESIGNED IN ACCORDANCE WITH THE 2017 FBC, 6TH EDITION FOR A THREE SECOND GUST OF 150 MPH

SYSTEM TO BE SITE DESIGNED AND FOUNDATION ANCHORING TIE DOWN

CONSULTANTS

RAILROAD CONSULTANTS, PLLC MURFREESBORO, TN 37129 PHONE: (615) 663-1142 213 UPTOWN SQUARE




PHONE: (866) 574-7446 BARDWELL, KY 42023 6807 HWY 62 WEST BUILDINGS, LLC

REVISION: DATE CHECKED BY: DBG DRAWN BY: JGG 2

S-1-PG

PORTABLE GARAGE--FL--V=150MPH GRACELAND PORTABLE PROJECT NO: 14017 1--FBC 20 12-29-17 SHEET NUMBER

SCALE: 1/4"=1'-0

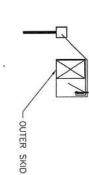

THE TIE DOWN ENGINEERED DOUBLE SLOT BUCKLE #59140
OR EQUAL. REFER TO—
MANUFACTURERS SPECIFICATIONS
FOR INSTALLATION

STRAP RATCHET

1-1/4"x6'-0x12 GA min GALV. STRAPping FED. SPEC. GG-5781-H

IRON ROOT DOUBLE HEAD #54291 EARTH ANCHORS. ANCHOR SYSTEM LOCATED AT EACH PIER.

ANCHOR TIE DOWN DETAIL

OUTER SKID

IESE PLANS WERE DESIGNED IN ACCORDANCE TH THE 2017 FBC, 6TH EDITION FOR A IREE SECOND GUST OF 150 MPH

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SHEET APPROVAL STAMP



CONSULTANTS

RAILROAD CONSULTANTS, PLLC MURFREESBORO, TN 37129 PHONE: (615) 663-1142 213 UPTOWN SQUARE

PORTABLE GARAGE-

_--V=150MPH---

SYSTEM TO BE SITE DESIGNED AND FOUNDATION ANCHORING TIE DOWN

LOCALLY PERMITTED




중 오	BARDWELL, KY 42023 CH PHONE: (866) 574-7446 RE	S.
묽	6807 HWY 62 WEST	
2	BUILDINGS, LLC	
Γ	GRACELAND PORTABLE	

HONE: (866) 574-7446 REVISION:	BARDWELL, KY 42023	6807 HWY 62 WEST	BUILDINGS, LLC	RACELAND PORTABLE
REVISION:	CHECKED BY: DBG	DRAWN BY:	DATE:	PROJECT NO:
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C	2	SHEE
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2	3	R

SCALE: 1/4"=1'-0

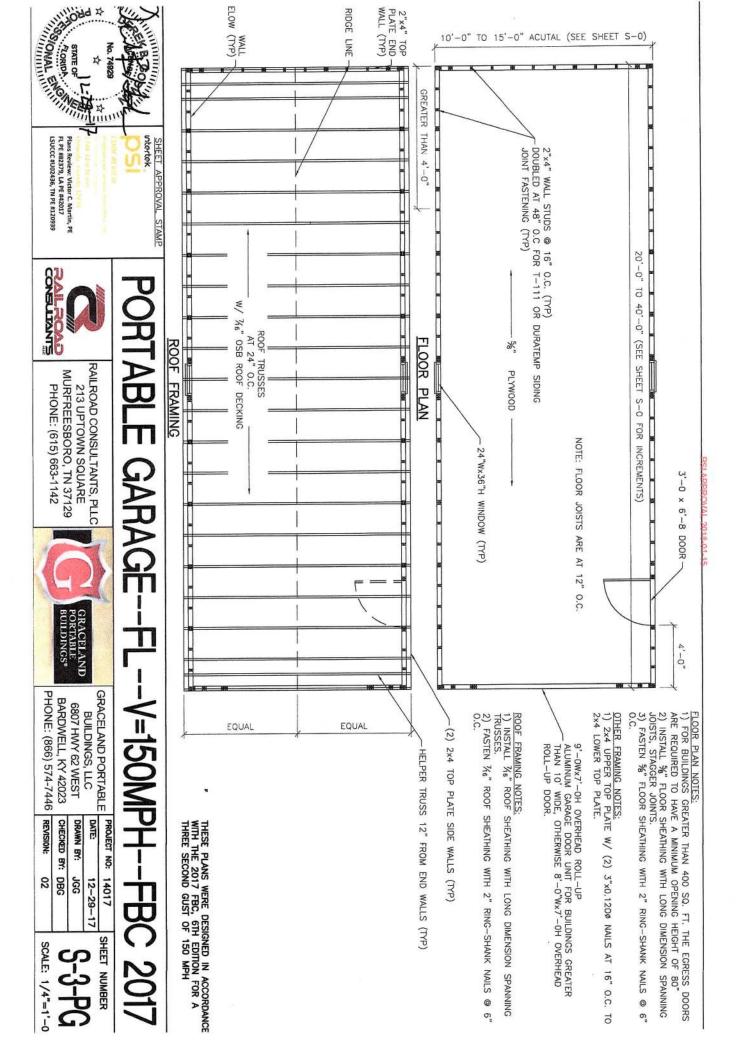

Plans Review: Victor C. Martin, PE FL PE #82379, LA PE #42017 LSUCCC #U02436, TN PE #120939 CONSULTANTS RAILROAD CONSULTANTS, PLLC MURFREESBORO, TN 37129 PHONE: (615) 663-1142 213 UPTOWN SQUARE PHONE: (866) 574-7446 REVISION: GRACELAND PORTABLE BARDWELL, KY 42023 BUILDINGS, LLC 6807 HWY 62 WEST DATE: CHECKED BY: DBG PROJECT NO: 14017 DRAWN BY: JGG 02 12-29-17

PORTABLE GARAGE--FL--V=150N

SHEET APPROVAL STAMP (4) 4x6 PT SYP SKID 7'-9½" 2x4 STUDS @ 16" W/ DOUBLE STUD -@ 48" O.C. 2x4 BOTTOM PLATE -8 T-111 SIDING -3 10'*. 12'. 10'-0"*, 11'-2", 13'-0" or 15'-0" VARIES BUILDING SECTIONS 14' & 16' (NOMINAL) WIDE 4'-8" CLR VARIES 2x4 TRUSS @ 24" O.C.
W/ HELPER TRUSS @
— 12" FROM END WALLS
W/ STRUCTURAL MENDING PLATES
AT EACH JOINT 1 PER SIDE χ_6 " OSB DECKING .W/ METAL ROOF (FIBERGLASS/ASPHALT SHINGLES ARE OPTIONAL) 92 x6 TRTD FLOOR 92 x JOIST @ 12 O.C. %" TRTD PLYWOOD DECKING NOTE:

8'-41/2"

12" FROM THE EXTERIOR OF THE BUILDING (EXCLUDING THE SHEATHING). ON 10'-0" WIDE BUILDINGS THE OUTER SKIDS ARE SPACED AT

IESE PLANS WERE DESIGNED IN ACCORDANCE TH THE 2017 FBC, 6TH EDITION FOR A IREE SECOND GUST OF 150 MPH

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SHEET NUMBER

S-4-PG SCALE: 1/4"=1'-0

IESE PLANS WERE DESIGNED IN ACCORDANCE TH THE 2017 FBC, 6TH EDITION FOR A IREE SECOND GUST OF 150 MPH

intertek

PORTABLE GARAGE--

FL--V=150MPH--FBC 2017

6) INSTALL 1 LAYER OF 15 LB ROOFING FELT, START WITH A 19" WIDE STRIP PARALLEL WITH AND STARTING AT EAVES FASTENED SECURELY TO HOLD IN PLACE. START AT EAVE WITH A 38" WIDE SHEET WITH OVERLAPPING SUCCESSIVE SHEETS BY 19". FASTEN UNDERLAYMENT WITH CORROSION—RESISTANT FASTENERS PER MAUFACTURER'S INSTRUCTIONS AND SPACED A MAXIMUM OF 36" APART.

924M OVER OSB SHEATHING.
3) PROVIDE 29 GAUGE RIDGE CAP, EAVE TRIM AND RAKE TRIM.
4) INSTALL AND FASTEN METAL ROOFING PER MANUFACTURER'S INSTRUCTIONS FOR WIND LOADING.
5) OPTIONAL SHINGLES SHALL BE IN ACCORDANCE WITH ASTM D 7158 TYPE H OR ASTM D 3161F

ROOFING AND UNDERLAYMENT NOTES:

1) PROVIDE A RIDGE VENT TYPICAL WITH INSECT SCREEN.

2) METAL ROOFING SHALL BE 29 GAUGE METAL IN ACCORDANCE WITH ASTM A 924 OR ASTM A

SHEET APPROVAL STAMP




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BUILDINGS, LLC BLE 6807 HWY 62 WEST NGS* BARDWELL, KY 42023
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DATE: 12-29-17 DRAWN BY: JGG CHECKED BY: DBG REVISION: 02
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IESE PLANS WERE DESIGNED IN ACCORDANCE TH THE 2017 FBC, 6TH EDITION FOR A IREE SECOND GUST OF 150 MPH

SHEET APPROVAL STAMP

PORTABLE GARAGE--

FLOOR SHEATHING (NAIL PATTERN)

_--V=150N

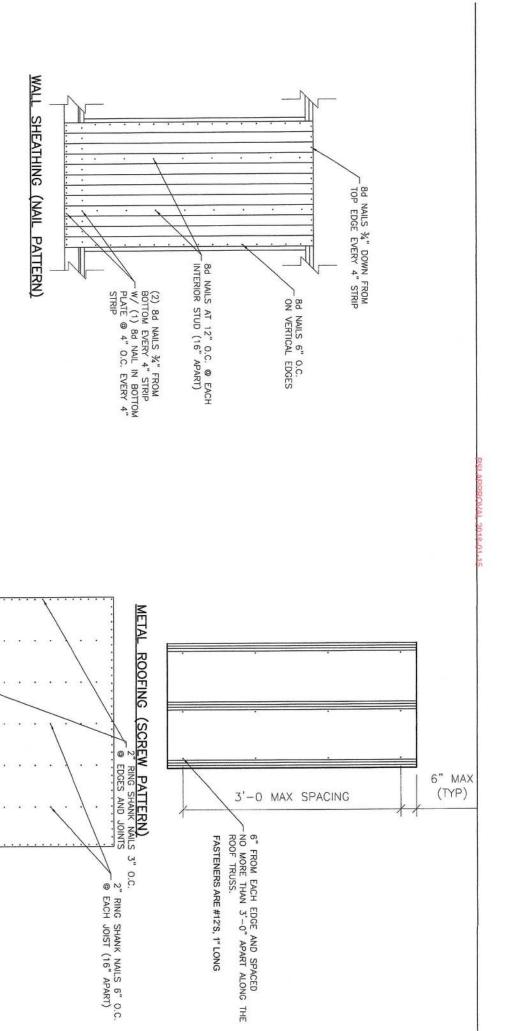FBC 2017

CONSTITUTIONS RAILROAD CONSULTANTS, PLLC MURFREESBORO, TN 37129 PHONE: (615) 663-1142 213 UPTOWN SQUARE GRACELAND PORTABLE PROJECT NO: 14017 BUILDINGS, LLC DATE: 12-29-PHONE: (866) 574-7446 BARDWELL, KY 42023 6807 HWY 62 WEST

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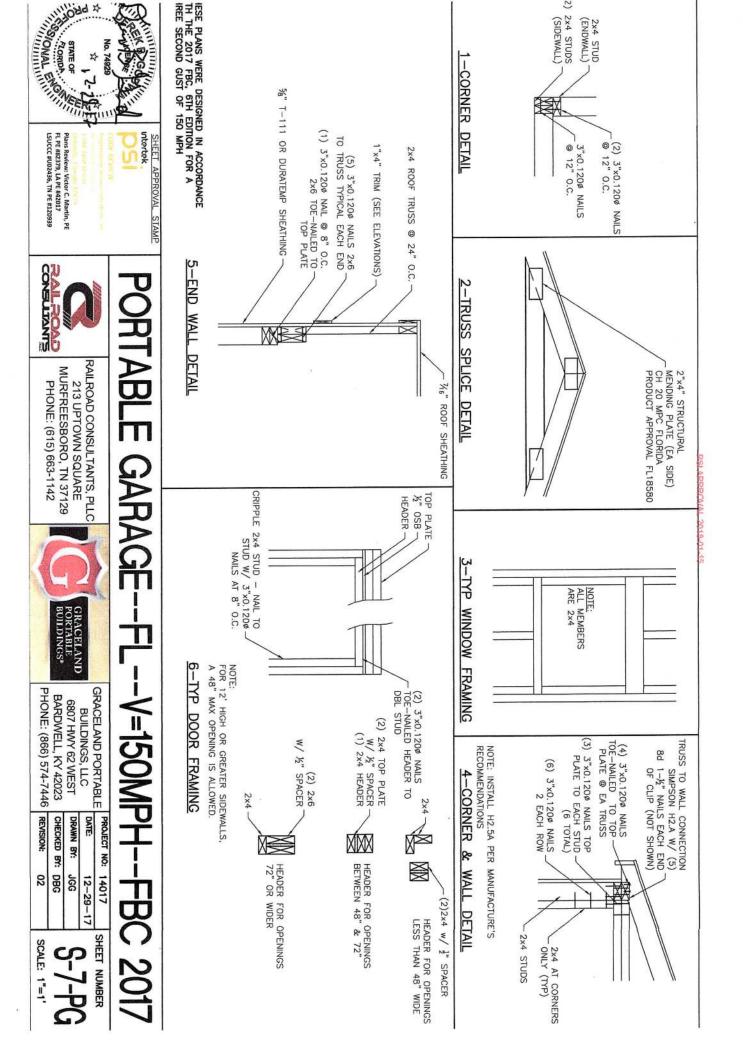
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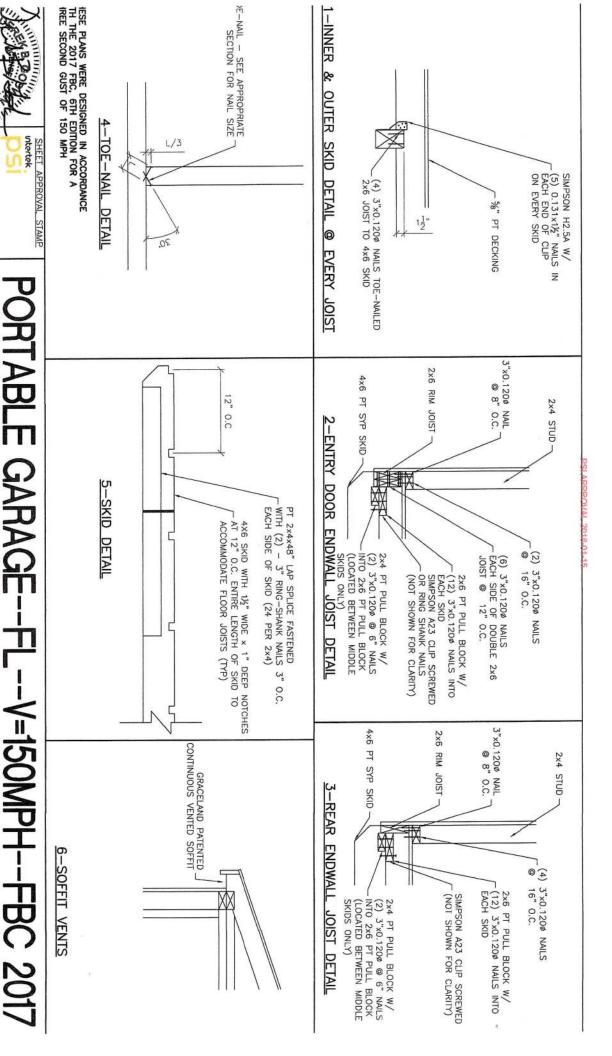
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LSUCCC #U02436, TN PE #120939 Plans Review: Victor C. Martin, PE FL PE #82379, LA PE #42017





Plans Review: Victor C. Martin, PE FL PE #82379, LA PE #42017 LSUCCC #U02436, TN PE #120939

CONSULTANTS

RAILROAD CONSULTANTS, PLLC 213 UPTOWN SQUARE

GRACELAND PORTABLE PROJECT NO: 14017

DATE:

12-29-17

SHEET NUMBER

PHONE: (866) 574-7446 BARDWELL, KY 42023 6807 HWY 62 WEST BUILDINGS, LLC

REVISION:

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SCALE: 1"=1"

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MURFREESBORO, TN 37129

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