

64

FOUNDATION NOTES:

MATERIAL SPECIFICATIONS:

- SOIL & SITE PREPARATION:**
1. FOUNDATION DESIGN IS BASED ON AN ALLOWABLE SOIL BEARING PRESSURE OF 2.0 KIPS/SQ FT. THE USER SHALL VERIFY THAT THIS VALUE MAY DIFFER FROM THIS MUST BE BROUGHT TO THE ATTENTION OF THE ENGINEER.
 2. FOUNDATIONS SHALL BE BUILT ON UNDISTURBED SOIL OR PROPERLY COMPACT FILL MATERIAL. COMPACTED SOILS SHALL BE TESTED TO A MINIMUM OF 95% RELATIVE DENSITY.
 3. EXCAVATIONS FOR FOUNDATIONS SHALL BE BACKFILLED WITH SOIL WHICH IS FREE OF ORGANIC MATERIAL, CONSTRUCTION DEBRIS, AND LARGE ROCKS.
 4. LICENSED USER IS RESPONSIBLE FOR INSURING THAT SOIL CONDITIONS MEET OR EXCEED THE DESIGN REQUIREMENTS.

- BASE PAD:**
1. BASE PADS TYPE "A" SHALL BE 30" X 30" AND PAD TYPE "B" SHALL USE A 12" CONCRETE IN FOOTINGS SHALL HAVE A SPECIFIED COMPRESSIVE STRENGTH OF NO LESS THAN 2500 PSI AT 28 DAYS.

- MASONRY UNITS:**
1. UNITS SHALL BE CONSTRUCTED WITH NOMINAL 15" X 12" CONCRETE MASONRY UNITS CONFORMING TO ASTM C 90.

- GROUND ANCHORS:**
1. ALL GROUND ANCHORS AND SHIMS SHALL BE CLEAR OF PRESSURE TREATED WOOD & SIMILAR MATERIAL.


- THE-DOWNS STRAPS:**
1. THE-DOWNS STRAPS SHALL BE 1/2" X 4" X 8" GALVANNELED STEEL, 605.56 LB/FT TYPICAL FINISHES, GRADE 55. THE-DOWNS STRAPS AND CONNECTIONS SHALL HAVE 27500 PSI MIN. ULTIMATE CAPACITY.

INSTALLATION SPECIFICATIONS:

- SOIL SITE PREPARATION:**
1. WHERE WATER INVADES THE GROUND FROM A ROOT VALLEY, DOWN-SPIUT, SCHEPPE, OR OTHER RAINWATER COLLECTOR OR INTERIOR DRIP/SPRINKLER SYSTEMS, THE FOUNDATION SHALL BE BUILT ON A DRAINAGE MATTER WHICH IS FREE OF ANY ORGANIC MATERIAL, CONSTRUCTION DEBRIS, AND LARGE ROCKS. REMOVE PRIOR TO THEIR CONSTRUCTION. FILL MATERIAL SHALL BE FREE OF VEGETATION AND FOREIGN MATERIAL.

- MASONRY UNITS:**
1. LONG DIMENSION OF ALL PERS MAY BE INSTALLED PERPENDICULAR OR PARALLEL TO THE FRAME MEMBERS OF FACTORIES, 12" HIGH UNITS.
 2. FOUNDATION WALLS OF ROLL-UP MASONRY CONSTRUCTION SHALL BE CAPED WITH 4" OF SOLID MASONRY OR CONCRETE OR SOLID 2 X 4 LUMBER.
 3. CONCRETE MASONRY UNITS SHALL CONFORM TO THE ASTM C 90 STANDARDS.
 4. MASONRY SHALL BE CONSTRUCTED IN ACCORDANCE WITH THE MANUFACTURER'S SPECIFIED, INCLUDING STACKING AND LAYING OF ALL UNITS, JOINTS AND THE APPLICATION OF MORTAR, CURING AND PROTECTION SHALL COMPLY WITH ASTM C 946.

- THE-DOWNS STRAP:**
1. THE FIRST THE-DOWN STRAP FROM THE END WALL SHALL NOT EXCEED 24".
 2. REFER TO ANCHOR SCHEDULE FOR MINIMUM NUMBER OF GROUND ANCHORS.

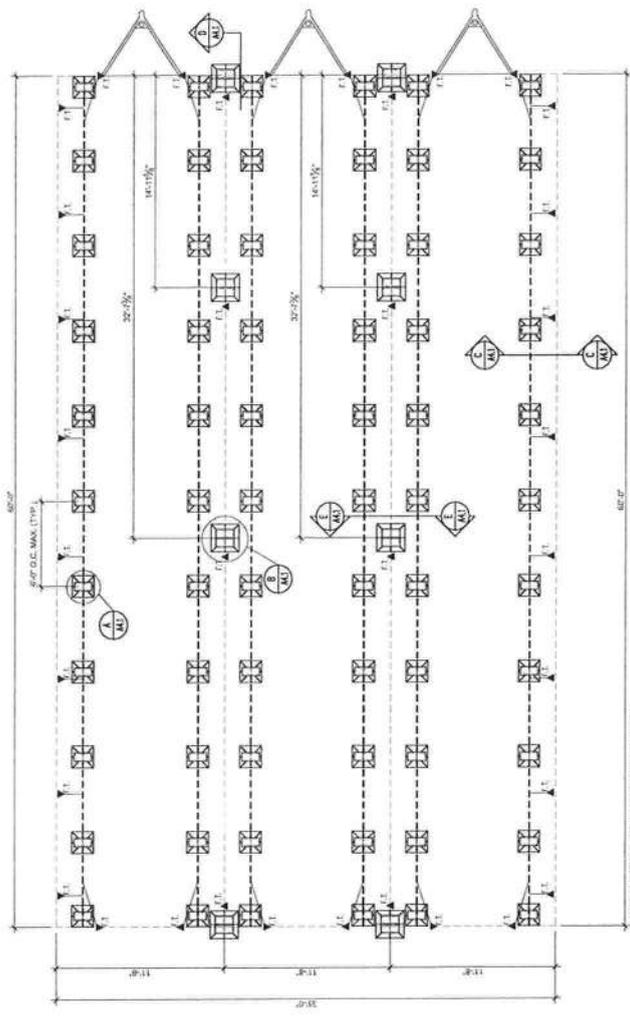

FOUNDATION PLAN
SCALE: 1/4" = 1'-0"

NOTE: DESIGNER SHALL BE RESPONSIBLE FOR VERIFYING ALL INFORMATION UTILIZED AND OBTAINED FROM ALL SOURCES. A WELL TEST IS REQUIRED FOR PERMITTING. THE DESIGNER SHALL BE RESPONSIBLE FOR THE DESIGN OF THE STRAP PLATE FOR FRAME CONNECTION. THE DATE OF THE STRAP PLATE DESIGN SHALL BE USED.

FBC 8TH EDITION (2023) SCHEDULES REFERENCE:

- 1. ANCHOR BOLT: SEE ANCHOR BOLT SCHEDULE
- 2. WOOD JOIST: SEE WOOD JOIST SCHEDULE
- 3. WOOD FRAMING: SEE WOOD FRAMING SCHEDULE

ANCHORS & STRAPPING SCHEDULE

SEE THE FOLLOWING FOR THE ANCHOR BOLT SCHEDULE, WOOD JOIST SCHEDULE, WOOD FRAMING SCHEDULE, AND THE-DOWN STRAP SCHEDULE.

FOUNDATION DIMENSIONS

A. MODULE WIDTH	B. PIER TO MODULE EDGE	C. STEEL BEAM SPACING
11'-0"	1'-0"	16'-0"
D. MAX PIER SPACING	E. WINDUPLUG SOIL BEARING CAPACITY	
32'-0"	2000 PSF	

SYMBOL LEGEND

- ▲ FRAME TO GROUND ANCHOR TO GROUND ANCHOR

EAST COAST MODULAR
MASCOTTE
801 W MEMS BLVD
MASCOTTE, TN 37423
WWW.EASTCOASTMODULAR.COM
(407) 765-0135



MODULAR STRUCTURE FOR:
EAST COAST MODULAR
(36' x 60')

Digitally signed
by Julio
Orbego
Date: 2024.02.27
12:34:25 -05'00'



THIS DRAWING HAS BEEN ELECTRONICALLY SIGNED AND SEALED BY JULIO ORBEGO, P.E. ON THE DATE AND TIME SHOWN USING A DIGITAL SIGNATURE. THE ORIGINAL DRAWING HAS NOT BEEN CHANGED SINCE IT WAS SIGNED AND SEALED. THIS DRAWING IS NOT VALID FOR ANY OTHER PROJECTS OR FOR ANY OTHER PURPOSES WITHOUT THE WRITTEN CONSENT OF THE ENGINEER AND THE USER.

DATE:	02-26-2024
DRAWN BY:	R.M.H.
JOB NO.:	004-20240104
SHEET NO.:	A4

REVISION DATE:	
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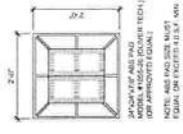
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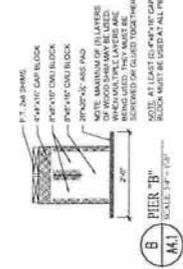
THIS ITEM HAS BEEN ELECTRONICALLY SIGNED AND SEALED BY JULIO ORBEGOSO, P.E. ON THE DATE AND TIME STAMP SHOWN USING A CERTIFIED DIGITAL SIGNATURE PROGRAM. ANY ALTERATIONS TO THIS DOCUMENT MUST BE CONSIDERED UNSIGNED AND SEALED AND THE SIGNATURES MUST BE VERIFIED ON ANY ELECTRONIC COPIES.

REVISION DATE


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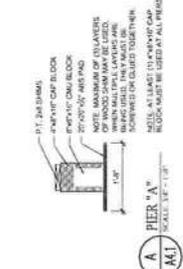
B PIER B
 SCALE: 3/8" = 1'-0"
 NOTE: ALL PIER SIZE MUST BE EQUAL OR EXCEEDED 24.5% MIN. EQUAL OR EXCEEDED 24.5% MIN.




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 SCALE: 3/8" = 1'-0"
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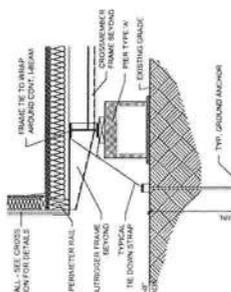
A PIER A
 SCALE: 3/8" = 1'-0"
 NOTE: ALL PIER SIZE MUST BE EQUAL OR EXCEEDED 24.5% MIN. EQUAL OR EXCEEDED 24.5% MIN.




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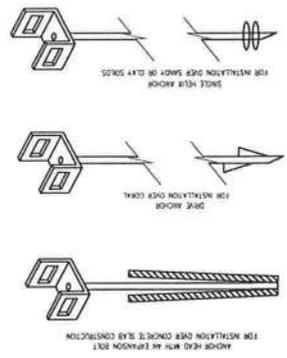
D SECTION TIE DOWN, ENDWALL (TYP.)
 SCALE: 3/8" = 1'-0"

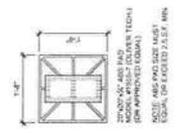

C SECTION TIE DOWN, SIDEWALL (TYP.)
 SCALE: 3/8" = 1'-0"

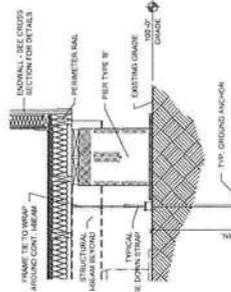

E SECTION TIE DOWN, MATELINE (TYP.)
 SCALE: 3/8" = 1'-0"

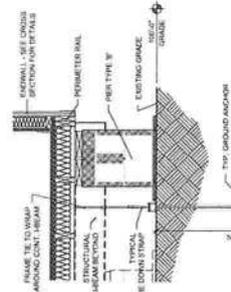

TYPICAL GROUND ANCHOR DETAIL
 SCALE: N/A