# \$172.75

443678
Columbia County New Building Permit Application

For Office Use Only Application # 908 116 Date Received 8/30 By Fermit # 3868/
Zoning Official 12. W Date 9-10-19 Flood Zone X Land Use Ag Zoning A-3
FEMA Map # N/A Elevation N/A MFE N/A River N/A Plans Examiner 7.6. Date 9.10-14
Comments Non Habitable Storage Bldg. F. 30' Sides 25' Mear 25'
DNOC (PEH Doed or PA Site Plan o State Road Info o Well letter o 917 Sheet   Parent Parcel #
Dev Permit # In Floodway Aerter of Auta, from Contractor F W Comp. letter
Owner Builder Disclosura Statement Diand Owner Affidavit DEllisville Water Lapp Fee Paid Sub VF Form
Septic Permit No. 1906-7 OR City Water Fax
Applicant (Who will sign/pickup the permit, Rami Al-Chacar Phone 336-756-156
Address 820 Reeves Drive, Mt Airy, NC 27030
Owners Name Burn and Jennifer Robinson Phone 386-392-3645
911 Address 434 NW Noege 1 Rd, Lake City, FL 38055
Contractors Name Javier Lara Phone 877-272-8276
Address 820. Preeves Drive, Mount Airy, NC 27030
Contractor Email Shaper mitting e Shaina. Com enclude to get updates on this job.
Fee Simple Owner Name & Address
Bonding Co. Name & Address
Architect/Engineer Name & Address Moorg . 401 S. Main St., Ste 200, Mt. Airy, NC 27630
Mortgage Lenders Name & Address
Circle the correct power company FL Power & Light Clay Elec. Suwannee Valley Elec. Duke Energy
Property ID Number 30-35-16-03401-000 Estimated Construction Cost 13, 303 00
Subdivision NameLotBlockUnitPhase
Driving Directions from a Major Road 90-121 & C-135, TR AND 16-5 1/2 Nil CEN
3'12
Construction of 30x41x13_accessory_Structure Commercial OR Residential
Proposed Use/Occupancy Storage Number of Existing Dwellings on Property
Is the Building Fire Sprinkled? No If Yes, blueprints included Or Explain
Circle Proposed Culvert Permit or Culvert Waiver or D.O.T. Permit or Have an Existing Drive
Actual Distance of Structure from Property Lines - Front Side Side Rear
Number of Stories Heated Floor Area Total Floor Area 1236 Acreage 5.89
Zoning Applications applied for (Site & Development Plan, Special Exception, etc.) 30 x41
7/12/19- Let Rami know reading for publishers be submitted together.) Revised 7-1-15

#### Columbia County Building Permit Application

#### CODE: Florida Building Code 2017 and the 2014 National Electrical Code.

Application is hereby made to obtain a permit to do work and installations as indicated. I certify that no work or installation has commenced prior to the issuance of a permit and that all work be performed to meet the standards of all laws regulating construction in this jurisdiction.

TIME LIMITATIONS OF APPLICATION: An application for a permit for any proposed work shall be deemed to have been abandoned 180 days after the date of filing, unless pursued in good faith or a permit has been issued.

TIME LIMITATIONS OF PERMITS: Every permit issued shall become invalid unless the work authorized by such permit is commenced within 180 days after its issuance, or if the work authorized by such permit is suspended or abandoned for a period of 180 days after the time work is commenced. A valid permit receives an approved inspection every 180 days. Work shall be considered not suspended, abandoned or invalid when the permit has received an approved inspection within 180 days of the previous approved inspection.

FLORIDA'S CONSTRUCTION LIEN LAW: Protect Yourself and Your Investment: According to Florida Law, those who work on your property or provide materials, and are not paid-in-full, have a right to enforce their claim for payment against your property. This claim is known as a construction lien. If your contractor fails to pay subcontractors or material suppliers or neglects to make other legally required payments, the people who are owed money may look to your property for payment, even if you have paid your contractor in full. This means if a lien is filed against your property, it could be sold against your will to pay for labor, materials or other services which your contractor may have failed to pay.

NOTICE OF RESPONSIBILITY TO CONTRACTOR AND AGENT: YOU ARE HERBY NOTIFIED as the recipient of a building permit from Columbia County, Florida, you will be held responsible to the County for any damage to sidewalks and/or road curbs and gutters, concrete features and structures, together with damage to drainage facilities, removal of sod, major changes to lot grades that result in ponding of water, or other damage to roadway and other public infrastructure facilities caused by you or your contractor, subcontractors, agents or representatives in the construction and/or improvement of the building and lot for which this permit is issued. No certificate of occupancy will be issued until all corrective work to these public infrastructures and facilities has been corrected.

WARNING TO OWNER: YOUR FAILURE TO RECORD A NOTICE OF COMMENCEMENT MAY RESULT IN YOU PAYING TWICE FOR IMPROVEMENTS TO YOUR PROPERTY. A NOTICE OF COMMENCEMENT MUST BE RECORDED AND POSTED ON THE JOB SITE BEFORE THE FIRST INSPECTION. IF YOU INTEND TO OBTAIN FINANCING, CONSULT WITH YOUR LENDER OR ATTORNEY BEFORE RECORDING YOUR NOTICE OF COMMENCEMENT.

OWNERS CERTIFICATION: I CERTIFY THAT ALL THE FOREGOING INFORMATION IS ACCURATE AND THAT ALL WORK WILL BE DONE IN COMPLIANCE WITH ALL APPLICABLE LAWS REGULATING CONSTRUCTION AND ZONING.

NOTICE TO OWNER: There are some properties that may have deed restrictions recorded upon them. These restrictions may limit or prohibit the work applied for in your building permit. You must verify if your property is encumbered by any restrictions or face possible litigation and or fines.

Mary Mary

RYAN ROBINSON

Print Owners Name	Owners Signature		
**If this is an Owner Builder Permit A	pplication then, ONLY the owns	er can sign the building permit whe	n it is issued.
contractors affidavit: By my swritten statement to the owner of this Building Permit including all a contractor's Signature	all the above written respons application and permit time life Contra	sibilities in Columbia County for	obtaining
Affirmed under penalty of perjury to b	y the Contractor and subscribe	ed before me this <u>274</u> day of <u>Ju</u>	ne 20 <u>19</u> .
Personally known or Produced	Identification		
State of Florida Notary Signature (For	SEAL:	FRANCES GARCIA  NOTARY PUBLIC SURRY COUNTY	

Page 2 of 2 (Both Pages must be submitted together 9LINA Revised 7-1-17

\*\*Property owners must sign here

before any permit will be issued.

#### NOTICE OF COMMENCEMENT

Tax Parcel Identification Number:

30-35-10-02401-000

Clark's Office Stamp

Inst: 201912017245 Date: 07/24/2019 Time: 4:48PM Page 1 of 1 B: 1389 P: 2128, P.DeWitt Cason, Clerk of Court

Columbia, County, By: PT

Deputy Clerk

THE UNDERSIGNED hereby gives notice that improvements will be made to certain real property, and in accordance with Section 713.13 of the Florida Statutes, the following information is provided in this NOTICE DE COMMENCEMENT.


1. Description of property (legal description): 30 - 35 - 16 - 00401 - 000
a) Street (job) Address: 434 NW Noegel Rd Lake City, FL 32055
2. General description of improvements: 30x41x12 detached accessory Structure
3. Owner Information or Lessee information if the Lessee contracted for the improvements:
a) Name and address: Much + I enhiter Wakinson
o) your and address of the purity fittinging (it owel that owell)
C) wherest in property STOY GGS
a) Name and address: Javier Lara/Steel Buildings + Structures 820 Rieves Dr. Mt. Airy 27030 b) Telephone Na.: 877-272-8276
h) Telegringe No. 871, 272, 273, 273
5. Surety Information (if applicable, a copy of the payment bond is attached):
a) Name and address:
b) Amount of Bond:
c) Telephone No.:
6 Lender
a) Name and address:
b) Phone No
7. Person within the State of Florida designated by Owner upon whom notices or other documents may be served as provided by Section
713.13(1)(a)7., Florida Statutes:
a) Name and address:
b) Telephone No.:
9 in addition to himself as hosself Owner desired to 5 it
<ol> <li>In addition to himself or herself, Owner designates the following person to receive a copy of the Lienor's Notice as provided in Section 713.13(I)(b), Florida Statutes:</li> </ol>
a) Name:OF
by telephone ito:
WARNING TO OWNER: ANY PAYMENTS MADE BY THE OWNER AFTER THE EXPIRATION OF THE NOTICE OF COMMENCEMENT ARE CONSIDERED IMPROPER PAYMENTS UNDER CHAPTER 713, PART I, SECTION 713.13, FLORIDA STATUTES, AND CAN RESULT IN YOUR PAYING TWICE FOR IMPROVEMENTS TO YOUR PROPERTY; A NOTICE OF COMMENCEMENT MUST BE RECORDED AND POSTED ON THE JOB SITE BEFORE THE FIRST INSPECTION. IF YOU INTEND TO OBTAIN FINANCING, CONSULT YOUR LENDER OR AN ATTORNEY BEFORE COMMENCING WORK OR RECORDING YOUR NOTICE OF COMMENCEMENT.
STATE OF FLORIDA
COUNTY OF COLUMBIA 10.
Signature of Owner or Lessee, or Owner's or Lessee's Authorized Office/Director/Partner/Manager
RYAN A- ROBINSON
Printed Name and Signatory's Title/Office
The foregoing instrument was acknowledged before me, a Florida Notary, this 24 day of July 20 19 by:
Pura A R lands
Pyan A. Robinson as Transcr for Self (Name of Person' (Type of Authority) (name of party on behalf of whom instrument was executed)
(Name of Person) (Type of Authority) (name of party on behalf of whom instrument was executed)
Personally Known OR Produced Identification 1/ Type ALDL
OK TOURS OF TOURS
Notary Stamp disease Notary Notary Stamp disease Notary Notary Stamp disease Notary Notary Stamp disease Notary No
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# STATE OF FLORIDA DEPARTMENT OF HEALTH ONSITE SEWAGE TREATMENT AND DISPOSAL SYSTEM APPLICATION FOR CONSTRUCTION DEPARTMENT

PERMIT NO.	19-0621
DATE PAID:	91319
FEE PAID:	7600
RECEIPT #:	143 Ked 8

MEETICATION	FOR CONSTRUCTION PERI	MIT
APPLICATION FOR: [ ] New System [ ] E. [ ] Repair [ ] A	xisting System [ ] bandonment [ ]	Holding Tank [ ] Innovative Temporary [ ]
APPLICANT: Steel Buildin	ngs and Structures	Inc Ryan Residen
AGENT: JAVIEK LARA	<u> </u>	TELEPHONE: 877-272-82
MAILING ADDRESS: P.O. Box	: 1287, Mt. Airy.	NC 27030
APPLICANT'S RESPONSIBILITY TO	T TO 489.105(3)(m) OR 489 O PROVIDE DOCUMENTATION ( TING CONSIDERATION OF STJ	ED AGENT. SYSTEMS MUST BE CONSTRUCTED 9.552, FLORIDA STATUTES. IT IS THE OF THE DATE THE LOT WAS CREATED OR ATUTORY GRANDFATHER PROVISIONS.
PROPERTY INFORMATION		
LOT: BLOCK:	SUBDIVISION:	PLATTED:
PROPERTY ID #: 30-35-16-	02401-000 zoning:	I/M OR EQUIVALENT: [ Y / [ Y ]
		ATE PUBLIC [ ] <= 2000GPD [ ] > 2000GPD
		DISTANCE TO SEWER:FT
PROPERTY ADDRESS: 434 NO	gel Rd, Lake City	. FL 39055
DIRECTIONS TO PROPERTY: At		
BUILDING INFORMATION	PRESIDENTIAL	[ ] COMMERCIAL
Unit Type of No Establishment	No. of Building Consequence Bedrooms Area Sqft Ta	ommercial/Institutional System Design able 1, Chapter 64E-6, FAC
Single Family	3467	
2 Stral Bidg	30x4 1230	
3		
4		
[ ] Floor/Equipment Drains	[ ] Other (Specify)	
SIGNATURE: Juin wa	, , omer (obserta)	DATE: 08 29 2019
1/		•



#### STATE OF FLORIDA DEPARTMENT OF HEALTH PPLICATION OF CONTENT OF THE

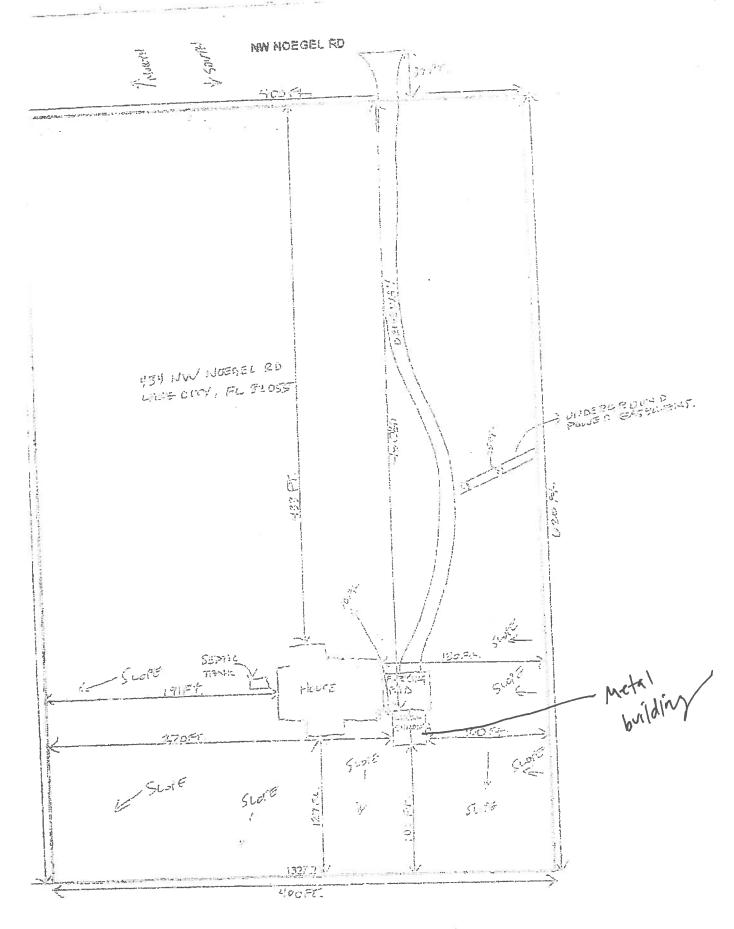Form Appendicular June 19-0621

\* Sec Attacheda Staff an autoritied by: Flan Fagrayed, 🗸 Courty Steam Department ALL CHANGES MUST BE APPROVED BY THE COUNTY HEALTH DEPARTMENT CAN MEDIA ACCORDED ON CONTRACTOR ACCORDED ACCOR French 4 564

Aerial Viewer

Pictometery

#### Columbia County Property Appraiser Jeff Hamptoe

#### **2019 Preliminary Certified Values**

Google Maps

updated: 8/14/2019

Parcel: << 30-3\$-16-02401-000 >>

Owner & Pr	operty Info	Result:	1 of 1
Owner	ROBINSON RYAN A & J 434 NW NOEGEL RD LAKE CITY, FL 32055755		erenementementemente renga (*1914) provincio dell'erende
Site	434 NOEGEL RD, LAKE	CITY	
Description*	COMM NE COR OF SW1/4 W R/W OF NW NOEGEL R CONT S 396.56 FT, W 650. 643.39 FT TO POB. ORB 58 835-1147, WD 1288-1928,	D, S 401.06 FT 32 FT, N 396.40	FOR POB FT, E
Area	5.89 AC	S/T/R	30-3S-16
Use Code**	IMPROVED A (005000)	Tax District	3

<sup>\*</sup>The <u>Description</u> above is not to be used as the Legal Description for this parcel in any legal transaction.

\*\*The <u>Use Code</u> is a FL Dept. of Revenue (DOR) code and is not maintained by the Property Appraiser's office. Please contact your city or county Planning & Zoning office for specific zoning information.

2019	2016	2013	2010	2007	O 2005	✓ Sales
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Property &	Assess	sment Valu	ies		
2018 Certified Values			2019 Prelin	minary (	Certified
Mkt Land (1)		\$5,568	Mkt Land (1)		\$5,568
Ag Land (1)		\$1,828	Ag Land (1)		\$1,882
Building (1)		\$168,509	Building (1)		\$183,505
XFOB (1)		\$2,004	XFOB (1)		\$2,004
Just		\$203,309	Just		\$218,305
Class		\$177,909	Class		\$192,959
Appraised		\$177,909	Appraised		\$192,959
SOH Cap [?]		\$1,549	SOH Cap [?]		\$13,292
Assessed		\$174,799	Assessed		\$179,667
Exempt	нх нз	\$50,000	Exempt	нх нз	\$50,000
	count	y:\$124,799		count	y:\$129,667
Total	cit	ty:\$124,799	Total	cit	y:\$129,667
Taxable	othe	er:\$124,799	Taxable	othe	r:\$129,667
	schoo	ы:\$149,799		schoo	ı:\$154,667

▼ Sales History						
Sale Date	Sale Price	Book/Page	Deed	V/I	Quality (Codes)	RCode
2/2/2015	\$100	1288/1928	WD	V	U	11
2/27/1997	\$0	835/1147	WD	V	U	02 (Multi-Parcel Sale) - show

<b>▼</b> Building Cha	racteristics					
Bldg Sketch	Bldg Item	Bldg Desc*	Year Blt	Base SF	Actual SF	Bldg Value
Sketch	1	SINGLE FAM (000100)	2015	2439	3467	\$183,505

\*Bldg Desc determinations are used by the Property Appraisers office solely for the purpose of determining a property's Just Value for ad valorem tax purposes and should not be used for any other purpose.

<b>▼</b> Extra	▼ Extra Features & Out Buildings (Codes)							
Code	Desc	Year Blt	Value	Units	Dims	Condition (% Good)		
0166	CONC,PAVMT	2015	\$2,004.00	1002.000	0 x 0 x 0	(000.00)		

Land Code	Desc	Units	Adjustments	Eff Rate	Land Value
000100	SFR (MKT)	1.000 AC	1.00/1.00 1.00/1.00	\$5,568	\$5,568
005500	TIMBER 2 (AG)	4.890 AC	1.00/1.00 1.00/1.00	\$385	\$1,882
009910	MKT.VAL.AG (MKT)	4.890 AC	1.00/1.00 1.00/1.00	\$0	\$27,228

columbia.floridapa.com/gis/ 1/2

#### Legend

#### 2018Aerials

Roads

Roads

others

Dirt

Interstate

Main

Other


Paved

Private Parcels

LidarElevations

## Columbia County, FLA - Building & Zoning Property Map

Printed: Tue Sep 03 2019 16:51:05 GMT-0400 (Eastern Daylight Time)

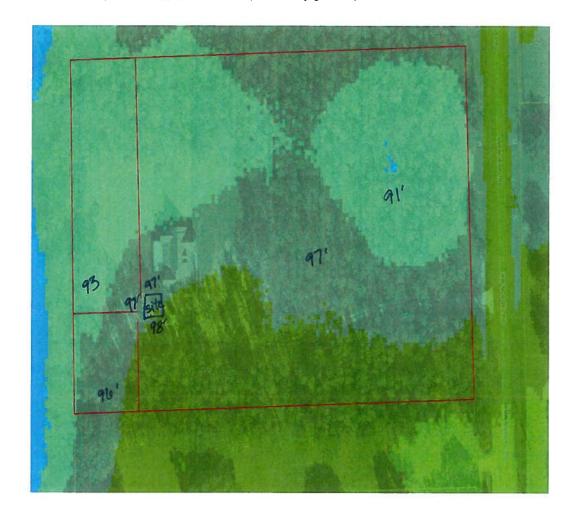

#### Parcel Information

Parcel No: 30-3S-16-02401-000

Owner: ROBINSON RYAN A & JENNIFER R

Subdivision:

Lot:

Acres: 5.66245461 Deed Acres: 5.89 Ac

District: District 3 Bucky Nash Future Land Uses: Agriculture - 3

Flood Zones:

Official Zoning Atlas: A-3







# STRUCTURAL DESIGN ENCLOSED BUILDING

# MAXIMUM 30'-0" WIDE X 20'-0" EAVE HEIGHT- BOX EAVE FRAME

14 December 2018 Revision 7 M&A Project No. 16062S/16155S/16207S/17155S/17200S/18068S/18156S/18290S

Prepared for:

Steel Buildings and Structures, Inc. P.O. Box 1287 Mt. Airy, NC 27030

Prepared by:

Moore and Associates Engineering and Consulting, Inc.

1009 East Avenue North Augusta, SC 29841

401 S. Main St., Suite 200 Mount Airy, NC 27030





				-100		
						NS. A
MOORE AND AS ENGINEERING AND C	ONSULTING, INC.	CHEC	n by: at CED by: PDH ECT NGR: VSN	STEEL BUII M 30'-0"x20	DINGS AND STRI P.O. BOX 1287, IOUNT AIRY, NC 2 D'-0" ENCLOSED S'	OF THE STATE OF TH
THES DOCUMENT IS THE PROPERTY OF MODRE AS CONSULTING, THE UNMITHDRIZED REPRODUCTION THES DOCUMENT IS STREETLY PREMINETED AND BE SUBJECT TO LEGAL ACTION.	COPYING, OR OTHERVISE USE OF NAY INFRINGEMENT THEREUPON MAY		-		DAC NO 2K-3	REV. 7

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SHEET 1A
             PE SEAL COVER SHEET (2 OF 2)
SHEET 2
             DRAWING INDEX
SHEET 3
             INSTALLATION NOTES AND SPECIFICATIONS
             TYPICAL SIDE AND END ELEVATIONS
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SHEET 4
             TYPICAL RAFTER/COLUMN FRAME AND SIDE FRAMING SECTION (BOX EAVE STRUCTURE)
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SHEET 15
SHEET 16
            OPTIONAL BASE RAIL ON TIMBER BEAM
            OPTIONAL BASE RAIL ON TIMBER BEAM
SHEET 17
            WITH SOIL NAIL
SHEFT 18
            OPTIONAL CONCRETE STRIP FOOTING
```



MOORE AND ASSOCIATES ENGINEERING AND CONSULTING, INC.	DRAVIN BY: AT CHECKED BY: PDH	STEEL BUILDINGS AND STRUCTURES, I P.O. BOX 1287, MOUNT AIRY, NC 27030 30'-0"x20'-0" ENCLOSED STRUCTURE		
THIS DOCUMENT IS THE PROPERTY OF MODRE AND ASSOCIATES ENGINEERING AND CONSULTING. THE UNAUTHORIZED REPRODUCTION, COPYING, OR OTHERWISE USE OF THIS DOCUMENT IS STRUCTLY PROMOBILED AND ANY DIFRINGEMENT THEREUPON MAY BE SUBJECT TO LEGAL ACTION.		DATE: 12-14-18		JUB ND 180685/ 181565/182905

#### INSTALLATION NOTES AND SPECIFICATIONS

- 1. DESIGN IS FOR MAXIMUM 30'-0" WIDE  $\times$  20'-0" EAVE HEIGHT ENCLOSED STRUCTURES.
- 2 DESIGN WAS DONE IN ACCORDANCE WITH THE 2017 FLORIDA BUILDING CODE (FBC) 6TH EDITION, 2018 NORTH CAROLINA BUILDING CODE, 2006 INTERNATIONAL BUILDING CODE (IBC), 2009 IBC, 2012 IBC AND 2015 IBC.
- 3. DESIGN LOADS ARE AS FOLLOWS:

A) DEAD LOAD

= 1.5 PSF

B) LIVE LOAD

- = 12 PSF
- C> GROUND SNOW LOAD = 30 PSF ( $\leq$  26'-0'), 35 PSF (26'-0'  $\leq$  W  $\leq$  30'-0')
  - (UNBALANCED SNOW LOADS DUE TO DRIFTING HAVE NOT BEEN EVALUATED.)
- 4. 3-SECOND GUST ULTIMATE WIND SPEED (V<sub>ULT</sub>) 105 TO 145 MPH (NOMINAL WIND SPEED 82 TO 112 MPH): MAXIMUM RAFTER/COLUMN AND END COLUMN SPACING = 5.0 FEET (UNLESS NOTED OTHERWISE).
- 5 END WALL COLUMNS (POST) ARE EQUIVALENT TO SIDE WALL POSTS UNLESS NOTED OTHERWISE.
- 6. RISK CATEGORY I.
- 7. WIND EXPOSURE CATEGORY B.
- 8. SPECIFICATIONS APPLICABLE TO 29 GAUGE METAL PANELS FASTENED DIRECTLY TO 2 1/2" x 2 1/2" 14 GAUGE TUBE STEEL (TS) FRAMING MEMBERS (UNLESS NOTED OTHERWISE)
- 9. AVERAGE FASTENER SPACING ON-CENTERS ALONG RAFTERS OR HAT CHANNELS, AND COLUMNS (INTERIOR OR END) = 8 INCHES.
- 10. FASTENERS CONSIST OF 1/4\*x3/4\* SELF-DRILLING FASTENER (SDF), USE CONTROL SEAL WASHER WITH EXTERIOR FASTENERS.

  SPECIFICATIONS APPLICABLE ONLY FOR MEAN ROOF HEIGHT OF 20 FEET OR LESS, AND ROOF SLOPES OF 14\* (3:12 PITCH) OR LESS SPACING REQUIREMENTS FOR OTHER ROOF HEIGHTS AND/OR SLOPES MAY VARY.
- 11. GROUND ANCHORS SHALL BE INSTALLED THROUGH BASE RAIL WITHIN 6° OF EACH COLUMN.
- 12. GROUND ANCHORS CONSIST OF #4 REBAR W/ WELDED NUT x 36' LONG IN SUITABLE SOIL CONDITIONS. OPTIONAL ANCHORAGE MAY BE USED IN SUITABLE SOILS AND MUST BE USED IN UNSUITABLE SOILS AS NOTED.
- 13. WIND FORCES GOVERN OVER SEISMIC FORCES, SEISMIC PARAMETERS ANALYZED ARE: SDIL SITE CLASS = D RISK CATEGORY I/II/III

I<sub>E</sub>= 1.0 R = 3.25

Sps= 5.039

V= CsW

S<sub>D1</sub>= 1.258


14. WINDOW AND DOOR DESIGN PRESSURES ARE APPLICABLE TO THE STATE OF FLORIDA ONLY.




MOODE AND ACCOCLATED		STEEL BUT	LDINGS AND S	STRUCTURES, INC.		
MOORE AND ASSOCIATES	DRAWN BY: AT	!	P.O. BOX 1287,			
ENGINEERING AND CONSULTING, INC.	CONSTITUTING INC			Y, NC 27030		
EndineElding Mild ComboLimo, Mc.	CHECKED BY: PDH	30'-0"x2	0'-0" ENCLOSE	D STRUCTURE		
THIS DOCUMENT IS THE PROPERTY OF MODIFE AND ASSOCIATES ENGINEERING AND CONSULTING. THE UNAUTHORIZED REPRODUCTION, COPYING, OR OTHERWISE USE OF THIS DOCUMENT IS STRUCTLY PROHOBITED AND ANY INFRINGEMENT THEREUPON MAY BE SURJECT TO LEGAL ACTION.	PROJECT NGR: VSN	DATE: 12-14-18	SCALE: NTS	JEB NE 180685/ 181565/182905		
I THIS DOCUMENT IS STRUCTLY PROHIBITED AND ANY DEFRINGENENT THERETIEN MAY		2410 44 14 10	GOTED III'S	311 101 101363716E 903		
BE SUBJECT TO LEGAL ACTION.	CLIENT: SBSI	SHT. 3	DAC" ND 2K-	3 REV. 7		

# VINDOW (AS APPLICABLE) DESIGN PRESSURE (218 PSF, -236 PSF) LENGTH VARIES DEPENDING ON NUMBER AND SPACING OF RAFTERS


TYPICAL SIDE ELEVATION

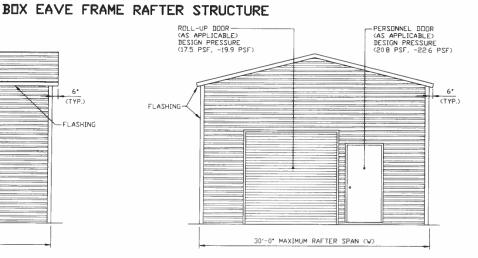

TYPICAL END ELEVATION SCALE: NTS

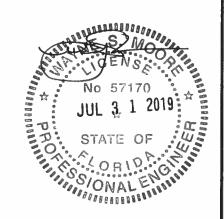


MOORE AND ASSOCIATES ENGINEERING AND CONSULTING, INC.	DRAWN BY: AT CHECKED BY: PDH	N	P.O. BOX 1 MOUNT AIRY, 1	- 12
THIS DOCUMENT IS THE PROPERTY OF MODRE AND ASSOCIATES ENGINEERING AND CONSULTING. THE UNAUTHORIZED REPRODUCTION, COPYING, OR OTHERWISE USE OF THIS DOCUMENT IS STRUCTLY PROMORTED AND ANY DEFINIGEMENT THERELPOIN MAY BE SUBJECT TO LEGAL ACTION.		DATE: 12-14-18	SCALE: NTS	JUB ND 180565/182905

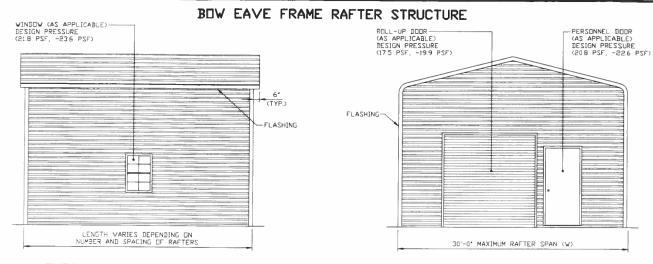


TYPICAL SIDE ELEVATION

SCALE: NTS


TYPICAL END ELEVATION
SCALE: NTS

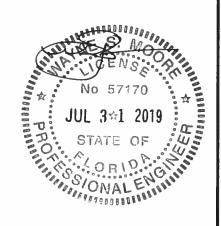


moore in bridge title	DRAWN BY: AT	]	P.O. BOX 1287,			
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SCALE NTS

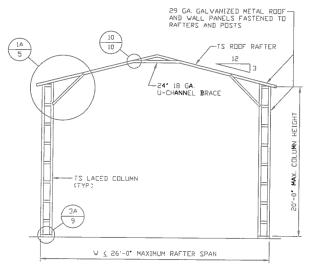

TYPICAL RAFTER/COLUMN FRAME SECTION
SCALE: NTS

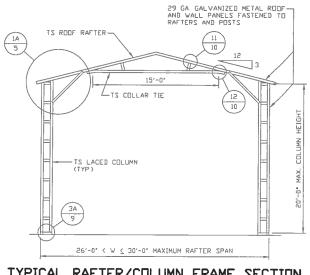

TYPICAL RAFTER/COLUMN SIDE FRAMING SECTION

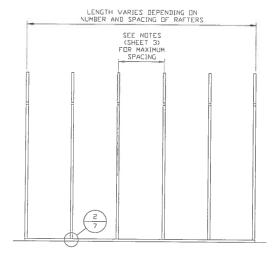
No 57170

JUL 3-1 2019


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MOORE AND ASSOCIATES  DRAWN BY: AT  STEEL BUILDINGS AND STRUCTURES, INC. P.O. BOX 1287,	



RAFTER/COLUMN FRAME SECTION

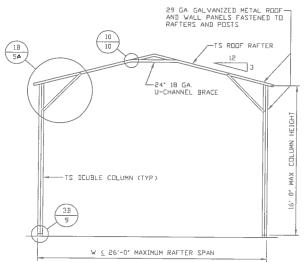

TYPICAL RAFTER/COLUMN SIDE FRAMING SECTION SCALE NTS

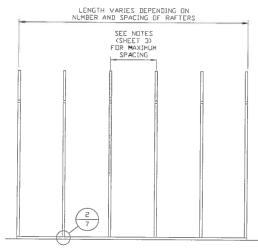
29 GA GALVANIZED METAL ROOF-AND WALL PANELS FASTENED TO RAFTERS AND POSTS TS ROOF RAFTER-11 10 1B 5A 12 15'-0" LTS COLLAR TIE 12 - TS DOUBLE COLUMN (TYP.) 26'-0" < W < 30'-0" MAXIMUM RAFTER SPAN SCALE: NTS

16'-0" MAX. COLUMN HEIGHT

TYPICAL RAFTER/COLUMN FRAME SECTION

No 57170  JUL 341 2019  STATE OF  ORIDARIAN  ORIDARIAN  SONAL ENGINEERING
ORIDONAL ENGINEERS


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MOORE AND ASSOCIATES DRAW	DRAWN BY: AT	]	P.O. BOX 1	*
				<del>:</del>

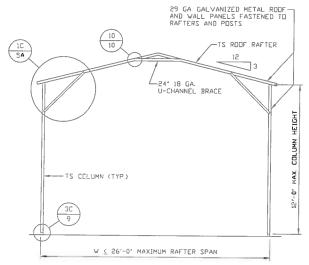


LENGTH VARIES DEPENDING DN
NUMBER AND SPACING OF RAFTERS

SEE NOTES
(SHEET 3)
FOR MAXIMUM
SPACING


TYPICAL RAFTER/COLUMN SIDE FRAMING SECTION SCALE NTS

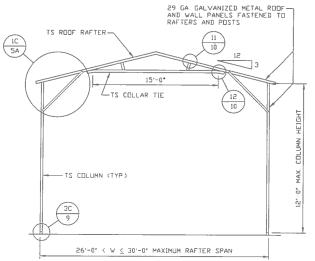


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SCALE NTS

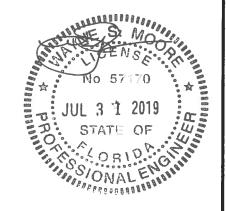


MOORE AND ASSOCIATES ENGINEERING AND CONSULTING, INC.	DRAVIN BY: AT CHECKED BY: PDH	STEEL BUILDINGS AND STRUCTURES. P.O. BOX 1287, MOUNT AIRY, NC 27030 30'-0"x20'-0" ENCLOSED STRUCTURE			
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LENGTH VARIES DEPENDING ON NUMBER AND SPACING OF RAFTERS

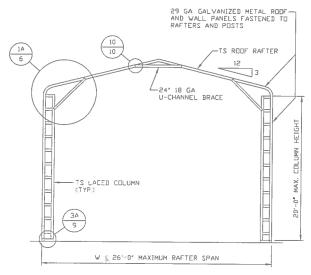


## TYPICAL RAFTER/COLUMN SIDE FRAMING SECTION SCALE NTS

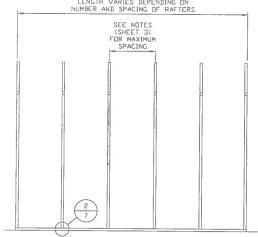


TYPICAL RAFTER/COLUMN FRAME SECTION
SCALE NTS

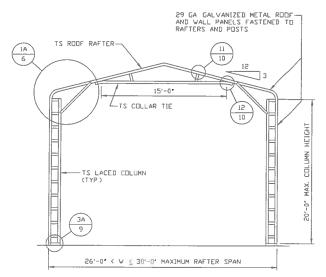


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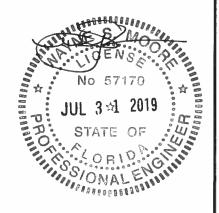
SCALE: NTS

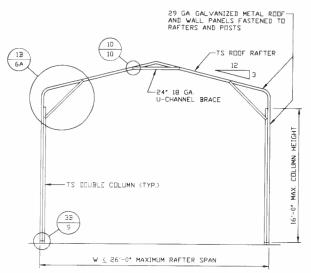


TYPICAL RAFTER/COLUMN FRAME SECTION
SCALE: NTS

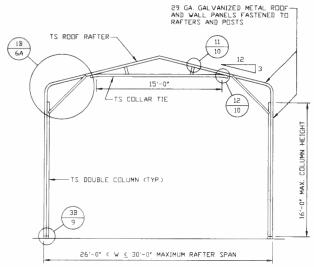


TYPICAL RAFTER/COLUMN SIDE FRAMING SECTION

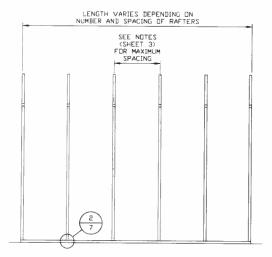


MOORE AND ASSOCIATES ENGINEERING AND CONSULTING, INC.	DRAVN BY: AT CHECKED BY: PDH	STEEL BUILDINGS AND STRUCTURES, INC P.O. BOX 1287, MOUNT AIRY, NC 27030 30'-0"x20'-0" ENCLOSED STRUCTURE			30
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TYPICAL RAFTER/COLUMN FRAME SECTION

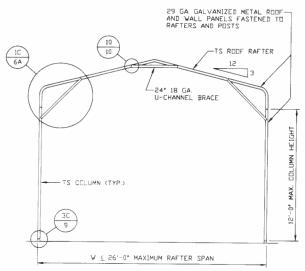


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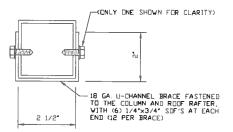
TYPICAL RAFTER/COLUMN SIDE FRAMING SECTION SCALE NTS

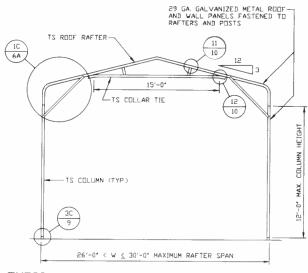

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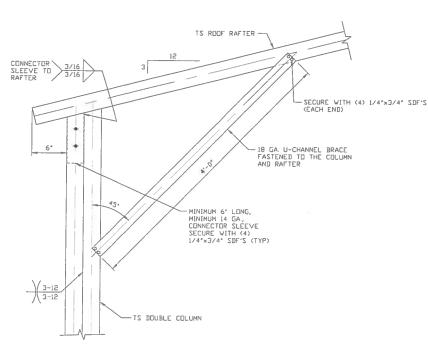
BOX EAVE RAFTER/CORNER POST CONNECTION DETAIL
FOR HEIGHTS 16'-0' < TO < 20'-0"

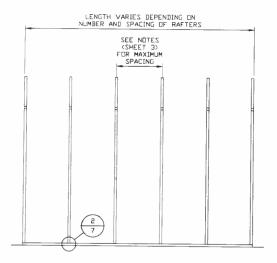

BRACE SECTION
SCALE: NTS

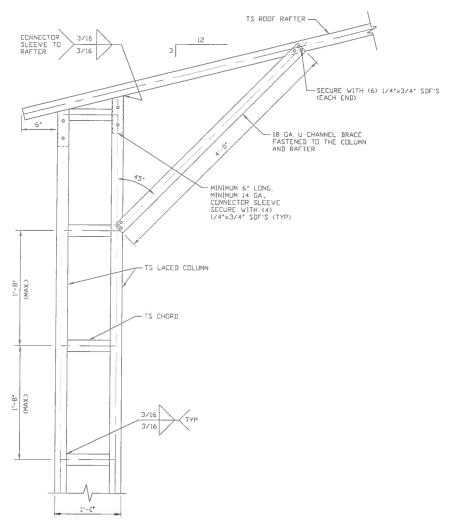

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MOORE AND ASSOCIATES	DRAWN BY: AT	STEEL BUI	LDINGS AND S P.O. BOX 13		TURES, INC.



18 GA. U-CHANNEL BRACE FASTENED
TO THE COLLUM AND ROOF RAFTER,
WITH (4) 1/4\*x3/4\* SDF'S AT EACH
END (8 PER BRACE)


#### BRACE SECTION


SCALE NTS

BOX EAVE RAFTER/CORNER POST CONNECTION DETAIL


FOR HEIGHTS 12'-0' < TO < 16'-0'

SCALE: NTS

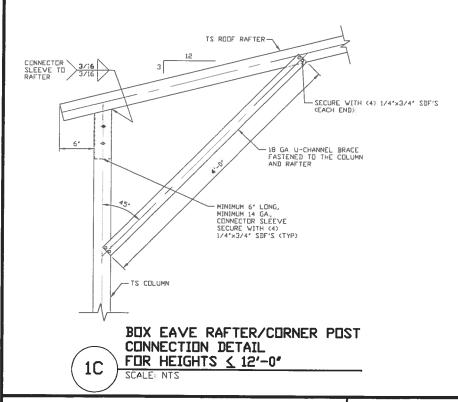


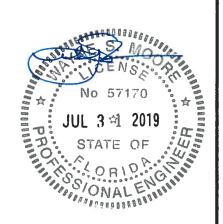

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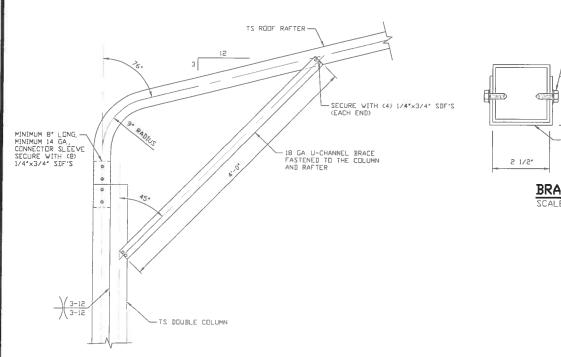
BOX EAVE RAFTER/CORNER POST CONNECTION DETAIL
FOR HEIGHTS 16'-0" < TO < 20'-0"

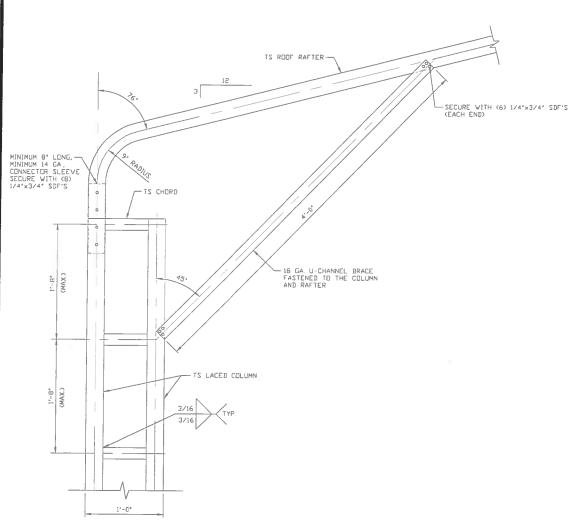

BRACE SECTION
SCALE: NTS

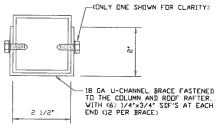

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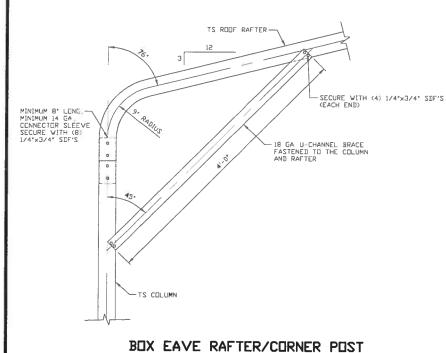


IB GA U-CHANNEL BRACE FASTENED
TO THE COLUMN AND ROOF RAFTER,
VITH (4) 1/4\*x3/4\* SDF'S AT EACH
END (8 PER BRACE)

#### BRACE SECTION

SCALE: NTS

BOX EAVE RAFTER/CORNER POST CONNECTION DETAIL FOR HEIGHTS 12'-0" < TO < 16'-0"



No 57170

JUL 3 1 2019

STATE OF

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CONNECTION DETAIL

FOR HEIGHTS & 12'-0'


SCALE: NTS

MOORE AND ASSOCIATES
ENGINEERING AND CONSULTING, INC.

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-	MOUNT AIRY, NC 27030
CHECKED BY: PDH	30'-0"x20'-0" ENCLOSED STRUCTURE

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$\dashv$	PROJECT NGR: VSH	DATE: 12-14-18	SCALE: NTS	JUB ND 18156\$/18290\$
	CLIENT: SBSI	SHT. 6A	DVG. ND: SK-3	REV. 7

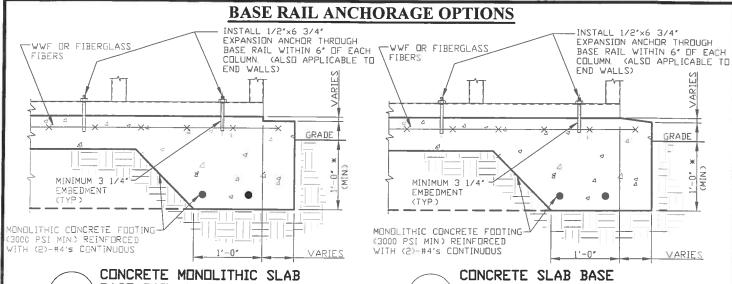

#### BASE RAIL ANCHORAGE

SCALE NTS MINIMUM ANCHOR EDGE DISTANCE IS 4" COURDINATE WITH LOCAL CODES/ORD

#### GENERAL NOTES

NOTE CONCRETE MONOLITHIC SLAB DESIGN BASED ON MINIMUM SOIL BEARING CAPACITY OF 1,500 PSF

#### CONCRETE:

CONCRETE SHALL HAVE A MINIMUM SPECIFIED COMPRESSIVE STRENGTH OF 3,000 PSI AT 28 DAYS.

COVER OVER REINFORCING STEEL:

FOR FOUNDATIONS, MINIMUM CONCRETE COVER OVER REINFORCING BARS SHALL BE PER ACI-318:

3' IN FOUNDATIONS WHERE THE CONCRETE IS CAST AGAINST AND PERMANENTLY IN CONTACT WITH THE EARTH OR EXPOSED TO THE EARTH OR WEATHER, AND 1 1/2' ELSEWHERE.

#### REINFORCING STEEL:

THE TURNDOWN REINFORCING STEEL SHALL BE ASTM A615 GRADE 60 THE SLAB REINFORCEMENT SHALL BE WELDED WIRE FABRIC MEETING ASTM A185 OR FIBERGLASS FIBER REINFORCEMENT.

#### REINFORCEMENT MAY BE BENT IN THE SHOP OR THE FIELD PROVIDED

- REINFORCEMENT IS BENT COLD.
  THE DIAMETER OF THE BEND, MEASURED ON THE INSIDE OF THE BAR, IS NOT LESS THAN SIX-BAR DIAMETERS.
  REINFORCEMENT PARTIALLY EMBEDDED IN CONCRETE SHALL NOT
- BE FIELD BENT

#### HELIX ANCHOR NOTES:

- 1 FOR VERY DENSE AND/OR CEMENTED SANDS, COARSE GRAVEL AND COBBLES, CALICHE, PRELOADED SILTS AND CLAYS, USE MINIMUM (2) 4" HELICES WITH MINIMUM 30" EMBEDMENT OR SINGLE 6" HELIX WITH MINIMUM 50" EMBEDMENT
- FOR CORAL USE MINIMUM (2) 4" HELICES WITH MINIMUM 30" EMBEDMENT OR SINGLE 6" HELIX WITH MINIMUM 50" EMBEDMENT
- FOR MEDIUM DENSE COARSE SANDS, SANDY GRAVELS, VERY STIFF SILTS, AND CLAYS USE MINIMUM (2) 4" HELICES WITH MINIMUM 30 INCH EMBEDMENT OR SINGLE 6" HELIX WITH MINIMUM 50" EMBEDMENT
- FOR LODGE TO MEDIUM DENSE SANDS, FIRM TO STIFF CLAYS AND SILTS ALLUVIAL FILL, USE MINIMUM (2) 6' HELICES WITH MINIMUM 50' EMBEDMENT.
- 5 FOR VERY LOSE TO MEDIUM DENSE SANDS, FIRM TO STIFFER CLAYS AND SILTS, ALLUVIAL FILL, USE MINIMUM (2) 8" HELICES WITH MINIMUM 6C" EMBEDMENT.





SCALE: NTS MINIMUM ANCHOR EDGE DISTANCE IS 4".
\* COORDINATE WITH LOCAL CODES/ORD VARI

WIN

GRADE


VARIES

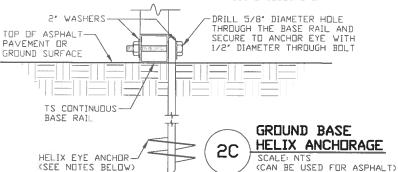

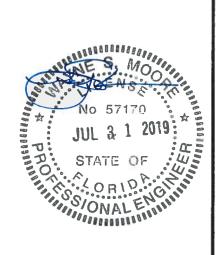


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#### **BOX EAVE RAFTER END WALL AND SIDE WALL OPENINGS**

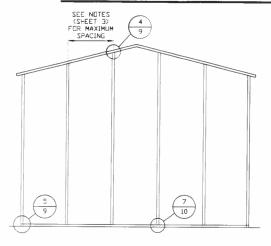


# TYPICAL BOX EAVE RAFTER END WALL FRAMING SECTION

SCALE: NTS

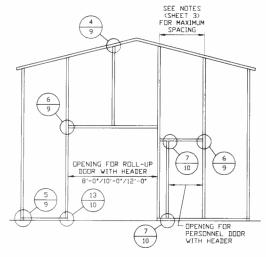


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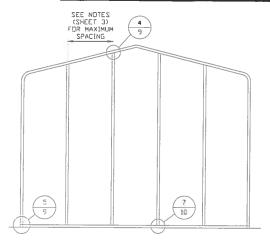
# TYPICAL BOX EAVE RAFTER SIDE WALL OPENINGS FRAMING SECTION

SCALE: NTS

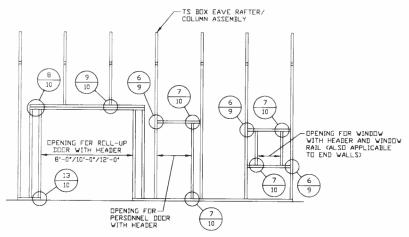


ENGINEERING AND CONSULTING, INC.	PROJECT MGR WSM	0'-0" ENCLOSE SCALE: NTS	 JCTURE 18068\$/ D 18156\$/18290\$
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### **BOX EAVE RAFTER END WALL AND SIDE WALL OPENINGS**

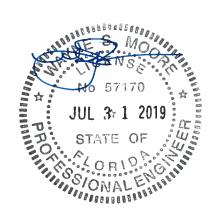


# TYPICAL BOX EAVE RAFTER END WALL FRAMING SECTION

SCALE NTS

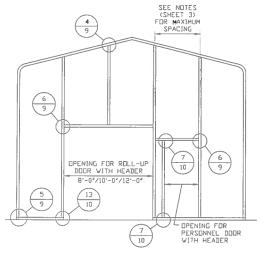

# TYPICAL BOX EAVE RAFTER END WALL OPENINGS FRAMING SECTION

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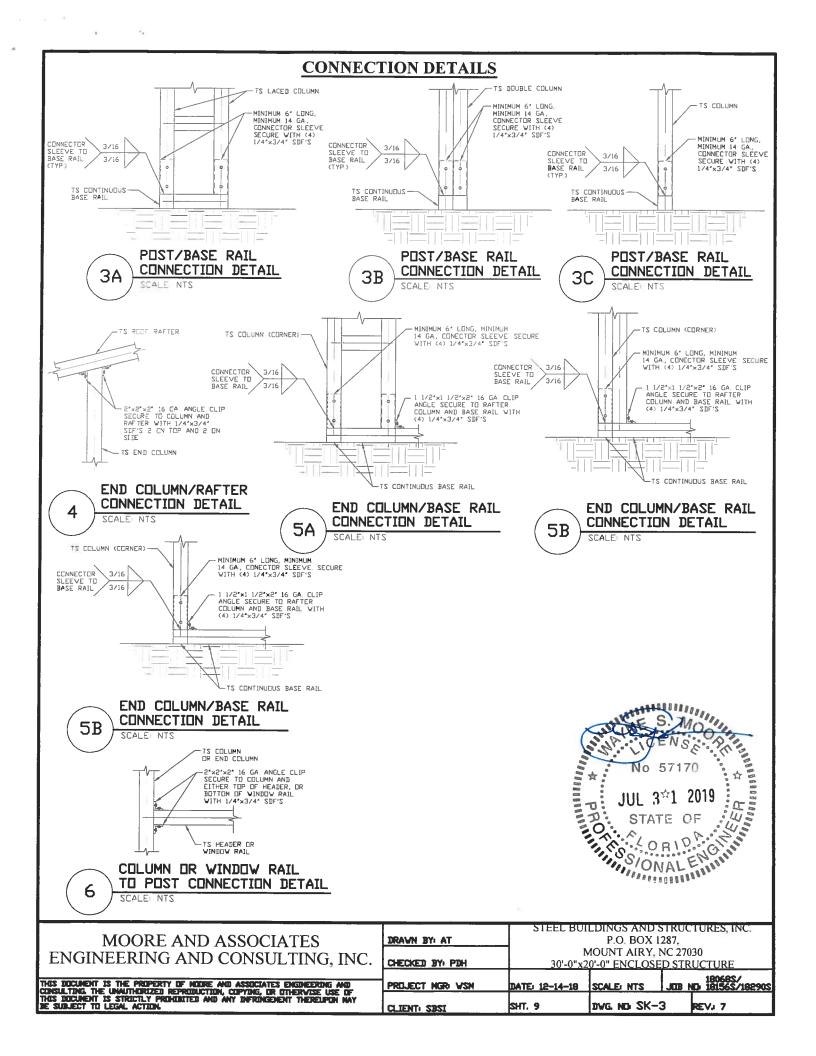

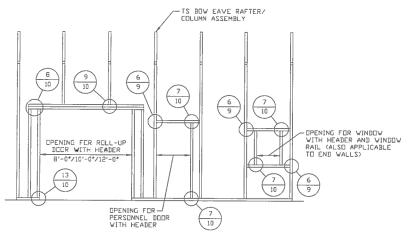
# TYPICAL BOX EAVE RAFTER SIDE WALL OPENINGS FRAMING SECTION


SCALE NTS



		STEEL BUI		TRUCTURES, INC.
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ENGINEERING AND CONSULTING, INC.		N	MOUNT AIRY, N	NC 27030
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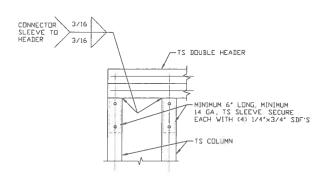


#### **CONNECTION DETAILS**

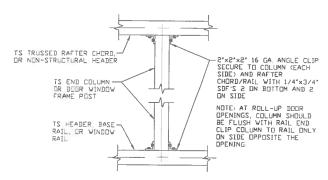


7 COLUMN TO HEADER, BASE RAIL, OR WINDOW RAIL CONNECTION DETAIL

SCALE NTS




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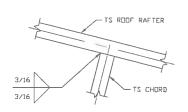
8 DOUBLE HEADER/COLUMN
CONNECTION DETAIL
SCALE NTS

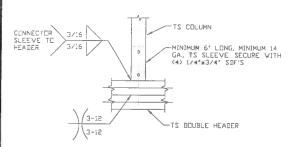


9 COLUMN/DOUBLE HEADER
CONNECTION DETAIL
SCALE NTS

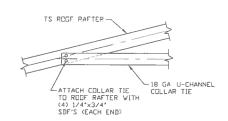


10 COLLAR TIE CONNECTION DETAIL



RAFTER TO CHORD CONNECTION DETAIL SCALE: NTS

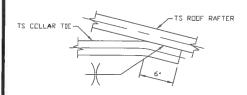

12 COLLAR TIE CONNECTION DETAIL

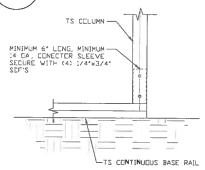


13 COLUMN/BASE RAIL CONNECTION DETAIL




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ENGINEEDING AND CONCULTING INC	CHECKED BY: PDH	MOUNT AIRY, NC 27030 30'-0"x20'-0" ENCLOSED STRUCTURE			
MOORE AND ASSOCIATES	DRAWN BY: AT	STEEL BUI	LDINGS AND S P.O. BOX 1		TURES, INC.

#### **BOX EAVE RAFTER LEAN-TO OPTIONS**

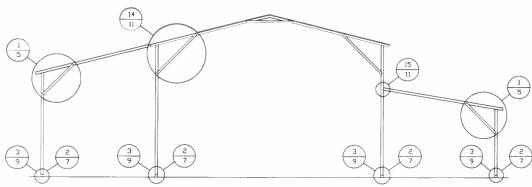


TYPICAL BOX EAVE RAFTER LEAN-TO OPTIONS FRAMING SECTION (BOTH OPTIONS SHOWN)

SCALE: NTS

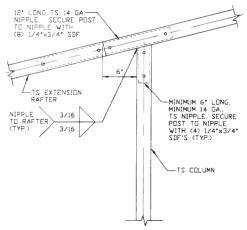

SIDE EXTENSION RAFTER/
CORNER POST DETAIL


SCALE: NTS

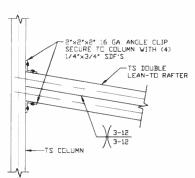

LEAN-TO RAFTER TO RAFTER POST CONNECTION DETAIL FOR WIDTHS 12'-0" < TO \( \leftarrow\) 16'-0"

SCALE: NTS

15A

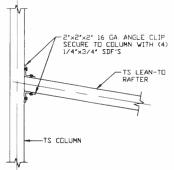

LEAN-TO RAFTER
TO RAFTER POST
CONNECTION DETAIL
FOR WIDTHS \( 12'-0'')

SCALE: NTS

15B

AND 57170

AND 57170

STATE OF

ORIO


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ENGINEERING AND CONSULTING, INC.

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	MOUNT AIRY, NC 27030				
DRAWN BY: AT	P.O. BOX 1287,				
	STEEL BUILDINGS AND STRUCTURES, INC.				


PROJECT NG	NO DATE	12-14-18 SCAL	E NTS JOB	18068\$/ ND: 18156\$/18290\$
CLIENT: SBS	SHT.	11 DVG.	ND SK-3	REV. 7

#### **BOW EAVE RAFTER LEAN-TO OPTIONS**

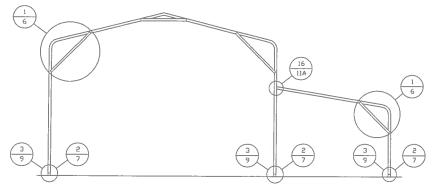


#### TYPICAL BOW EAVE RAFTER LEAN-TO OPTIONS FRAMING SECTION

SCALE: NTS

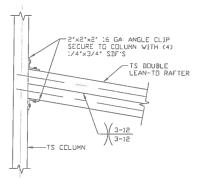

LEAN-TO RAFTER TO RAFTER POST CONNECTION DETAIL FOR WIDTHS 12'-0' < TO \( \) 16'-0'

16A) SCALE NTS

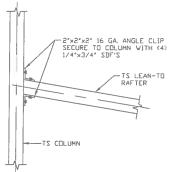

LEAN-TO RAFTER
TO RAFTER POST
CONNECTION DETAIL
FOR WIDTHS & 12'-0"

16B

No 57170

JUL 3 2019

STATE OF


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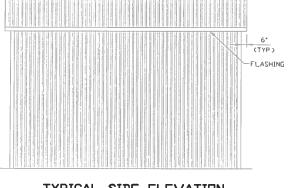
MOORE AND ASSOCIATES	DRAWN BY: AT	ŀ	P.O. BOX 1	,
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#### **BOX EAVE RAFTER VERTICAL ROOF/SIDING OPTION**




#### TYPICAL END ELEVATION VERTICAL ROOF/SIDING

SCALE NTS

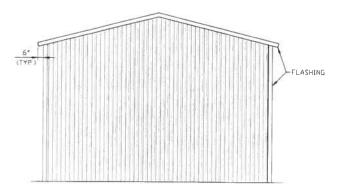


#### TYPICAL SIDE ELEVATION VERTICAL ROOF/SIDING SCALE: NTS

1125"-I8 GAUGE-HAT CHANNEL PURLIN

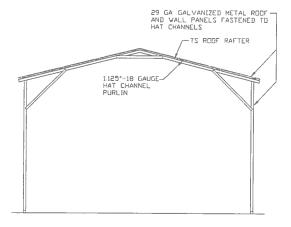

#### TYPICAL SECTION VERTICAL ROOF/SIDING OPTION

PANEL ATTACHMENT (ALTERNATE FOR VERTICAL ROOF PANELS) SCALE: NTS

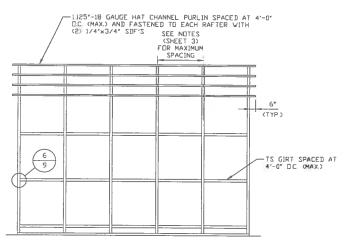


TYPICAL FRAMING SECTION VERTICAL ROOF/SIDING OPTION



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#### **OPTIONAL HEADER**

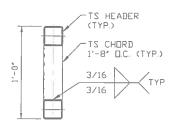


HEADER DETAIL FOR DOOR
OPENINGS 12'-0" < LENGTH < 20'-0"

SCALE: NTS




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ENGINEEDING AND CONCLUTING INC	CHECKED BY: PDH	· ·	AOUNT AIRY, I 0'-0" ENCLOSE	NC 27030 ED STRUCTURE
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#### ADDITIONAL BASE RAIL ANCHORAGE OPTION

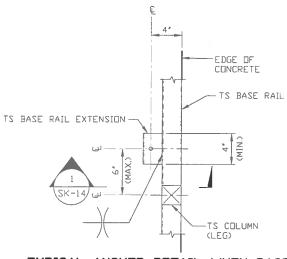


TYPICAL ANCHOR DETAIL WHEN BASE RAIL IS NEAR EDGE OF CONCRETE

SCALE NTS

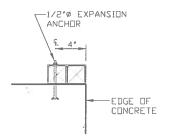



SECTION 1 SCALE: NTS SK-14

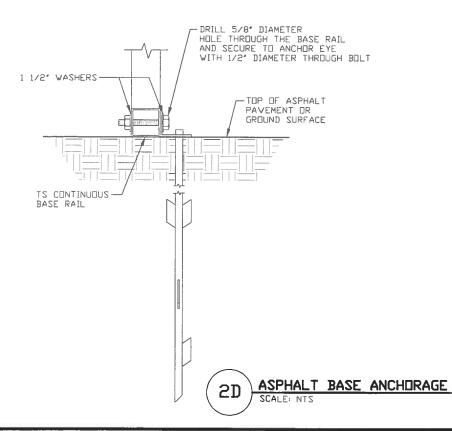




		STEEL BUI	LDINGS AND S	STRUCTURES, INC.
MOORE AND ASSOCIATES	DRAWN BY: AT		P.O. BOX 1	287,
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## **OPTIONAL CONCRETE STRIP FOOTING** Q FOOTING AND BASE RAIL FOOTING AND BASE RAIL 30'-0" MAXIMUM LENGTH RAIL BASE TS BASE RAIL CONCRETE STRIP FOOTING (3000 PSI MIN) CONCRETE STRIP FOOTING PLAN SCALE: NTS TS RAFTER POST S. TS BASE RAIL GRADE MIN -2 #4 T&B INSTALL 1/2'x6 3/4' EXPANSION ANCHOR THROUGH BASE RAIL WITHIN 6' OF EACH COLUMN MINIMUM 3 1/4' EMBEDMENT (TYP) 2" CLR. ū **SECTION** SK-18, \* COORDINATE WITH LOCAL CODES/ORD. STEEL BUILDINGS AND STRUCTURES, INC. MOORE AND ASSOCIATES P.O. BOX 1287, DRAWN BY AT MOUNT AIRY, NC 27030 ENGINEERING AND CONSULTING, INC. CHECKED BY: PDH 30'-0"x20'-0" ENCLOSED STRUCTURE 180685/ JUD ND 181565/182905 THIS DOCUMENT IS THE PROPERTY OF MODRE AND ASSOCIATES ENGINEERING AND CONSULTING. THE UNWITHORIZED REPRODUCTION, COPYING, OR OTHERWISE USE OF THIS DOCUMENT IS STREETLY PROHOBITED AND ANY INFRINGEMENT THEREUPON MAY BE SUBJECT TO LEGAL ACTION. PROJECT MGR: VSN DATE: 12-14-18 SCALE: NTS SHT. 18 DVG ND SK-3 REV. 7 CLIENT: SBSI

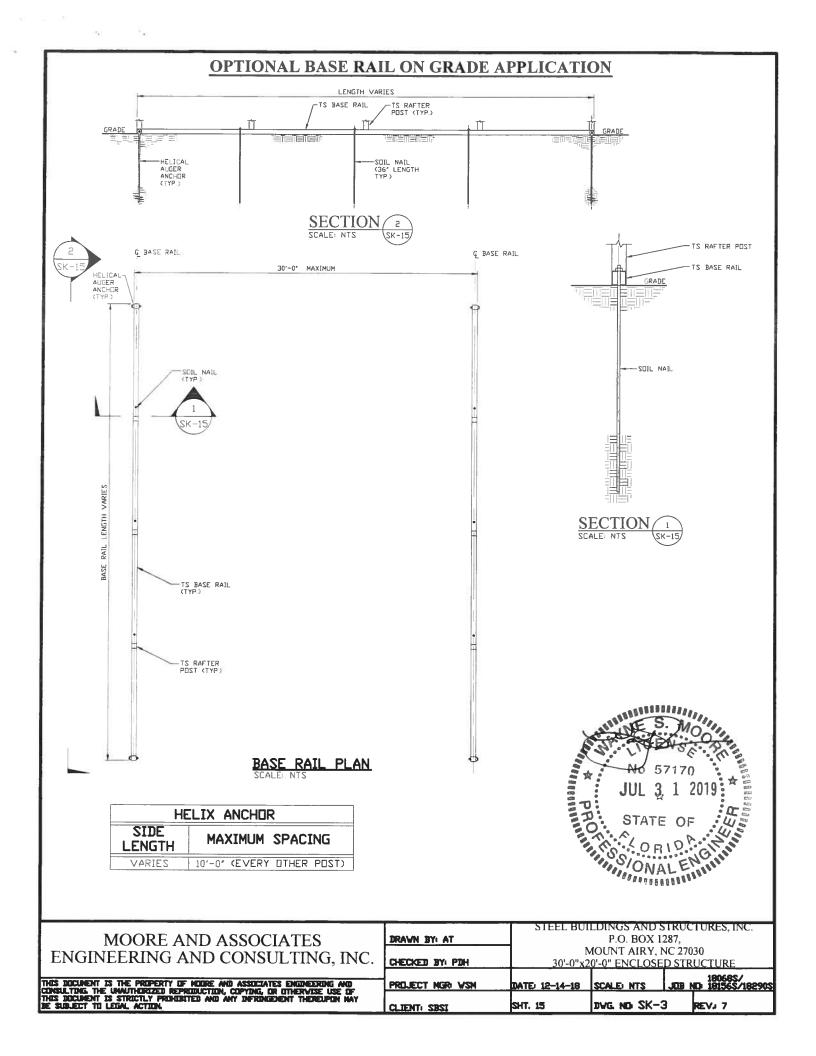As required by Florida Statute 553,842 and Florida Administrativa Code 93-72, please plant in the information and approval numbers on the building components fisled below if they will be utilized on the construction project for which you are applying for a building permit. We recommend you context your local product supplier should you not know the product approval number for any of the applicable listed products. Statewide approved products are listed online @ www.hordabuilding.org

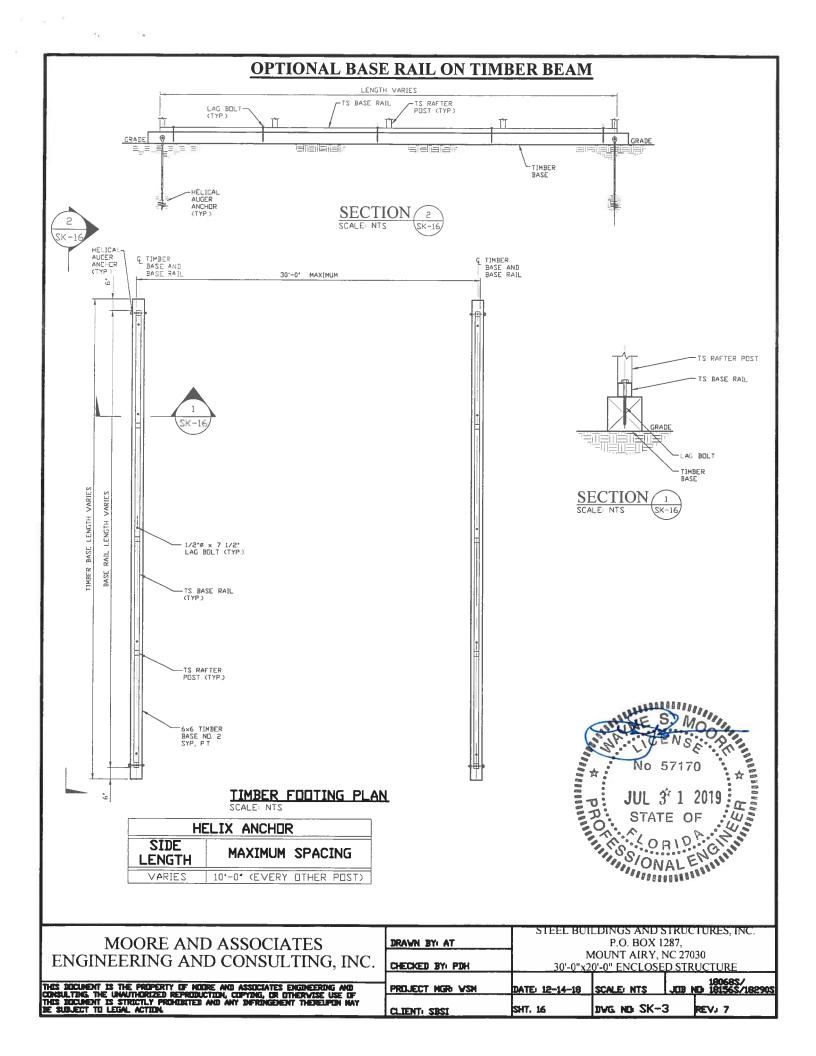Category/Subcategory	Manufacturer	Product Description	Approval Number(s)
1. EXTERIOR DOORS			
A. SWINGING	Pocahratas	Entry dear	12903.1
B. SLIDING			
C. SECTIONAL/ROLL UP	Asta	1203 Correccial mindlock	8888- 25
D. OTHER			
	9		
2. WINDOWS	1		
A. SINGLE/DOUBLE HUNG	Parahmetas	Stidion, Window	19940.1
B. HORIZONTAL SLIDER		J	
C. CASEMENT			
D. FIXED	1		
E. MULLION			
F. SKYLIGHTS			
G. OTHER			
			4
3. PANEL WALL			
A. SIOING			
8. SOFFITS			
C. STOREFRONTS			
D. GLASS BLOCK	ą		
E OTHER	Steel Buildings	1 AG MASTAL WALL	<i>მ</i> მ569.\
	3		
4. RODANG PRODUCTS			
A. ASPHALT SHINGLES			
B: WON-STRUCT METAL			
C. ROOFING TILES			
D. SIMGLE PLY ROOF			
E OTHER			
5. STRUCT COMPONENTS			
A. WOOD CONNECTORS			
BL WOOD ANCHORS			
C. TRUSS PLATES			
D. INSULATION FORMS			
E. LINTELS			
F. OTHERS	Steel Buildings	AG Metal Roof	22561-1
6. NEW EXTERIOR			
ENVELOPE PRODUCTS		1	

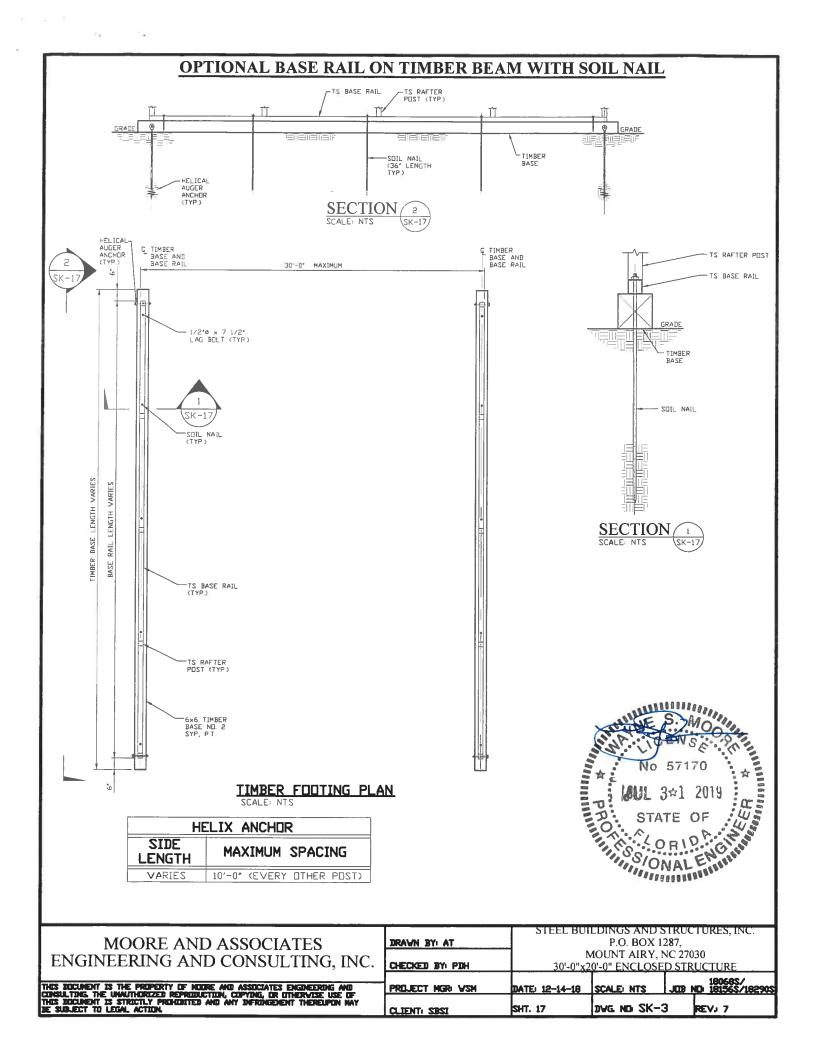The products listed below did not demonstrate product approval at plan review. I understand that at the time of inspection of these products, the following information must be available to the inspector on the jobsite; 1) copy of the product approval, 2) performance characteristics which the product was tested and certified to comply with, 3) copy of the applicable manufacturers installation requirements.

Further | Understand these products may have to be removed if approval cannot be demonstrated during inspection.

NOTES:	_
W. And Company of the Administration and the	