





- EXPANSIVE SOILS: WHERE DIRECTED BY THE SOILS ENGINEER, SOIL AUGMENTATION PER THE SOILS ENGINEER'S SPECIFICATIONS SHALL BE IMPLEMENTED PRIOR TO PLACING ANY FOUNDATIONS TESTS AS SPECIFIED SHALL BE PREFORMED TO DETERMINE THE SUITABILITY OF THE SUB-GRADE TO SUPPORT THE DESIGN LOADS.

- WELDED WIRE MESH SLAB REINFORCING SHALL MEET THE REQUIRE-MENTS OF ASTM A185 MIN, YEILD STRESS = 85 KSI, REINFORCING STEEL SHALL BE GRADE 60 AND MEET THE REQUIRE. MENTS OF ASTM A615, ALL BENDS SHALL BE MADE COLD.
- CONCRETE SHALL BE STANDARD MIX F'C = 3000 PSI FOR ALL FTGS, SLABS, COLUMNS AND BEAMS OR SHALL BE STANDARD PUMP MIX F'C = 3000 PSI. STRENGTH SHALL BE ATTAINED WITHIN 28 DAYS OF PLACE-MENT. MIXING, PLACING AND FINISHING SHALL BE AS PER ACI STANDARDS.
- CONCRETE BLOCK SHALL BE AS PER MANUFACTURER'S PRODUCT GUIDE FOR ASTM C-90 REQUIREMENTS WITH MEDIUM SURFACE FINISH F'm = 1500 PSI.
- STRUCTURAL STEEL SHALL CONFORM TO ASTM A36 STANDARDS FOR STRENGTH, BOLTS SHALL BE ASTM A307 / GRADE 1 OR A325, AS PER PLAN REQUIREMENTS.

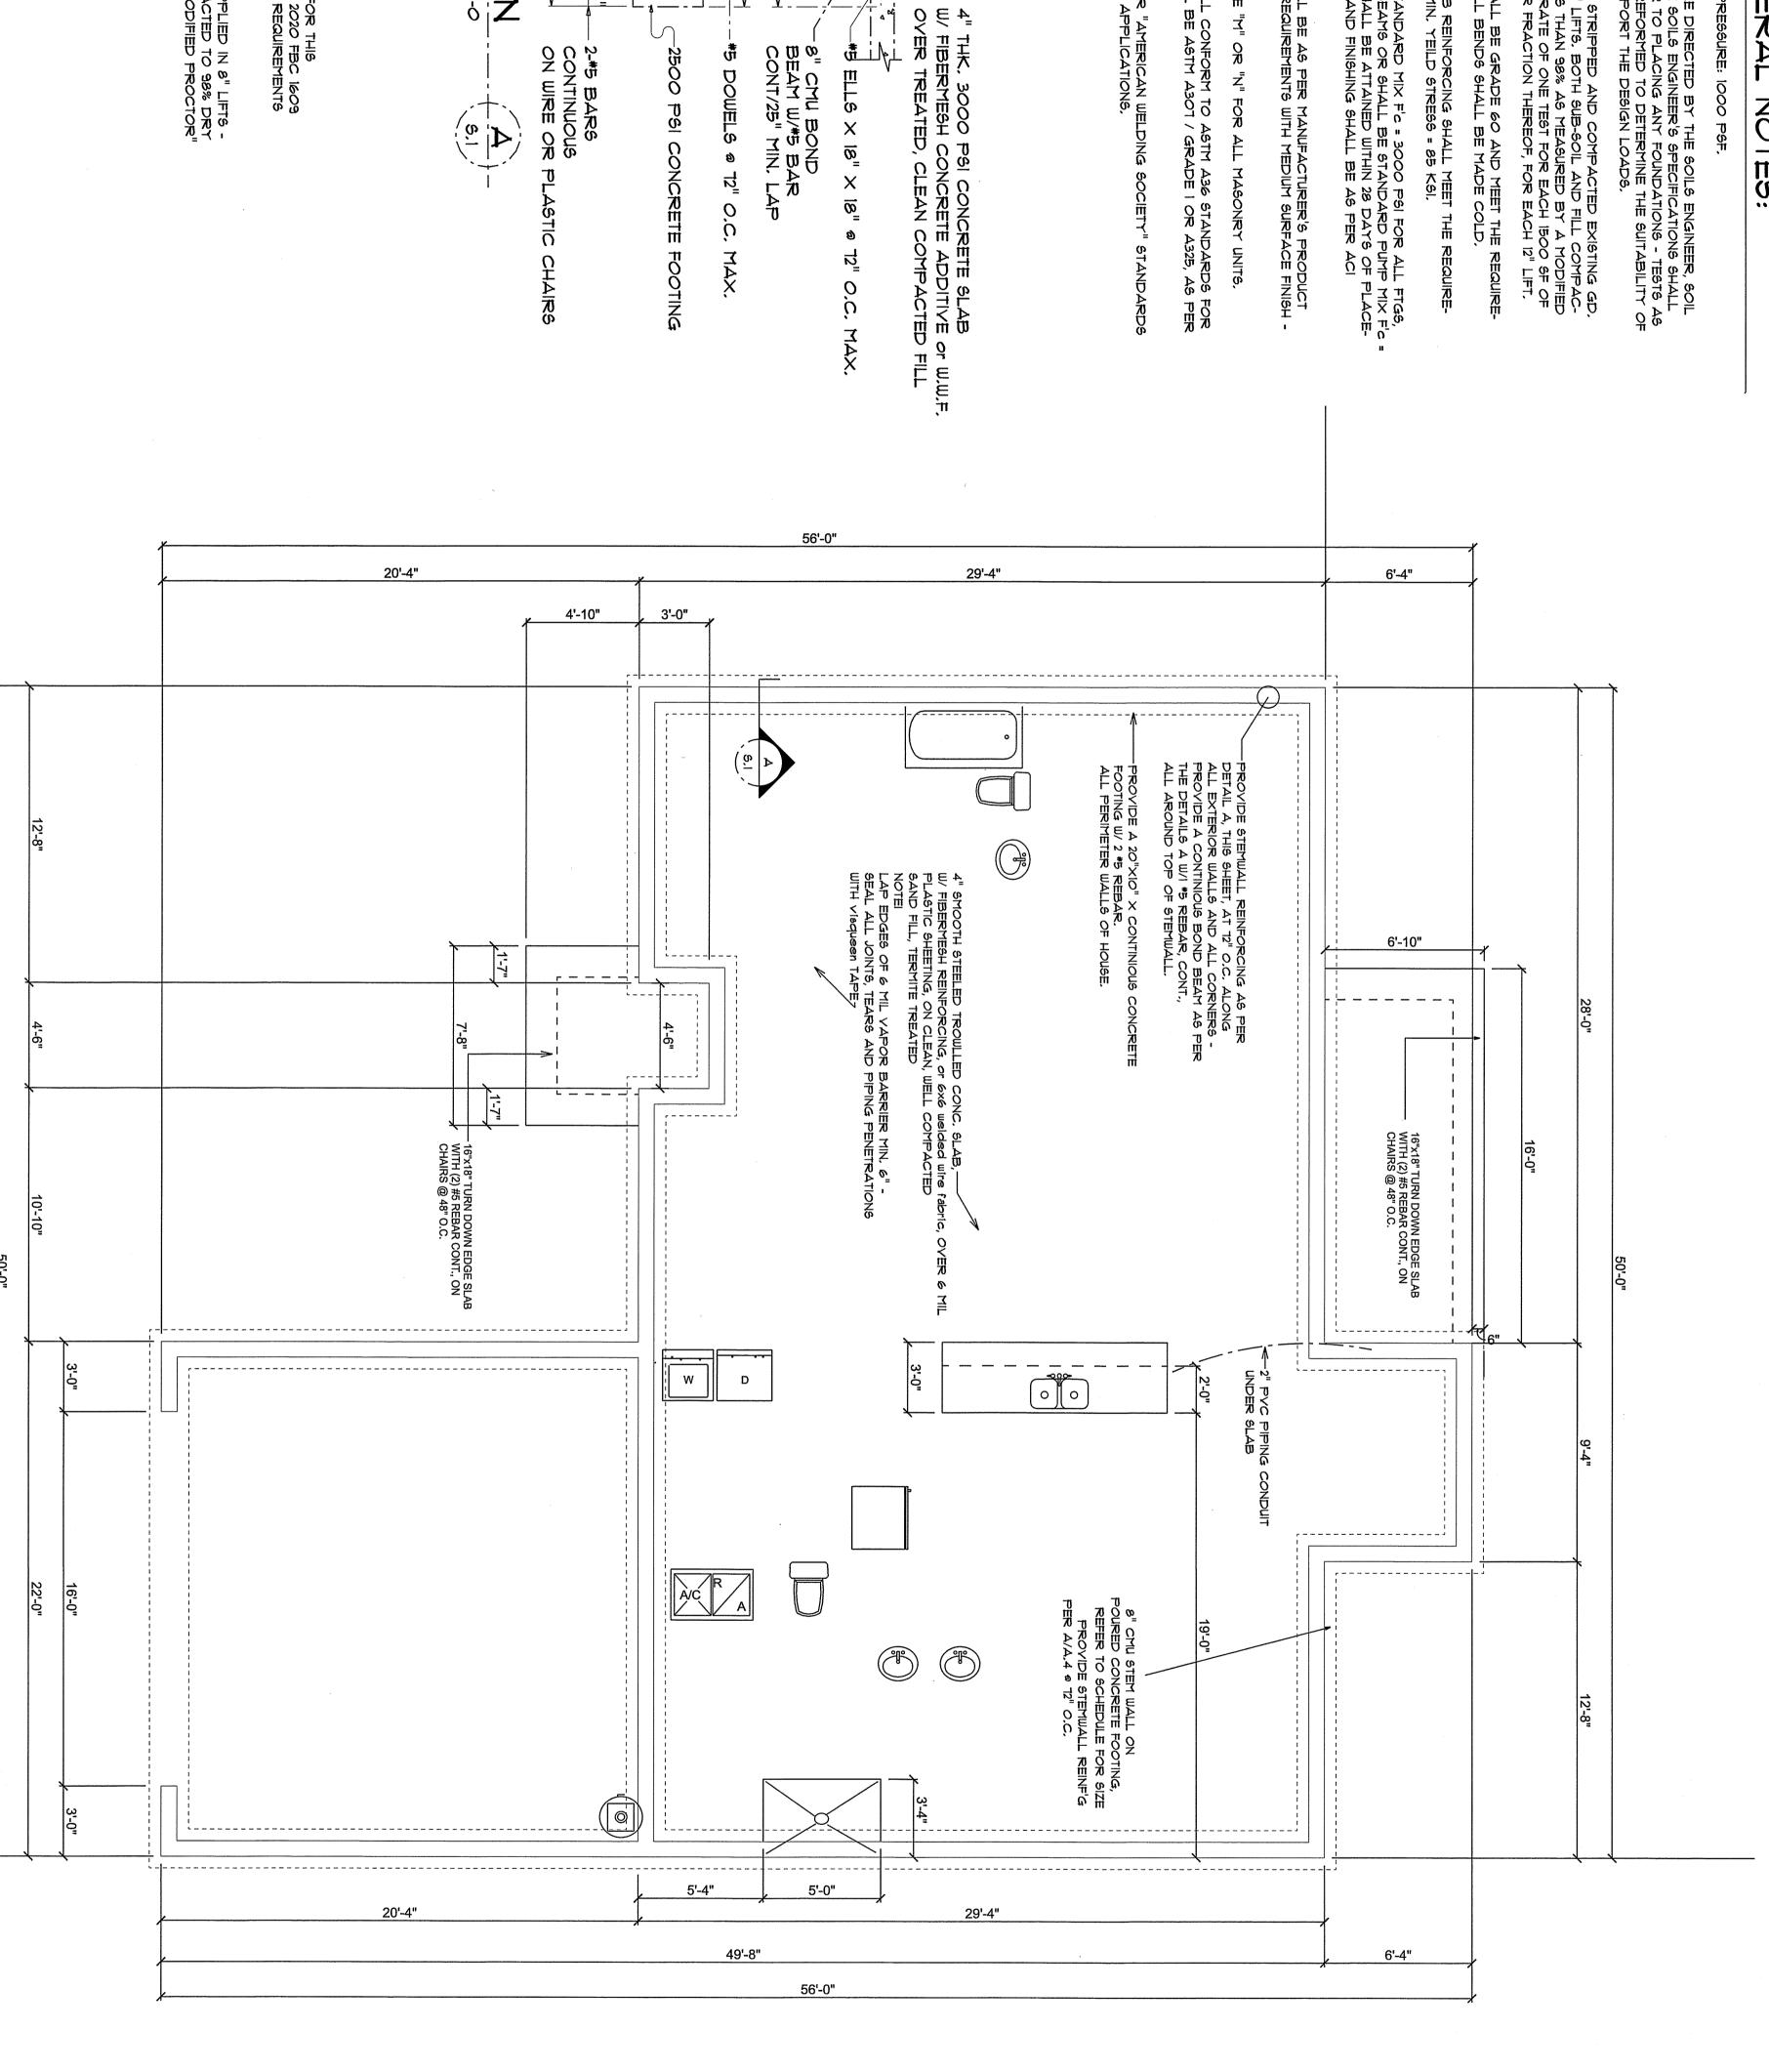



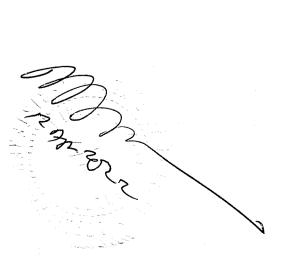




**Bradley Franks Construction** 455 SW Deputy J Davis Ln Lake City PHONE:386-755-2455 Florida info@bradleyfranks.com

SCALE: 1/4" = 1' DRAWN BY: DATE: 1/13/2022

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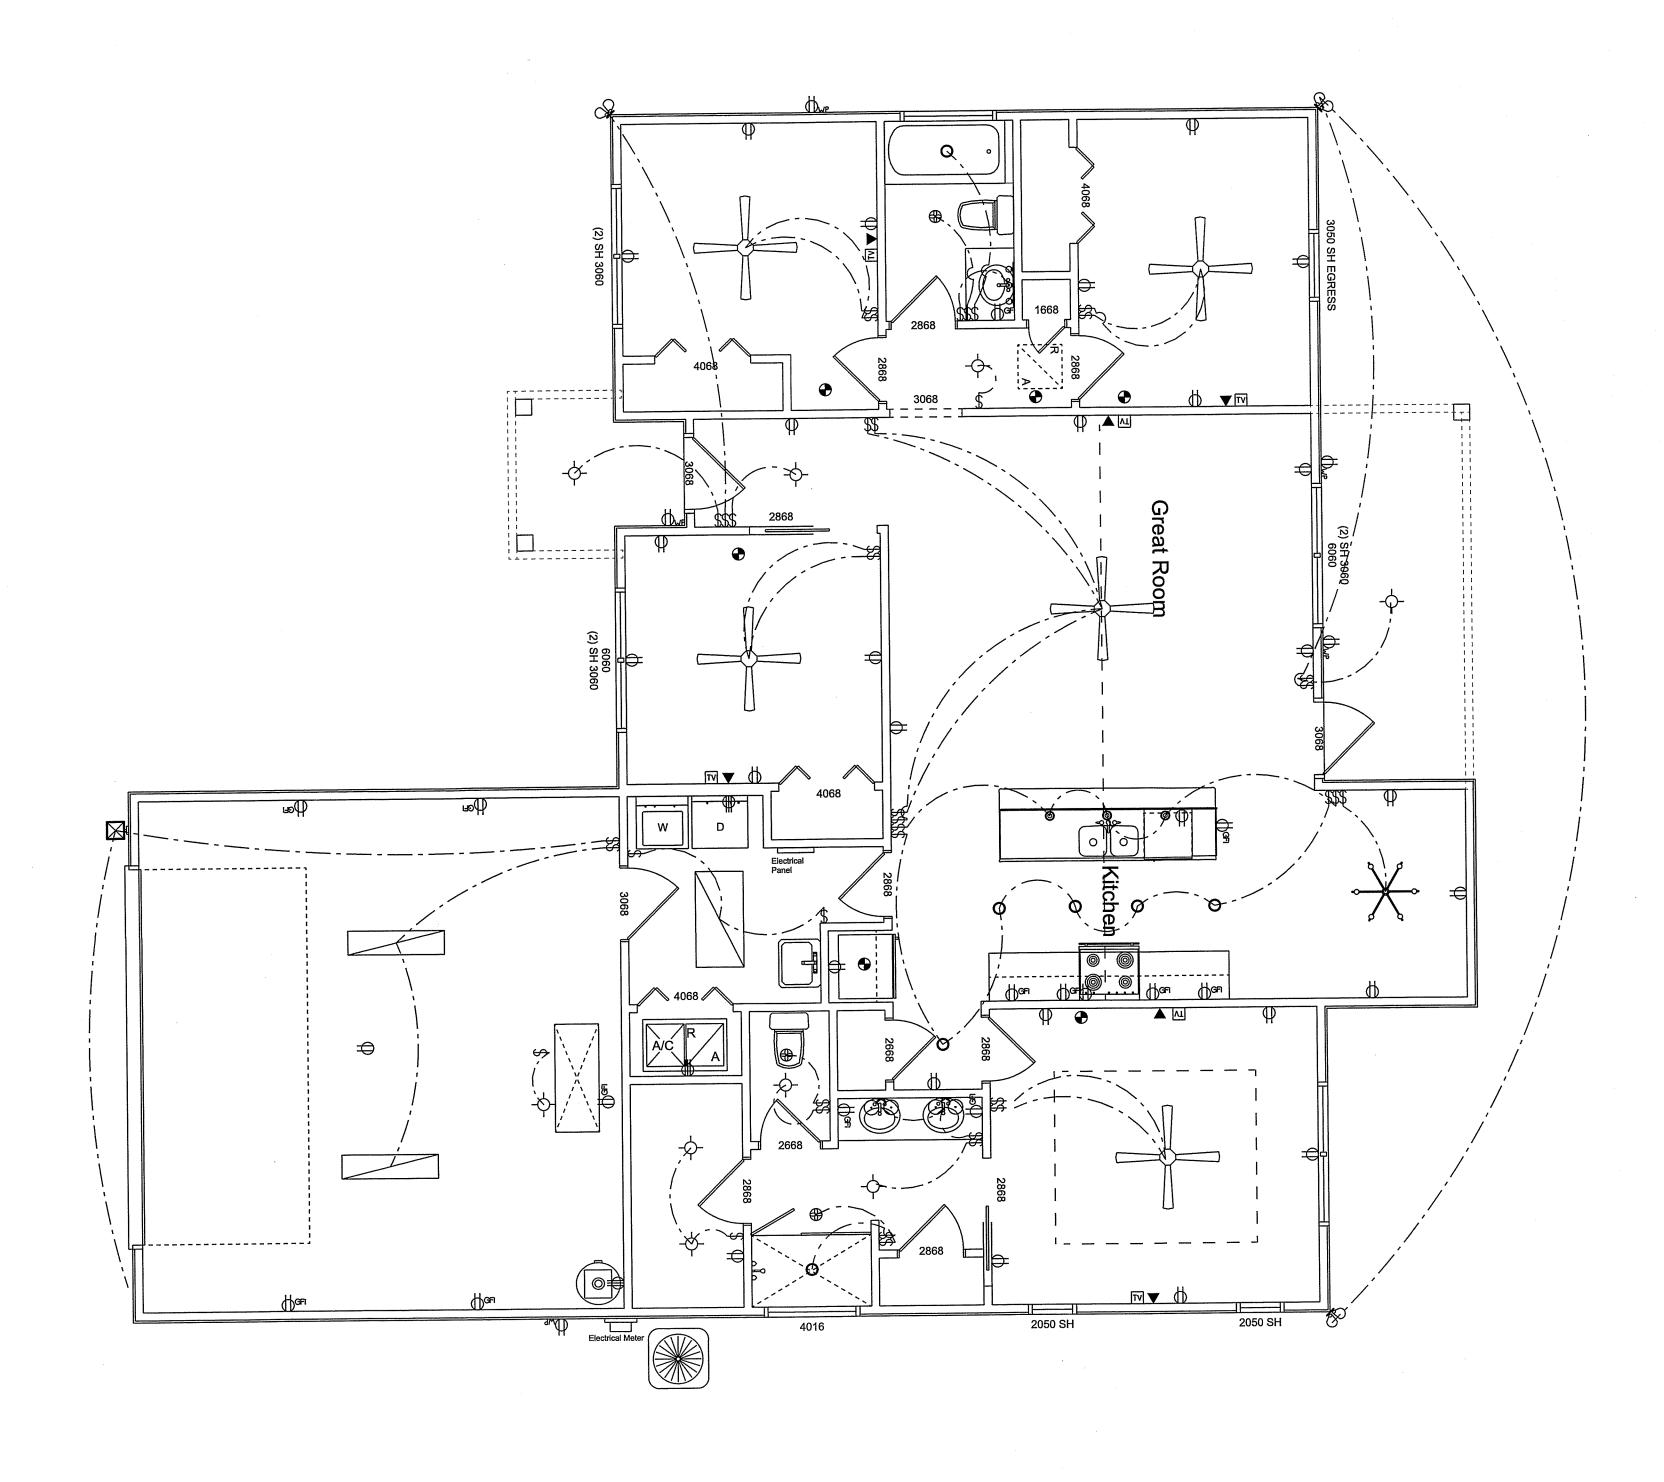
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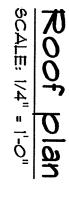


DATE: 1/13/2022

ELECTRICAL LE	LEGEND	
ELECTRICAL	COUNT	SYMBOL
ceiling fan 4 bladed 01	Q	
can light 6inch	7	0
ceiling light 38	ယ	0
chandelier 03	_	
fluorescent light 1 x 4	2	
fluorescent light 2 x 4	_	
exterior light 03	_	
spotlight double	ယ	₽P
LAN connection	6	H
cable tv outlet	6	ĪV
fan	3	₩
light	9	<b>ф</b>
outlet	29	<b>+</b>
outlet 220v	3	€
outlet gfi	13	<b></b>
outlet wp	5	ф
outlet-contemporary		<b>+</b>
smoke detector	6	•
switch	5	₩.
switch double	9	\$
switch double - rocker style	1	\$
switch quad		\$\$\$\$
switch triple	3	\$\$\$
vanity bar light 02		0 0 0
wall mounted 01 2 lights	2	0,0

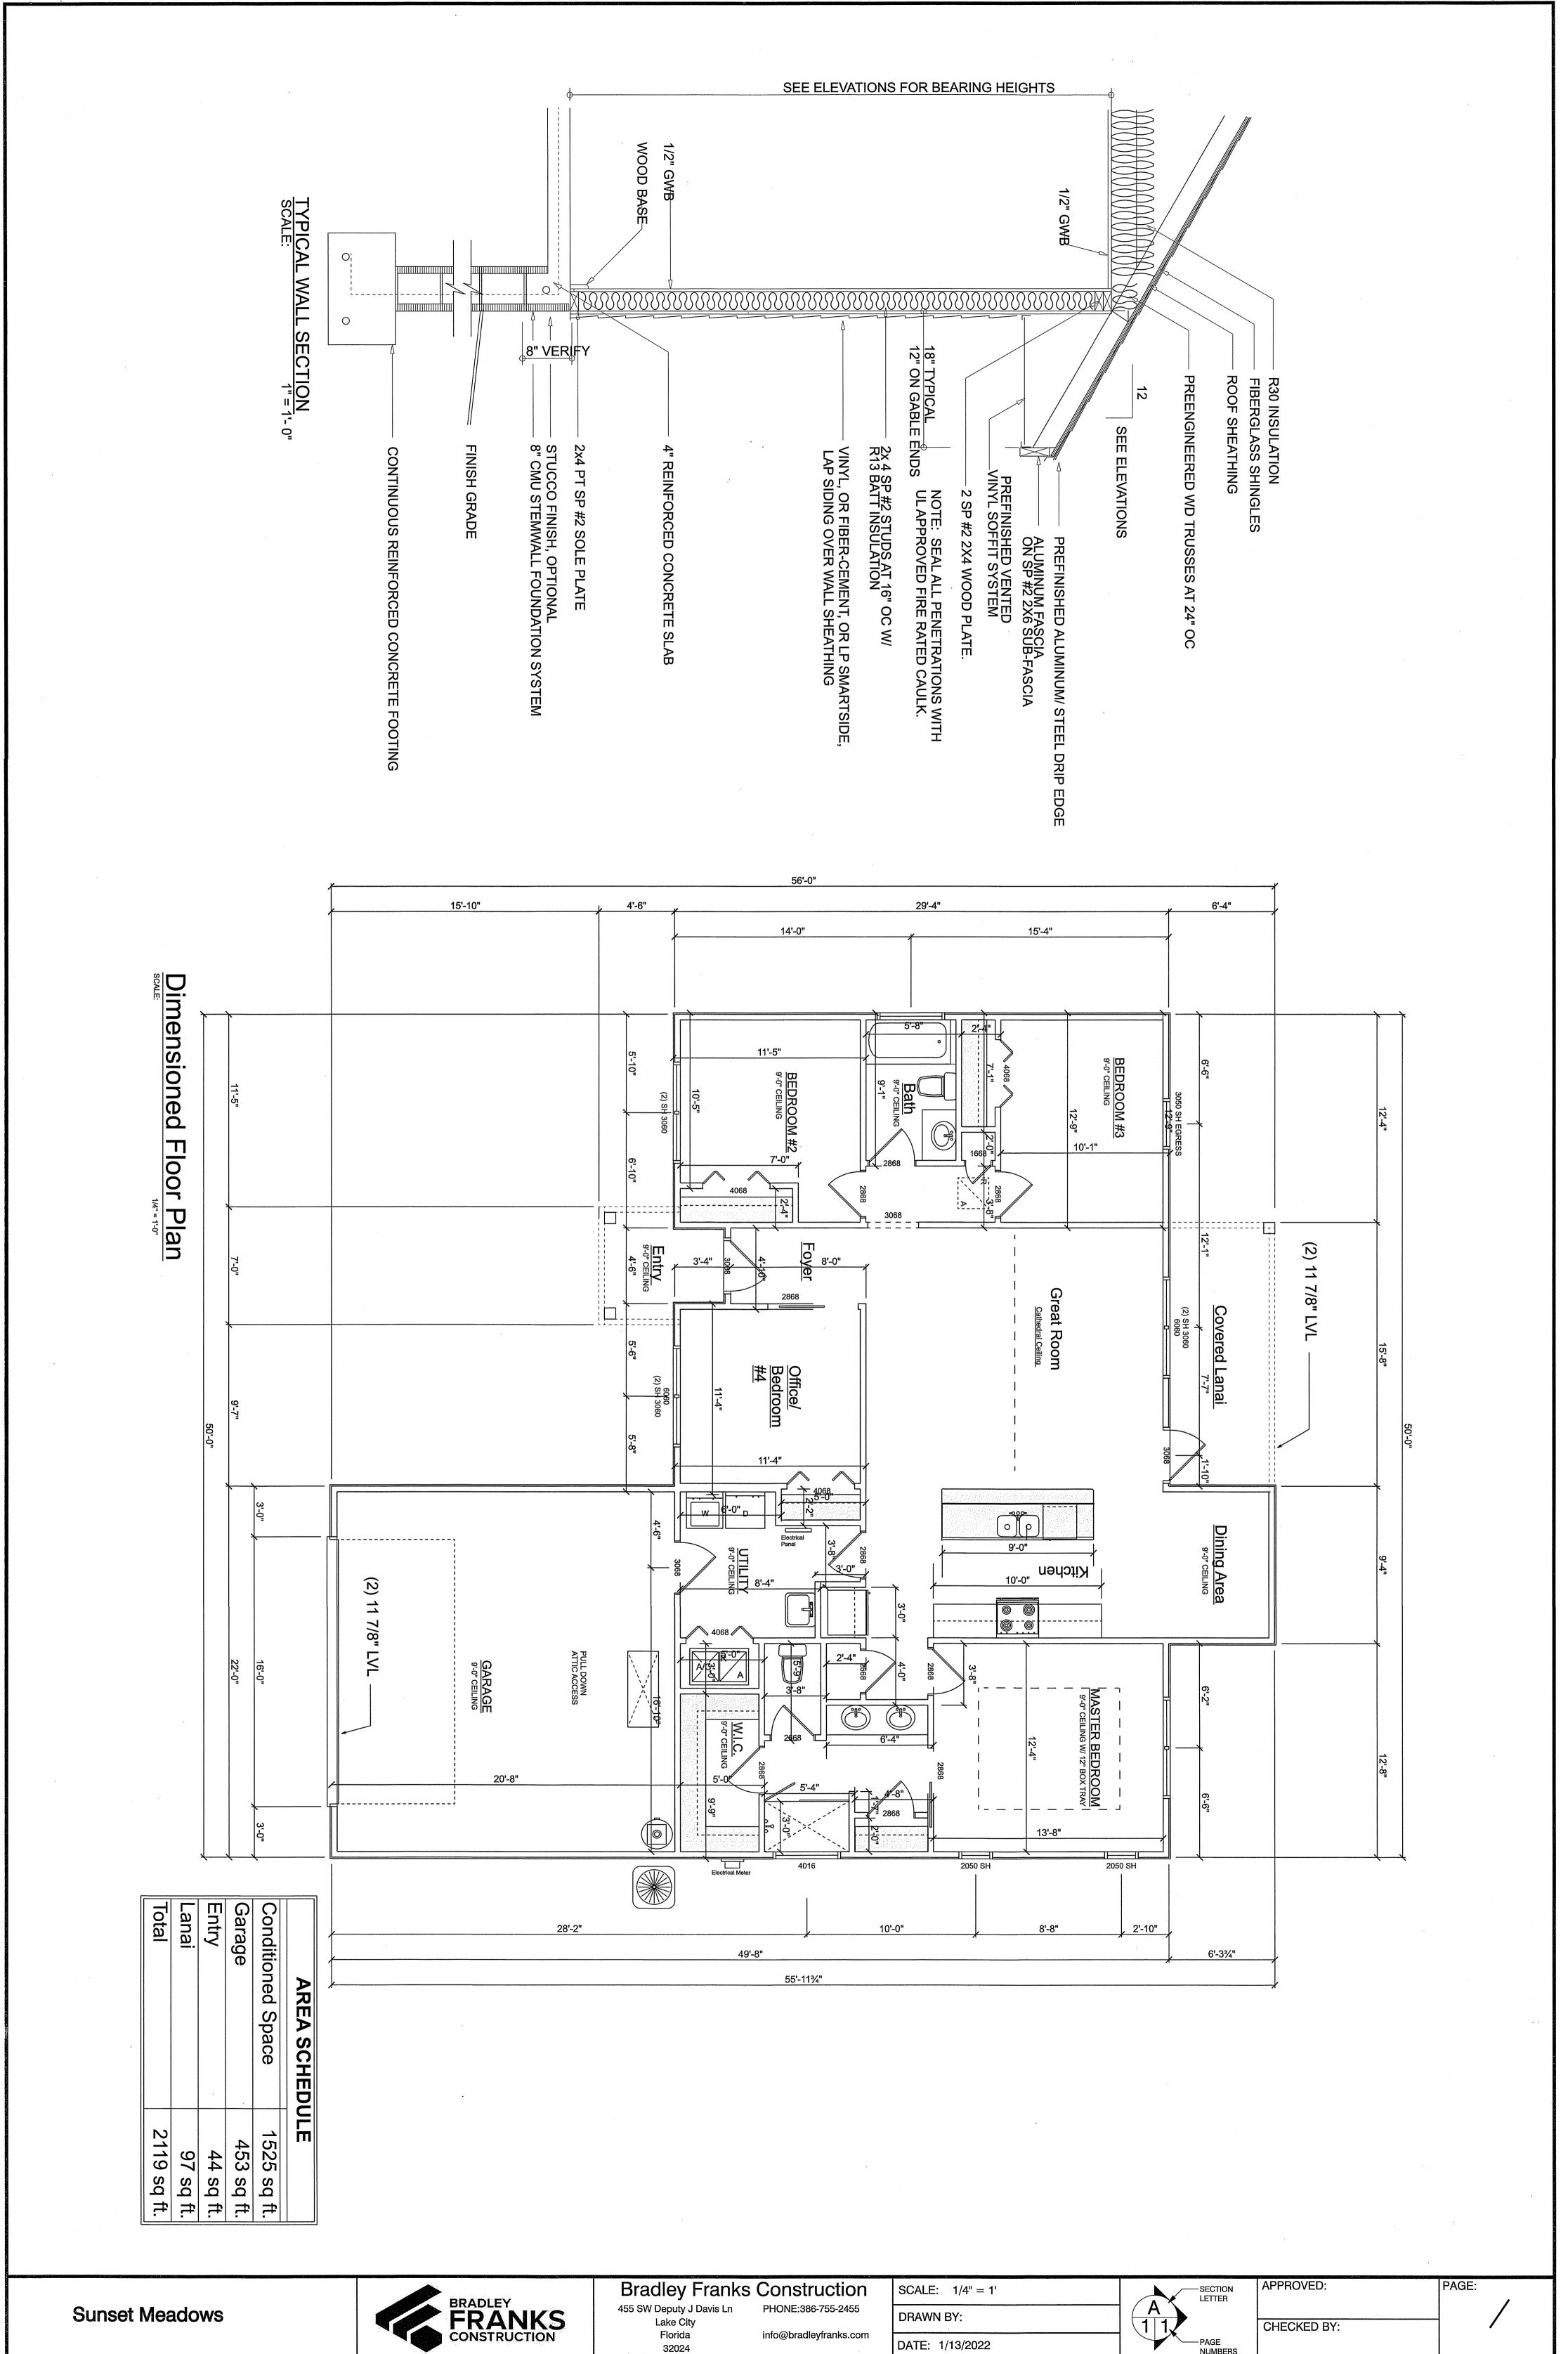

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SEE ELEVATIONS FOR ROOF PITCH ALL OVERHANG 18" (12" on gables) UNLESS OTHERWISE NOTED


SEE EXTERIOR ELEVATIONS AND FLOOR PLANS TO VERIFY PLATE AND HEEL HEIGHTS

NOTE!
THE DESIGN WIND SPEED FOR THIS PROJECT IS 115 MPH PER FBC 1609
AND LOCAL JURISDICTION REQUIREMENTS

NOTE!

SHEATH ROOF W/ 1/2" CDX PLYWOOD PLACED W/ LONG DIMENSION PERPENDICULAR TO THE ROOF TRUSSES, SECURE TO FRAMING W/ 8d NAILS - AS PER DETAIL ON SHEET SD.4


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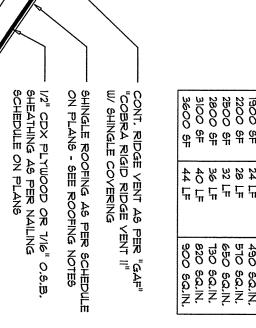

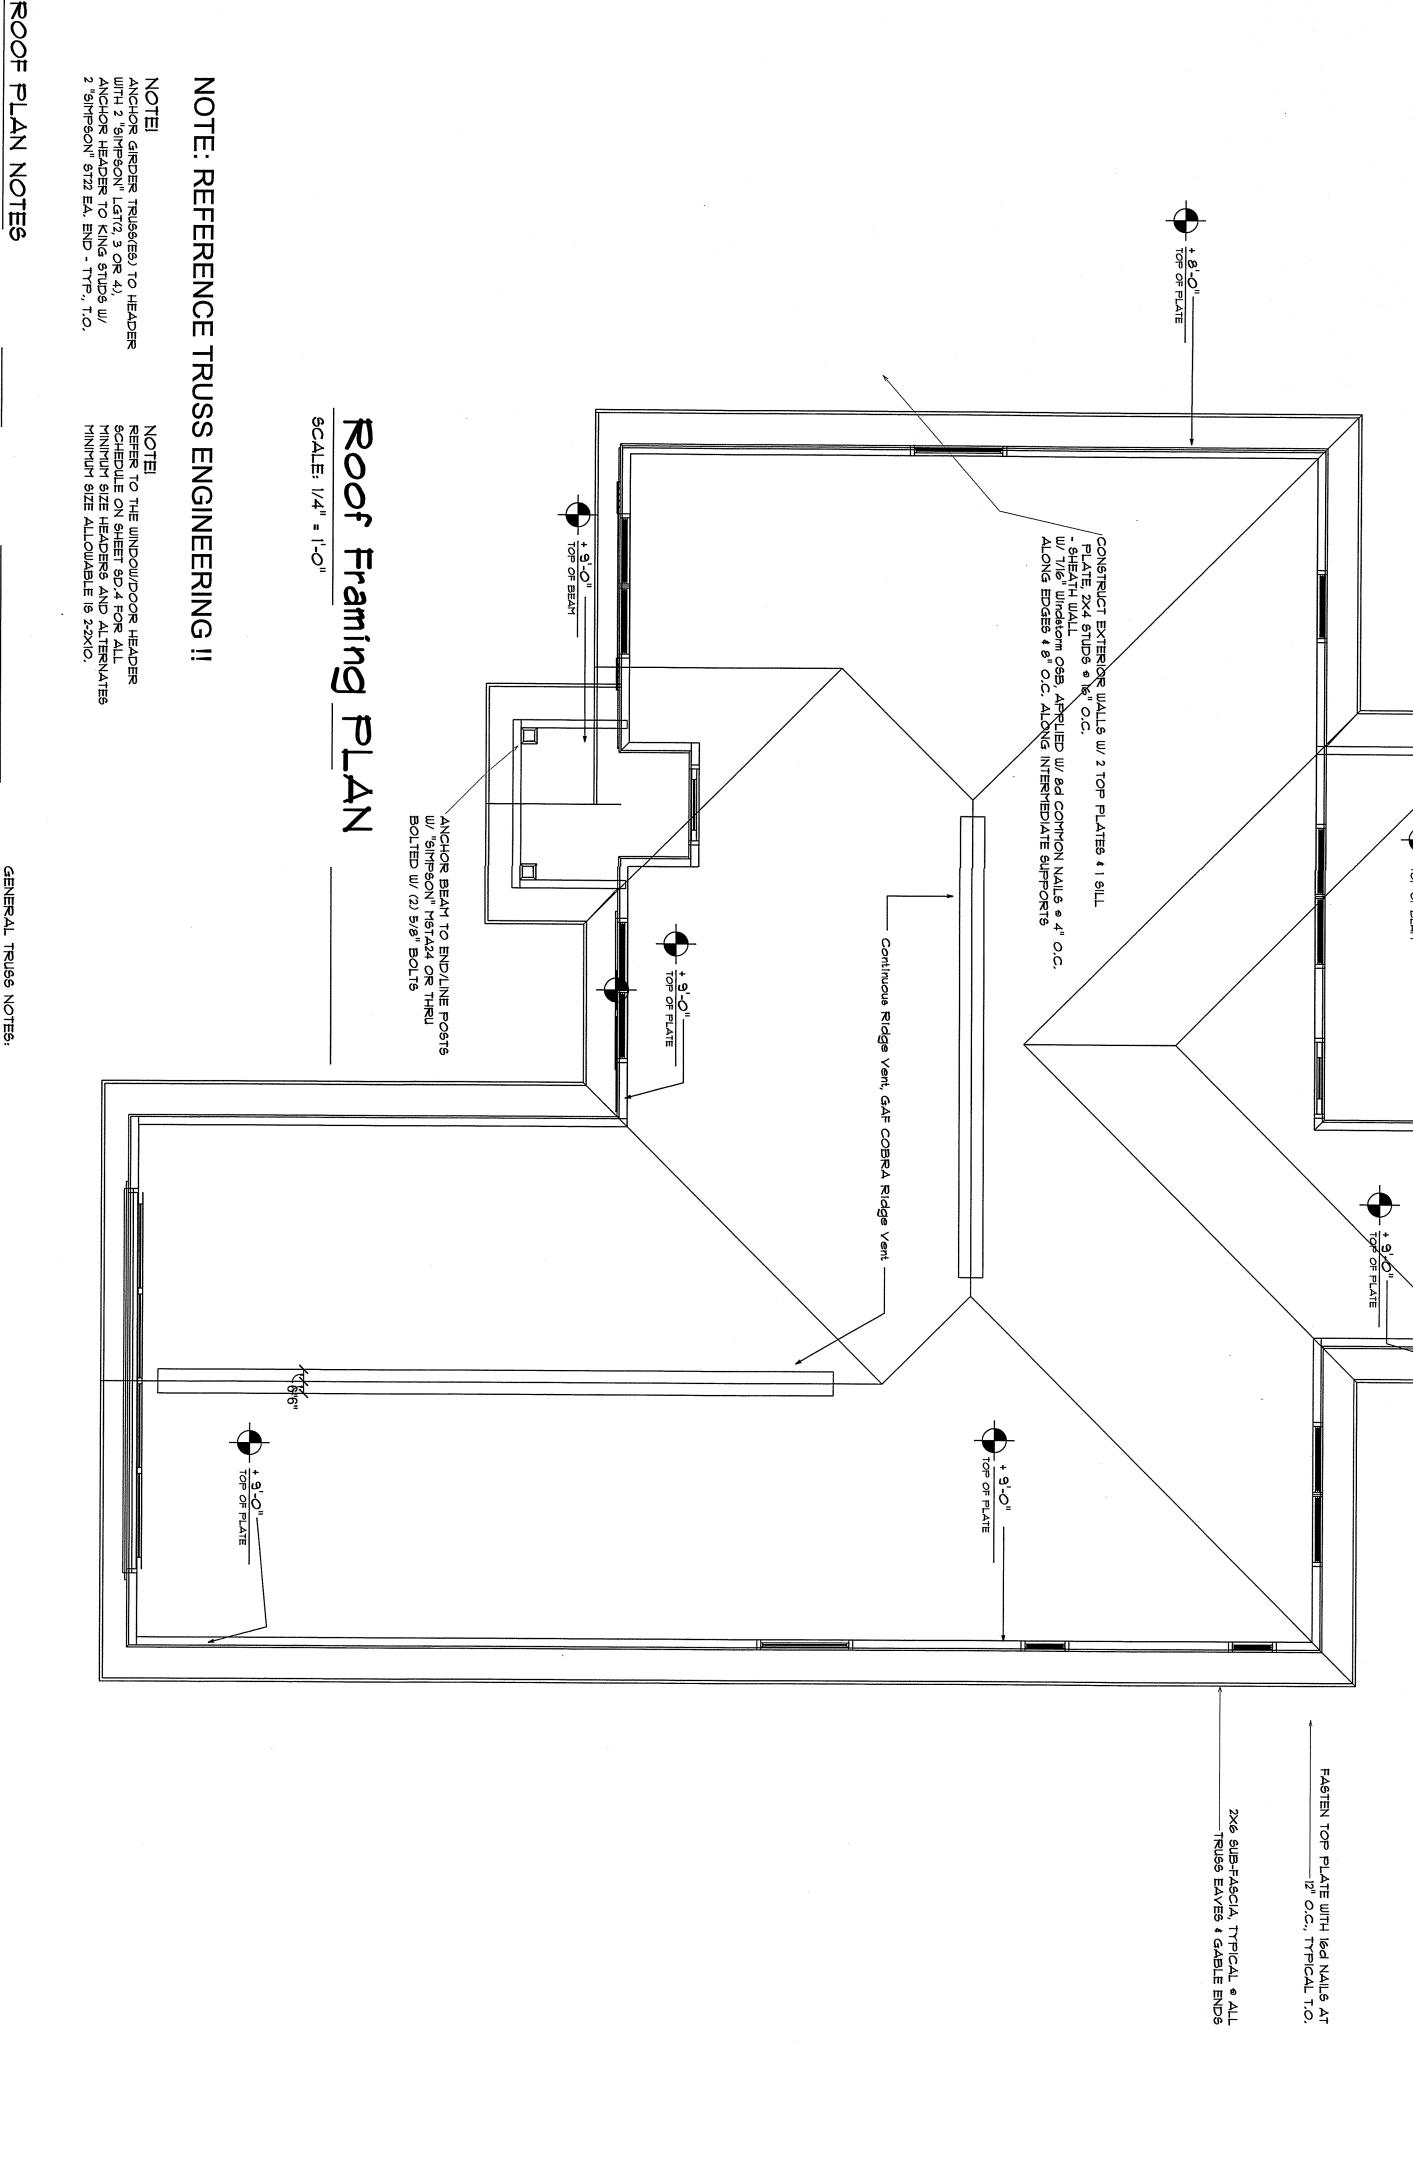
## DOOD MOOD STRUCTURAL NOTES


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ATTIC OF VENT AREA OF INTAKE  1600 SF 20 LF 410 SQ.IN. 1900 SF 24 LF 490 SQ.IN. 2500 SF 28 LF 510 SQ.IN. 2500 SF 32 LF 650 SQ.IN. 3100 SF 40 LF 130 SQ.IN. 3600 SF 44 LF 900 SQ.IN.									
	3600 SF	3 <u>00</u> 6	_		2200 SF		_		ATTIC
AREA OF NTAKE 410 90.IN. 490 90.IN. 510 90.IN. 650 90.IN. 130 90.IN. 820 90.IN. 900 90.IN.			36 LF						OF VENT
L	300 sa.in.	820 SQ.IN.	130 SQ.IN.	650 6Q.IN.	N'OS OLS	490 sq.in,	410 sq.in.	NTAKE	AREA OF





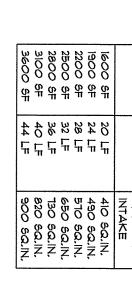

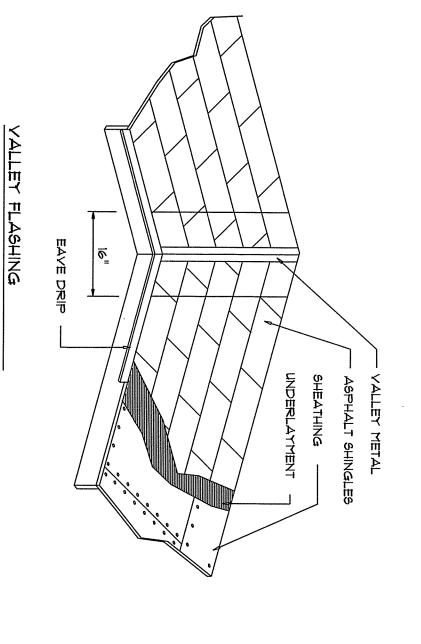

	TOOOFING ME	ROOFING METALS FOR FLASHING/ROOFING MINIMUM THICKNESS REQUIREMENTS	HOOK/100H	
	MATERIAL	THICKNESS (In)	GAGE	WEIGHT
٠	COPPER			6
	ALUMINUM	0.024		
	STAINLESS STEEL		28	
	GALYANIZED STEEL	6LI <i>O''O</i>	26 (ZINC COATED G90)	
	ZINC ALLOY	0.027		






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BRADLEY	
FRANKS	
CONSTRUCTION	- 1

**Bradley Franks Construction** 455 SW Deputy J Davis Ln Lake City Florida


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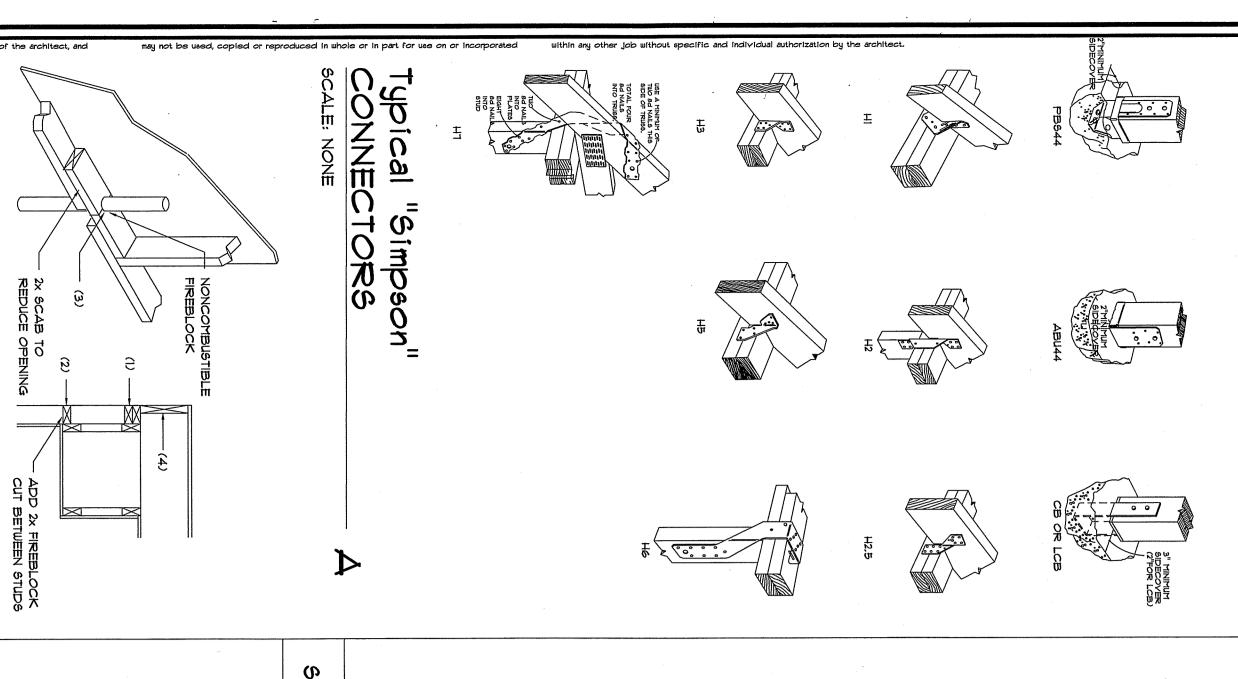
SCALE: 1/4" = 1'DRAWN BY: DATE: 1/13/2022

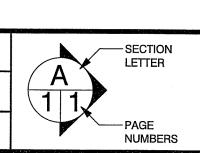

APPROVED: CHECKED BY:

Roofing/Flashing



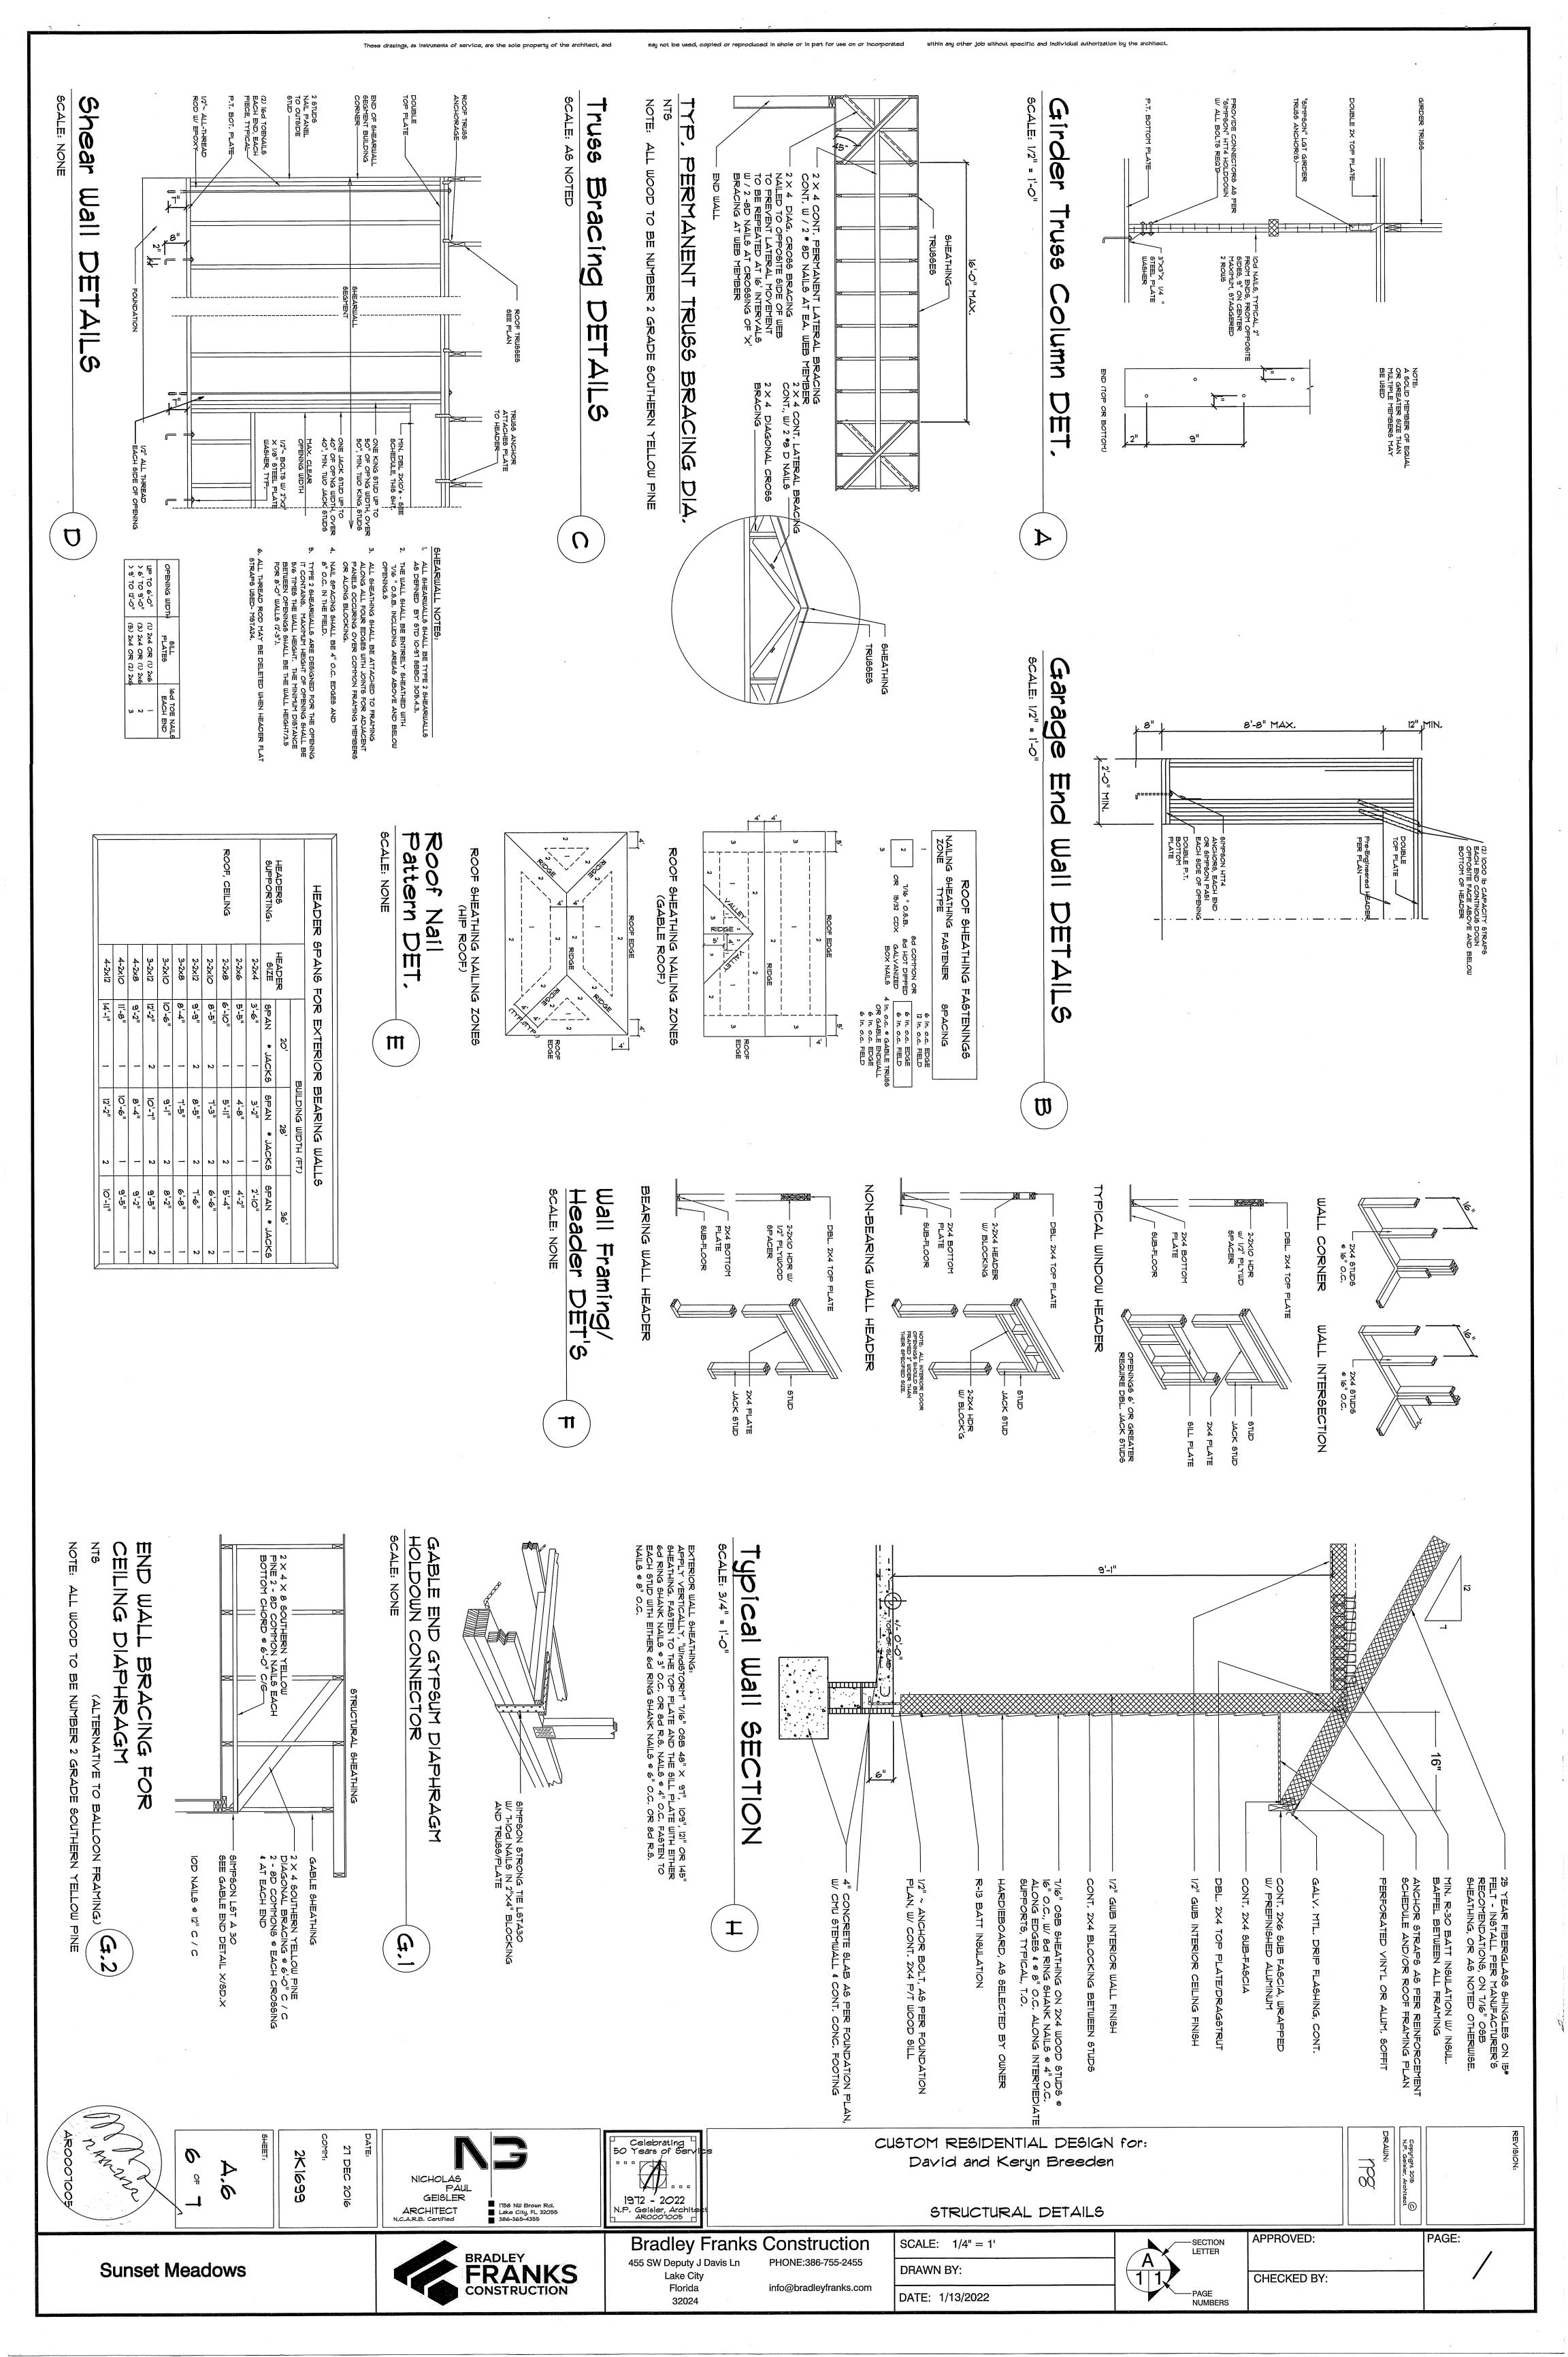

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SOIL CHEMICAL BARRIER METHOD:

AND NEED FOR REINSPECTION AND TREATMENT CONTRACT RENEWAL SHALL BE PROVIDED, THE SIGN SHALL BE POSTED NEAR THE WATER HEATER OR ELECTRIC PANEL, FBC 104.2.6

2. CONDENSATE AND ROOF DOWNSPOUTS SHALL DISCHARGE AT LEAST 1'-O" AWAY FROM BUILDING SIDE WALLS, FBC 1503.4.4

TERMITE AND THE PROPERTY OF TH

PROTECTION NOTES:

CENTERLINE PLUS OR MUHOUT

FIREBLOCKING NOTES:

EBLOCKING SHALL BE INSTALLED

FRAME CONSTRUCTION IN THE

BY OTHERS

GM. T.J.

A 5

ON CENTER

TENNY

LEANOUT

EANOUT

SLIDING GLASS

AT OPENINGS AROUND VENTS, PIPES, DUCTS, CHIMNEYS AND FIREPLACES CEILING AND FLOOR LEVELS WITH "PYROPANEL MULTIFLEX SEALANT"

DETAILS

8. MINIMUM 6 MIL VAPOR RETARDER MUST BE INSTALLED TO PROTECT AGAINST RAINFALL DILUTION. IF RAINFALL OCCURS BEFORE VAPOR RETARDER PLACEMENT, RETREATMENT IS REQUIRED. FBC 1816.1.4

9. CONCRETE OVERPOUR AND MORTAR ALONG THE FOUNDATION PERIMETER MUST BE REMOVED BEFORE EXTERIOR SOIL TREATMENT. FBC 1816.1.5

10. SOIL TREATMENT MUST BE APPLIED UNDER ALL EXTERIOR CONCRETE OR GRADE WITHIN 1'-O" OF THE STRUCTURE SIDEWALLS. FBC 1816.1.6

11. AN EXTERIOR VERTICAL CHEMICAL BARRIER MUST BE INSTALLED AFTER CONSTRUCTION IS COMPLETE INCLUDING LANDSCAPING AND IRRIGATION. ANY SOIL DISTURBED AFTER THE VERTICAL BARRIER IS APPLIED, SHALL BE RETREATED. FBC 1816.1.6 TO HAVE PER-CONSTRUCTION TREATMENT.

13. A CERTIFICATE OF COMPLIANCE MUST BE ISSUED TO THE BUILDING DEPARTMENT BY \* LICENSED PEST CONTROL COMPANY BEFORE A CERTIFICATE OF COCUPANCY WILL BE ISSUED, THE CERTIFICATE OF COMPLIANCE SHALL STATE: "THE BUILDING HAS RECEIVED A COMPLETE TREATMENT FOR THE PREVENTION OF SUBTERRANEAN TERMITES. THE TREATMENT IS IN ACCORDANCE WITH THE RULES AND LAWS OF THE FLORIDA DEPARTMENT OF AGRICULTURE AND CONSPUERS SERVICES", FBC 1816.1.7

IB. NO WOOD, VEGETATION, STUMPS, CARDBOARD, TRASH, ETC., SHALL BE BURIED WITHIN 15'-O" OF ANY BUILDING OR PROPOSED BUILDING. FBC 2303.1.4 14. AFTER ALL WORK IS COMPLETED, LOOSE WOOD AND FILL MUST BE REMOVED FROM BELOW AND WITHIN 1'-O" OF THE BUILDING. THIS INCLUDES ALL GRADE STAKES, TUB TRAP BOXES, FORMS, SHORING OR OTHER CELLULOSE CONTAINING MATERIAL. FBC 2303.1.3

ANY AND ALL DISPUTES ARISING FROM EVENTS ASSOCIATED WITH THE CONSTRUCTION OF THIS PROJECT BETWEEN THE WINER, CONTRACTOR(S) AND SUPPLIERS SHALL BE RESOLVED THROUGH BINDING ARBITRATION. . WOOD IN CONTACT WITH CONCRETE OR MASONRY SHALL PRESSURE TREATED. WORK SHALL BE IN ACCORDANCE W/ APPLICABLE CODE.
LOCAL REGULATIONS, INCLUDING APPLICABLE ENERGY
DES. ALL COMPONENTS OF THE BUILDING SHALL MEET WITH
MINIMUM ENERGY REQUIREMENTS OF THE BUILDING CODE.
DISCREPANCIES SHALL BE REPORTED TO THE ARCHITEC
RITING PRIOR TO THE COMMENCEMENT OF THE WORK. INSULATION SHALL BE LEFT EXPOSED AND ALL LABLES INTACT ON THE WINDOWS AND DOORS UNTIL INSPECTED THE BUILDING OFFICIAL.

ELECTRICAL CODE: NATIONAL ELECTRICAL LIFE SAFETY: NFPA-101 - LATEST BUILDING CODE: 2020 FLORIDA BUILDING CODE CONSTRUCTION DOCUMENTS

LIVE LOADS: 1st FLOOR: 40PSF, 2nd FLOOR: 40PSF, ROOF: AS DETERMINED BY SHAPE FACTORS APPLIED TO THE WIND FORCE GENERATED BY THE DESIGN WIND SPEED.

DO NOT SCALE OFF THESE PLANS
AMPLE DIMENSIONS ARE SHOWN ON THE PLANS TO LOCATE ALL ITEMS.
SIMPLE ARITHMETIC MAY BE USED TO DETERMINE THE LOCATIONS OF THOSE ITEMS NOT DIMENSIONED.

CHANGES TO FINAL PLAN SETS

SOIL DESIGN STATEMENT:
FOOTING DESIGN IS BASED UPON 1000PSF SOIL BEARING PRESSURE PROVIDED BY CLEAN SAND, GRAVEL OR STONE. OTHER SOIL CONDITIONS
16: CLAY, HIGH LEVEL OF ORGANICS OR OTHER UNDESIRABLE SOILS SHALL
REQUIRE FOUNDATION MODIFACATIONS. DESIGN VALUES/LOADS & CODES
WIND DESIGN SPEED: 130 MPH, UNLESS NOTED / NOTES

**CENERAL** 

NOTES

PROJECT INFORMATION

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OF DECKING
Material: 1/2" CD Plywood or 7/16" 0.8.B.
Sheet 61ze: 48"x96" Sheets Perpendicular to
Fasteners: 8d Ring Shank Nails per schedule o

ALL ANCHORS SHALL BE SECURED W/ NAILS AS PRESCI

Material: 7/16" O.S.B. "WindSTORM": 48" X 97", 109", 121" OR 145" Sheet Size48"x97" (109", 121" OR 145") Sheets Placed Vertical Fasteners: 8d Ring Shank Nails & 4" O.C. Edges & 8" O.C. Interio Dragstrut: Double Top Plate (6,7,P,) W/2 - 16d Nails & 12" O.C. Wall Studs: 2x4 SPF Studs & 16" O.C.

RRICANE UPLIFT CONNECTORS Truss Anchors: Simpson H2.5a & Ea. Truss End (Typ. U.O.N.)
Wall Tension: Wall Sheathing Nailing is Adequate - 8d & 4" O.C.
Anchor Bolts: 1/2" A301 & 48" O.C. - 1st Bolt 8" from corner
Corner Hold-down Device: Simpson HD2a, ea. corner

UNLISTED JOINTS IN SON A34 FRAMING

-00TINGS AND FOUNDATIONS
Footing: 20"X12" Cont. W/2-#5 Cont.

APP 393

BUILDING COMPONENTS & CLADDING LOAT MEAN BUILDING HEIGHT = 30.0', EXPOSUR ROOF ANGLE T TO 2T m<u>¯</u> ₩ Ø

5 10 21.8 / -29.1 25.9 / -34.7 30.4 /-40.7 35.3 / -47.2

5 20 20.8 / -27.2 24.7 / -32.4 29.0 / -38.0 33.7 / -44.0

5 50 19.5 / -24.6 23.2 / -29.3 27.2 / -34.3 31.6 / -39.8

HEIGHT & EXPOSURE ADJUSTMENT COEFFICIENTS
FOR BUILDING COMPONENTS & CLADDING
BLDG EXPOSURE FUEL
HEIGHT "E" 21.8 / -23.6 20.8 / -22.6 19.5 / -21.3 12.0 / -19.9 11.4 / -19.4 10.0 / -18.6 14.9 / -23.7 13.6 / -23.0 11.9 / -22.2 1.29 1.29 1.35 1.40 / -48.4 0 / -44.6 / -39.4 35,3 / -38,2 33,7 / -36,7 31,6 / -34,6 20.3 / -83.1 18.5 / -11.1 16.1 / -10.5 20.3 / -32.3 18.5 / -31.4 16.1 / -30.2

DESIGN CRITERIA:

I. THE DESIGN COMPLIES WITH THE REQUIREMENTS OF THE 2020 BUILDING CODE - SECTION 1609 AND OTHER REFERENCED CODE SPECIFICATIONS, ALL CODES AND SPECIFICATIONS SHALL BE LAST TIME OF PERMIT.

3, ROOF DESIGN LOADS: SUPERIMPOSED DEAD LOADS: SUPERIMPOSED LIVE LOADS:, BASED ON ANSI/ASCE 1-10. WIND LOAD CRITERIA: RISK 2020 FBC 1609-A WIND YASD ...... 20 PSF

5. INITIAL TREATMENT SHALL BE DONE AFTER ALL EXCAVATION AND BACKFILL IS COMPLETE, FBC 1816.1.1
6. SOIL DISTURBED AFTER THE INITIAL TREATMENT SHALL BE RETREATED NCLUDING SPACES BOXED OR FORMED. FBC 1816.1.2

BOXED AREAS IN CONCRETE FLOOR FOR SUBSEQUENT INSTALLATION TRAPS, ETC., SHALL BE MADE WITH PERMANENT METAL OR PLASTIC DRMS, PERMANENT FORMS MUST BE OF A SIZE AND DEPTH THAT WILL IMINATE THE DISTURBANCE OF SOIL AFTER THE INITIAL TREATMENT.

IEADS SHALL NOT BE INSTALLED WITHIN 1'-O" FROM BUILDING SIDE WALLS.
BC 1503.4.4

1. TO PROVIDE FOR INSPECTION FOR TERMITE INFESTATION, BETWEEN WALLS.
COVERINGS AND FINAL EARTH GRADE SHALL NOT BE LESS THAN 6".
EXCEPTION: PAINT AND DECORATIVE CEMENTIOUS FINISH LESS THAN 5/8"
HICK ADHERED DIRECTLY TO THE FOUNDATION WALL, FBC 1403.1.6

4. FLOOR DESIGN LOADS:
SUPERIMPOSED DEAD LOADS:
SUPERIMPOSED LIVE LOADS:
RESIDENTIAL
BALCONIES ARE AS INDICATED

OY Y DOL 5
OLS ARE MOST OFTEN ENCOUNTERED IN DRAWINGS: ELEVATIONS, DIMENSION PLANS, SECTIONS & STRUCTURAL PLANS

TYPE OF ELEVATION MARK USED TO INDICATE THE TOP OF A LOG WALL STACK - NOMINAL ONLY.

<del>•</del>

Celebrating 50 NICHOLAS PAUL 1972 - 2022 GEISLER N.P. Geisler, Archit AR0007005

CUSTOM RESIDENTIAL DESIGN for:

☐ 1758 NW Brown Rd.☐ Lake City, FL 32055☐ 386-365-4355 STRUCTURAL INFORMATION **Bradley Franks Construction** SCALE: 1/4" = 1"455 SW Deputy J Davis Ln PHONE:386-755-2455 DRAWN BY: Lake City Florida info@bradleyfranks.com

Α **NUMBERS** 

APPROVED: **CHECKED BY:** 

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**Sunset Meadows** 

ARCHITECT N.C.A.R.B. Certified FRANKS CONSTRUCTION

32024

DATE: 1/13/2022

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