

PRODUCT CODE	R.O. SIZE	COUNT
INT. DO	OR SCHEDULE	
-0 DBF	R.O. 62" X 82-1/2"	2
668 R	R.O. 20" X 82-1/2"	1
068 L	R.O. 26" X 82-1/2"	1
068 R	R.O. 26" X 82-1/2"	1
468 L	R.O. 30" X 82-1/2"	2
468 R	R.O. 30" X 82-1/2"	1
668 L	R.O. 32" X 82-1/2"	3
668 R	R.O. 32" X 82-1/2"	2
868 L	R.O. 34" X 82-1/2"	1
868 R	R.O. 34" X 82-1/2"	1

PRODUCT CODE	R.O. SIZE	COUNT
EXT. DO SMOOTH FIBE	OOR SCHEDUL RGLASS INFINITY	
L 3-0 6PNL COL IN SWING	R.O. 38" X 81-1/2"	1
R 2-8 6PNL COL OUT SWING	R.O. 34" X 82-1/2"	1

PRODUCT CODE	R.O. SIZE	COUNT
WINDOW	SCHEDULE	
SILVER LI	NE 2900 SERIES	
2830 COL.	R.O. 32-1/2" X 36-1/2"	1
2830 OBS COL TEMP	R.O. 32-1/2" X 36-1/2"	1
3052 COL	R.O. 36-1/2" X 62-1/2"	3
3052 TWIN COL.	R.O. 72-1/2" X 62-1/2"	3
4010 FIX TRANSOM	R.O. 48-1/2" X 12-1/2"	1

NOTE: ALL INTERIOR DOORRS TO HAVE 82-1/2" R.O.) HEIGHT FROM FINISHHED FLOOR.

NOTE: **ALL WINDOWS TO BE VINYL** 

> CUSTOMER NAME: MR. & MRS. RUFUS BRYANT HEATED LIVING AREA

**Pennyworth Homes** 

Got Land? Let's Build! PennyworthHomes.com FL-CRC0584

EXHIBIT "A"

SANFORD B

GROUND FLOOR: SECOND FLOOR: N/A OTHER: N/A TOTAL HEATED: 1152

> **NON-HEATED** LIVING AREA

PORCH: GARAGE: N/A OTHER: N/A TOTAL U/R 1296

# IMPORTANT-PLEASE READ

BELOW CAREFULLY

OUR SALES BROCHURES AND OTHER ADVERTISING LIT-ERATURE ARE INTENDED TO GENERALLY REFLECT AND DEPICT THE STYLES AND QUALITY OF HOMES WE BUILD THROUGHOUT A PORTION OF THE UNITED STATES. OUR SALES MODELS ARE DESIGNED AND BUILT TO GENERALLY CONFORM WITH A VARIETY OF LOCAL CUSTOMS, PRAC-TICES, AND BUILDING CODES PREVALENT OR IN EFFECT IN THE IMMEDIATE AREA SURROUNDING THE LOCATION OF THOSE MODELS. THIS SET OF PLANS IS AN ACTUAL PART OF OUR CONTRACT WITH YOU AND, AS SUCH, IS IN-TENDED TO TAKE PRIORITY OVER ANYTHING IN CONFLICT WITH IT CONTAINED IN OUR ADVERTISING LITERATURE OUR SALES MODELS AND EVEN OUR ORAL SALES PRESENT TATION. NO CHANGE, MODIFICATION, OR REVISION OF THESE PRINTED PLANS SHALL BE BINDING ON THE PARTIES UNLESS SET FORTH ON THESE PLANS OR OTHER WISE REDUCED TO WRITING AND EXECUTED BY SAID PARTIES, PLEASE REVIEW THESE PLANS ALONG WITH "EXHIBIT B" OF YOUR CONTRACT CAREFULLY AND MAKE CERTAIN BEFORE YOU SIGN THEM THAT THEY ACCU-RATELY REPRESENT THE HOME YOU ARE PURCHASING ADDITIONALLY, P.W.H. HOMES INC. HEREBY RESERVES THE RIGHT TO SUBSTITUTE MATERIALS OF EQUIVALENT QUALITY AND/OR TECHNIQUES OF ASSEMBLY AND/OR CONSTRUCTION METHODS FROM THAT CONTAINED IN THESE PLANS OR SPECIFIED IN EXHIBIT "B" WHERE NEC-ESSARY TO ACCOMODATE DIFFERENCES IN LOCAL CODES GEOGRAPHIC CUSTOMS, OPTION SELECTION AND AVAIL-ABILITY OF MATERIALS. ALL MATERIALS (LUMBER, OR OTHER BUILDING SUPPLIES) DELIVERED TO JOBSITE WHICH ARE IN EXCESS OF THOSE REQUIRED TO CON-STRUCT THE HOUSE AS AGREED REMAIN THE PROPERTY

PENNYWORTH HOMES INC. RESERVES THE RIGHT TO ONLY MAKE CHANGES TO PENNYWORTH HOMES INC. DEEMS TO BE AESTHETICALLY, ARCHITECTURALLY,

AND STRUCTURALLY SOUND.

13, November

PENNYWORTH HOMES INC. RESERVES THE RIGHT TO MAKE MODIFICATIONS TO THIS PLAN AFTER THE BUYERS APPROVAL / SIGNATURE, DUE TO THE ENGINEER'S AND BUILDING DEPT. REVIEW. THE BUYER SHALL BE NOTIFIE OF THESE MODIFICATIONS TO THE PLAN VIA CHANGE ORDER.

DRAWN BY: PLAN DATE: BAA | 08/01/2008


PAGE

JOB# 08-04-0042

OF

NOTE: BUILDER IS TO CONFIRM ROUGH OPENINGS BEFORE FRAMING.

UTILITY STUB OUT LOCATIONS TO BE DETERMINED BY SITE REQUIREMENTS

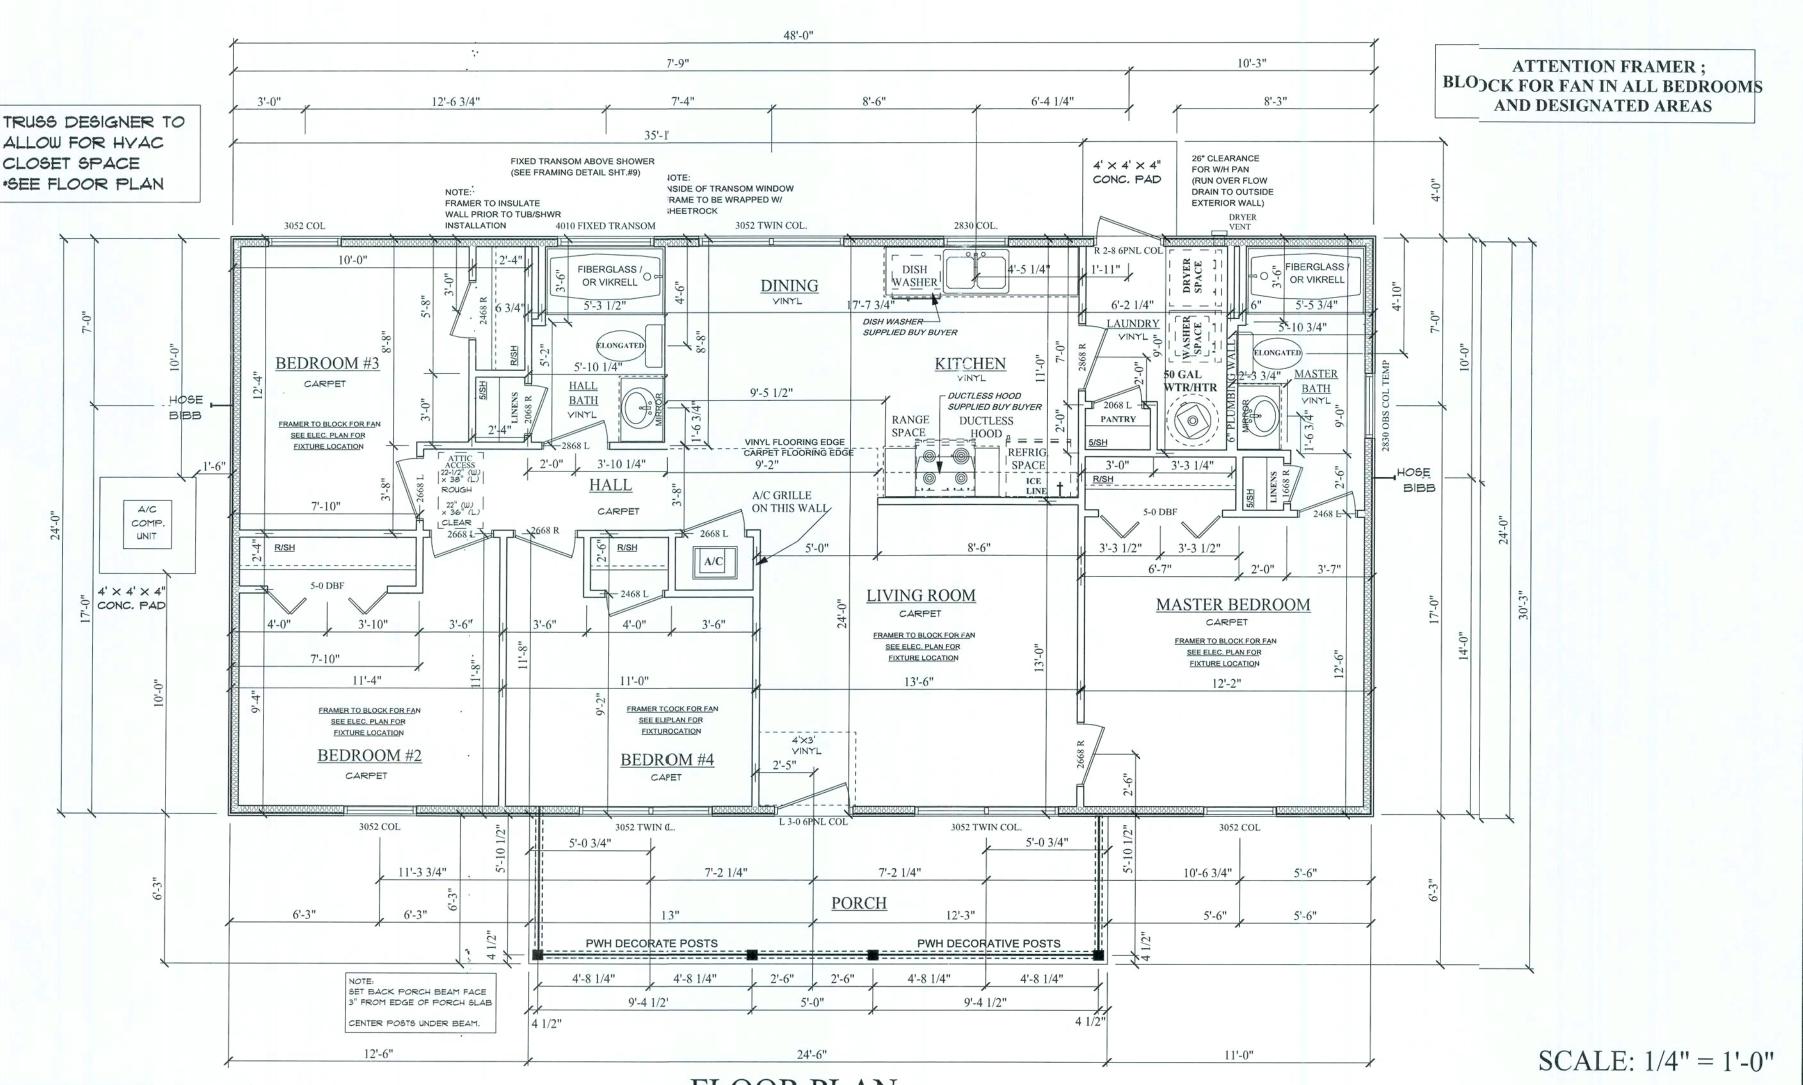

NOTE: PLAN MAY CHANGE TO REFLECTS CHANGES FOR NEW HYAC REQUIREMENTS FLOOR PLAN


DRAWN BY: DISCRIPTION OF REVISION

ELECTRICAL/HVAC FIXTRES SHOWN ON THIS DRAWING ARE LOCATED IN ACCORANCE WITH PENNYWORTH HOMES SPECIFICATIONS DO NOT RELOCATE ANY FIXTURE WITHOUT PRIOIAPPROVAL FROM THE CONSTRUCTION SUPERVIOR.

NOTE: PENNYWORTH HOMES RESERVES THE RIGHT TO MAKE CHANGES TO THE ELECTRICAL LAYOUT TO MEET NECESSARY ELECTRICAL OR BUILDING CODDES. CHANGES MAY ALSO BE MADE AT THE DISCRETION OF THE BUILDER OR ELECTRICIAN DUE TO HOUSE FRAAMING

OR ELECTRICAL INSTALLATION TECHNIQUES.

#### ELECTRICAL SYMBOL COUNT 8 9 Ф AF U 15 AF OUTLET F BATH FAN ₽ BATH MAIN 999 BATH OVER MIRROR LR O 5 BED LIV FAN NO BLOCK GATY 0 CABLE TV OUTLET 3 7777 CHIMES -¢-CLOSET\_UTILITY FLOOD V DBL FLOOD DR O-DINING ROOM \_\_\_\_ DOOR BELL ELECTRIC PANEL EXT CEILING EXT WALL 1 GFI OUTLET ₹ R GFI WR -HALL KITCH FLOURESCENT KITCHEN FLOURESCENT -6-KITCHEN SINK CEILING LIT PHONE ( PHONE JACK SMOKE DETECTOR1 PHONE WALL PHONE \$ switch 15 switch 3 way \$3

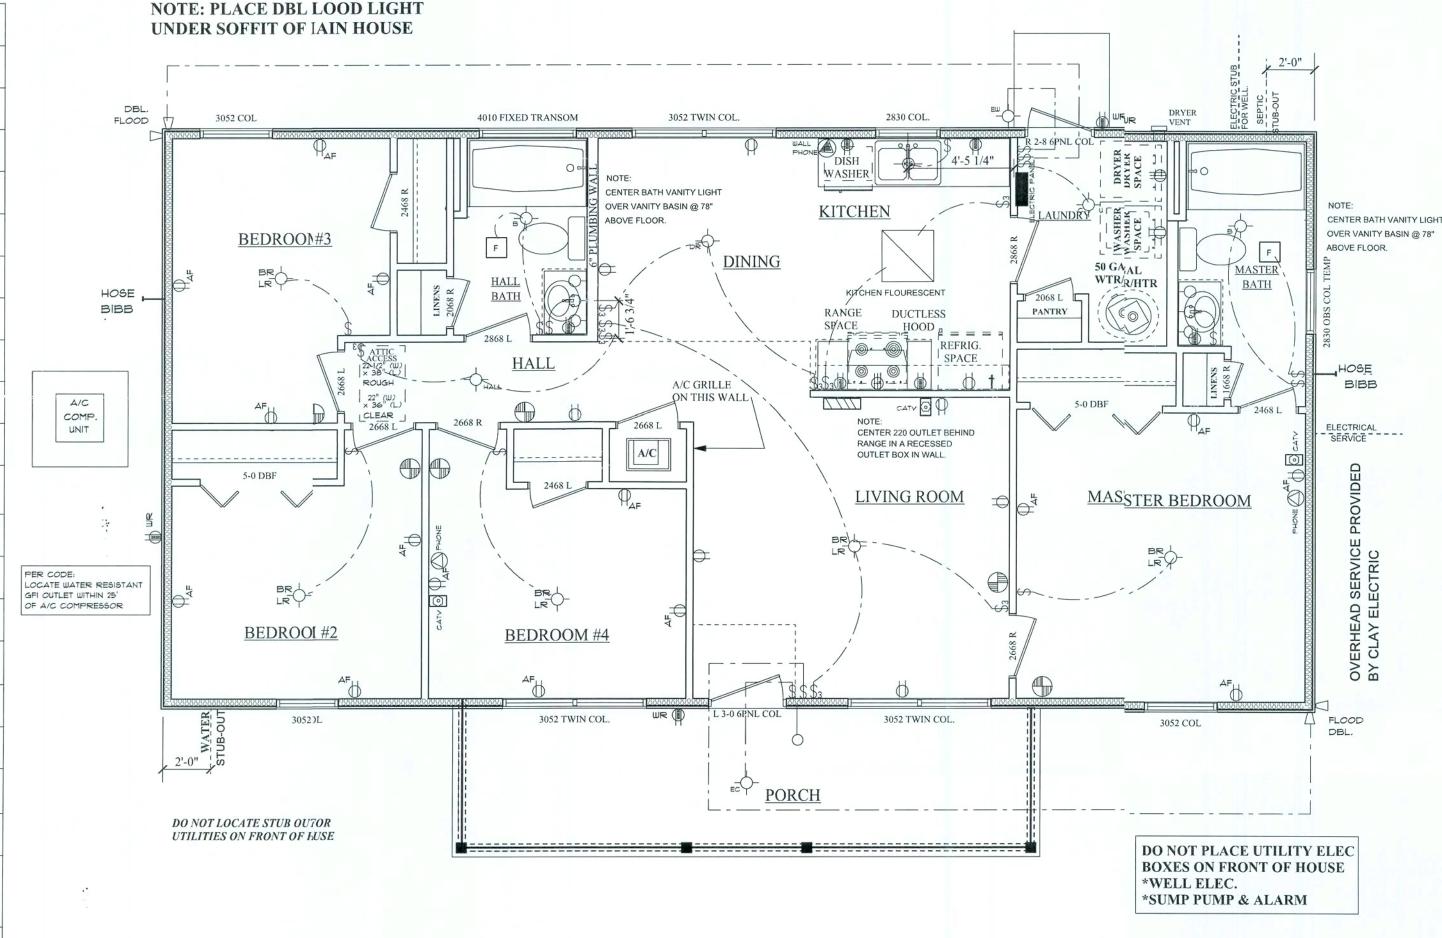

ELECTRICAL PLAN

FRAMER: BLOCK FOR FAN IN ALL BEDROOMS AND DESIGNATEDAREAS

SCALE: 1/4" = 1'-0"

DRAWN BY: DISCRIPTION OF REVISION

#### **Pennyworth Homes**

Got Land? Let's Build! PennyworthHomes.com

EXHIBIT "A"

SANFORD B

CUSTOMER NAME:

MR. & MRS. RUFUS BRYANT HEATED LIVING AREA

GROUND FLOOR: SECOND FLOOR:

OTHER: N/A TOTAL HEATED: 1152

N/A

#### NON-HEATED LIVING AREA

PORCH: **GARAGE:** OTHER: N/A TOTAL U/R 1296


# IMPORTANT-PLEASE READ

#### **BELOW CAREFULLY**

OUR SALES BROCHURES AND OTHER ADVERTISING LIT ERATURE ARE INTENDED TO GENERALLY REFLECT AND DEPICT THE STYLES AND QUALITY OF HOMES WE BUILD THROUGHOUT A PORTION OF THE UNITED STATES. OUR SALES MODELS ARE DESIGNED AND BUILT TO GENERALLY CONFORM WITH A VARIETY OF LOCAL CUSTOMS, PRAC-TICES, AND BUILDING CODES PREVALENT OR IN EFFECT IN THE IMMEDIATE AREA SURROUNDING THE LOCATION OF THOSE MODELS. THIS SET OF PLANS IS AN ACTUAL PART OF OUR CONTRACT WITH YOU AND, AS SUCH, IS IN TENDED TO TAKE PRIORITY OVER ANYTHING IN CONFLICT WITH IT CONTAINED IN OUR ADVERTISING LITERATURE, OUR SALES MODELS AND EVEN OUR ORAL SALES PRESEN TATION. NO CHANGE, MODIFICATION, OR REVISION OF THESE PRINTED PLANS SHALL BE BINDING ON THE PARTIES UNLESS SET FORTH ON THESE PLANS OR OTHER WISE REDUCED TO WRITING AND EXECUTED BY SAID PARTIES. PLEASE REVIEW THESE PLANS ALONG WITH "EXHIBIT B" OF YOUR CONTRACT CAREFULLY AND MAKE CERTAIN BEFORE YOU SIGN THEM THAT THEY ACCU-RATELY REPRESENT THE HOME YOU ARE PURCHASING ADDITIONALLY, P.W.H. HOMES INC. HEREBY RESERVES THE RIGHT TO SUBSTITUTE MATERIALS OF EQUIVALENT QUALITY AND/OR TECHNIQUES OF ASSEMBLY AND/OR CONSTRUCTION METHODS FROM THAT CONTAINED IN THESE PLANS OR SPECIFIED IN EXHIBIT "B" WHERE NEC-ESSARY TO ACCOMODATE DIFFERENCES IN LOCAL CODES GEOGRAPHIC CUSTOMS, OPTION SELECTION AND AVAIL-ABILITY OF MATERIALS. ALL MATERIALS (LUMBER, OR OTHER BUILDING SUPPLIES) DELIVERED TO JOBSITE WHICH ARE IN EXCESS OF THOSE REQUIRED TO CON-STRUCT THE HOUSE AS AGREED REMAIN THE PROPERTY

#### NOTE:

PLANS, REQUESTED BY BUYERS, THAT PENNYWORTH HOMES INC. DEEMS TO BE AESTHETICALLY, ARCHITECTURALLY, AND STRUCTURALLY SOUND

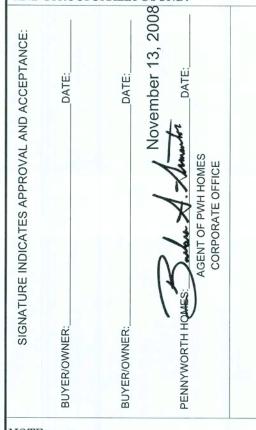


PENNYWORTH HOMES INC. RESERVES APPROVAL / SIGNATURE, DUE TO THE ENGINEER'S AND BUILDING DEPT. OF THESE MODIFICATIONS TO THE PLAN VIA CHANGE ORDER


BAA | 08/01/2008 |

JOB# 08-04-0042

OF \

**PAGE** 

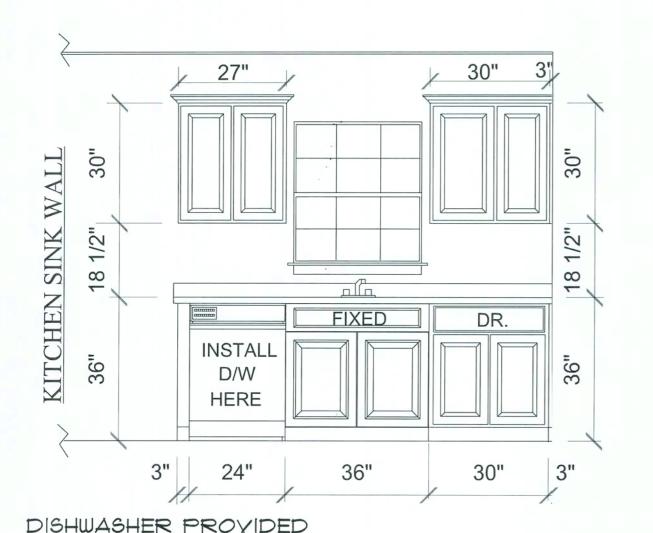

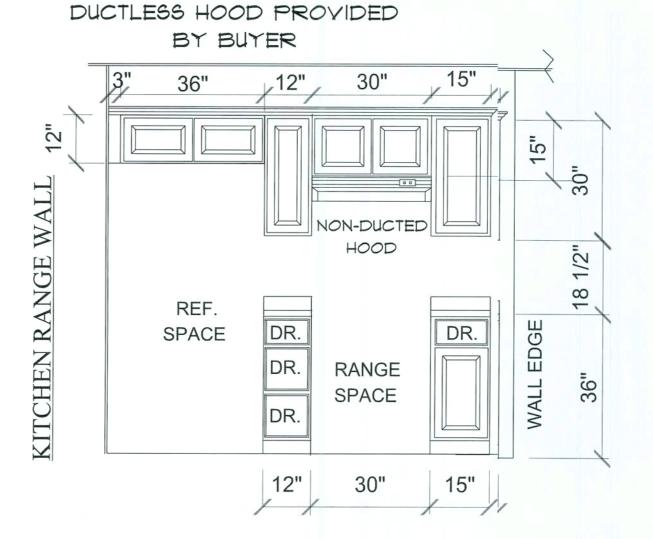


# KITCHIN CABINET ELEVATIONS

INSTALL CROWN MOLDING ARCIND TOP OF KITCHEN WALL CABINES.

INSTALL QUARTER ROUND MOLDIING AROUND BOTTOM OF ALL BASE CABINETS & VANITIES.

CABINETS ARE SYMBOLIC. ACTUAL UNITS MAY YERI IN STYLE \*TO BE DETERMINED BY BUYER.

BY BUYER

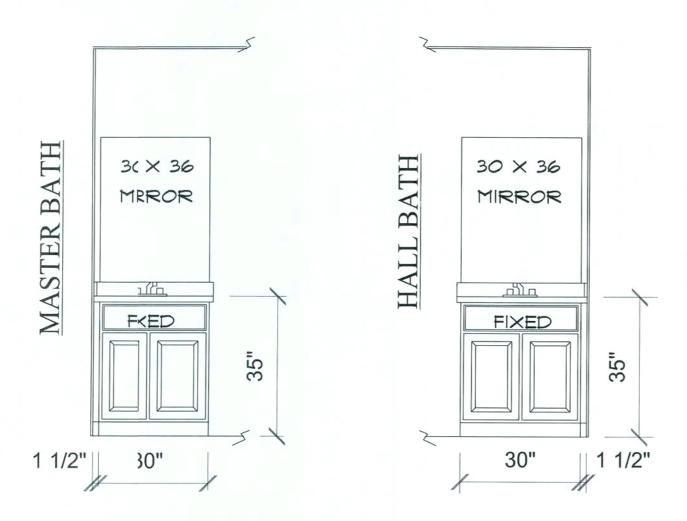

# VANITY CABINET ELEVATIONS

SCALE: 1/2'' = 1'-0''

REV.#	REV. DATE:	L DRAWN BY	DISCRIPTION OF REVISION

**Pennyworth Homes** 

Got Land? Let's Build! PennyworthHomes.com FL-CRC058 EXHIBIT "A"

SANFORD B CUSTOMER NAME:

MR. & MRS. RUFUS BRYANT HEATED LIVING AREA

GROUND FLOOR: SECOND FLOOR: N/A OTHER: N/A

TOTAL HEATED: 1152 NON-HEATED LIVING AREA

PORCH: 144 **GARAGE:** N/A OTHER: N/A TOTAL U/R


**IMPORTANT-PLEASE READ** 

1296

**BELOW CAREFULLY** 

ERATURE ARE INTENDED TO GENERALLY REFLECT AND DEPICT THE STYLES AND QUALITY OF HOMES WE BUILD THROUGHOUT A PORTION OF THE UNITED STATES. OUR SALES MODELS ARE DESIGNED AND BUILT TO GENERALLY CONFORM WITH A VARIETY OF LOCAL CUSTOMS, PRAC-TICES, AND BUILDING CODES PREVALENT OR IN EFFECT IN THE IMMEDIATE AREA SURROUNDING THE LOCATION OF THOSE MODELS. THIS SET OF PLANS IS AN ACTUAL PART OF OUR CONTRACT WITH YOU AND, AS SUCH, IS IN-TENDED TO TAKE PRIORITY OVER ANYTHING IN CONFLICT WITH IT CONTAINED IN OUR ADVERTISING LITERATURE, OUR SALES MODELS AND EVEN OUR ORAL SALES PRESEN-TATION. NO CHANGE, MODIFICATION, OR REVISION OF THESE PRINTED PLANS SHALL BE BINDING ON THE PARTIES UNLESS SET FORTH ON THESE PLANS OR OTHER WISE REDUCED TO WRITING AND EXECUTED BY SAID PARTIES. PLEASE REVIEW THESE PLANS ALONG WITH "EXHIBIT B" OF YOUR CONTRACT CAREFULLY AND MAKE CERTAIN BEFORE YOU SIGN THEM THAT THEY ACCU-RATELY REPRESENT THE HOME YOU ARE PURCHASING. ADDITIONALLY, P.W.H. HOMES INC. HEREBY RESERVES THE RIGHT TO SUBSTITUTE MATERIALS OF EQUIVALENT QUALITY AND/OR TECHNIQUES OF ASSEMBLY AND/OR CONSTRUCTION METHODS FROM THAT CONTAINED IN THESE PLANS OR SPECIFIED IN EXHIBIT "B" WHERE NEC-ESSARY TO ACCOMODATE DIFFERENCES IN LOCAL CODES GEOGRAPHIC CUSTOMS, OPTION SELECTION AND AVAIL-ABILITY OF MATERIALS. ALL MATERIALS (LUMBER, OR OTHER BUILDING SUPPLIES) DELIVERED TO JOBSITE WHICH ARE IN EXCESS OF THOSE REQUIRED TO CON-STRUCT THE HOUSE AS AGREED REMAIN THE PROPERTY OF P.W.H. HOMES INC. NOTE:

PENNYWORTH HOMES INC. RESERVES THE RIGHT TO ONLY MAKE CHANGES TO PLANS, REQUESTED BY BUYERS, THAT PENNYWORTH HOMES INC. DEEMS TO BE AESTHETICALLY, ARCHITECTURALLY, AND STRUCTURALLY SOUND.

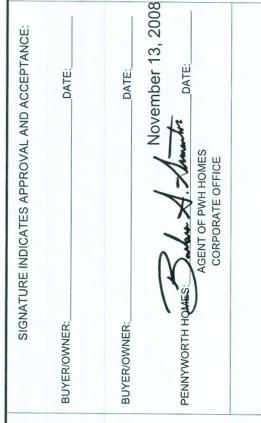


PENNYWORTH HOMES INC. RESERVES THE RIGHT TO MAKE MODIFICATIONS TO THIS PLAN AFTER THE BUYERS APPROVAL / SIGNATURE, DUE TO THE ENGINEER'S AND BUILDING DEPT. REVIEW. THE BUYER SHALL BE NOTIFIED OF THESE MODIFICATIONS TO THE PLAN VIA CHANGE ORDER.

PAGE

OF

DRAWN BY: PLAN DATE: 08/01/2008

JOB# 08-04-0042

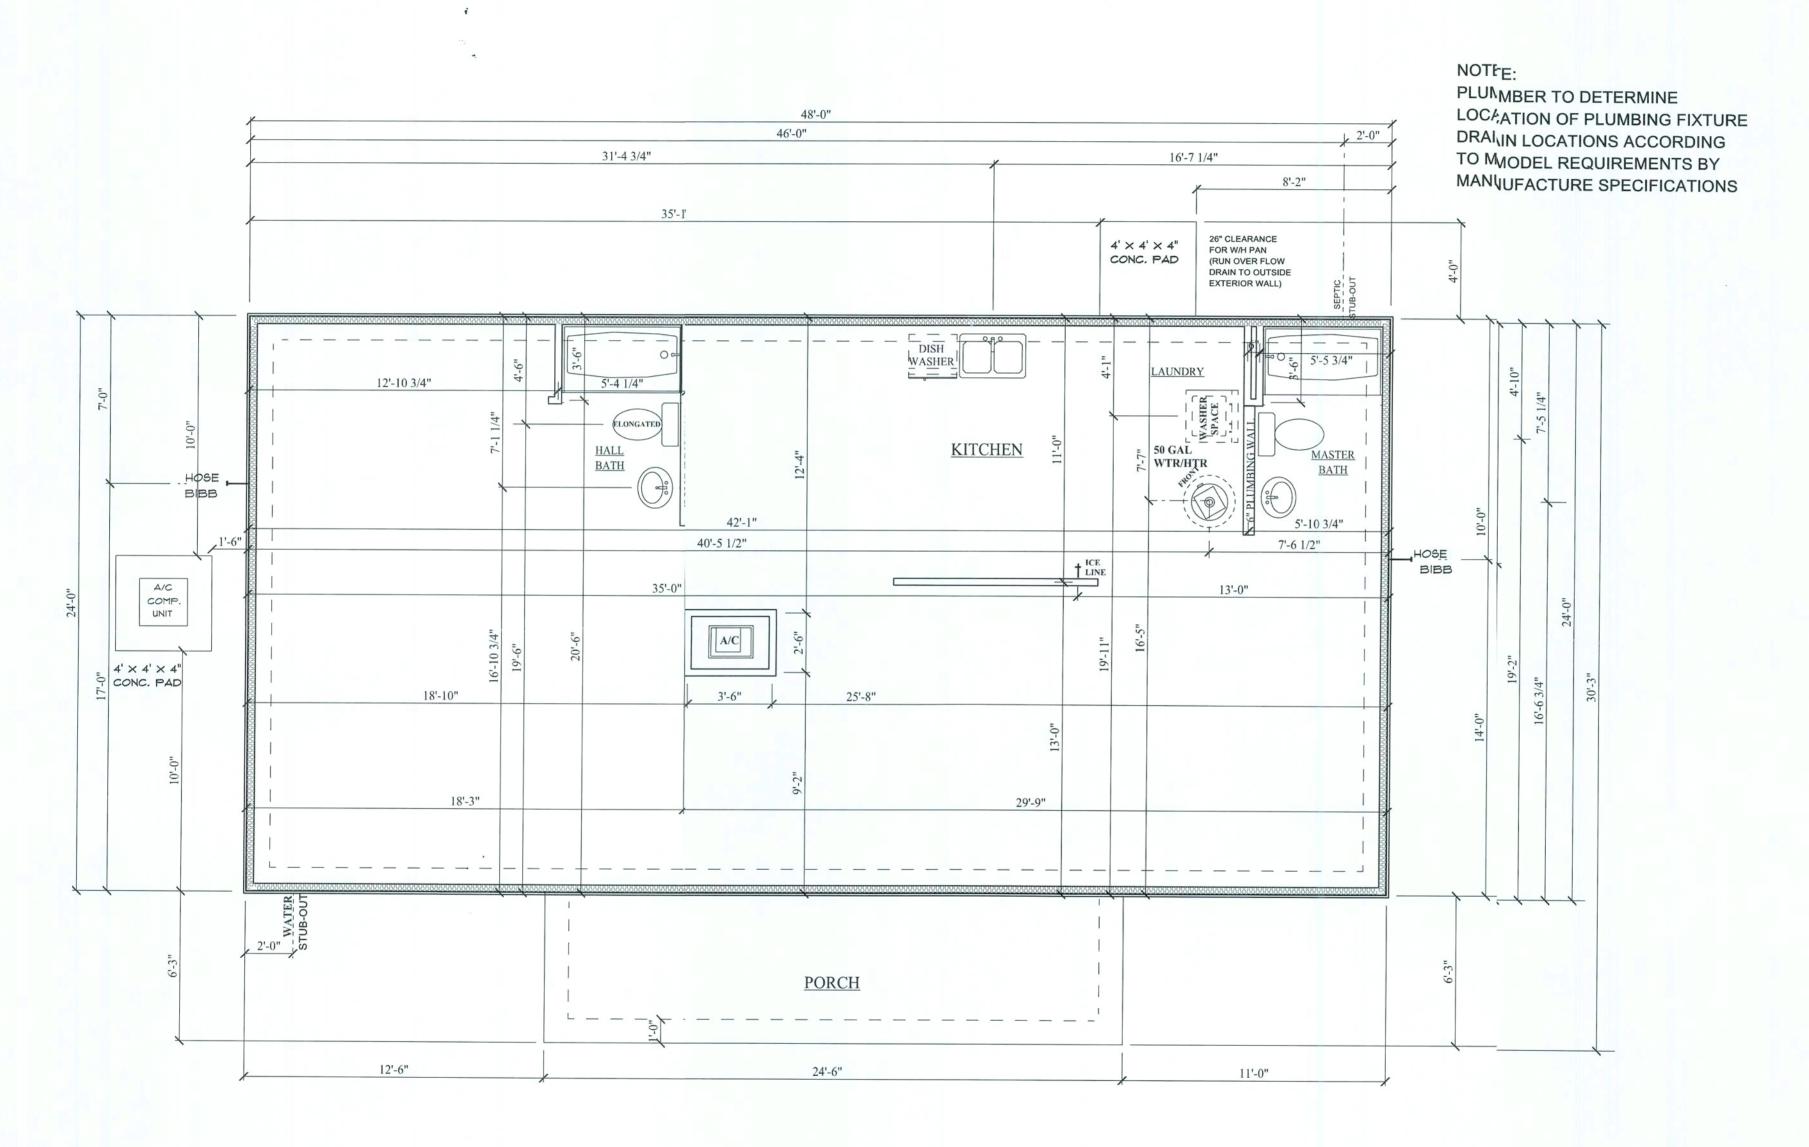

# PLUMBING PLAN

SCALE: 1/4'' = 1'-0''

REV.# REV. DATE: I DRAWN BY: DISCRIPTION OF REVISION

# Pennyworth Homes

Got Land? Let's Buildl c-010738 PennyworthHomes.com FL-CRC058

EXHIBIT "A"

PLAN: SANFORD B

CUSTOMER NAME:
MR. & MRS. RUFUS BRYANT

HEATED LIVING AREA

GROUND FLOOR: 1152 SECOND FLOOR: N/A

OTHER: N/A
TOTAL HEATED: 1152

NON-HEATED LIVING AREA

 PORCH:
 144

 GARAGE:
 N/A

 OTHER:
 N/A

 TOTAL U/R
 1296

#### IMPORTANT-PLEASE READ

#### BELOW CAREFULLY

OUR SALES BROCHURES AND OTHER ADVERTISING LIT-ERATURE ARE INTENDED TO GENERALLY REFLECT AND DEPICT THE STYLES AND QUALITY OF HOMES WE BUILD THROUGHOUT A PORTION OF THE UNITED STATES. OUR SALES MODELS ARE DESIGNED AND BUILT TO GENERALLY CONFORM WITH A VARIETY OF LOCAL CUSTOMS, PRAC-TICES, AND BUILDING CODES PREVALENT OR IN EFFECT IN THE IMMEDIATE AREA SURROUNDING THE LOCATION OF THOSE MODELS. THIS SET OF PLANS IS AN ACTUAL PART OF OUR CONTRACT WITH YOU AND, AS SUCH, IS INTENDED TO TAKE PRIORITY OVER ANYTHING IN CONFLICT WITH IT CONTAINED IN OUR ADVERTISING LITERATURE, OUR SALES MODELS AND EVEN OUR ORAL SALES PRESEN-TATION. NO CHANGE, MODIFICATION, OR REVISION OF THESE PRINTED PLANS SHALL BE BINDING ON THE PARTIES UNLESS SET FORTH ON THESE PLANS OR OTHER-WISE REDUCED TO WRITING AND EXECUTED BY SAID PARTIES. PLEASE REVIEW THESE PLANS ALONG WITH "EXHIBIT B" OF YOUR CONTRACT CAREFULLY AND MAKE CERTAIN BEFORE YOU SIGN THEM THAT THEY ACCU-RATELY REPRESENT THE HOME YOU ARE PURCHASING. ADDITIONALLY, P.W.H. HOMES INC. HEREBY RESERVES THE RIGHT TO SUBSTITUTE MATERIALS OF EQUIVALENT QUALITY AND/OR TECHNIQUES OF ASSEMBLY AND/OR CONSTRUCTION METHODS FROM THAT CONTAINED IN THESE PLANS OR SPECIFIED IN EXHIBIT "B" WHERE NEC-ESSARY TO ACCOMODATE DIFFERENCES IN LOCAL CODES, GEOGRAPHIC CUSTOMS, OPTION SELECTION AND AVAIL-ABILITY OF MATERIALS. ALL MATERIALS (LUMBER, OR OTHER BUILDING SUPPLIES) DELIVERED TO JOBSITE WHICH ARE IN EXCESS OF THOSE REQUIRED TO CON-STRUCT THE HOUSE AS AGREED REMAIN THE PROPERTY OF P.W.H. HOMES INC.

#### NOTE:

PENNYWORTH HOMES INC. RESERVES THE RIGHT TO ONLY MAKE CHANGES TO PLANS, REQUESTED BY BUYERS, THAT PENNYWORTH HOMES INC. DEEMS TO BE AESTHETICALLY, ARCHITECTURALLY, AND STRUCTURALLY SOUND.

BUYER/OWNER:

BUYER/OWNER:

BUYER/OWNER:

DATE:

DATE:

AGENT OF PWH HOMES

CORPORATE OFFICE

#### NOTE:

PENNYWORTH HOMES INC. RESERVES
THE RIGHT TO MAKE MODIFICATIONS
TO THIS PLAN AFTER THE BUYERS
APPROVAL / SIGNATURE, DUE TO THE
ENGINEER'S AND BUILDING DEPT.
REVIEW. THE BUYER SHALL BE NOTIFIEL
OF THESE MODIFICATIONS TO THE PLAN
VIA CHANGE ORDER.

DRAWN BY: PLAN DATE: 08/01/2008

JOB# 08-04-0042

OF 7

PAGE


# NOTE!:

REFER TO ENGINEERING FOR SPECIFICATIONS AND CALCULATIONS.

#### NOTE:

ROOF PITCHES ABOVE 4/12 ARE REQUIRED TO HAVE A MIN. OF (1) LAYER OF FELT PAPER PER FLORIDA BUILDING CODE SECTION 1507.3.8.2

5' LENGTH RAIN DIVERTER PLACED ON ROOF OVER REAR DOOR AREA

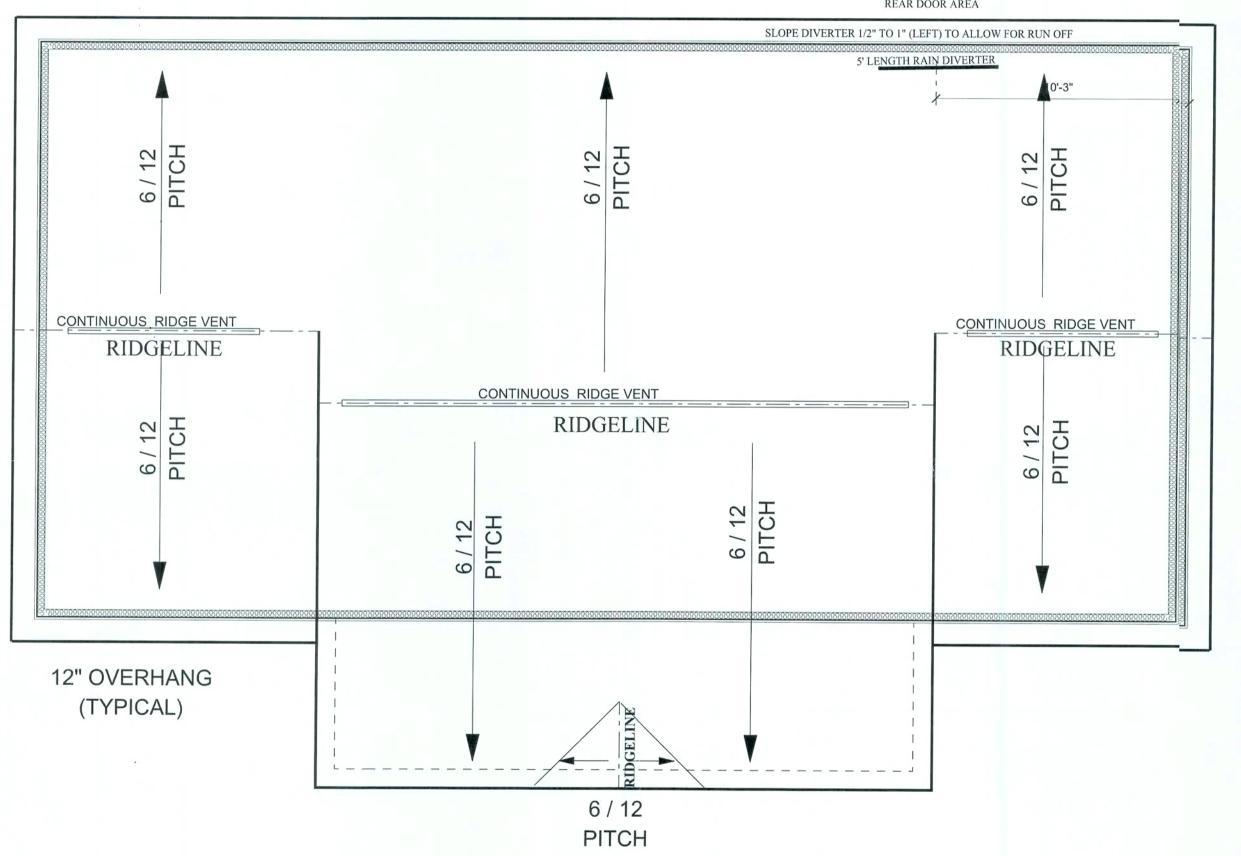

**ROOF LAYOUT** 

SCALE: 1/4'' = 1'0''

REV.# REV. DATE: DR/RAWN BY: DISCRIPTION OF REVISION

Pennyworth Homes

Got Land? Let's Buildle PennyworthHomes.com FL-CRCI

EXHIBIT "A"

PLAN: SANFORD B
CUSTOMER NAME:

MR. & MRS. RUFUS BRYANT HEATED LIVING AREA

GROUND FLOOR: 1152
SECOND FLOOR: N/A
OTHER: N/A
TOTAL HEATED: 1152

NON-HEATED LIVING AREA

 PORCH:
 144

 GARAGE:
 N/A

 OTHER:
 N/A

 TOTAL U/R
 1296

#### IMPORTANT-PLEASE READ

#### BELOW CAREFULLY

OUR SALES BROCHURES AND OTHER ADVERTISING LIT-ERATURE ARE INTENDED TO GENERALLY REFLECT AND DEPICT THE STYLES AND QUALITY OF HOMES WE BUILD THROUGHOUT A PORTION OF THE UNITED STATES. OUR SALES MODELS ARE DESIGNED AND BUILT TO GENERALLY CONFORM WITH A VARIETY OF LOCAL CUSTOMS, PRAC-TICES, AND BUILDING CODES PREVALENT OR IN EFFECT IN THE IMMEDIATE AREA SURROUNDING THE LOCATION OF THOSE MODELS. THIS SET OF PLANS IS AN ACTUAL PART OF OUR CONTRACT WITH YOU AND, AS SUCH, IS IN-TENDED TO TAKE PRIORITY OVER ANYTHING IN CONFLICT WITH IT CONTAINED IN OUR ADVERTISING LITERATURE, OUR SALES MODELS AND EVEN OUR ORAL SALES PRESEN-TATION. NO CHANGE, MODIFICATION, OR REVISION OF THESE PRINTED PLANS SHALL BE BINDING ON THE PARTIES UNLESS SET FORTH ON THESE PLANS OR OTHER-WISE REDUCED TO WRITING AND EXECUTED BY SAID PARTIES. PLEASE REVIEW THESE PLANS ALONG WITH "EXHIBIT B" OF YOUR CONTRACT CAREFULLY AND MAKE CERTAIN BEFORE YOU SIGN THEM THAT THEY ACCU-RATELY REPRESENT THE HOME YOU ARE PURCHASING. ADDITIONALLY, P.W.H. HOMES INC. HEREBY RESERVES THE RIGHT TO SUBSTITUTE MATERIALS OF EQUIVALENT QUALITY AND/OR TECHNIQUES OF ASSEMBLY AND/OR CONSTRUCTION METHODS FROM THAT CONTAINED IN THESE PLANS OR SPECIFIED IN EXHIBIT "B" WHERE NEC-ESSARY TO ACCOMODATE DIFFERENCES IN LOCAL CODES, GEOGRAPHIC CUSTOMS, OPTION SELECTION AND AVAIL-ABILITY OF MATERIALS. ALL MATERIALS (LUMBER, OR OTHER BUILDING SUPPLIES) DELIVERED TO JOBSITE WHICH ARE IN EXCESS OF THOSE REQUIRED TO CON-STRUCT THE HOUSE AS AGREED REMAIN THE PROPERTY OF P.W.H. HOMES INC.

NOTE:

PENNYWORTH HOMES INC. RESERVES
THE RIGHT TO ONLY MAKE CHANGES TO
PLANS, REQUESTED BY BUYERS, THAT
PENNYWORTH HOMES INC. DEEMS TO BE
AESTHETICALLY, ARCHITECTURALLY,
AND STRUCTURALLY SOUND.

ROVAL AND ACCEPTANCE:	DATE:	DATE:	MES DATE:	
SIGNATURE INDICATES APPROVAL AND ACCEPTANCE:	BUYER/OWNER:	BUYER/OWNER:	PENNYWORTH HOMES: AGENT OF PWH HOMES CORPORATE OFFICE	

NOTE


PENNYWORTH HOMES INC. RESERVES
THE RIGHT TO MAKE MODIFICATIONS
TO THIS PLAN AFTER THE BUYERS
APPROVAL / SIGNATURE, DUE TO THE
ENGINEER'S AND BUILDING DEPT.
REVIEW. THE BUYER SHALL BE NOTIFIED
OF THESE MODIFICATIONS TO THE PLAN
VIA CHANGE ORDER.

DRAWN BY: PLAN DATE: 08/01/2008

JOB# 08-04-0042

OF

PAGE

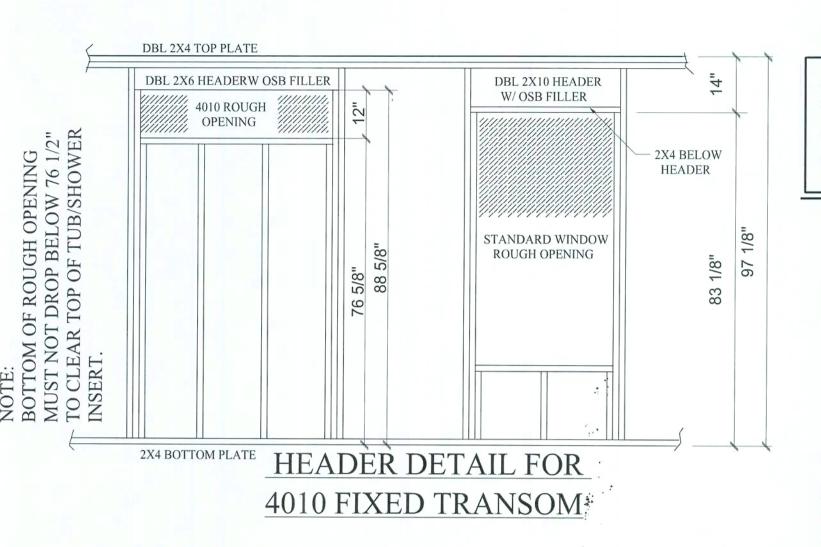

#### NOTE!:


REFER TO ENGINEERING FOR SPECIFICATIONS AND CALCULATIONS.

#### NOTE:


ALL METAL PRODUCTS USED ON PRESSURE TREATED LUMBER MUST BE HOT DIPPED GALVANIZED TO PREVENT DETERIORATION.


# PENNYWORTH HOMES TYPICALWALL SECTION FOR MONOLITHIC SLAB

NOTE: SEE FOUNDATION PLAN FOR FOUNDATON SPECIFICATIONS.

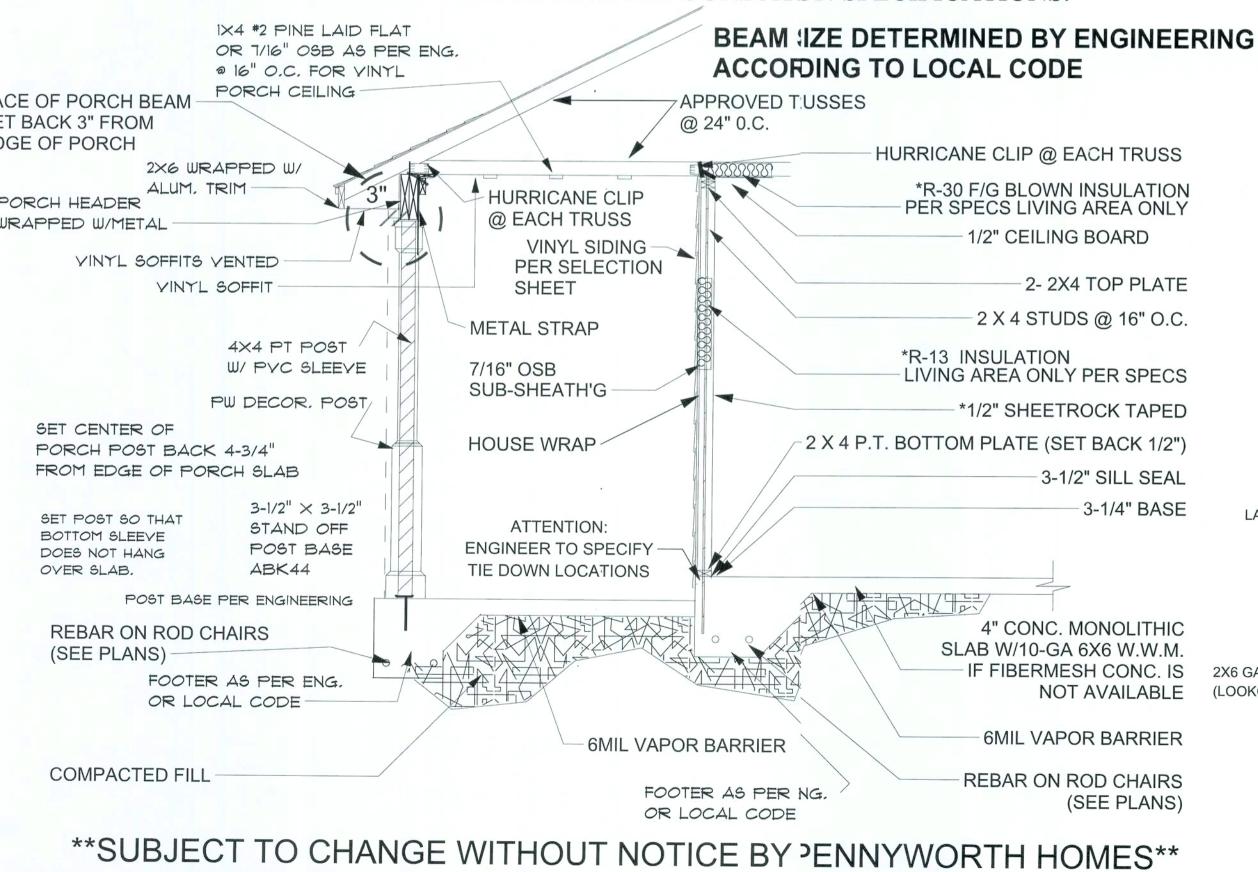

# BEAM SUBJECT 'TO CHANGE ACCORDING TO REQUIRED ENGINEERING SFPECIFICATIONS

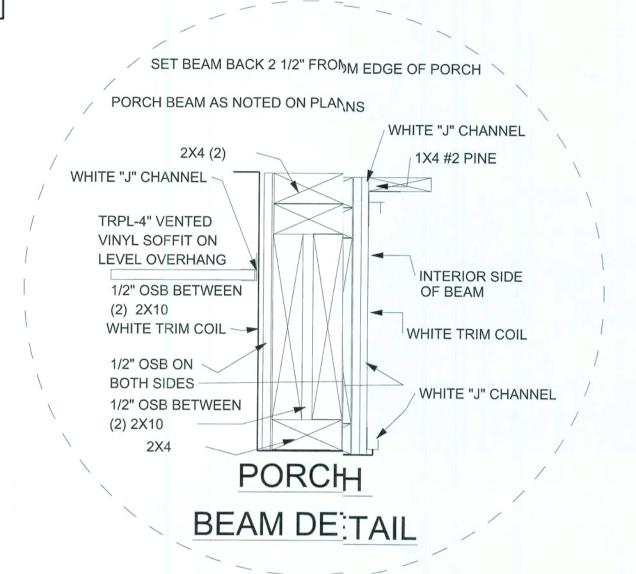

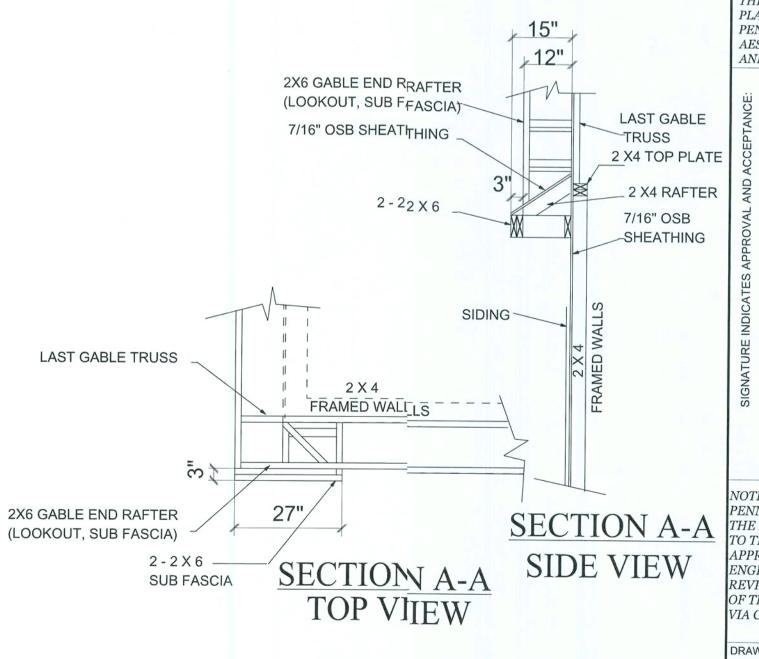

REV.#  $\mid$  REV. DATE:  $\mid$  I DRAWN BY:  $\mid$  DISCRIPTION OF REVISION

### Pennyworth Homes

Got Land? Let's Buildl PennyworthHomes.com FL-CRC0584 EXHIBIT "A"

PLAN: **SANFORD B**CUSTOMER NAME:

#### MR. & MRS. RUFUS BRYANT HEATED LIVING AREA

GROUND FLOOR: 1152
SECOND FLOOR: N/A
OTHER: N/A
TOTAL HEATED: 1152

#### NON-HEATED LIVING AREA

 PORCH:
 144

 GARAGE:
 N/A

 OTHER:
 N/A

 TOTAL U/R
 1296


#### IMPORTANT-PLEASE READ

#### BELOW CAREFULLY

OUR SALES BROCHURES AND OTHER ADVERTISING LITERATURE ARE INTENDED TO GENERALLY REFLECT AND DEPICT THE STYLES AND QUALITY OF HOMES WE BUILD THROUGHOUT A PORTION OF THE UNITED STATES. OUR SALES MODELS ARE DESIGNED AND BUILT TO GENERALLY CONFORM WITH A VARIETY OF LOCAL CUSTOMS, PRACTICES, AND BUILDING CODES PREVALENT OR IN EFFECT IN THE IMMEDIATE AREA SURROUNDING THE LOCATION OF THOSE MODELS. THIS SET OF PLANS IS AN ACTUAL PART OF OUR CONTRACT WITH YOU AND, AS SUCH, IS INTENDED TO TAKE PRIORITY OVER ANYTHING IN CONFLICT WITH IT CONTAINED IN OUR ADVERTISING LITERATURE, OUR SALES MODELS AND EVEN OUR ORAL SALES PRESEN TATION. NO CHANGE, MODIFICATION, OR REVISION OF THESE PRINTED PLANS SHALL BE BINDING ON THE PARTIES UNLESS SET FORTH ON THESE PLANS OR OTHER WISE REDUCED TO WRITING AND EXECUTED BY SAID PARTIES. PLEASE REVIEW THESE PLANS ALONG WITH "EXHIBIT B" OF YOUR CONTRACT CAREFULLY AND MAKE CERTAIN BEFORE YOU SIGN THEM THAT THEY ACCURATELY REPRESENT THE HOME YOU ARE PURCHASING. ADDITIONALLY, P.W.H. HOMES INC. HEREBY RESERVES THE RIGHT TO SUBSTITUTE MATERIALS OF EQUIVALENT QUALITY AND/OR TECHNIQUES OF ASSEMBLY AND/OR CONSTRUCTION METHODS FROM THAT CONTAINED IN THESE PLANS OR SPECIFIED IN EXHIBIT "B" WHERE NECESSARY TO ACCOMODATE DIFFERENCES IN LOCAL CODES GEOGRAPHIC CUSTOMS, OPTION SELECTION AND AVAILABILITY OF MATERIALS. ALL MATERIALS (LUMBER, OR OTHER BUILDING SUPPLIES) DELIVERED TO JOBSITE WHICH ARE IN EXCESS OF THOSE REQUIRED TO CONSTRUCT THE HOUSE AS AGREED REMAIN THE PROPERTY OF P.W.H. HOMES INC.

#### NOTE:

THE RIGHT TO ONLY MAKE CHANGES TO PLANS, REQUESTED BY BUYERS, THAT PENNYWORTH HOMES INC. DEEMS TO B AESTHETICALLY, ARCHITECTURALLY, AND STRUCTURALLY SOUND.

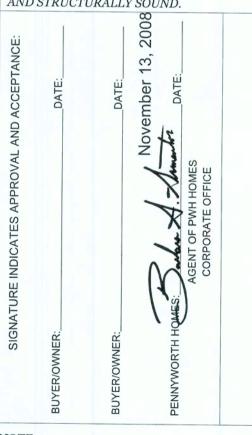


#### OTE:

PENNYWORTH HOMES INC. RESERVES
THE RIGHT TO MAKE MODIFICATIONS
TO THIS PLAN AFTER THE BUYERS
APPROVAL / SIGNATURE, DUE TO THE
ENGINEER'S AND BUILDING DEPT.
REVIEW. THE BUYER SHALL BE NOTIFIEL
OF THESE MODIFICATIONS TO THE PLAN
VIA CHANGE ORDER.

DRAWN BY: PLAN DATE: PAGE
BAA 08/01/2008


JOB# 08-04-0042

OF 7

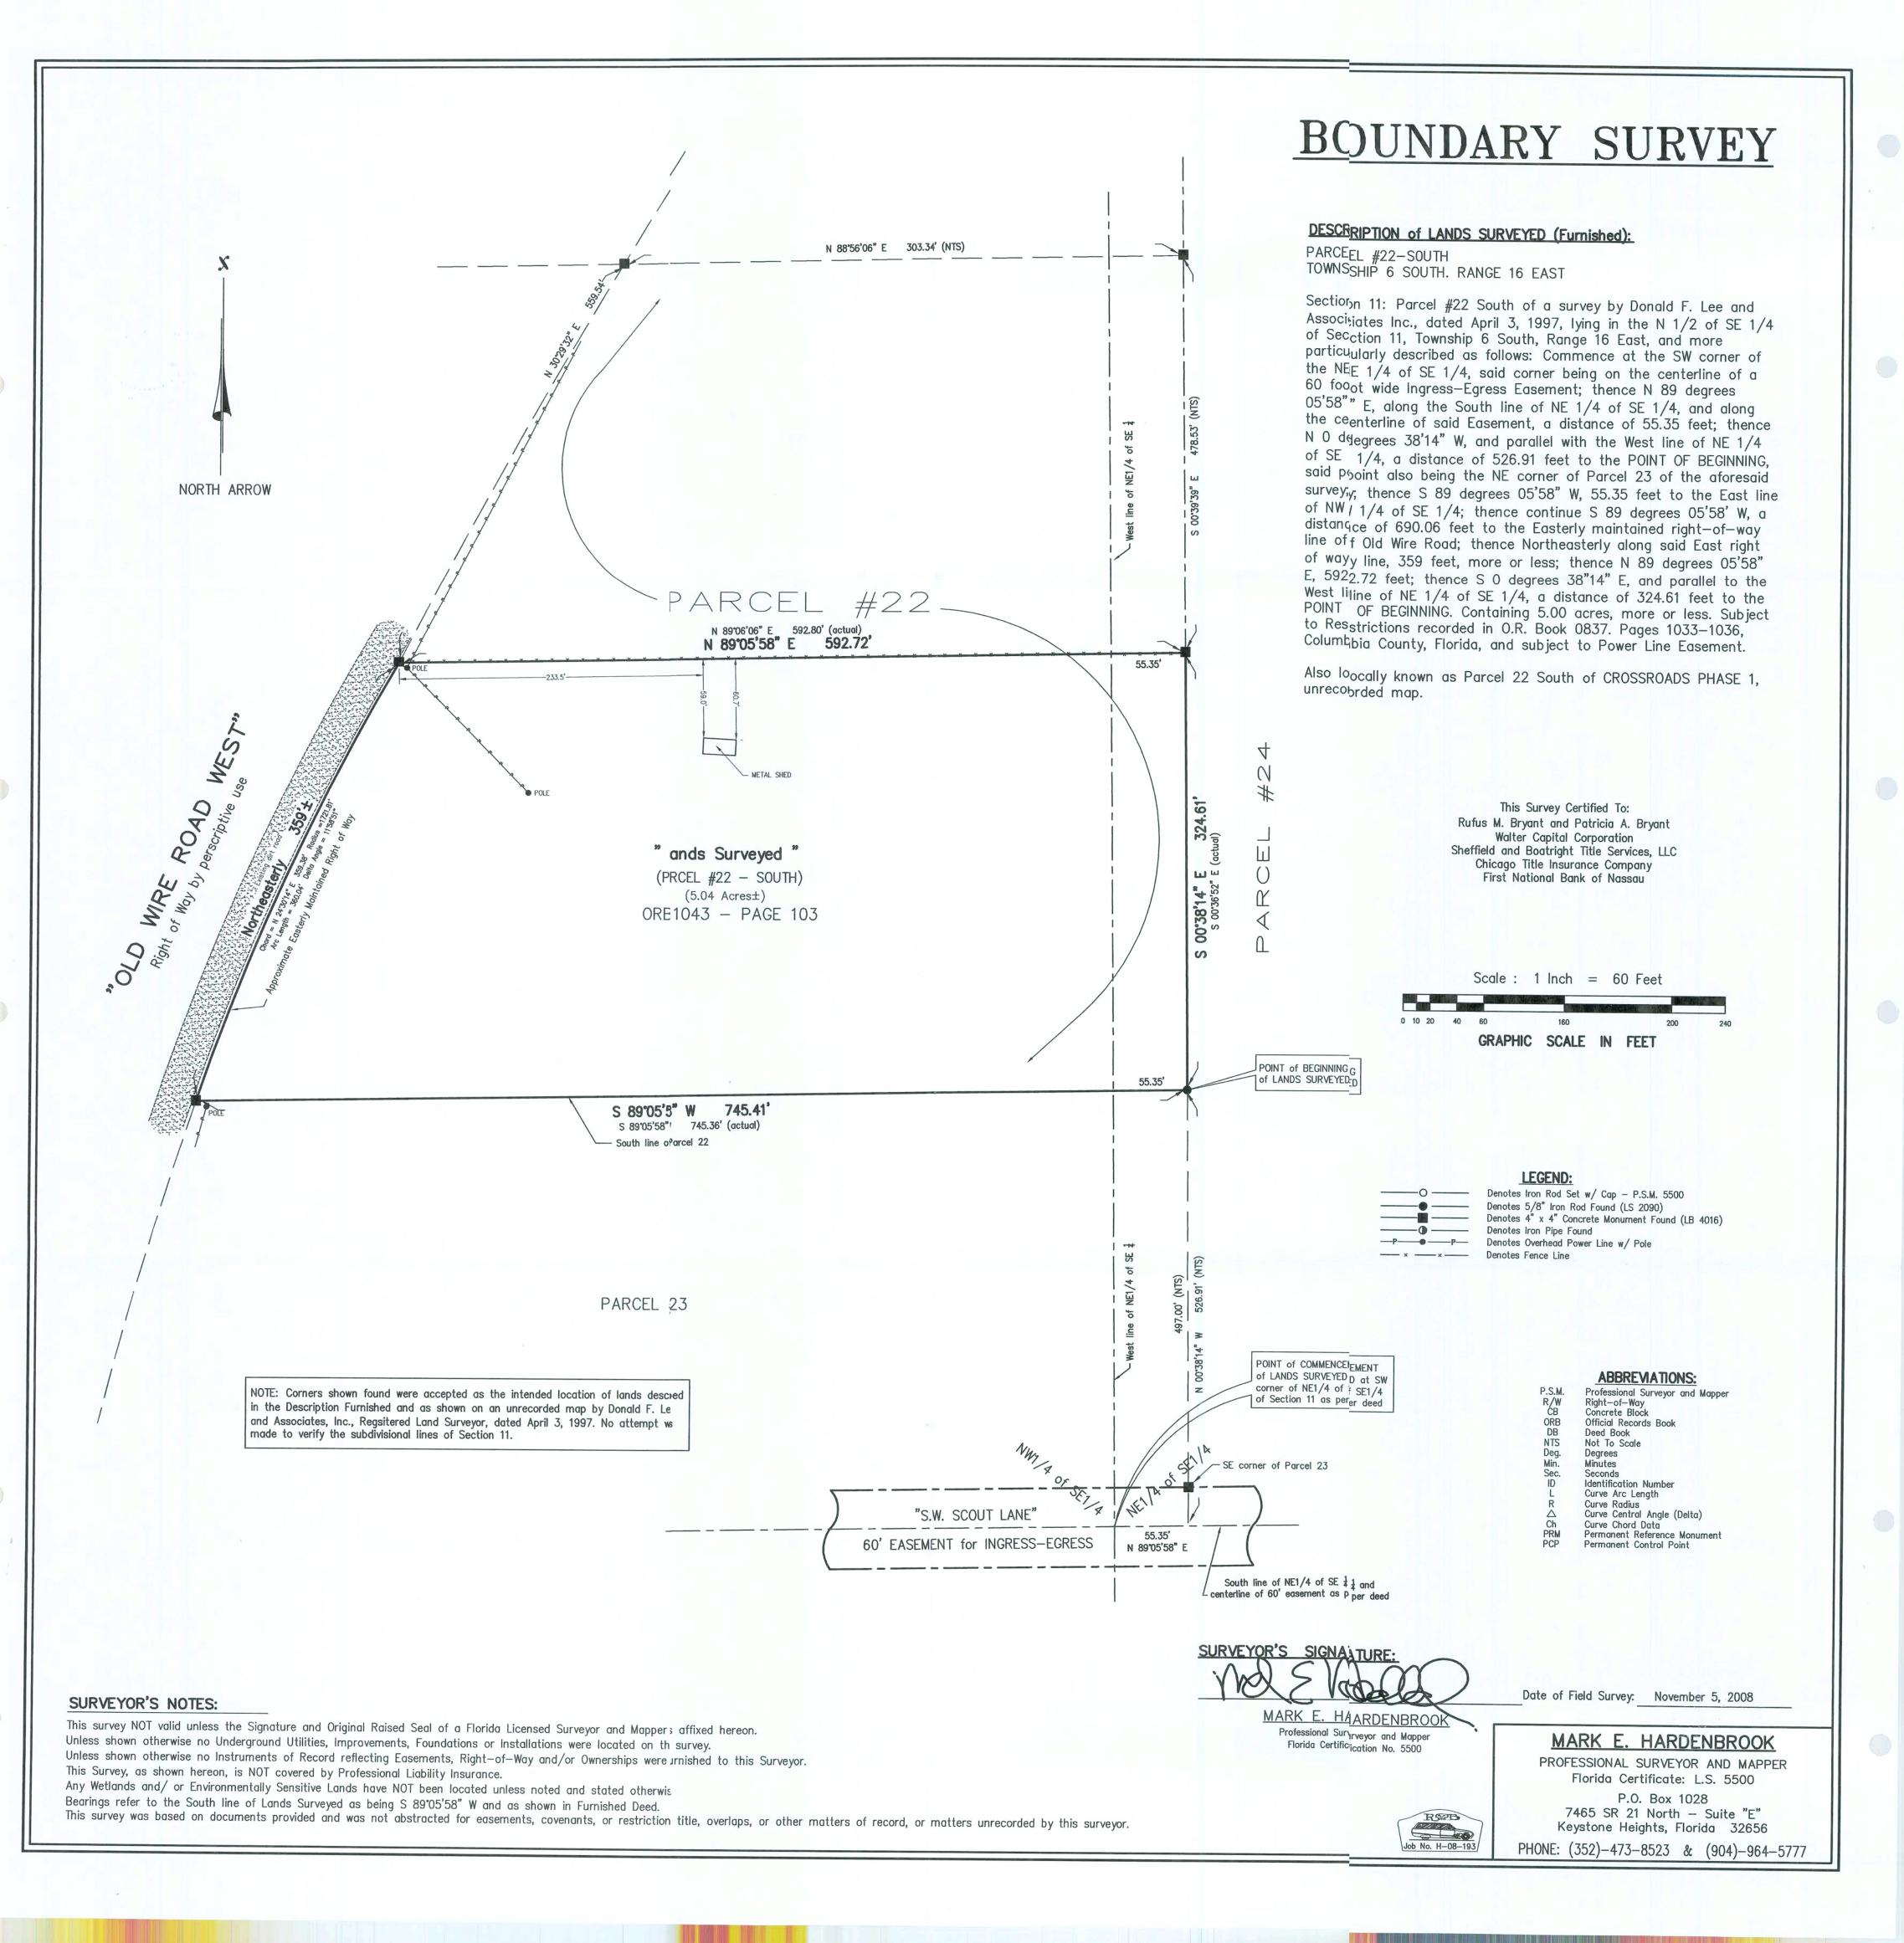






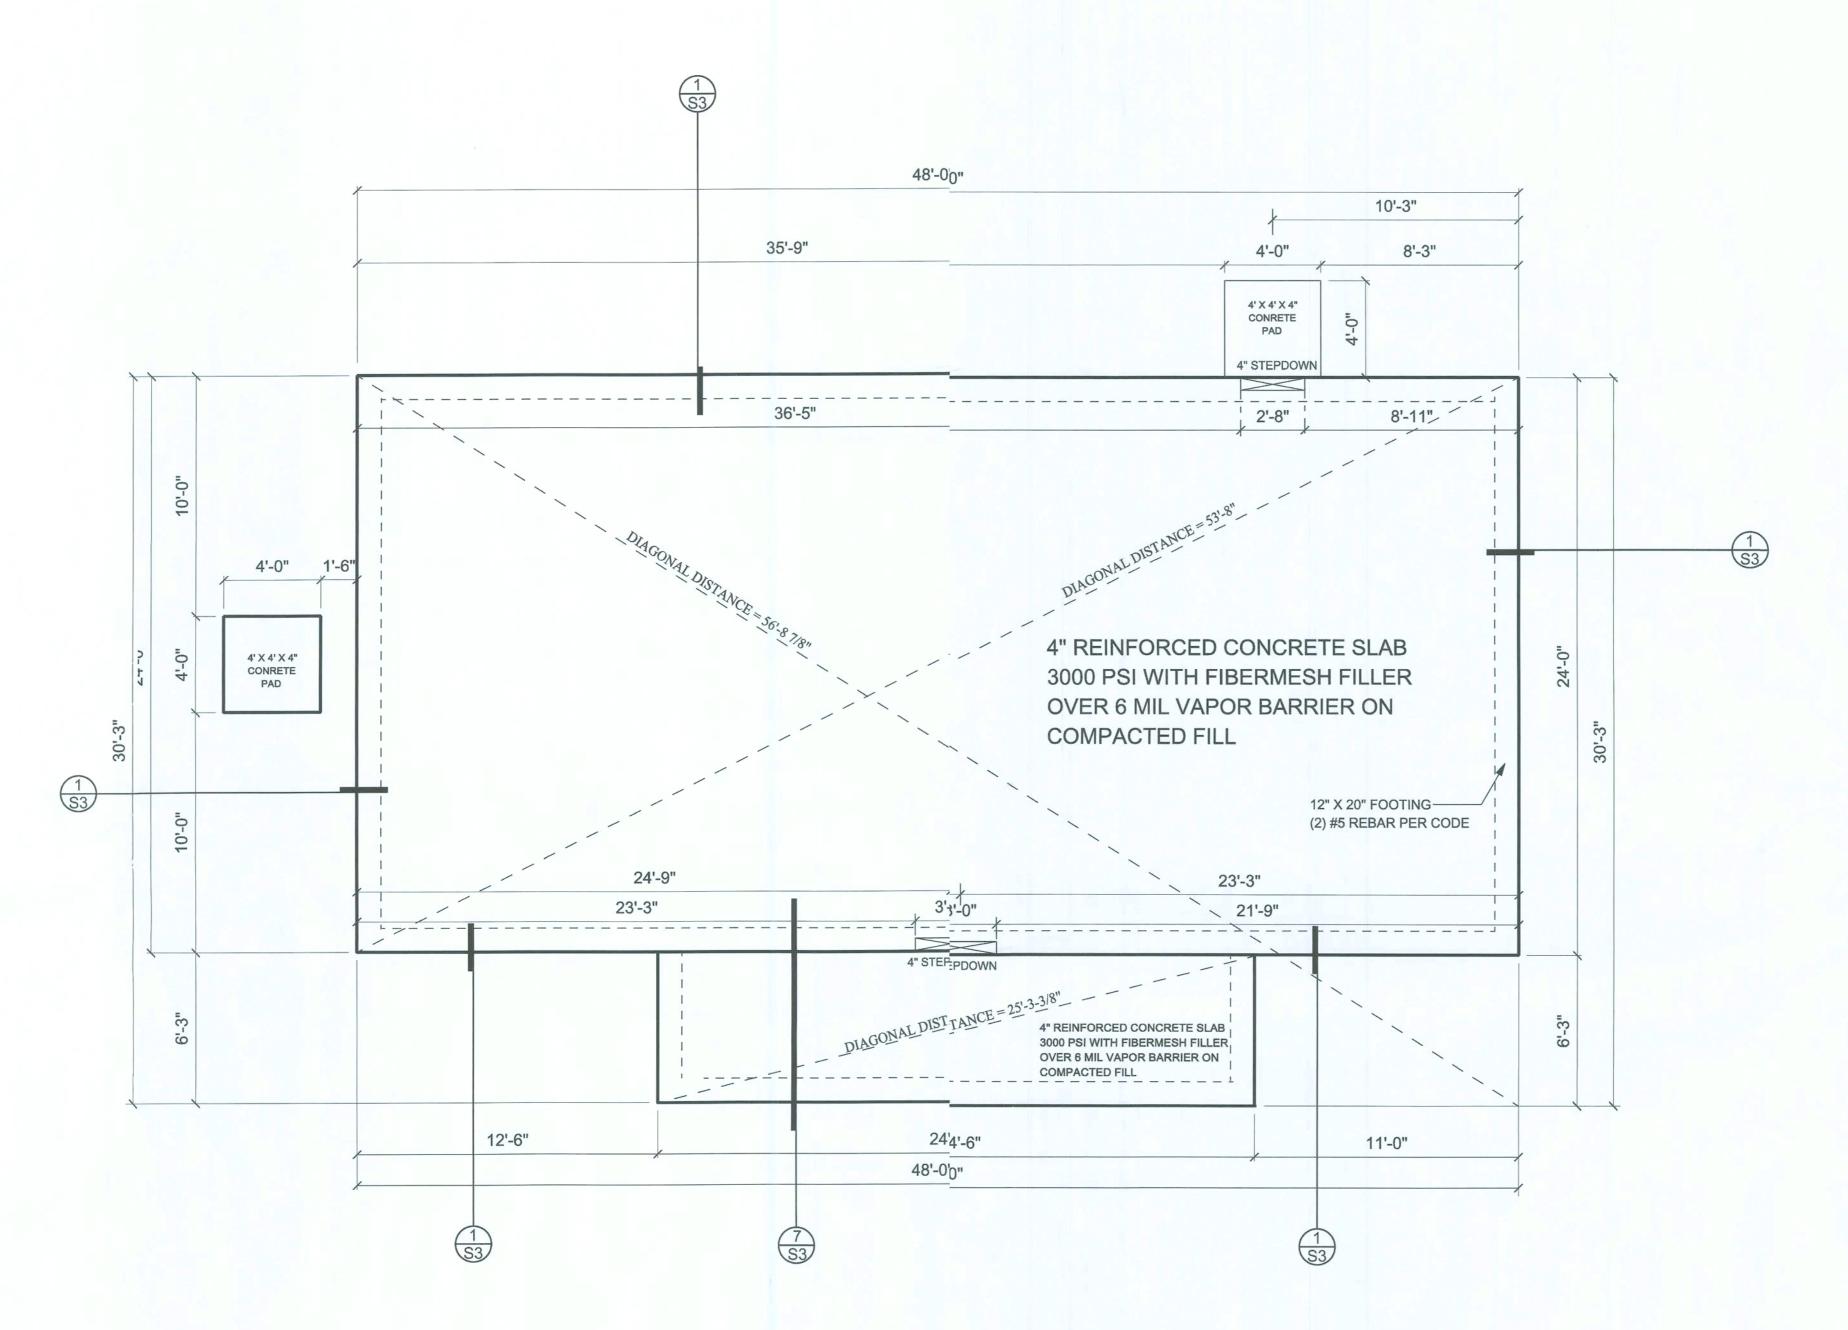


FOUNDATION PLAN



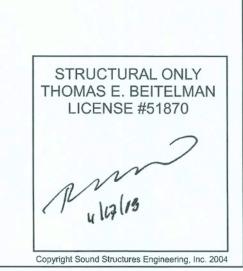

No. 08S-171

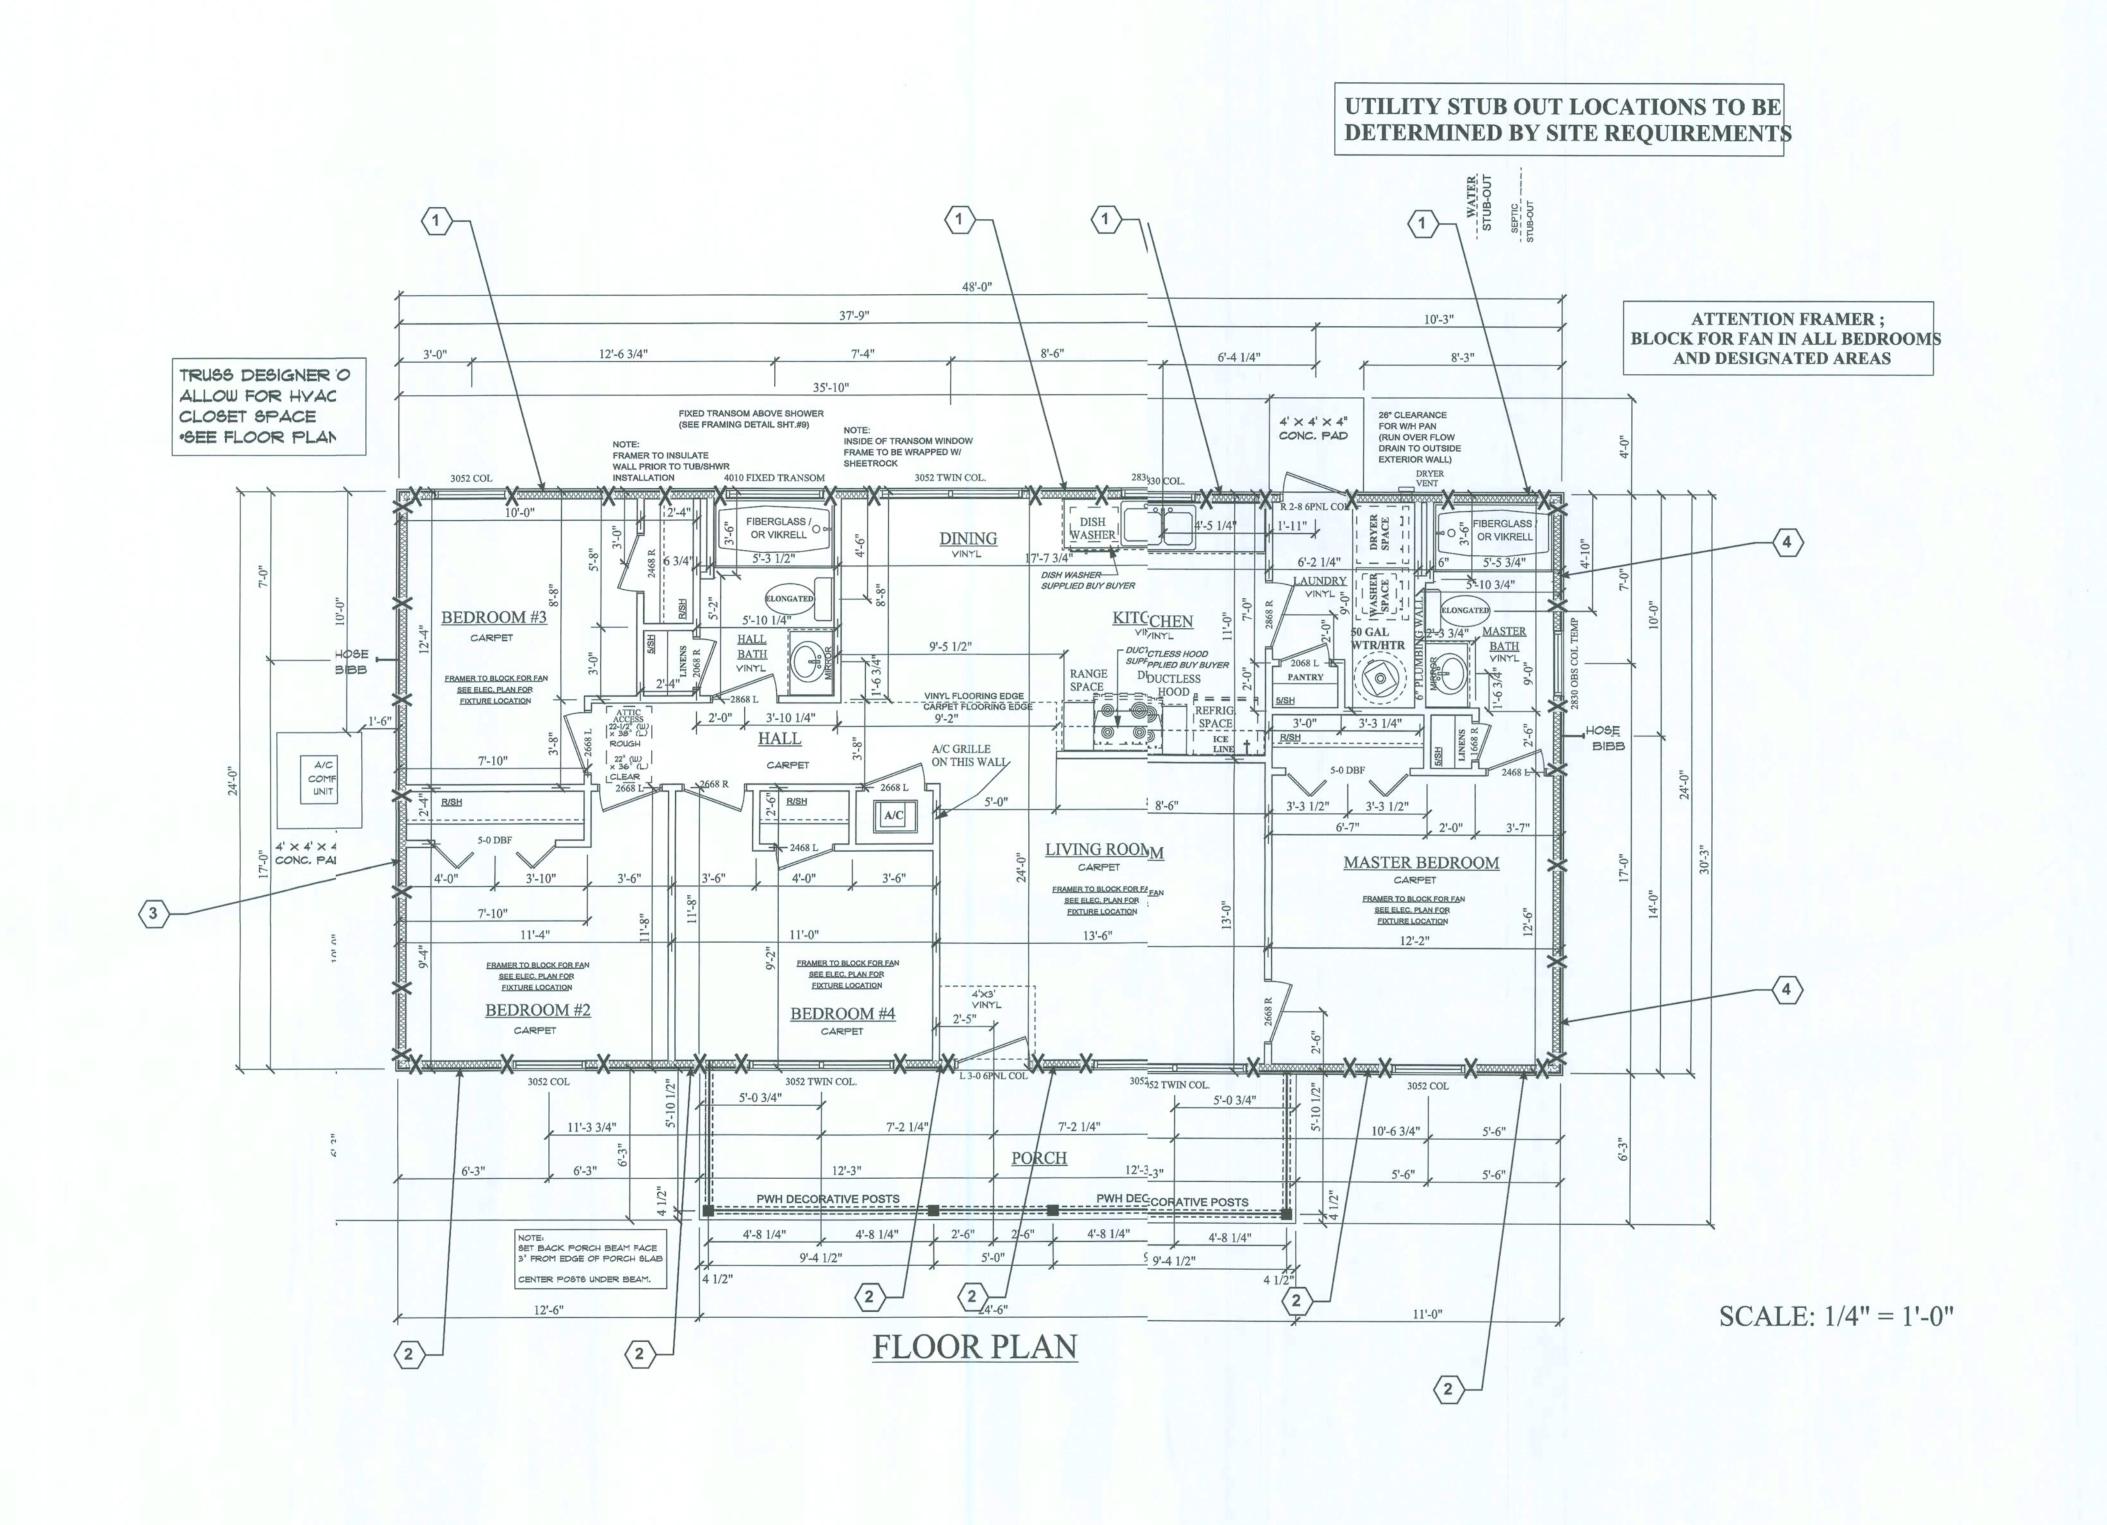

Engineering Structural Engineering
William E. Douglas P.E., President 0 Soun

- Bryant Resid

Pennyworth Homes - Old Wire Road, Ft. White, FL ails and Wind Load | SCALE: Varies | CLIENT: Revision By: Date: Description:

0


LICENSE #51870 Copyright Sound Structures Engineering, Inc. 2004

STRUCTURAL ONLY THOMAS E. BEITELMAN

# Shear-Wall Identification Number See Sheet S2 for specifications

X — Approximate location of ½" dia. tie-rods

Sheet S2 of 4 No. 08S-171

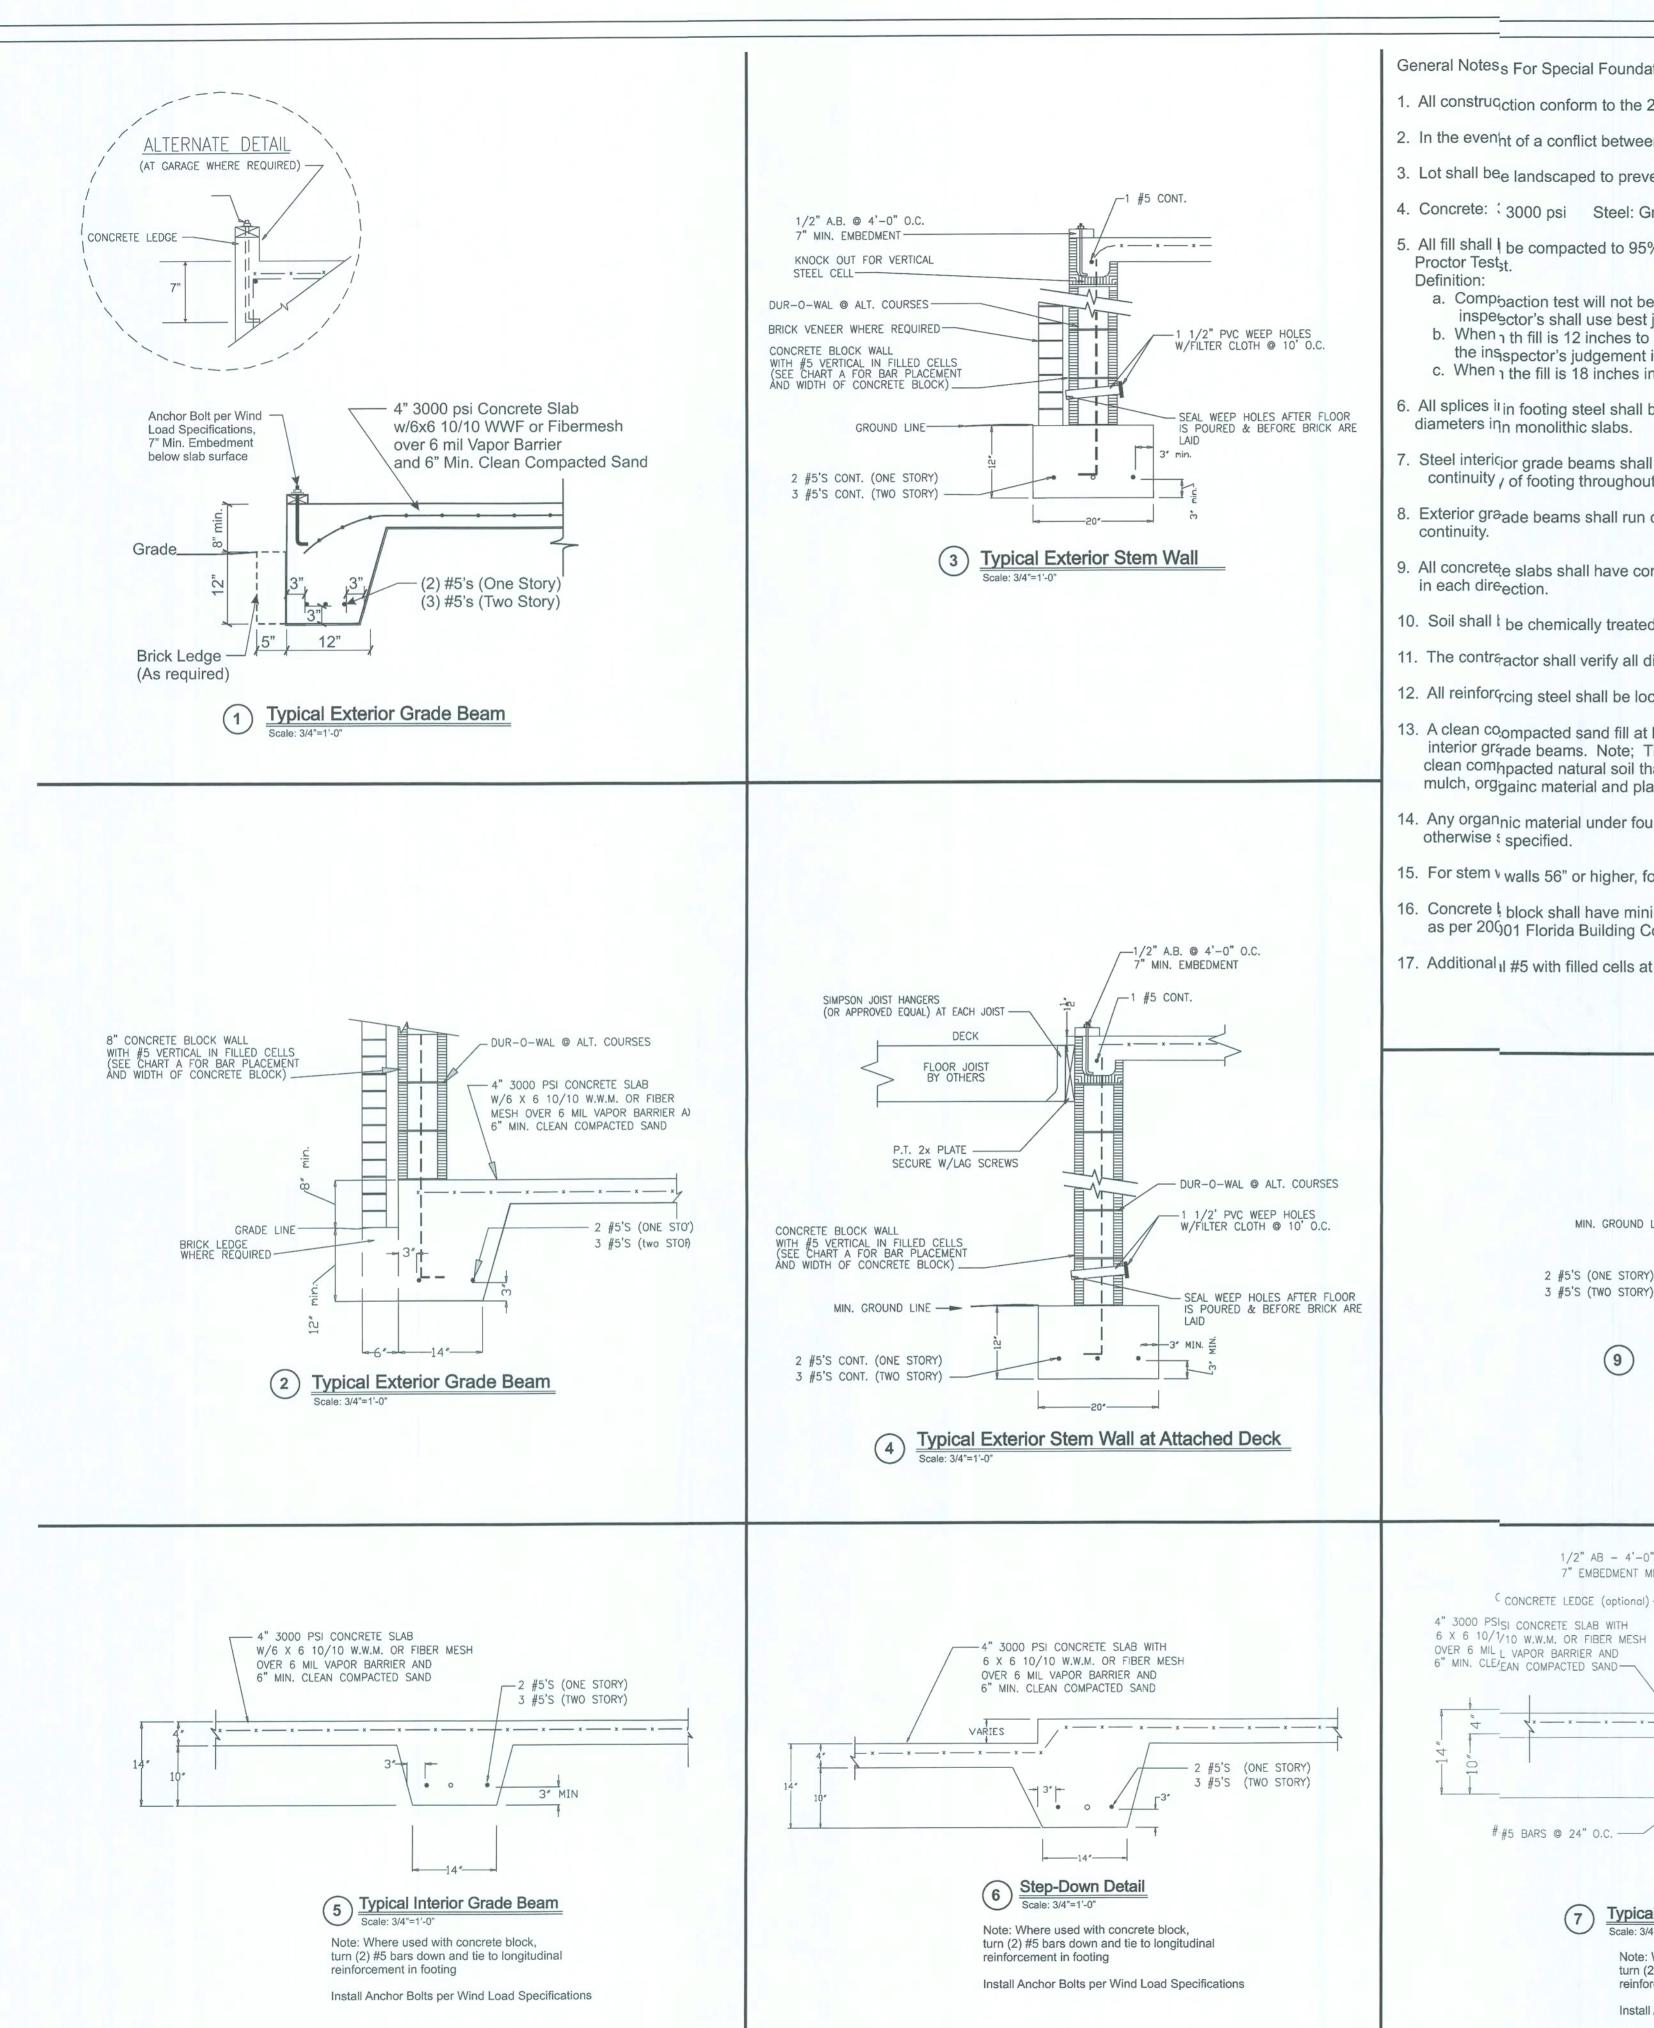

## General Notes<sub>S</sub> For Special Foundation


- 1. All construction conform to the 2004 Florida Building Code with 2006 revisions.
- 2. In the even'nt of a conflict between plans and the codes, the codes shall govern.
- 3. Lot shall bee landscaped to prevent the detention of surface water.
- 4. Concrete: 3000 psi Steel: Grade 60
- 5. All fill shall be compacted to 95% of maximum dry density as determined by the Modified Proctor Testat Definition:
- a. Composition test will not be required when the fill is less than 12 inches in depth, the inspector's shall use best judgement.
- b. When the fill is 12 inches to 18 inches in depth, compaction test will be required only if
- the inspector's judgement is that the compaction is questionable. c. When 1 the fill is 18 inches in depth or more, compaction test will be required.
- . All splices it in footing steel shall be lapped 40 bar diameters in concrete block and 30 bar diameters in monolithic slabs.
- . Steel intericior grade beams shall be spliced to steel in exterior grade beams to assure continuity , of footing throughout structure.
- . Exterior graade beams shall run continuous around the perimeter of the structure to assure continuity.
- . All concrete slabs shall have control joints to control cracking spaced maximum of 15 feet in each direction.
- 10. Soil shall be chemically treated for termites.
- 11. The contractor shall verify all dimensions at the site prior to beginning construction.
- 12. All reinforçcing steel shall be located ma min. 3" from concrete surface.
- 13. A clean compacted sand fill at least 18 inches thick shall be placed under all exterior and interior grade beams. Note; This may be omitted in areas that have at least 30 inches of clean comhpacted natural soil that has minimum bearing capacity of 2000 psf and is free of mulch, orggainc material and plastic clays and consist of at least 50% sand (ext.)
- 14. Any organnic material under foundation shall be removed prior to construction, unless otherwise specified.
- 15. For stem v walls 56" or higher, formwork shall be braced before backfilling.
- 16. Concrete block shall have minimum compressive strength of 1500 psi (Grade N-1 or better) as per 20001 Florida Building Code Table 2106.2.
- 17. Additional il #5 with filled cells at load bearing points on walls.

1/2" AB - 4'-0" O.C.

CONCRETE LEDGE (optional) -

# #5 BARS @ 24" O.C. -

7" EMBEDMENT MINIMUM

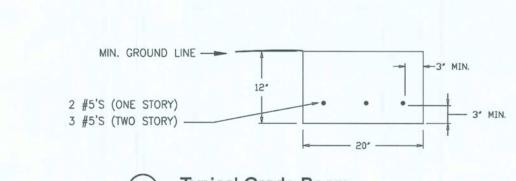

Typical Interior Grade Beam With Optional Curb

Note: Where used with concrete block,

reinforcement in footing

turn (2) #5 bars down and tie to longitudinal

Install Anchor Bolts per Wind Load Specifications

- 2 #5'S (ONE STORY)

3 #5'S (TWO STORY)

#### **CHART A** VERTICAL BAR PLACEMENT FOR **BLOCK WALL WITH CONCRETE FLOOR SLAB OR JOIST DESIGN**

For floor joist design use bond beam with (1) #5 reinforced bar continuous for slab floor, pour into block with welded wire mesh. (See chart below)

\*\*In all cases vertical bars shall be placed at either side of openings in wall and at each corner. Vertical bars shall be bent 24" into slab, each reinforced cell shall be filled with concrete.\*\*


#### \*\*\*Floor system to be placed before backfilling

H (Height of wall)	Width of Block	Vertical Bar Spacing
H <= 32"	8"	No. 5 @ 72" O.C.
32 < H <= 56	8"	No. 5 @ 48" O.C.
56 < H <= 72	8"	No. 5 @ 32" O.C.
72 < H <= 88	12"	No. 5 @ 32" O.C. with bond beam with (1) #5 at mid-height
	8"*	No. 5 @ 32" O.C. *(8" block may be used only if neither side of wall has soil bearing pressure. A bond beam with (1) #5 shall be provided at mid-height.
88 < H <= 120	12"	No. 5 @ 24" O.C. with bond beam with (1) #5 at mid-height
	8"*	No. 5 @ 24" O.C.  *(8" block may be used only if neither side of wall has soil bearing pressure. A bond beam with (1) #5 shall be provided at mid-height.
96 < H <= 120	12"	No. 5 @ 16" O.C. (All cells filled with 3000 psi concrete) with bond beam with (1) #5 at mid-height
	8"*	No. 5 @ 24" O.C.  *(8" block may be used only if neither side of wall has soil bearing pressure. A bond beam with (1) #5 shall be provided at mid-height.
120 < H <= 132	12"	No. 5 @ 8" O.C. (All cells filled with 3000 psi concrete) with bond beam with (1) #5 at mid-height
	8"*	No. 5 @ 24" O.C.  *(8" block may be used only if neither side of wall has soil bearing pressure. A bond beam with (1) #5 shall be provided at mid-height.


#### **CHART B** PHYSICAL PROPERTIES OF MASONRY CEMENTS

Masonry Cement Type	N	*S	*M
Time of setting Initial set, minimum, hr.	2	1 1/2	1 1/2
Final set, maximum, hr.	24	24	24
Compressive strength			
(average of 3 cubes, min.)			
7 days, (psi)	500	1300	1800
28 days (psi)	900	2100	2900

\*For the purpose of these plans, use grade "S" or "M"

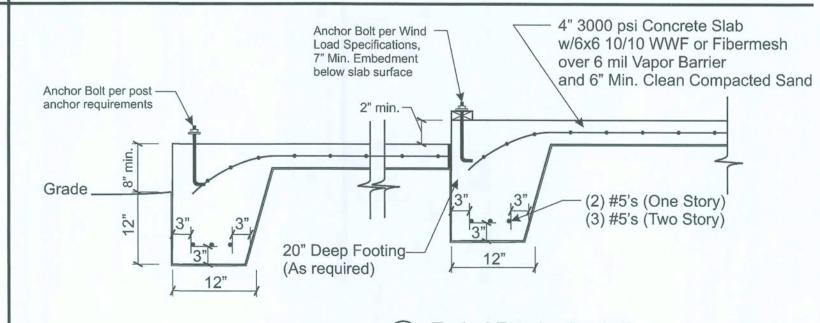

Typical Exterior Grade Beam

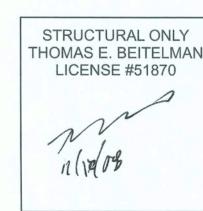


No. 08S-71


# ngi Engin -20

Ft. White, FL CLIENT:

Homes SCA


Sheet S3 of 4

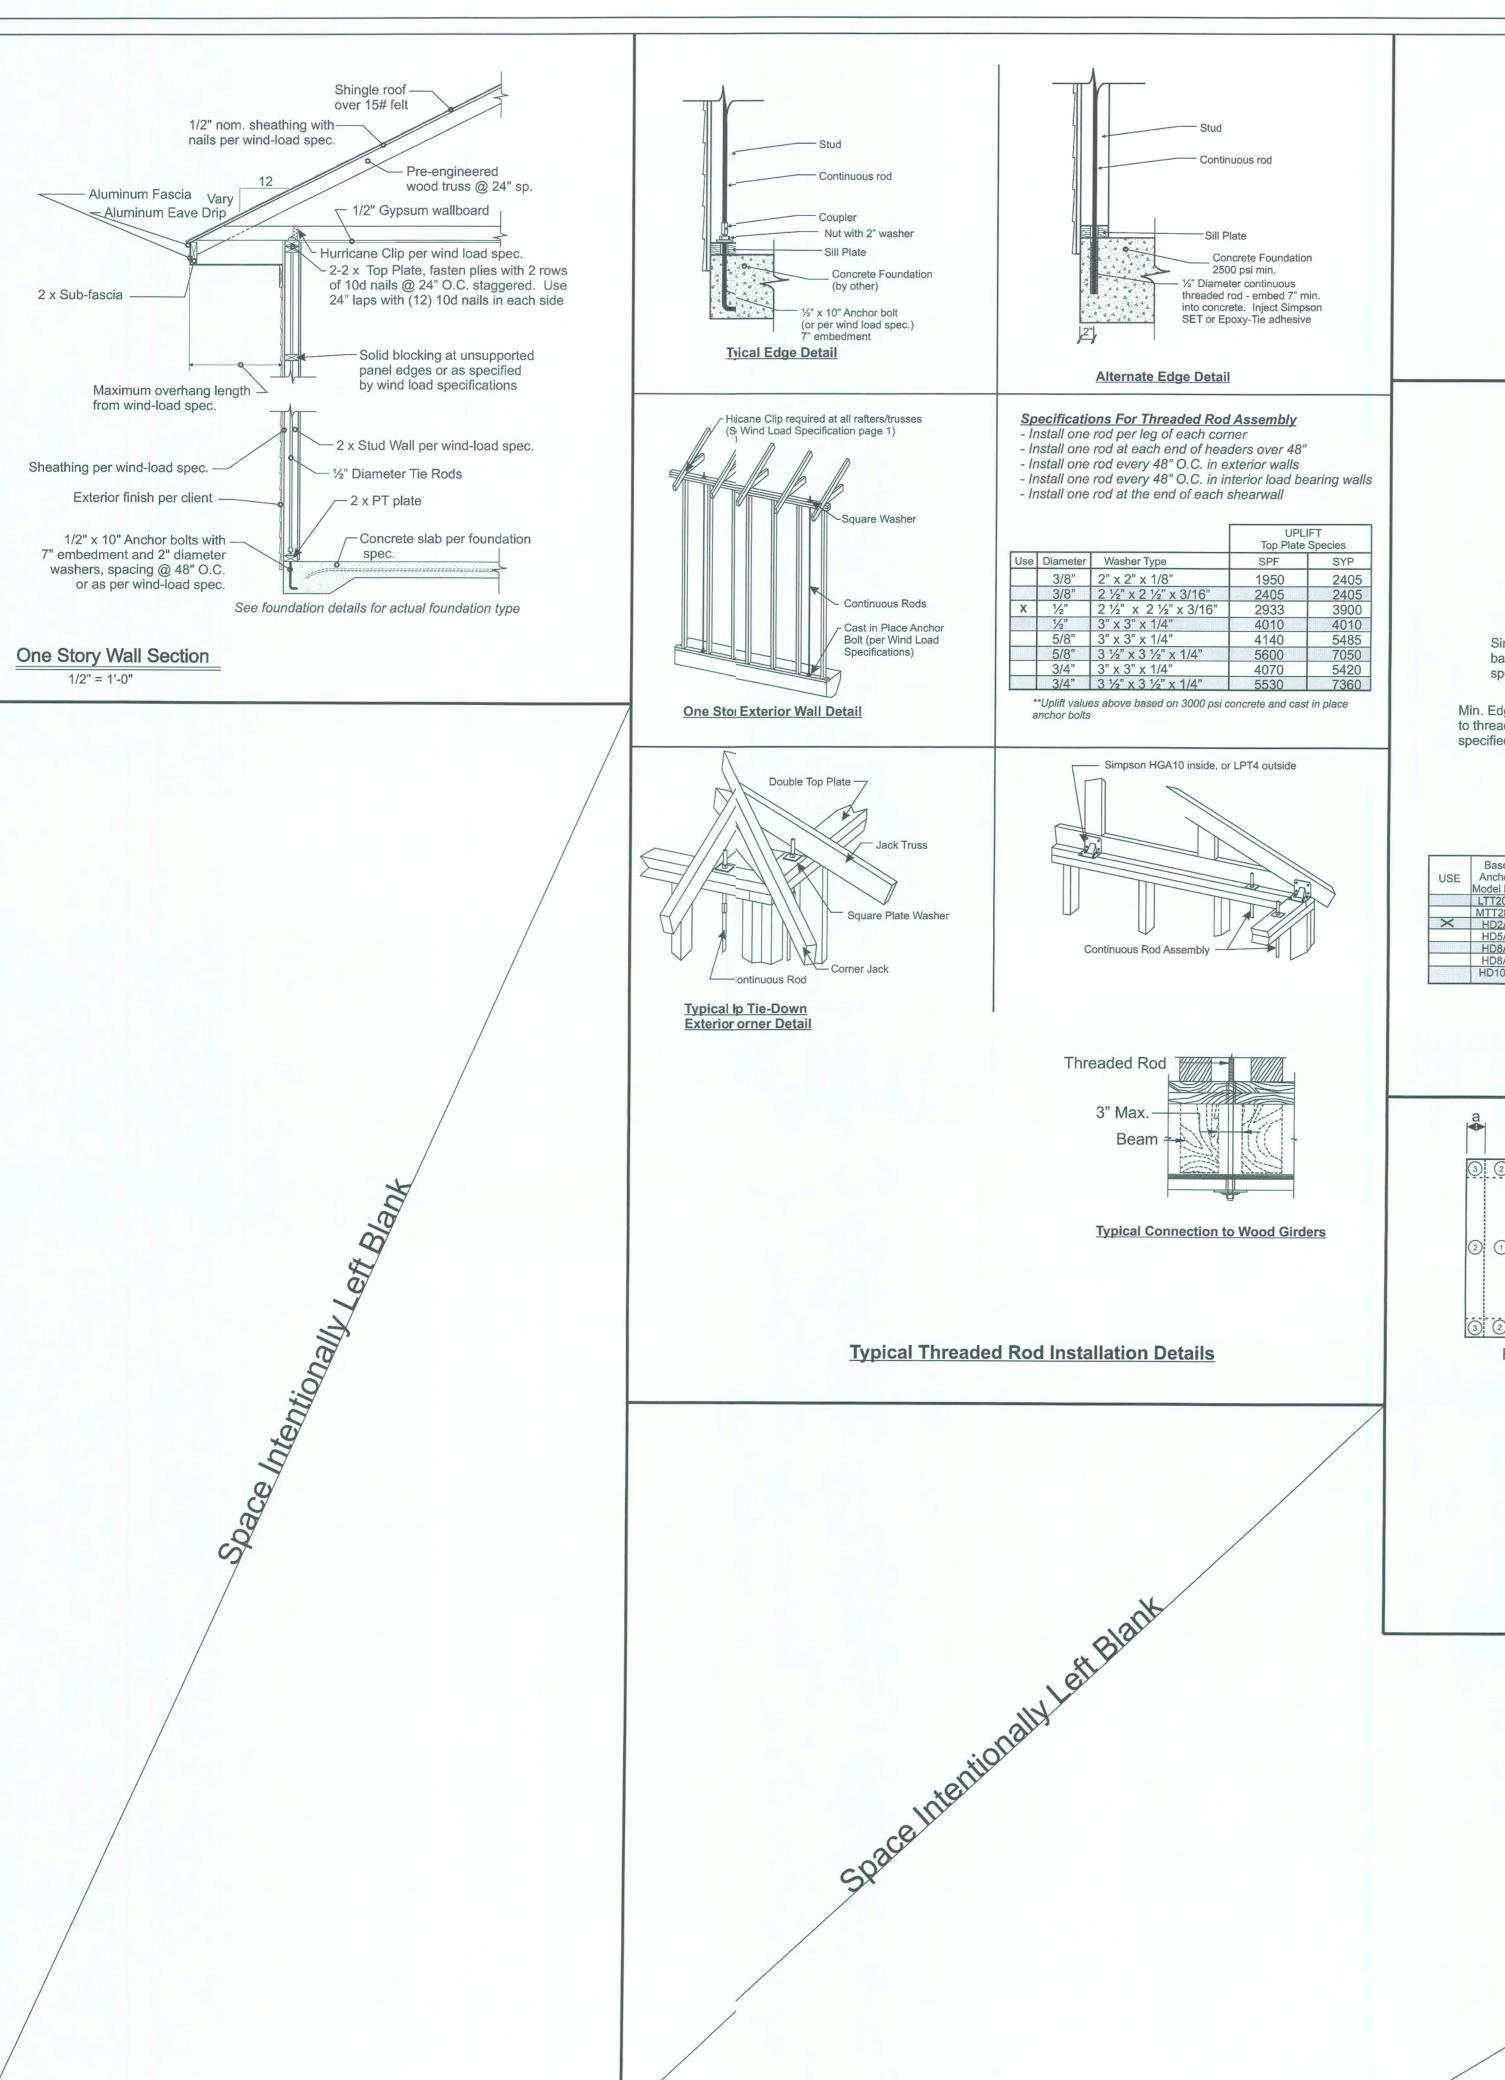

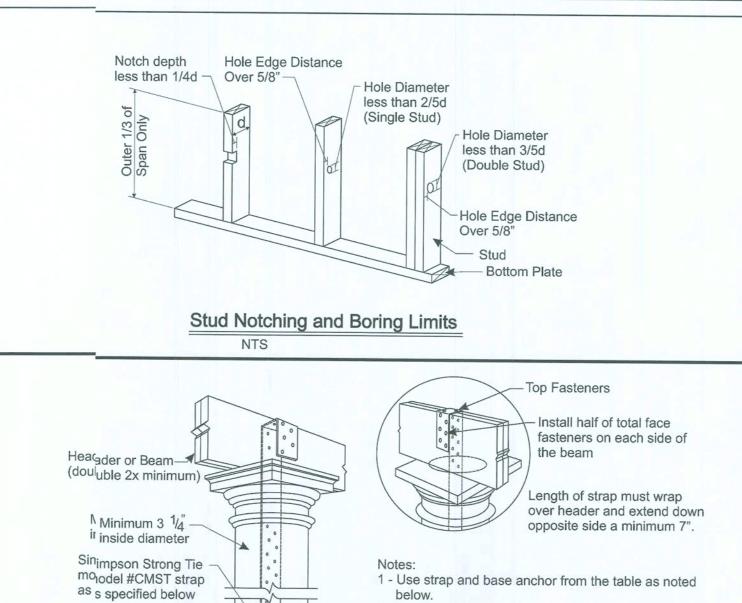

2 - In cases where anchor rod is installed after foundation Simpson h Strong Tie is poured, drill hole to depth noted in table below and base ancichor as use Simpson Epoxy-Tie. specified | below 3 - Overlap CMST strap with strap of base anchor with 1 1/2" additional overlap, as shown. 4 - Drill strap bolt holes size and quantity as specified Min. Edge distatance to threaded rod<sub>id</sub> as in table below. specified beloww 5 - Set column in place, and pull strap taut. While strap is held taut, fasten strap to beam with fasteners as specified in table below. Min. End distance to threaded rod as specified below

HD5A 5/8 g or 3/4 7/8 6 3/4 8 3/4 10 1/8 4 CMST14 2 3/4 13/16 8-10d 2-10d 3375 4010 HD8A 7 7/8 1 7 3/4 9 3/4 11 5/8 6 CMST14 3 7/8 15/16 8-10d 2-10d 3430 4435 HD8A 7 7/8 1 7 3/4 9 3/4 11 5/8 6 CMST12 3 7/8 15/16 10-10d 2-10d 4865 6305 HD10A 7 7/8 1 7 3/4 9 3/4 11 5/8 6 CMST12 4 7/8 15/16 10-10d 2-10d 4865 6305 Hollow Post Uplift Connection - Conventional Strapping

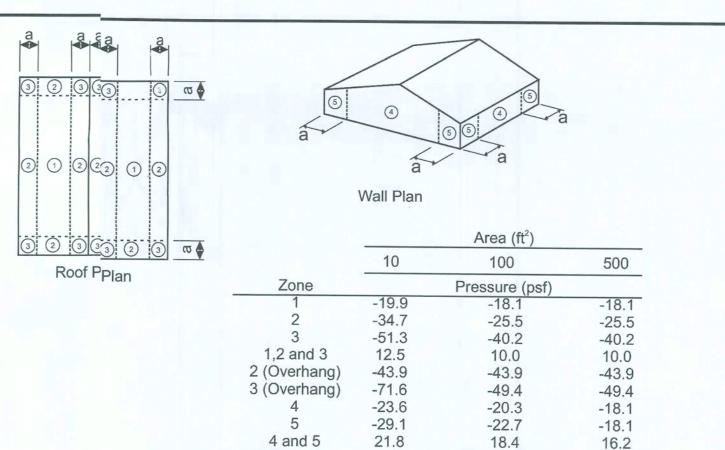

Component and Cladding Design Pressures
(Worst Case Only)

WIND ANALYSIS - 110 MPH, 3 Second Gust Wind Velocity

Calculations as per Section 1609, FBC 2004 with 2006 revisions, ASCE 7-02, or as per ASCE 7-02 (see instructions below) Design Professional FL Lic. #: Importance factor: 1 Building Category: Internal Pressure Coefficient: 0.13 Wind Exposure (s): Plans may be used as a master plan by the above contractor: Yes or No (circle one) Mean Roof Height: Stud Species: SPF or SYP Species for Top Plate: SPF or SYP Max. Stud Ht. (excluding gable end): End Zone Length: Stud Spacing: Roof Slope: Max. Overhang Length (excluding porches): HURRICANE CLIPS (HC) Model # @ End Model # @ Brand: Truss Span or Location Zone Interior Zone 1 - H2.5A

\*\*Note: Truss package was not available at time of analysis, hurricane clip sizes above are based on assumed common framed hip roof!! ROOF SHEATHING MATERIAL: Fastener 8d Ring-Shank NAILING 7/16" OSB Sheathing 100% continuous or as required: See Note 1, below. PATTERN: ANCHOR BOLTS: 1/2" dia. X 10" LONG w/2" washers From Each Corner

#### Wind Load Analysis Results

#### **First Story Level**

Wall Number	Length (ft)	Unit Shear (plf)	Capacity (lbs)	Actual Load (lbs)	% Used	Location
		Lc	ongitudinal Wal	lls		
1	28.2	99.6	8399.3	2805.0	33.4	Exterior
2	27.0	100.5	8051.4	2713.9	33.7	Exterior
		T	ransverse Wall	S		
3	24.0	159.1	7156.8	3818.6	53.4	Exterior
4	21.3	160.2	6361.6	3416.6	53.7	Exterior

#### Wall Bracing Panel Specifications:

P	anel Code:	Shear Walls
	Stud Spacing	16" O.C.
9	Exterior Panel Grade	OSB Sheathing
Face	Minimum Panel Thickness (inch)	7/16
Outside	Minimum Nail Penetration in Framin	g (indh) 1/2
nts	Nail Type	8d common
$^{\circ}$	Edge Nail Spacing	6"
	Intermediate Nail Spacing	12"
	Interior Panel Grade	Gypsum Wallboard
Face	Thickness of Material	1/2"
E E	Wall Construction	Unblocked
Inside	Nail Spacing - Edge	7" O.C.
Ë	Nail Spacing - Intermediate	12" O.C.
	Minimum Nail Size	5d cooler or wallboard
	Total Panel Shear Capacity	298.2 nlf

#### General Notes: PLEASE READ!

- 1 Roof sheathing will be a minimum of 7/16" in thickness with a nailing pattern specified on page 1.
- 2 Exterior wall sheathing will be a minimum of 7/16" in thickness with the nailing pattern specified above, and locations referenced from the attached sheets.
- 3 All exterior load-bearing and shear walls will have a stud spacing specified at 16" O.C. except as noted below.
- 4 All load bearing and shear walls will be framed with 2 x 4 No. 2 grade SPF studs or better.
- 5 Alternative hurricane clips are acceptable, provided they meet the minimum specification for those specified on
- 6 Bearing wall and shear wall door and window headers are to be 2-2 x 10 SYP with 1/2" CDX fletch for lengths under 6 ft unless otherwise specified on plans..
- 7 Simpson Strong Tie HH4 Header Hanger or equivalent should be provided on bearing wall and shear wall door and window openings over 6 ft.
- 8 Simpson Strong Tie model #HD5A hold downs are acceptable alternatives to the specified PHD2-SPS3.
- 9 4" x 4" Posts will require Simpson Strong Tie Post Bases model #ABU44 or better and double LSTA18 straps on each beam at top.

LICENSE #51870

Sheet S4 of 1 No.

ALE:

ng P.E.

08S-171

STRUCTURAL ONLY THOMAS E. BEITELMAN