



REVISIONS	


SOFTPLAN
ARCHITECTURAL DESIGN SOFTWARE

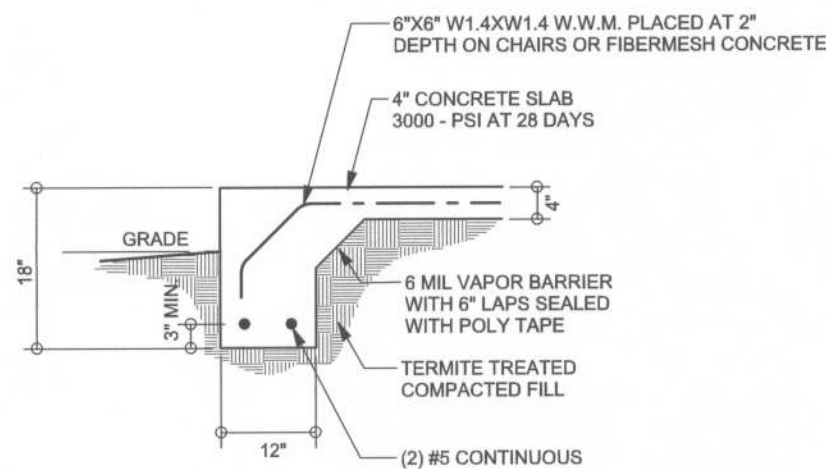


F1 S-2 MONOLITHIC FOOTING
SCALE: 1/2" = 1'-0"

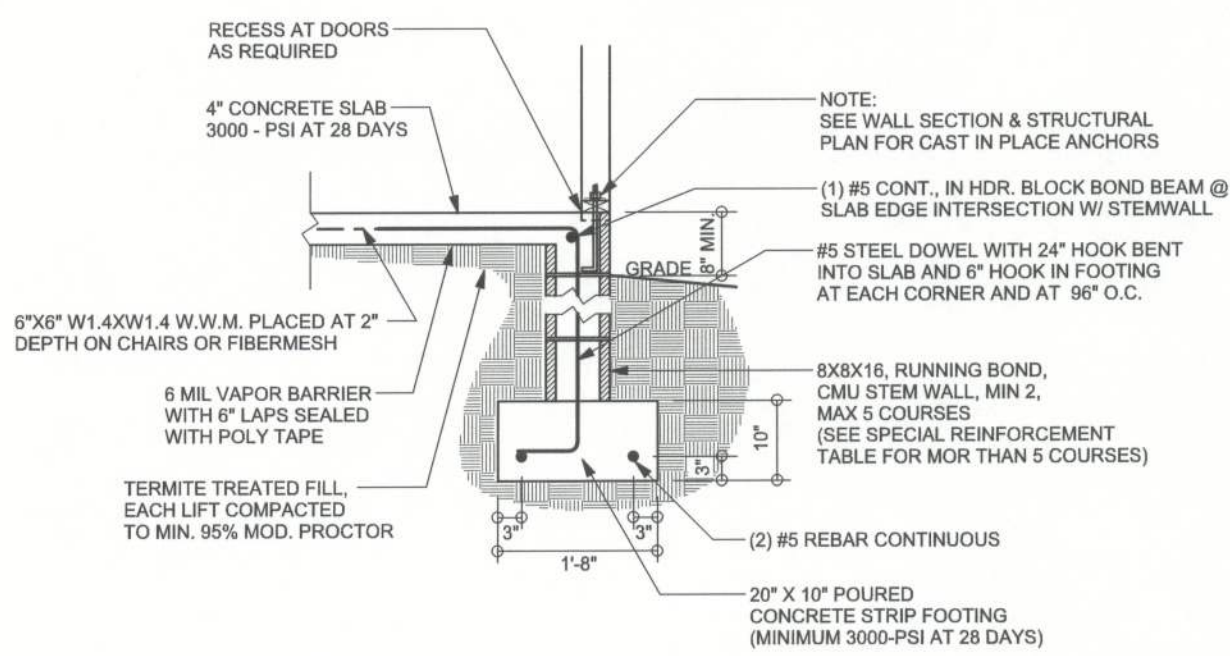


F9 S-2 ALT. STEM WALL FOOTING
SCALE: 1/2" = 1'-0"

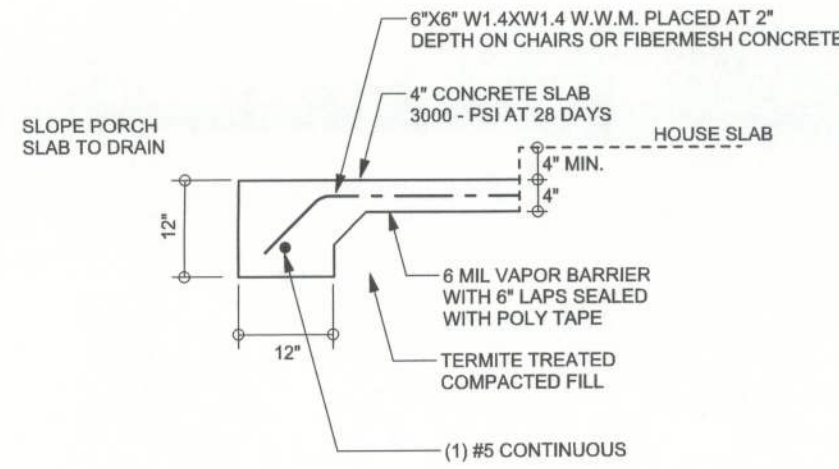


F5 S-2 PORCH FOOTING
SCALE: 1/2" = 1'-0"

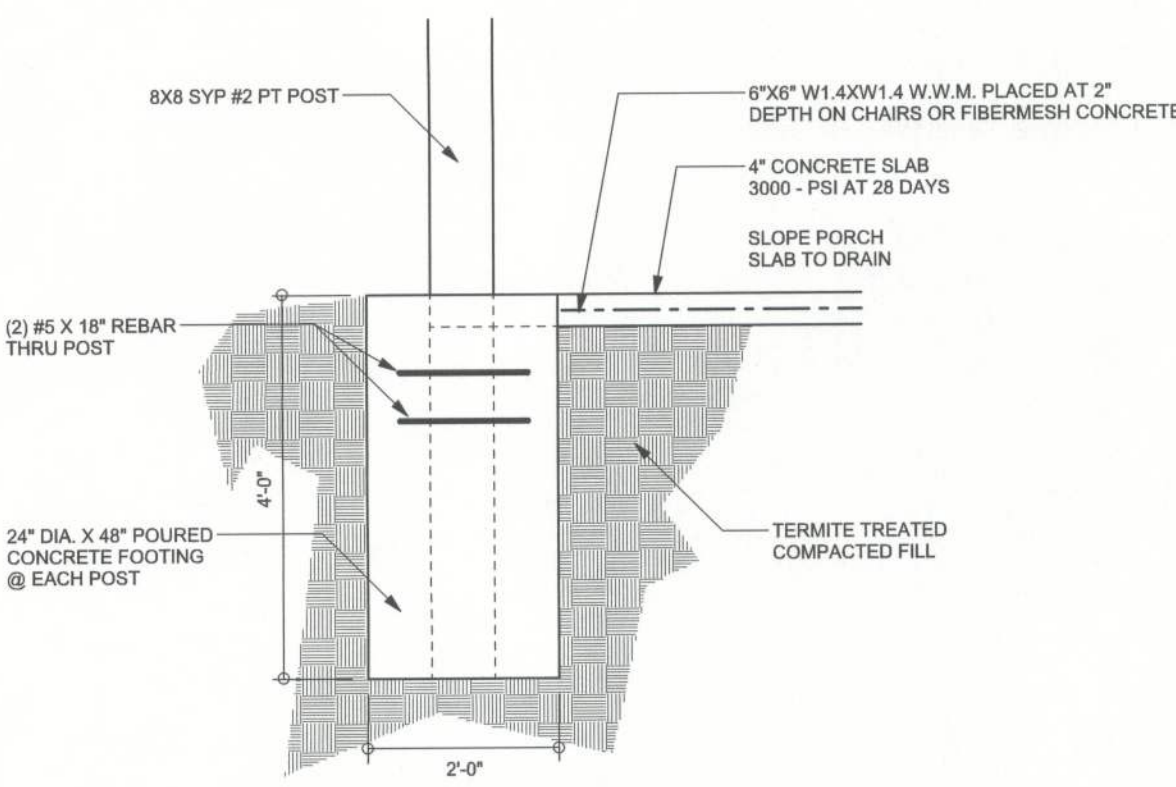

F15 S-2 REAR PORCH POST FOUNDATION
SCALE: 1/2" = 1'-0"

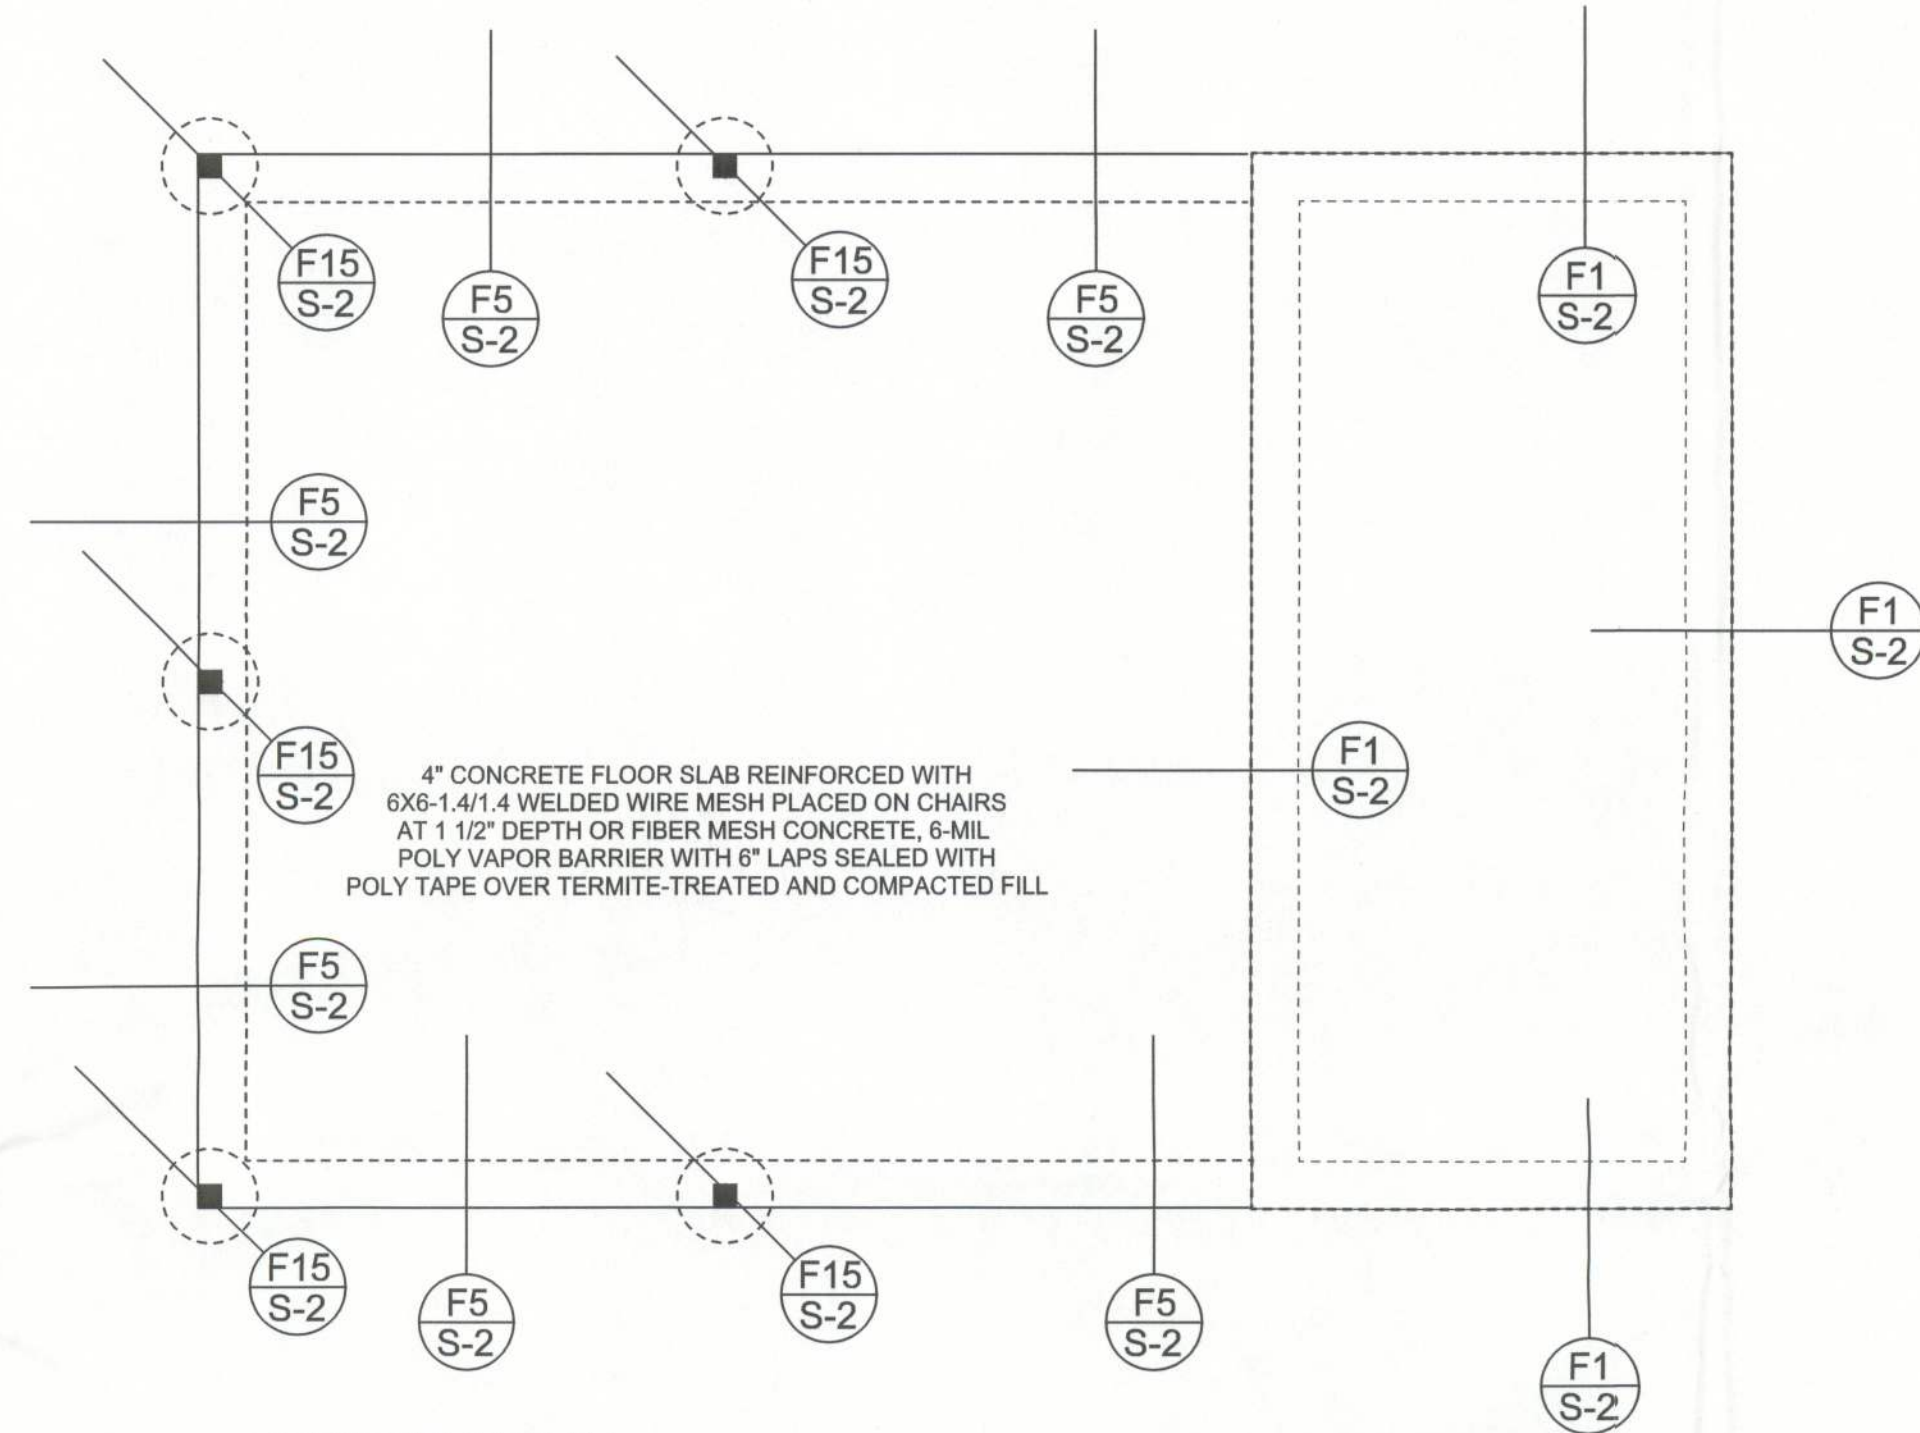

FOUNDATION PLAN
SCALE: 1/4" = 1'-0"
DIMENSIONS ON STRUCTURAL SHEETS
ARE NOT EXACT. REFER TO ARCHITECTURAL
FLOOR PLAN FOR ACTUAL DIMENSIONS

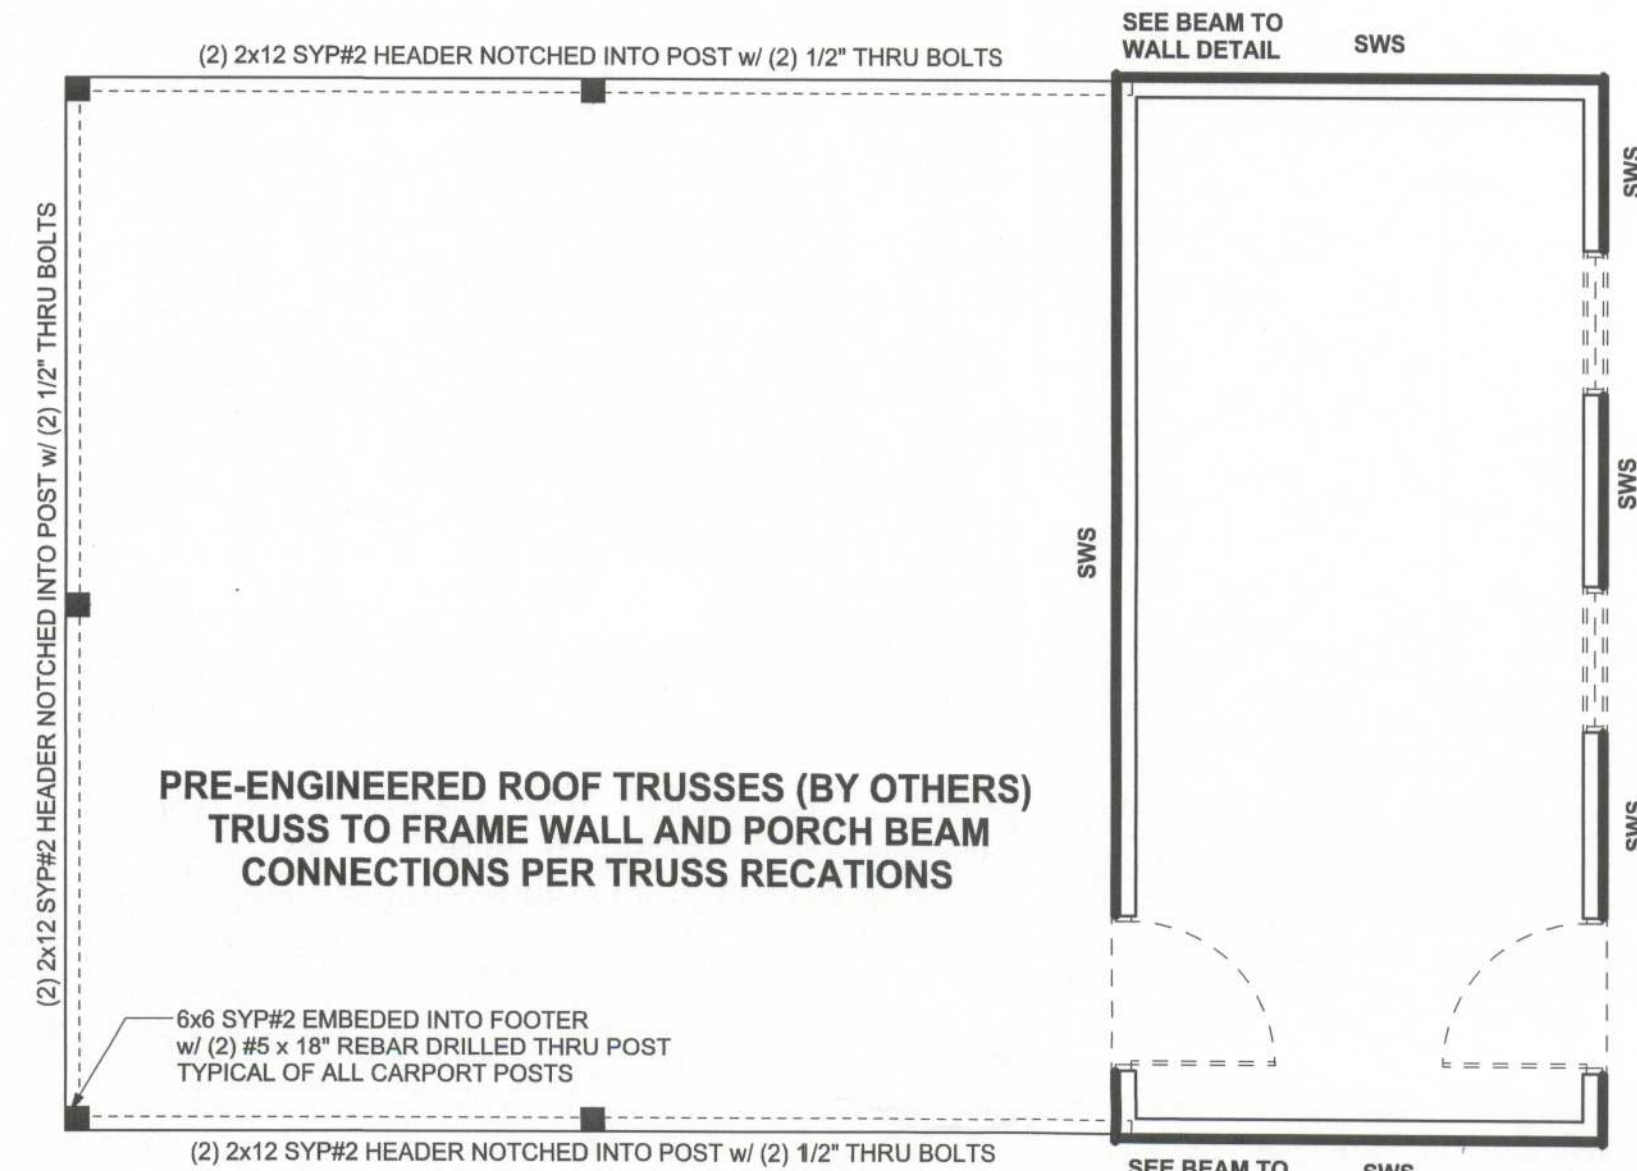

STRUCTURAL PLAN
SCALE: 1/4" = 1'-0"

HEADER LEGEND

(2) 2X10X0' 1J 1K	HEADER/BEAM CALL-OUT (U.N.O.)
---	NUMBER OF KING STUDS (FULL LENGTH)
---	NUMBER OF JACK STUDS (UNDER HEADER)
---	SPAN OF HEADER
---	SIZE OF HEADER MATERIAL
---	NUMBER OF PLIES IN HEADER

WALL LEGEND

	EXTERIOR WALL
	INTERIOR NON-LOAD BEARING WALL
	INTERIOR LOAD BEARING WALL w/ NO UPLIFT
	INTERIOR LOAD BEARING WALL w/ UPLIFT

TOTAL SHEAR WALL SEGMENTS

	REQUIRED	ACTUAL
TRANSVERSE	3538 lb	4032 lb
LONGITUDINAL	2268 lb	3740 lb

STRUCTURAL PLAN NOTES

- SN-1 ALL LOAD BEARING FRAME WALL & PORCH HEADERS SHALL BE A MINIMUM OF (2) 2X6 SPF #2 (U.N.O.)
- SN-2 ALL LOAD BEARING FRAME WALL HEADERS SHALL HAVE (1) JACK STUD & (1) KING STUD EACH SIDE (U.N.O.)
- SN-3 DIMENSIONS ON STRUCTURAL SHEETS ARE NOT EXACT. REFER TO ARCHITECTURAL FLOOR PLAN FOR ACTUAL DIMENSIONS
- SN-4 PERMANENT TRUSS BRACING IS TO BE INSTALLED AT LOCATIONS AS SHOWN ON THE SEALED TRUSS DRAWINGS. LATERAL BRACING IS TO BE RESTRAINED PER BCSI-03, BCSI-B1, BCSI-B2, & BCSI-B3. BCSI-B1, BCSI-B2, & BCSI-B3 ARE FURNISHED BY THE TRUSS SUPPLIER, WITH THE SEALED TRUSS PACKAGE

WINDLOAD ENGINEER: Mark Disoway, P.E. No. 53515, P.O. Box 868, Lake City, FL 32056, 386-754-5419

DIMENSIONS: Stated dimensions supersede scaled dimensions. Refer all questions to Mark Disoway, P.E. for resolution. Do not proceed without clarification.

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CERTIFICATION: I hereby certify that I have examined this plan, and that the applicable portions of the plan, relating to wind engineering comply with section RS101.2.1, Florida building code residential 2007 & 2009 Supplements, to the best of my knowledge.

LIMITATION: This design is valid for one building, at specified location.

MARK DISOWAY
P.E. No. 53515
FLORIDA
REGISTERED PROFESSIONAL ENGINEER
STAMP NO. 53515

Glenwood King Construction

Carolyn Drawdy Carport

ADDRESS:
1587 sw King St.
Columbia County, Florida

Mark Disoway P.E.
P.O. Box 868
Lake City, Florida 32056
Phone: (386) 754 - 5419
Fax: (386) 269 - 4871

PRINTED DATE:
September 03, 2010

DRAWN BY: Evan Beamsley
STRUCTURAL BY: Evan Beamsley

FINALS DATE:
Sept. 3, 2010

JOB NUMBER:
1009006

DRAWING NUMBER
S-2
OF 3 SHEETS