OWNER

MOURAS BLDG. 2

ADDRESS

735 SW STERLING TER. HIGH SPRINGS, FL 32038

CONSTRUCTION DRAWINGS

MOURAS BLDG. 2

HIGH SPRINGS, FL 32038


DESIGNER



1311 W. MARVIN ST. LONGWOOD, FL 32750

(407) 462 - 4489

FRONT ELEVATION

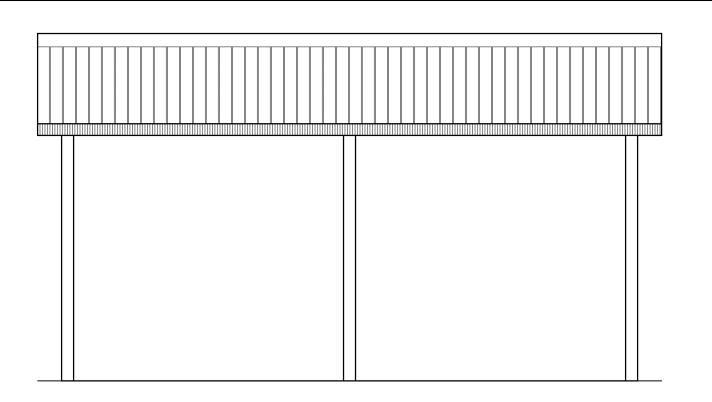

ABBREVIATIONS

	ABOVE ACOUSTICAL CEILING TILE ADJUSTABLE ABOVE FINISHED FLOOR AIR HANDLING UNIT ALUMINUM ANODIZED APPROXIMATE ARCHITECTURAL BOARD BUILDING BLOCK BLOCK BLOCK BEAM BELOW FINISHED FLOOR BOTTOM CEILING CONTROL JOINT CENTER LINE						
BV.	ABOVE	E.J.	EXPANSION JOINT	MAS.	MASONRY MATERIAL MAXIMUM MECHANICAL	R.D.	ROOF DRAIN
CT	ACOUSTICAL CEILING TILE	ELEC.	ELECTRICAL	MATL	MATERIAL	RTU	ROOF TOP UNIT
DJ.	ADJUSTABLE	EL.,ELEV.	ELEVATION	MAX.	MAXIMUM	R.M.	ROOM
.F.F.	ABOVE FINISHED FLOOR	EQUIP.	EQUIPMENT	MECH.	MECHANICAL	R.O.	ROUGH OPENING
HÜ	AIR HANDLING UNIT	EQUIV.	EQUIVALENT	MEP	MECHANICAL MECHANICAL, ELECTRICAL, PLUMBING	S/A	SUPPLY AIR SUSPENDED ACOUSTICAL CEILING
LUM.	ALUMINUM	ESCAL.	ELECTRIC WATER HEATER	MET.	METAL	S.A.C.	SUSPENDED ACOUSTICAL CEILING
NOD.	ANODIZED	E.W.C.	ESCALATOR	MFR.	MANUFACTURER	SAN.	SANITARY
PPROX.	APPROXIMATE	EXT.	EXTERIOR	MIN.	MINIMUM	S.C.	SOLID CORE
RCH.	ARCHITECTURAL	F.C.O.	FLOOR CLEAN OUT	MISC.	METAL MANUFACTURER MINIMUM MISCELLANEOUS MASONRY OPENING	S.F.	SQUARE FOOT
		F.D.	FLOOR DRAIN	M.O.	MASONRY OPENING	SIM.	SIMILAR
D.	BOARD	F.S.	FLOOR SINK	M.S.G.	MANUFACTURER STANDARDS GAGE	JE LU.	SPECIFICATIONS
LDG.	BUILDING	F.E.	FIRE EXTINGUISHER	MTD.	MOUNTED	SPKLR.	SPRINKLER
LK.	BLOCK	F.E.C.	FIRE EXTINGUISHER AND CABINET			SQ.	SQUARE
LKG.	BLOCKING	F.H.C.	FIRE HOSE CABINET	N.I.C.	NOT IN CONTRACT	s/s	STAINLESS STEEL
M.	BEAM	FIN.	FIRE HOSE CABINET FINISH FLOOR FLUORESCENT FOOTING GAUGE GALVANIZED	NONCOM.	NONCOMBUSTIBLE	STRUCT.	SQUARE STAINLESS STEEL STRUCTURAL
.F.F.	BELOW FINISHED FLOOR	FLR.	FLOOR	N.T.S.	NOT TO SCALE	STD.	STANDARD
OT.	BOTTOM	FLOUR.	FLUORESCENT			STL.	STEEL
		FTG.	FOOTING	O.C.	ON CENTER	SUSP	SUSPENDED
LG.	CFILING			O.D.	OVERELOW DRAIN	S&R	SHELF AND ROD
.J.	CONTROL JOINT	GA.	GAUGE	O.H. DR.	OVERHEAD DOOR.		
	CENTER LINE	GALV.	GALVANIZED	OPNG.	OPENING	THK.	THICK
.0.	CLEAN OUT	G.C.	GENERAL CONTRACTOR	3		T.O.S.	TOP OF STEEL
.M.U.	CONCRETE MASONRY UNIT	G.F.I.	GROUND FAULT INTERCEPTOR	PL.	PLATE	T.O.W.	TOP OF WALL
OL.	COLUMN	G.I.	GAI VANIZED IRON	PLAM	PLASTIC LAMINATE	TRD.	TREAD
ONTIN.	CONTINUOUS	GND.	GROUND	PLAS.	PLASTER	TYP.	TYPICAL
ONTR.	CONTRACTOR	GYP.	GYPSUM	PLYWD	PLYWOOD		
ONC.	CONCRETE	J	· · · · · · · · · · · · · · · · · · ·	PNI	PANFI	U.N.O.	UNLESS NOTED OTHERWISE
T	BOTTOM CEILING CONTROL JOINT CENTER LINE CLEAN OUT CONCRETE MASONRY UNIT COLUMN CONTINUOUS CONTRACTOR CONCRETE CERAMIC TILE COLD WATER DOUBLE DEGREE DEPARTMENT DETAIL DIAMETER DIMENSION DOWN DOWN DOWN DOWN DOWN DOWN DOWN SPOUT DRAWING EACH EXTERIOR INSULATION FINISH SYSTEM	HDWD.	HARDWOOD	P.O.B.	MANUFACTURER STANDARDS GAGE MOUNTED NOT IN CONTRACT NONCOMBUSTIBLE NOT TO SCALE ON CENTER OVERFLOW DRAIN OVERHEAD DOOR. OPENING PLATE PLASTIC LAMINATE PLASTER PLYWOOD PANEL POINT OF BEGINNING POLISHED PREFABRICATED POUNDS PER SQUARE FOOT POUNDS PER SQUARE INCH		_
w	COLD WATER	HDWR	HARDWARF	POL	POLISHED	V.C.T.	VINYL COMPOSITION TILE
••		H.C.	HANDICAP	PRFFAR	PREFABRICATED	VERT.	VERTICAL
BL.	DOUBLE .	H.S.	HANDSINK	P.T.	PRESSURE TREATED	VEST.	VESTIBULE
EG.	DEGREE	H.M.	HOLLOW METAL	P.S.F.	POUNDS PER SQUARE FOOT	V.I.F.	VERIFY IN FIELD
EPT.	DEPARTMENT	HOR	HORIZONTAL	P.S.I.	POUNDS PER SQUARE INCH		
ETL.	DETAIL	H P	HIGH POINT	PT	POINT	W/	WITH
AM.	DIAMETER	HR	HOUR	• •		W/O	WITH OUT
M.	DIMENSION	HT.	HEIGHT	OT	OLIARRY THE	W.C.O.	WALL CLEAN OUT
N.	DOWN	HW.	HOT WATER	×1	WOTHER THE	W.C.	WATER CLOSET
R.	DOOR		HOT HATEN	R	RISER	WD.	WOOD
S	DOWN SPOUT	LD	INSIDE DIAMETER	R/A	RETURN AIR	WH	WATER HEATER
WG.	DRAWING	INCAND	INCANDESCENT	REBAR	REINFORCING BAR	WT	WEIGHT
	51.V.11111.V	INSUI	INSULATION	RECEPT	RECEPTACI E	W.W.F.	WELDED WIRE FABRIC
Α.	FACH	1002.	INOULTHOR	RFF	REFERENCE	W.W.M.	WELDED WIRE MESH
n. I.F.S.	EXTERIOR INSULATION FINISH SYSTEM	JAN.	JANITOR	REINE	REINFORCED		/
	EXTENSION INCOLLANDON FINION STOTEM	JST.	JOIST	REQ'D	REQUIRED	YD	YARD /
			GALVANIZED GENERAL CONTRACTOR GROUND FAULT INTERCEPTOR GALVANIZED IRON GROUND GYPSUM HARDWOOD HARDWARE HANDICAP HANDICAP HANDICAP HANDICAV HOLLOW METAL HORIZONTAL HIGH POINT HOUR HEIGHT HOT WATER INSIDE DIAMETER INCANDESCENT INSULATION JANITOR JOIST		POUNDS PER SQUARE FOOT POUNDS PER SQUARE INCH POINT QUARRY TILE RISER RETURN AIR REINFORCING BAR RECEPTACLE REFERENCE REINFORCED REQUIRED		

ARCHITECTURAL SYMBOLS

A-000 INTERIOR ELEVATIONS	(#)	DOOR NUMBER INDICATION
WALL SECTIONS	000	- ROOM NUMBER - ROOM NAME
Building Sections	● 102	EXTERIOR WALL TYPES
DRAWING NO. — EXTERIOR ELEVATIONS SHEET NO.	FEO-	FIRE EXTINGUISHER
1 KEYNOTES	*	WALL / PARTITION TYPE IDENTIFICATION
REVISIONS	EL. 0'-00' AFF. REF. POINT	ELEVATION DATUM POINT
ENLARGED DETAILS OR FLOOR PLAN	FLOOR PLAN	DRAWING TITLE

DRAWINGS INDEX

TITLE	SHEET #	REVISIONS
COVERSHEET	A-00	
SITE PLAN	A-01	
FLOOR PLAN AND ELEVATIONS	A-02	
ROOF FRAMING PLAN	A-03	
BUILDING SECTION	A-04	
DETAILS	DS-01	
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NARRATIVE:

THE PURPOSE OF THESE PLANS IS TO PROVIDE CONSTRUCTION DRAWINGS FOR A WOOD POST FRAME BUILDING.



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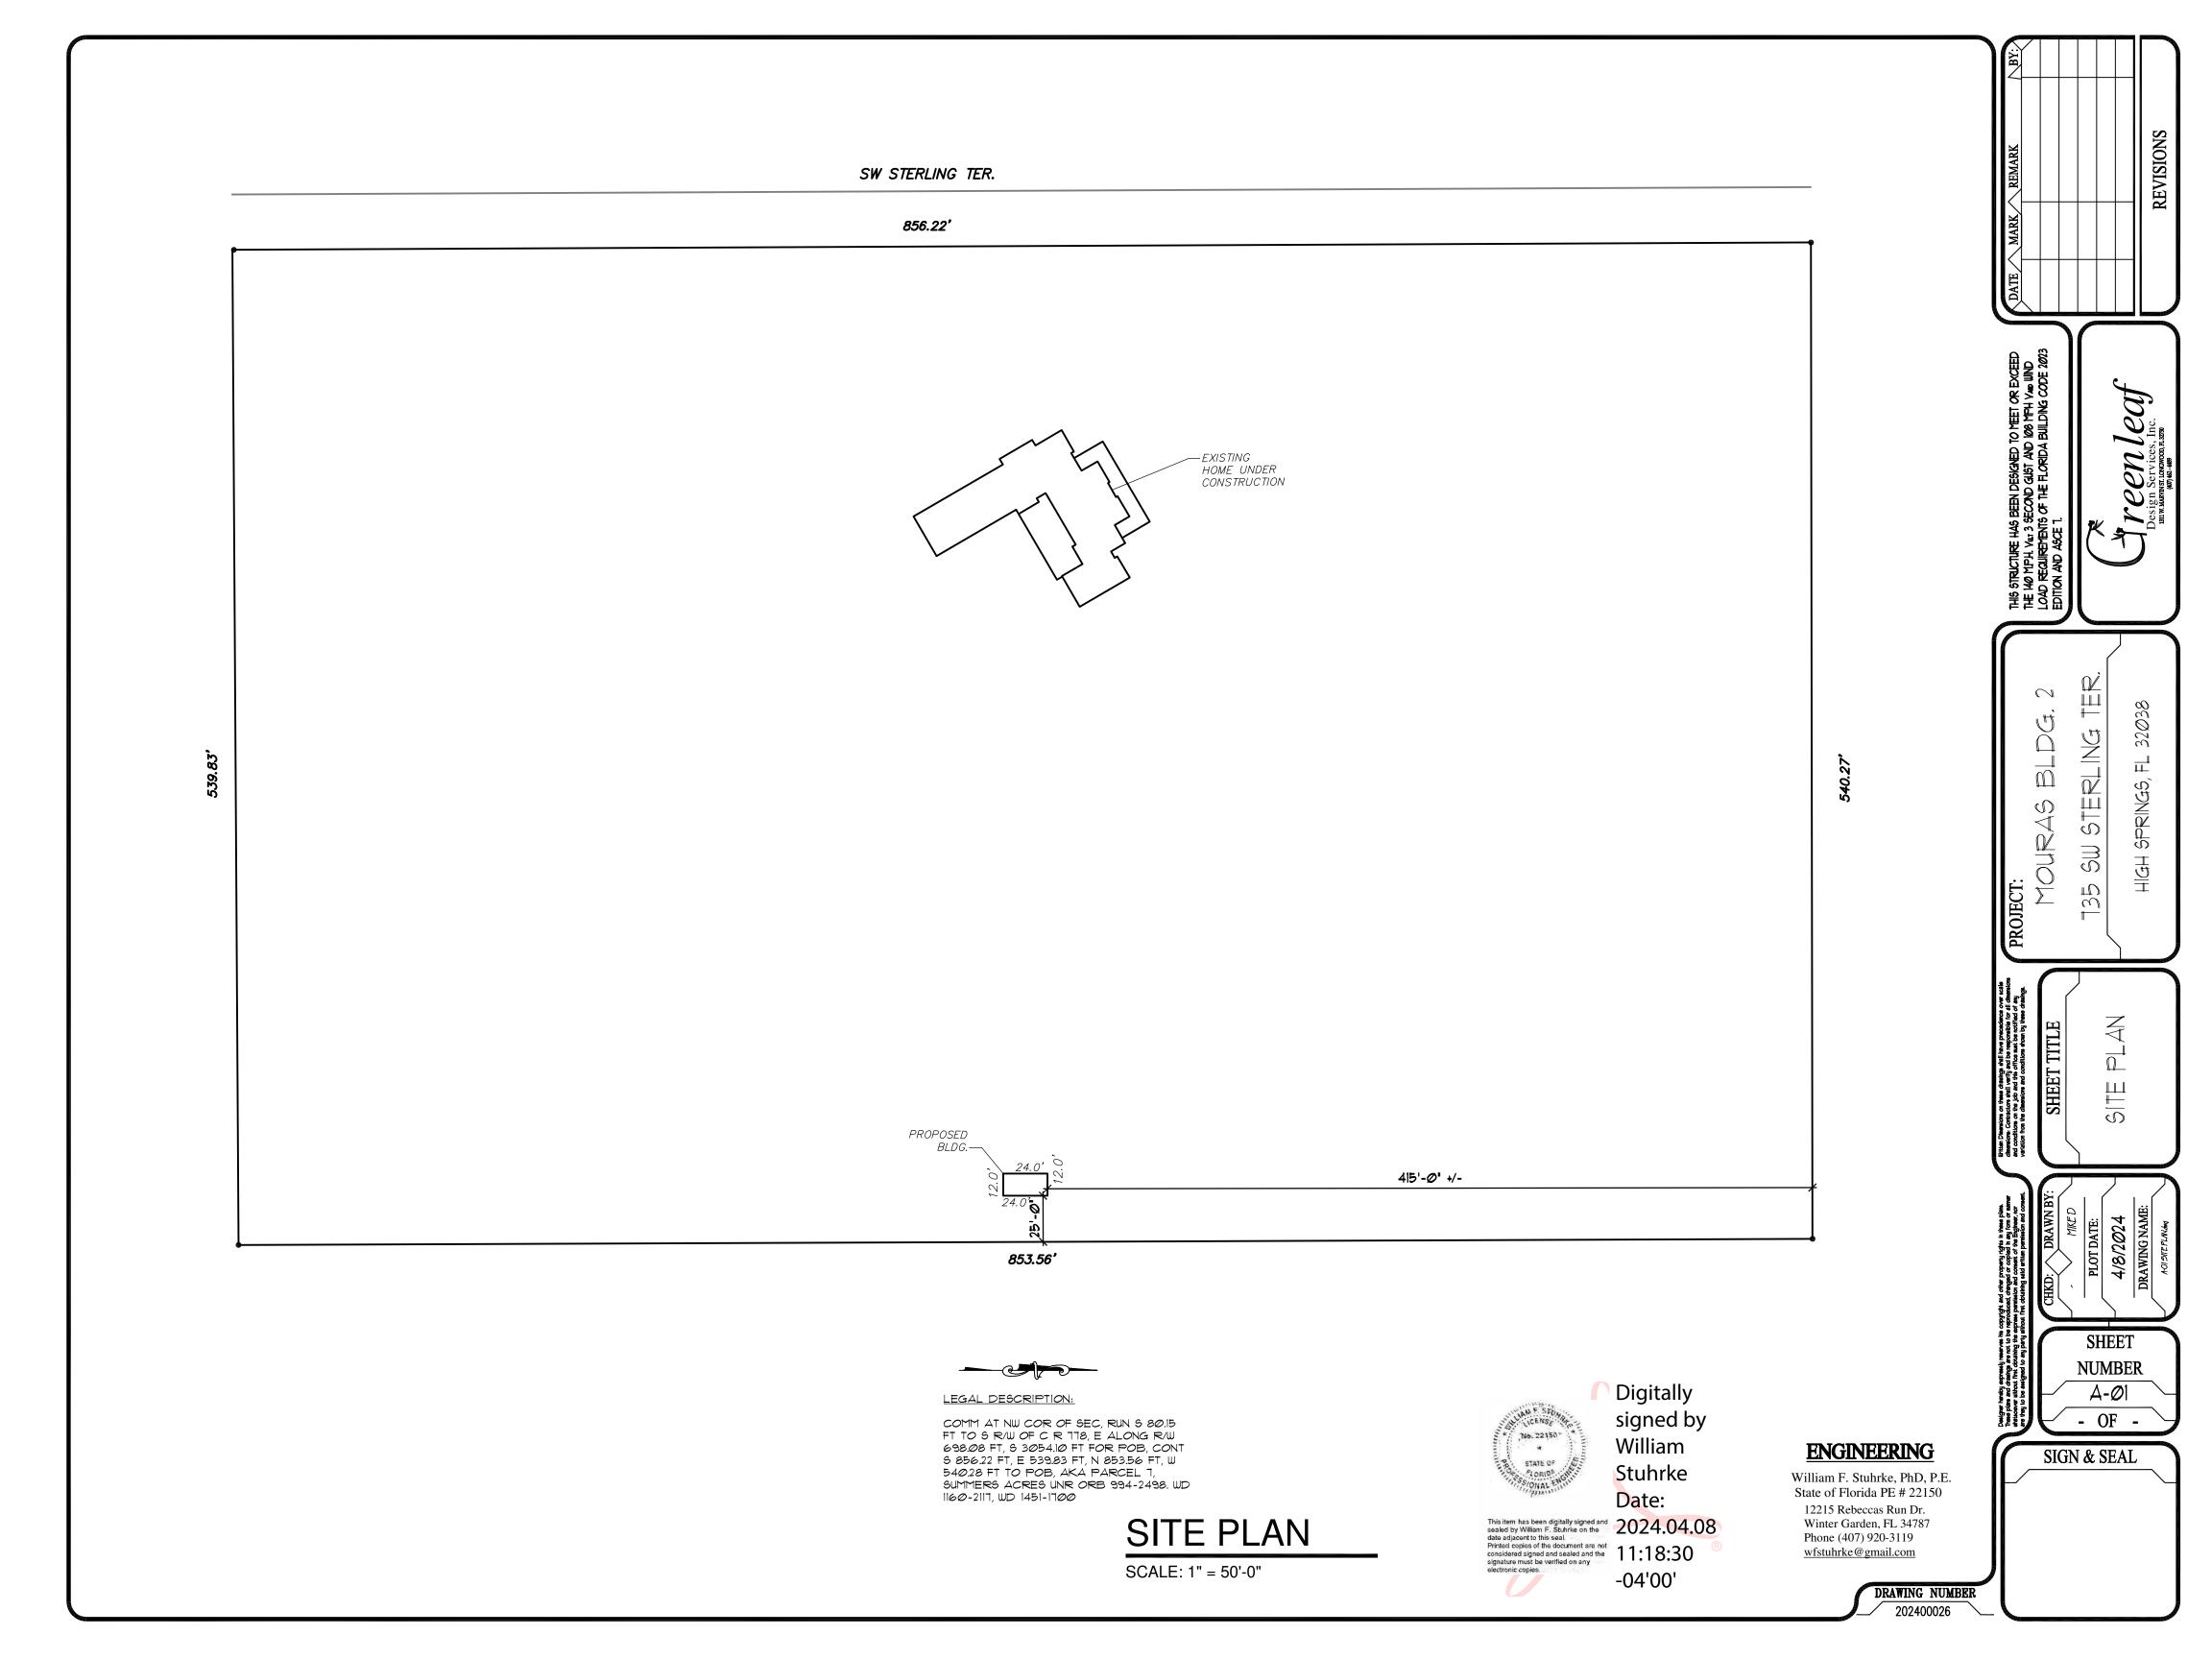
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MOURAS BLDG.


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William F. Stuhrke, PhD, P.E. State of Florida PE # 22150 12215 Rebeccas Run Dr. Winter Garden, FL 34787 Phone (407) 920-3119 wfstuhrke@gmail.com




SCALE: 3/16" = 1'-0"




RIGHT ELEVATION

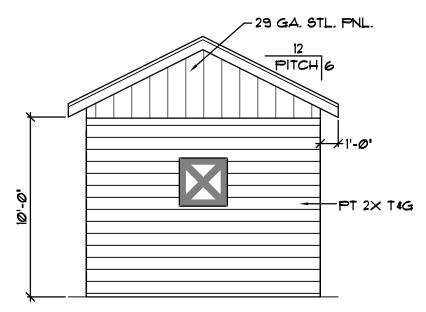SCALE: 3/16" = 1'-0"

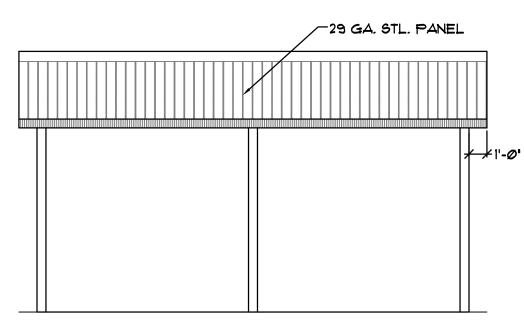

REAR ELEVATION


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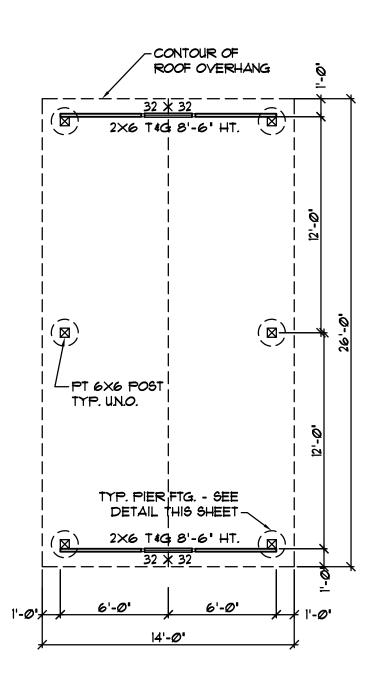
FRONT ELEVATION

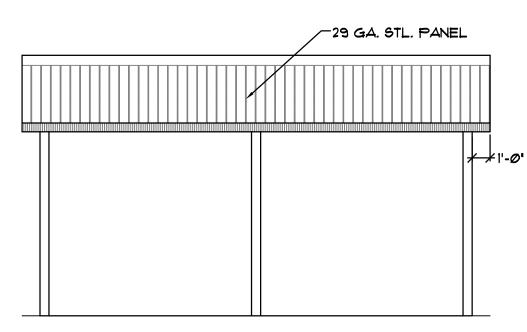SCALE: 3/16" = 1'-0"

NOTE: FOR DOOR AND WINDOW PRESSURE REQUIREMENTS SEE SHEET DS-ØI - "WIND REQUIREMENTS COMPONENTS AND CLADDING"





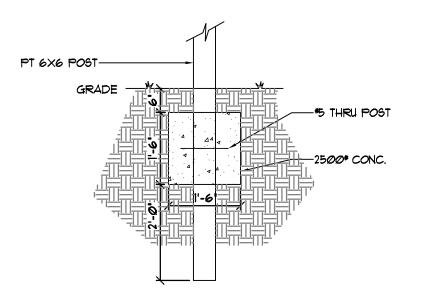



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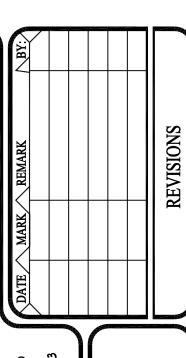
SCALE:3/16" = 1'-0"

FLOOR PLAN

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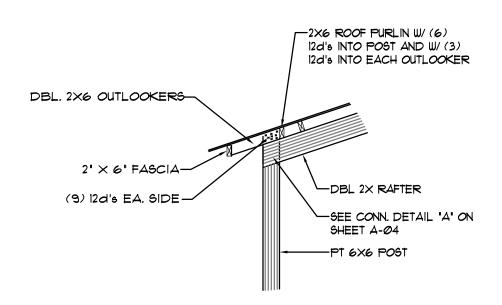


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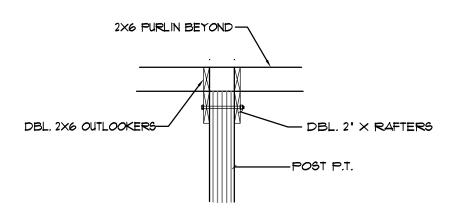
SHEET

NUMBER A-Ø2 - OF -


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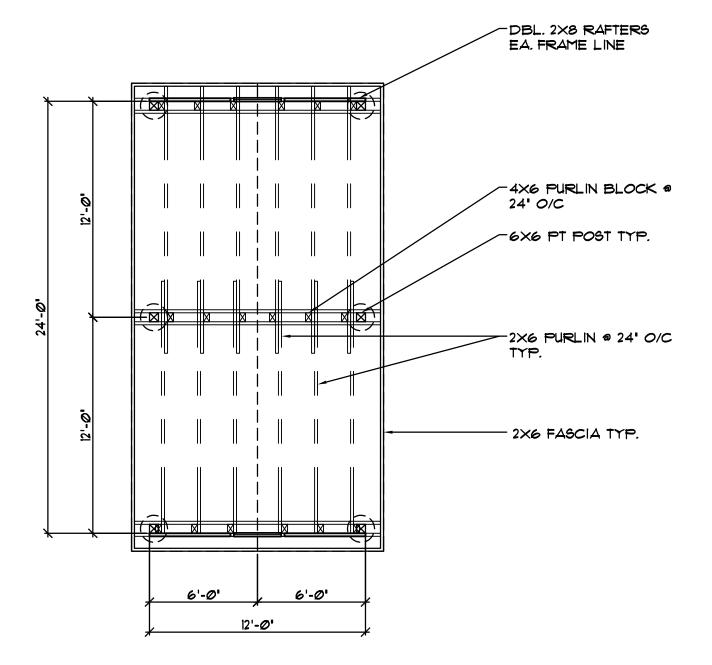
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ROOF FRAMING PLAN

SCALE: 3/16" = 1'-0"

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DRAWING NUMBER

REVISIONS

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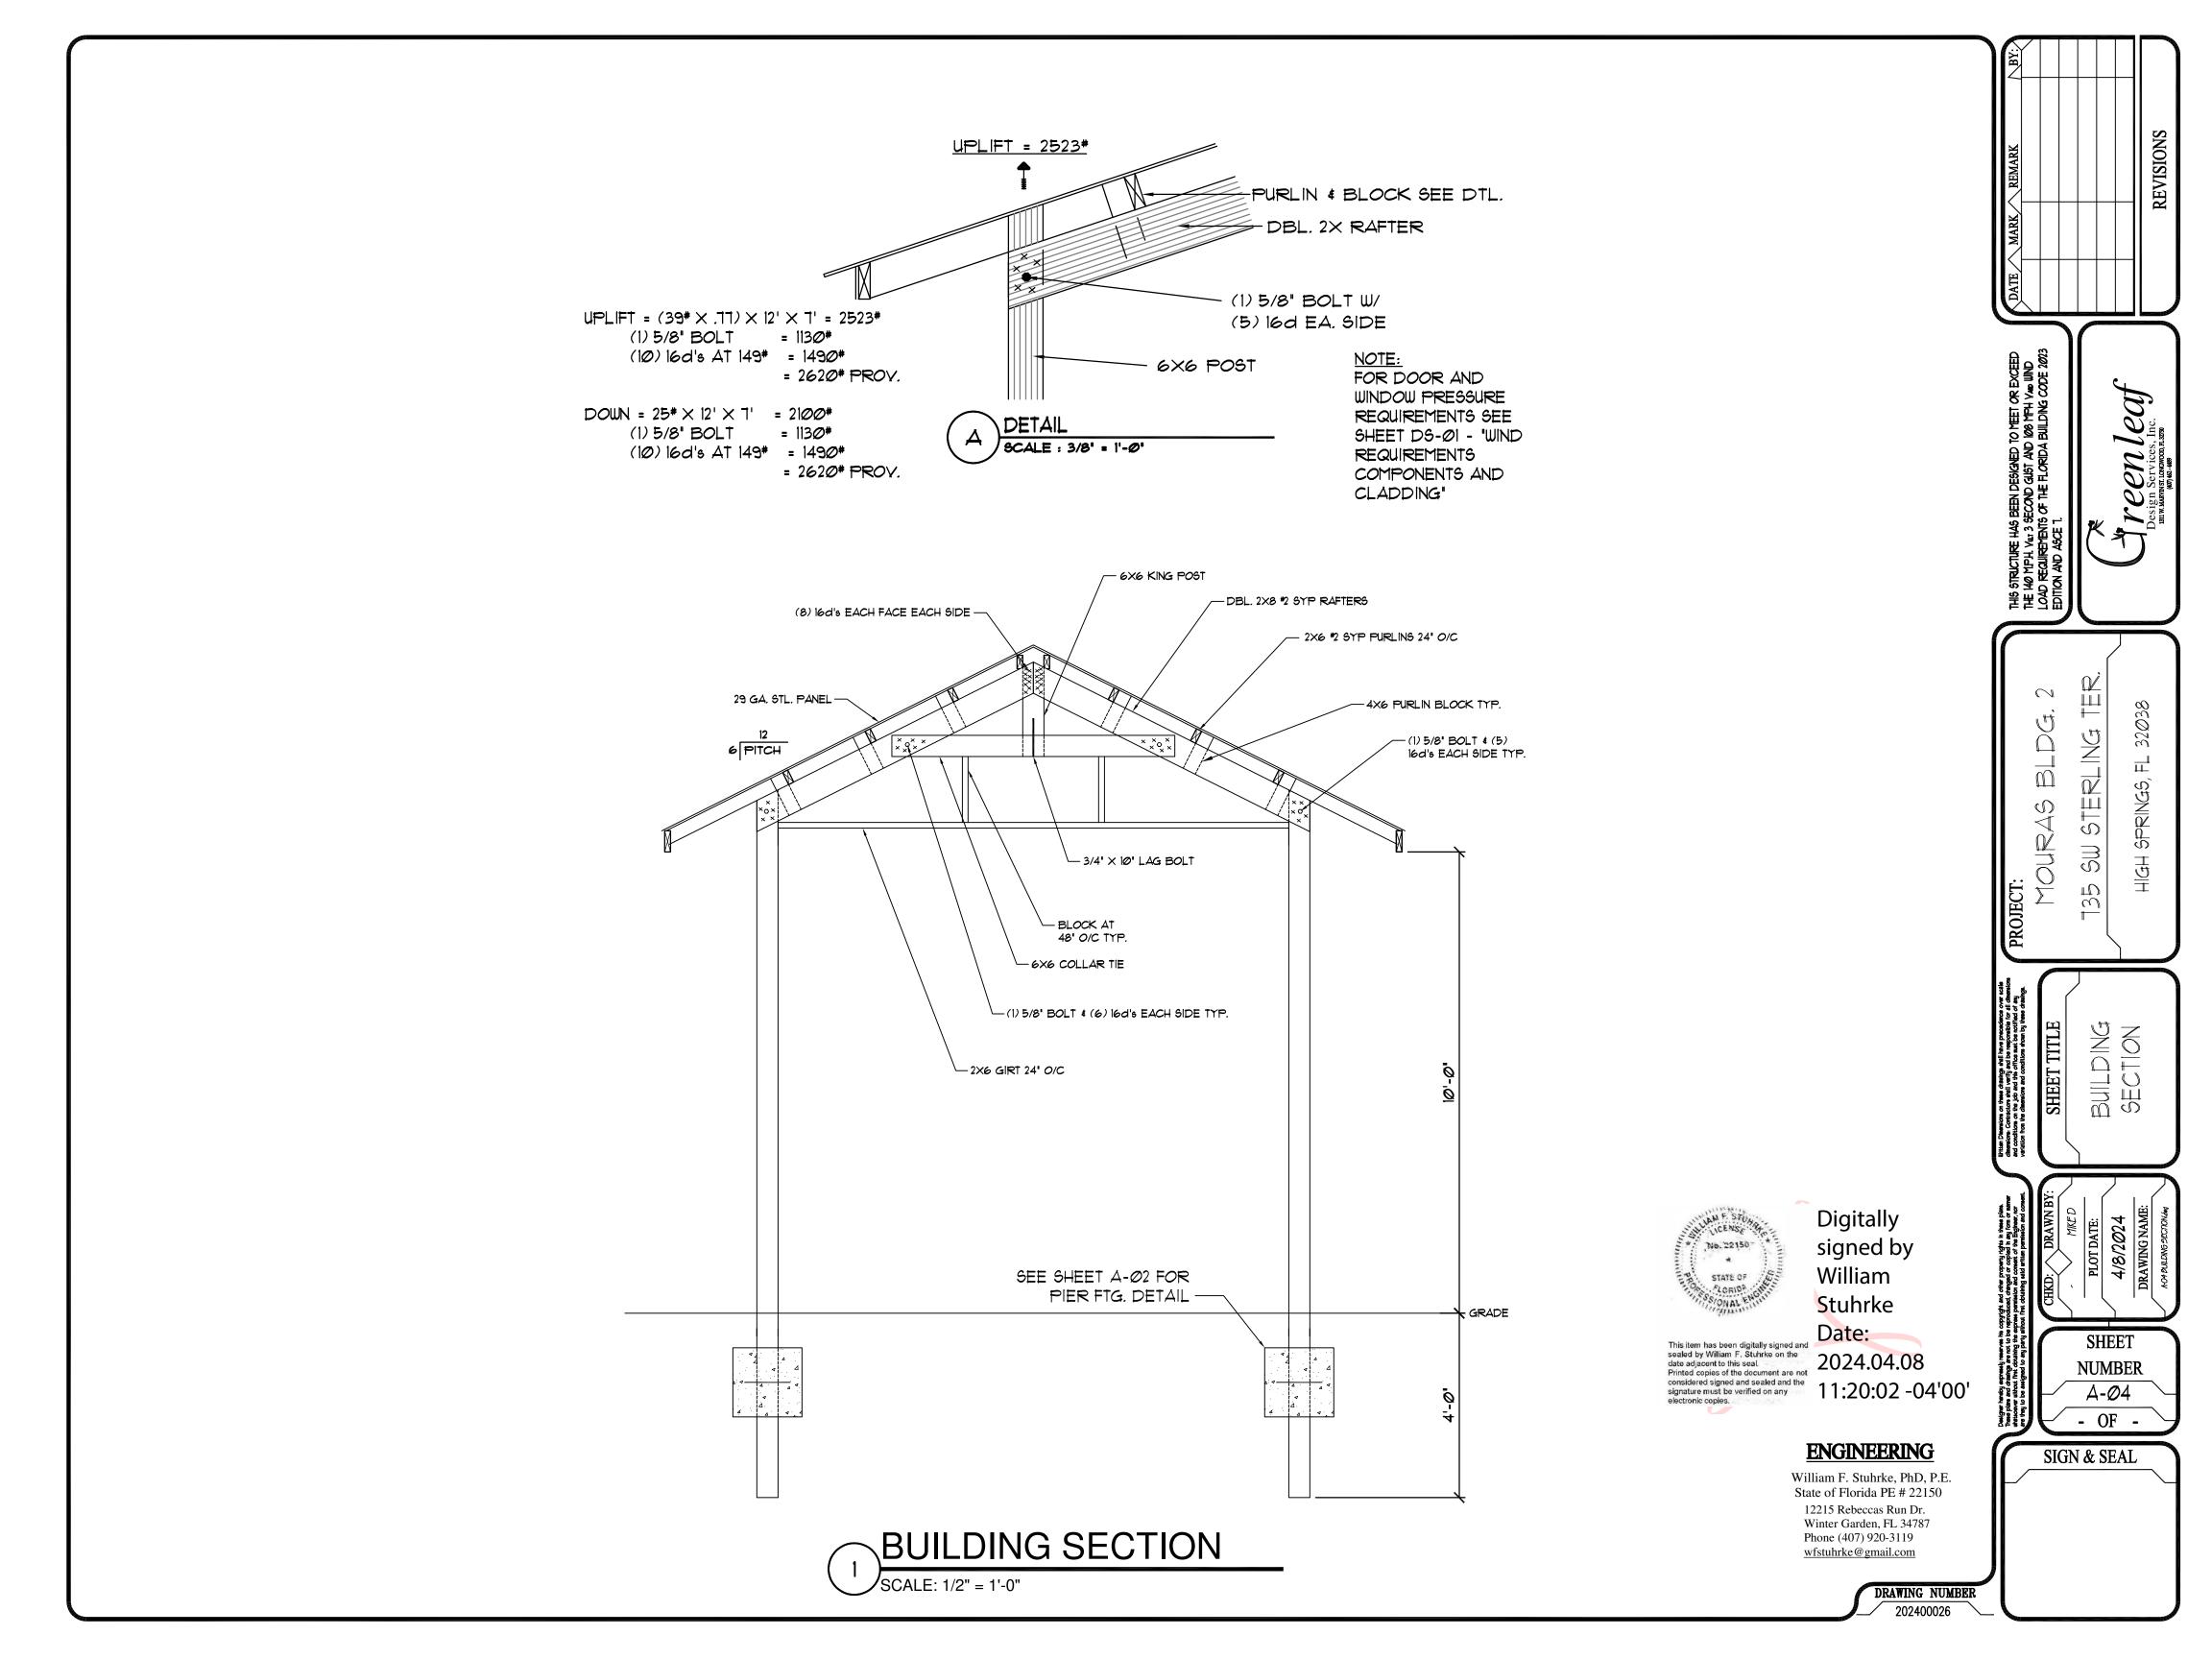
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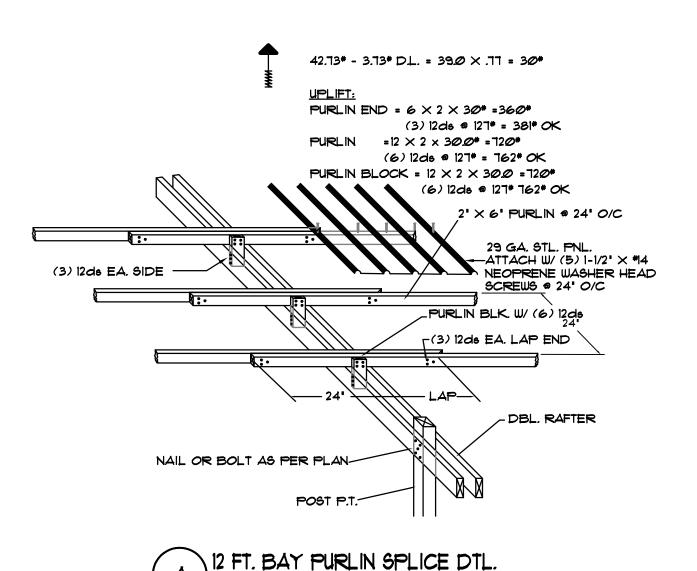
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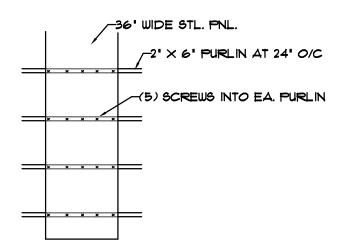
A-Ø3
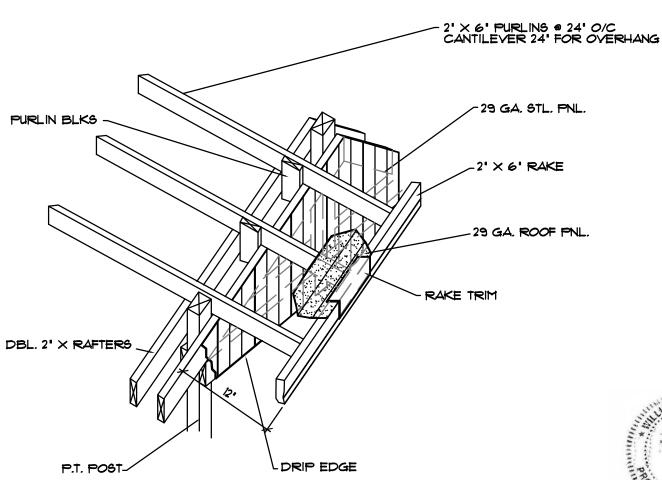
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B SCREW PLACEMENT PLAN N.T.S.

FLORIDA PRODUCT APPROVALS

METAL PNL. SIDING: 29 GA. MID FL. METAL ROOFING SUPPLY FL. *31397.1 METAL PNL. ROOFING: 29 GA. MID FL. METAL ROOFING SUPPLY FL. *23490.1

WIND REQUIREMENTS

BASIC WIND SPEED = 140 MPH (3 SEC. GUST)

BLDG. CATEGORY = 1

WIND IMPORTANCE FACTOR = 0.77

WIND EXPOSURE CATEGORY = B

DESIGN WIND LOADS:

WALLS = +23.8 -28.93 PSF ROOF = +11.76 -37.05 PSF COMPONENTS & CLADDING:

WALLS = +27.14 -33.18 PSF ROOF = +12.98 -42.73 PSF 3030 WDW. = +35.3 -47.2 PSF 4080 DR. = +33.7 -44.0 PSF

3068 DR = +35.3 -382 PSF ROOF LOADS:

LL. = 20* DL. = 05* BLDG. CLASSIFICATION:

GENERAL NOTES:

1.) ALL LUMBER TO BE #2 S.Y.P.

2.) BEARING POSTS TO BE 0.6 PCF C.C.A. OR 0.6 PCF ACQ.

3.) NAILS TO BE .131 X 12d GALV. GUN NAILS.

4.) BOLTS TO BE A301 W/ WASHERS.
5.) IF ACQ TREATED LUMBER IS USED, NAILS TO BE HOT

DIPPED GALY.



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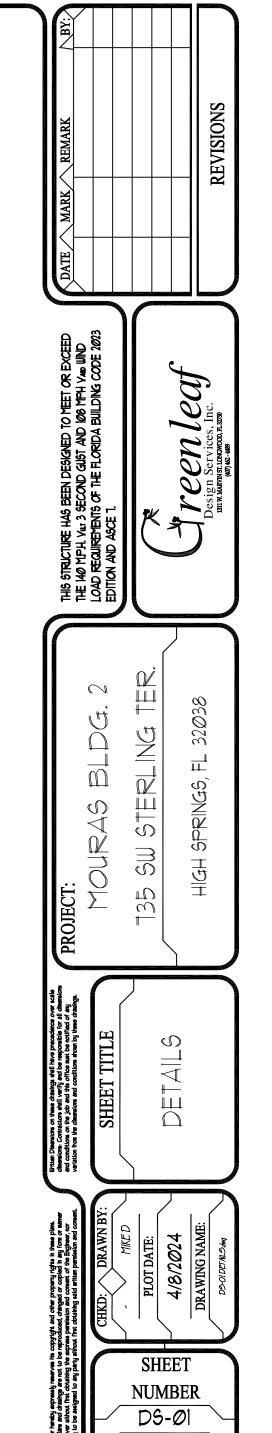
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