

76 North Meadowbrook Drive Alpine, UT 84004 office (201) 874-3483 swyssling@wysslingconsulting.com

January 13, 2023

Lumio Solar 12600 Challenger Parkway, Suite 200 Orlando, FL 32826 Scott Wyssling, PE

Digitally signed by Scott Wyssling, PE
DN: C=US, S=Utah, L=Alpine, O=Wyssling
Consulting, OU=Engineering, CN="Scott Wyssling,
PE", E=swyssling@wysslingconsulting, com
Reason: I am the author of this document
Location; your signing location here
Date: 2023.01.13 14:46:49-0700
Foxit PDF Editor Version: 11.1.0

Re: Engineering Services Waite Residence 175 Northeast Fronie Street, Lake City FL 5.200 kW System

To Whom It May Concern:

We have received information regarding solar panel installation on the roof of the above referenced structure. Our evaluation of the structure is to verify the existing capacity of the roof system and its ability to support the additional loads imposed by the proposed solar system.

A. Site Assessment Information

- 1. Site visit documentation identifying attic information including size and spacing of framing for the existing roof structure.
- Design drawings of the proposed system including a site plan, roof plan and connection details for the solar panels. This information will be utilized for approval and construction of the proposed system.

B. Description of Structure:

Roof Framing: Prefabricated wood trusses at 24" on center. All truss members are

constructed of 2 x 4 dimensional lumber.

Roof Material: Metal Roofing Roof Slopes: 27 +/- degrees Attic Access: Accessible Permanent

C. Loading Criteria Used

Dead Load

- Existing Roofing and framing = 7 psf
- New Solar Panels and Racking = 3 psf
- TOTAL = 10 PSF
- Live Load = 20 psf (reducible) 0 psf at locations of solar panels
- Ground Snow Load = 0 psf
- Wind Load based on ASCE 7-16
 - Ultimate Wind Speed = 120 mph (based on Risk Category II)
 - Exposure Category B

Analysis performed of the existing roof structure utilizing the above loading criteria is in accordance with the FBC 2020 7th Edition, including provisions allowing existing structures to not require strengthening if the new loads do not exceed existing design loads by 105% for gravity elements and 110% for seismic elements. This analysis indicates that the existing framing will support the additional panel loading without damage, if installed correctly.

D. Solar Panel Anchorage

- 1. The solar panels shall be mounted in accordance with the most recent S-5! Installation manual. If during solar panel installation, the roof framing members appear unstable or deflect non-uniformly, our office should be notified before proceeding with the installation.
- 2. System will be attached to the metal roofing material utilizing the patented S-5! Connection. Installation of the connections shall be in accordance with the manufacturer's recommendations...
- 3. Considering the wind speed, roof slopes, size and spacing of framing members, and condition of the roof, the panel supports shall be placed no greater than 48" on center.
- 4. Panel supports connections shall be staggered to distribute load to adjacent framing members.

Based on the above evaluation, this office certifies that with the racking and mounting specified, the existing roof system will adequately support the additional loading imposed by the solar system. This evaluation is in conformance with the $FBC\ 2020\ 7^{th}$ Edition, current industry standards and practice, and is based on information supplied to us at the time of this report.

Should you have any questions regarding the above or if you require further information do not hesitate to contact me.

Scott E. Wysslind, PE

Scott E. Wyssling, PE Florida License No. 8 (53) THIS PLAN HAS BEEN ELECTRONICALLY SIGNED AND SEALED BY SCOTT WYSSLING, PE USING A DIGITAL SIGNATURE AND DATE. PRINTED COPIES OF THIS DOCUMENT ARE NOT CONSIDERED SIGNED AND SEALED AND THE SIGNATURE MUST BE VERIFIED ON ANY ELECTRONIC COPIES

No. 8155

Wyssling Consulting, PLLC
76 N Meadowbrook Drive Alpine UT 84004


Florida License # RY34912

Date Signed 1/13/2023



ARRAY DESCRIPTION							
ROOF	# OF MODULES	AZIMUTH	TRUSS SIZE	TRUSS SPACING	ROOF MATERIAL		
#1	13	179	2X4	24"O.C.	METAL		

	DESIGN SPECIFICATION				
	RISK CATEGORY	II			
	CONSTRUCTION	SFD			
1	ZONING	RESIDENTIAL			
J	SNOW LOAD (ASCE 7-16)	0 PSF			
	EXPOSURE CATEGORY	В			
	WIND SPEED (ASCE 7-16)	120 MPH			

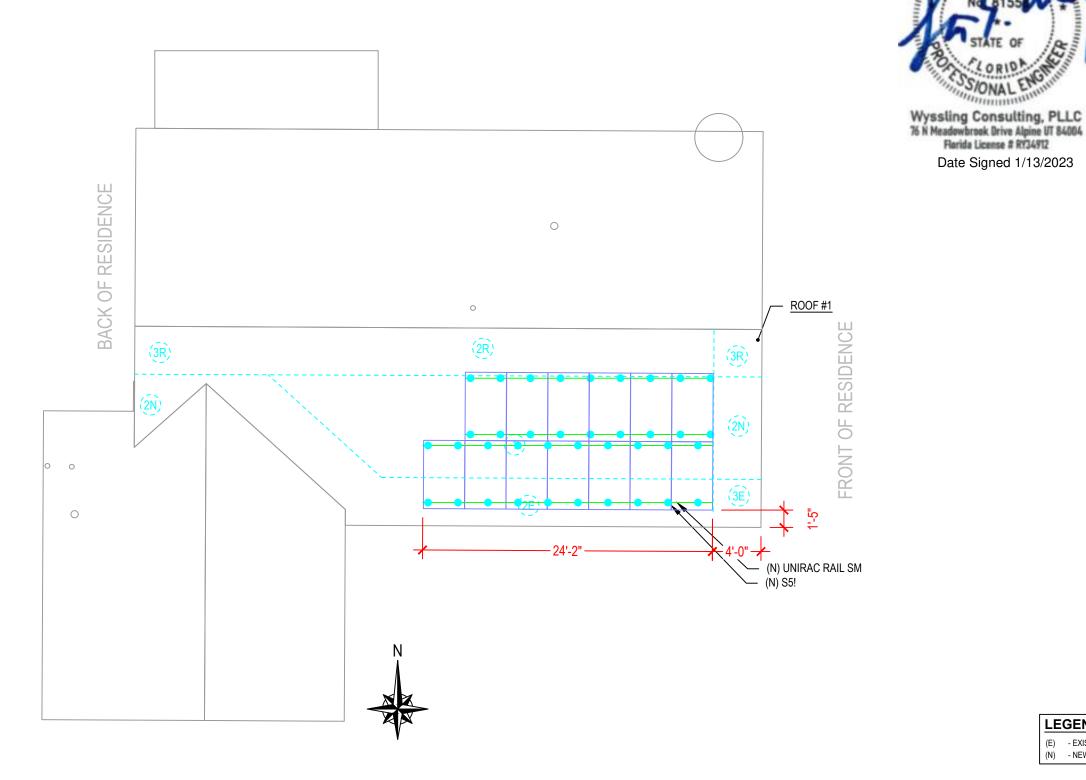



ATLANTIC KEY ENERGY LLC 12600 CHALLENGER PARKWAY

SUITE 200 ORLANDO, FL 32826 1 (407) 988-0273

PROJECT # P-0065497 175 NORTHEAST FRONIE STREET LAKE CITY, FL 32055 **GARY WAITE** RESIDENCE

SIGNATURE WITH SEAL

REVISIONS DESCRIPTION DATE REV

SHEET NAME

ROOF PLAN AND MODULES

01/12/2023

SHEET NUMBER

S-0

ROOF PLAN AND MODULES

THIS PLAN HAS BEEN ELECTRONICALLY SIGNED AND SEALED BY SCOTT WYSSLING, PE USING A DIGITAL SIGNATURE AND DATE. PRINTED COPIES OF THIS DOCUMENT ARE NOT CONSIDERED SIGNED AND SEALED AND THE SIGNATURE MUST BE VERIFIED ON ANY ELECTRONIC COPIES

Date Signed 1/13/2023

S-0

SCALE: NTS

LEGEND

(E) - EXISTING (N) - NEW

S-5! The Right Way!™

ProteaBracket[™]

A versatile bracket for mounting solar PV to trapezoidal roof profiles

profiles!

trapezoidal

3

solar

attach

ProteaBracket™ is now made in aluminum. Still the most versatile trapezoidal metal roof attachment solution on the market, the S-5! ProteaBracket just got better!

The bracket features an adjustable attachment base and module attachment options to accommodate different roof profile dimensions and mounting options.

Our pre-applied EPDM gasket with peel and stick adhesive makes installation a snap, ensuring accurate and secure placement the first time.

With no messy sealants, faster installation, and a weather-proof fit, ProteaBracket offers you the most versatile solar attachment solution available.

ProteaBracket* can be used for rail mounting or "direct-attach" with S-5! PVKIT™

*When ProteaBracket is used in conjunction with the \$-5! PVKIT, an additional nut is required during installation.

NEW

888-825-3432 | www.S-5.com

NOW AVAILABLE IN ALUMINUM



Features and Benefits

- 34% lighter saves on shipping
- Stronger L-Foot™
- Load-tested for engineered application
- · Corrosion-resistant materials
- Adjustable Fits rib profiles up to 3"
- Peel-and-Stick prevents accidental shifting during installation
- Fully pre-assembled
- 25-year warranty*

*See www.S-5 com for detail

S-51®
The Right Way!"

ProteaBracket[™] is the perfect solar attachment solution for most trapezoidal rib, exposed-fastened metal roof profiles!

ProteaBracket™ is compatible with common metal roofing materials and comes with a pre-applied EPDM gasket on the base.

Note: All four pre-punched holes must be used to achieve tested strength. Fasteners are provided.

For design assistance, ask your distributor, or visit www.S-5.com for the independent lab test data that can be used for load-critical designs and applications. Also, please visit our website for more information including metallurgical compatibilities and specifications.

S-5!° holding strength is unmatched in the industry.


Multiple Attachment Options:



Side Mount Rail



Bottom Mount Rail

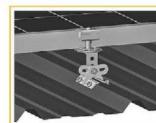

w/S-5! PVKIT™ (rail-less) ProteaBracket

ProteaBracket

ProteaBracket

As atili available in staicless sied.

1.18th

1.00" Slotted Hole

0.35" x 1.00" Slotted Hole

2.95" -

ProteaBracket fits profiles up to 3 inches

No surface preparation needed. (1) Wipe away excess oil and debris. (2) Peel off adhesive release paper. (3) Align and mount bracket directly onto crown of panel. (4) Secure ProteaBracket through pre-punched holes, using piercing-point S-SI screws.



5-5!° Warning! Please use this product responsibly!

Products are protected by multiple U.S. and foreign patents. For published data regarding holding strength, bolt torque, patents, and trademarks, visit the S-5t website at www.S-5.com. Copyright 2019, Medi Roof Innovations, Ltd. S-3tproducts are patent protected. S-3taggressively protects its patents, fractemarks, and copyrights. Version 07383. Distributed by



ATLANTIC KEY ENERGY LLC

12600 CHALLENGER PARKWAY SUITE 200 ORLANDO, FL 32826 1 (407) 988-0273

Lumio ×

RESIDENCE PROJECT # P-0065497 175 NORTHEAST FRONIE STREET LAKE CITY, FL 32055

SIGNATURE WITH SEAL

REVISIONS
DESCRIPTION DATE REV

ate: 01/12/202

SHEET NAME

EQUIPMENT

SPECIFICATIONS
SHEET NUMBER

S-1

SOLARMOUNT



SOLARMOUNT defined the standard in solar racking. Features are designed to get installers off the roof faster. Our grounding & bonding process eliminates copper wire and grounding straps to reduce costs. Systems can be configured with standard or light rail to meet your design requirements at the lowest cost possible. The superior aesthetics package provides a streamlined clean edge for enhanced curb appeal, with no special brackets required for installation.









System grounding through Enphase microinverters and trunk cables Light Rail is Fully Compatible with all SM Components



FAST INSTALLATION. SUPERIOR AESTHETICS

OPTIMIZED COMPONENTS . VERSATILITY . DESIGN TOOLS . QUALITY PROVIDER

SOLARMOUNT

#UNIRAC


OPTIMIZED COMPONENTS INTEGRATED BONDING & PRE-ASSEMBLED PARTS

Components are pre-assembled and optimized to reduce installation steps and save labor time. Our new grounding & bonding process eliminates copper wire and grounding straps or bonding jumpers to reduce costs. Utilize the micromverter mount with a wire

ONE PRODUCT - MANY APPLICATIONS

Quickly set modules flush to the roof or at a desired tilt angle. Change module to outperform your projects financial and aesthetic aspirations

tool that streamlines the process of designing a code compliant solar mounting system : Save time by creating a user profile, and recall preferences and projects automatically when you log in. You will enjoy the ability to share projects with customers; there's no

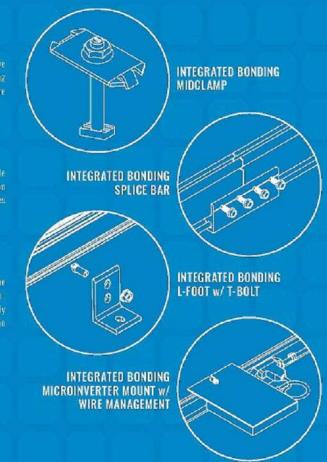



UNIRAC CUSTOMER SERVICE MEANS THE HIGHEST LEVEL OF PRODUCT SUPPORT













TECHNICAL SUPPORT

CERTIFIED QUALITY PROVIDER

BANKABLE WARRANTY

strength to back our products and reduce your risk. Have peace quality. SOLARMOUNT is covered by a twenty five (25) year

PROTECT YOUR REPUTATION WITH QUALITY RACKING SOLUTIONS BACKED BY ENGINEERING EXCELLENCE AND A SUPERIOR SUPPLY CHAIN

ATLANTIC KEY ENERGY LLC

12600 CHALLENGER PARKWAY SUITE 200 ORLANDO, FL 32826

PROJECT # P-0065497 175 NORTHEAST FRONIE STREE1 RESIDENCE LAKE CITY, FL

SIGNATURE WITH SEAL

REVISIONS DESCRIPTION DATE

SHEET NAME

EQUIPMENT SPECIFICATIONS

SHEET NUMBER

S-2