

SEE SEE A

LEFT ELEVATION

FILE COPY

SCALE: 1/4" = 1'-0"

REV.# REV. DATE: DRAWN BY: DISCRIPTION OF REVISION

Pennyworth Homes

Got Land? Let's Build! 010738 PennyworthHomes.com FL-CRO

EXHIBIT "A" PLAN:

CUSTOM CUSTOMER NAME:

MAUREEN RODRIGUEZ

HEATED LIVING AREA

GROUND FLOOR: 1798 SECOND FLOOR: N/A N/A OTHER: 1798 TOTAL HEATED:

NON-HEATED

LIVING AREA


PORCH: 21 GARAGE: N/A OTHER: N/A 1819 TOTAL U/R

IMPORTANT-PLEASE READ

BELOW CAREFULLY

OUR SALES BROCHURES AND OTHER ADVERTISING LIT ERATURE ARE INTENDED TO GENERALLY REFLECT AND DEPICT THE STYLES AND QUALITY OF HOMES WE BUILD THROUGHOUT A PORTION OF THE UNITED STATES. OUR SALES MODELS ARE DESIGNED AND BUILT TO GENERALLY CONFORM WITH A VARIETY OF LOCAL CUSTOMS, PRACTICES, AND BUILDING CODES PREVALENT OR IN EFFECT IN THE IMMEDIATE AREA SURROUNDING THE LOCATION OF THOSE MODELS. THIS SET OF PLANS IS AN ACTUAL PART OF OUR CONTRACT WITH YOU AND, AS SUCH, IS IN-TENDED TO TAKE PRIORITY OVER ANYTHING IN CONFLICT WITH IT CONTAINED IN OUR ADVERTISING LITERATURE. OUR SALES MODELS AND EVEN OUR ORAL SALES PRESEN TATION. NO CHANGE, MODIFICATION, OR REVISION OF THESE PRINTED PLANS SHALL BE BINDING ON THE PARTIES UNLESS SET FORTH ON THESE PLANS OR OTHER-WISE REDUCED TO WRITING AND EXECUTED BY SAID PARTIES. PLEASE REVIEW THESE PLANS ALONG WITH "EXHIBIT B" OF YOUR CONTRACT CAREFULLY AND MAKE CERTAIN BEFORE YOU SIGN THEM THAT THEY ACCU-RATELY REPRESENT THE HOME YOU ARE PURCHASING. ADDITIONALLY, P.W.H. HOMES INC. HEREBY RESERVES THE RIGHT TO SUBSTITUTE MATERIALS OF EQUIVALENT QUALITY AND/OR TECHNIQUES OF ASSEMBLY AND/OR CONSTRUCTION METHODS FROM THAT CONTAINED IN THESE PLANS OR SPECIFIED IN EXHIBIT "B" WHERE NEC-ESSARY TO ACCOMODATE DIFFERENCES IN LOCAL CODES, GEOGRAPHIC CUSTOMS, OPTION SELECTION AND AVAIL-ABILITY OF MATERIALS. ALL MATERIALS (LUMBER, OR OTHER BUILDING SUPPLIES) DELIVERED TO JOBSITE WHICH ARE IN EXCESS OF THOSE REQUIRED TO CON-STRUCT THE HOUSE AS AGREED REMAIN THE PROPERTY OF P.W.H. HOMES INC. NOTE:


PENNYWORTH HOMES INC. RESERVES THE RIGHT TO ONLY MAKE CHANGES TO PLANS, REQUESTED BY BUYERS, THAT PENNYWORTH HOMES INC. DEEMS TO BE AESTHETICALLY, ARCHITECTURALLY, AND STRUCTURALLY SOUND.

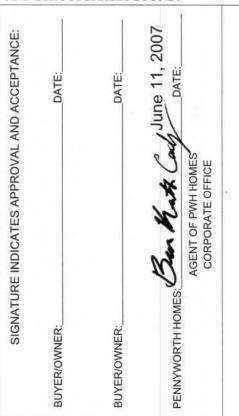


PENNYWORTH HOMES INC. RESERVES THE RIGHT TO MAKE MODIFICATIONS TO THIS PLAN AFTER THE BUYERS APPROVAL / SIGNATURE, DUE TO THE ENGINEER'S AND BUILDING DEPT. REVIEW. THE BUYER SHALL BE NOTIFIE OF THESE MODIFICATIONS TO THE PLAN VIA CHANGE ORDER.

DRAWN BY: PLAN DATE: BKC June 11, 2007

OF

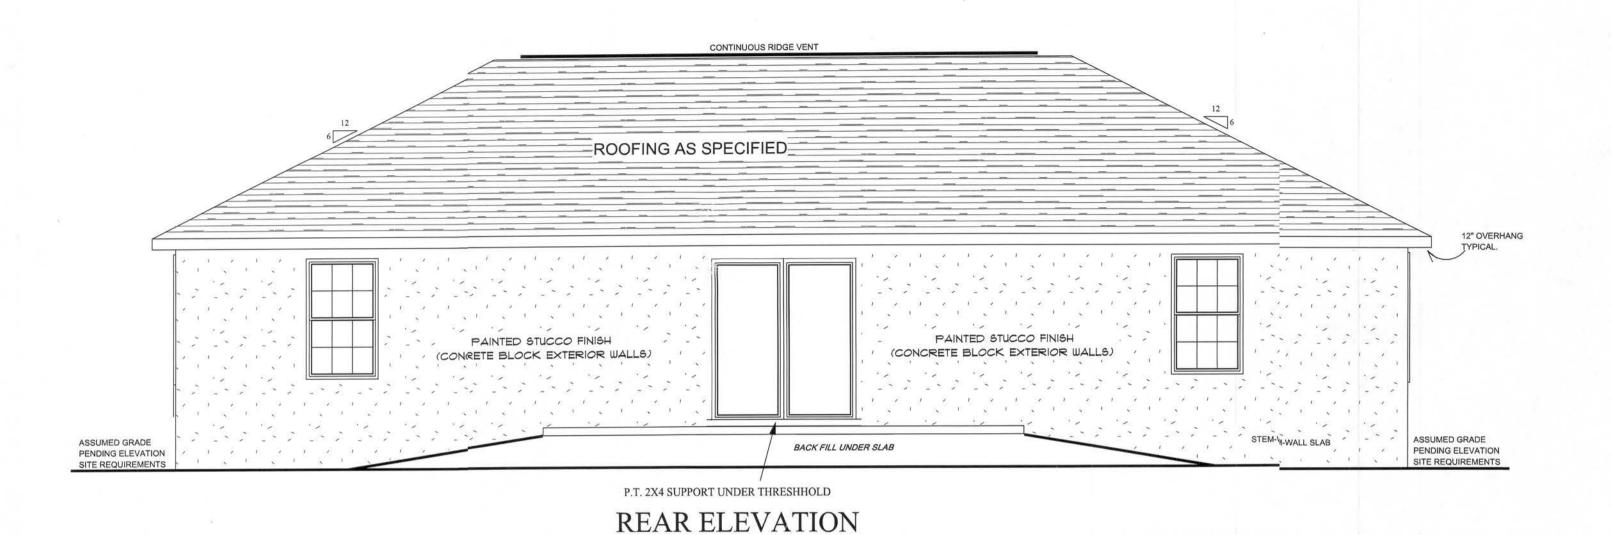

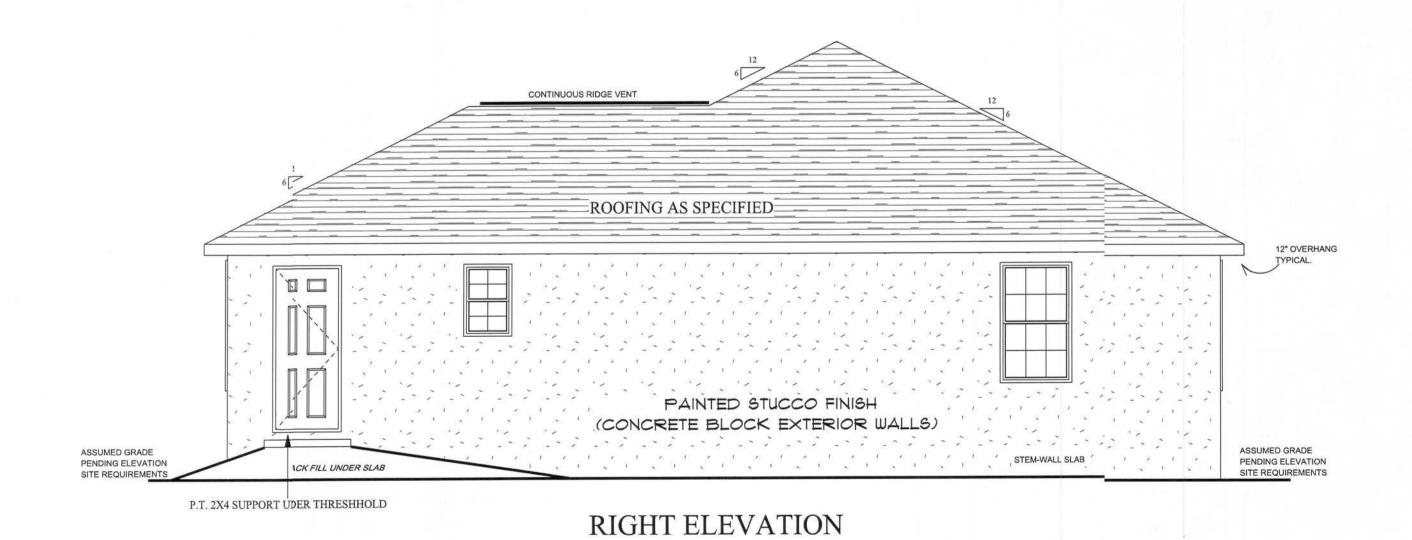

SCALE: 1/4'' = 1'-0''

REV.#	REV. DATE:	DRAWN BY:	DISCRIPTION OF REVISION	_

Pennyworth Homes

Got Land? Let's Buildl sc-010738 PennyworthHomes.com FL-CRC08

EXHIBIT "A"

PLAN: CUSTOM

CUSTOMER NAME:

MAUREEN RODRIGUEZ

HEATED LIVING AREA

GROUND FLOOR: 1798
SECOND FLOOR: N/A
OTHER: N/A
TOTAL HEATED: 1798

NON-HEATED LIVING AREA


PORCH:	21
GARAGE:	N/A
OTHER:	N/A
TOTAL U/R	1819
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BELOW CAREFULLY

IMPORTANT-PLEASE READ


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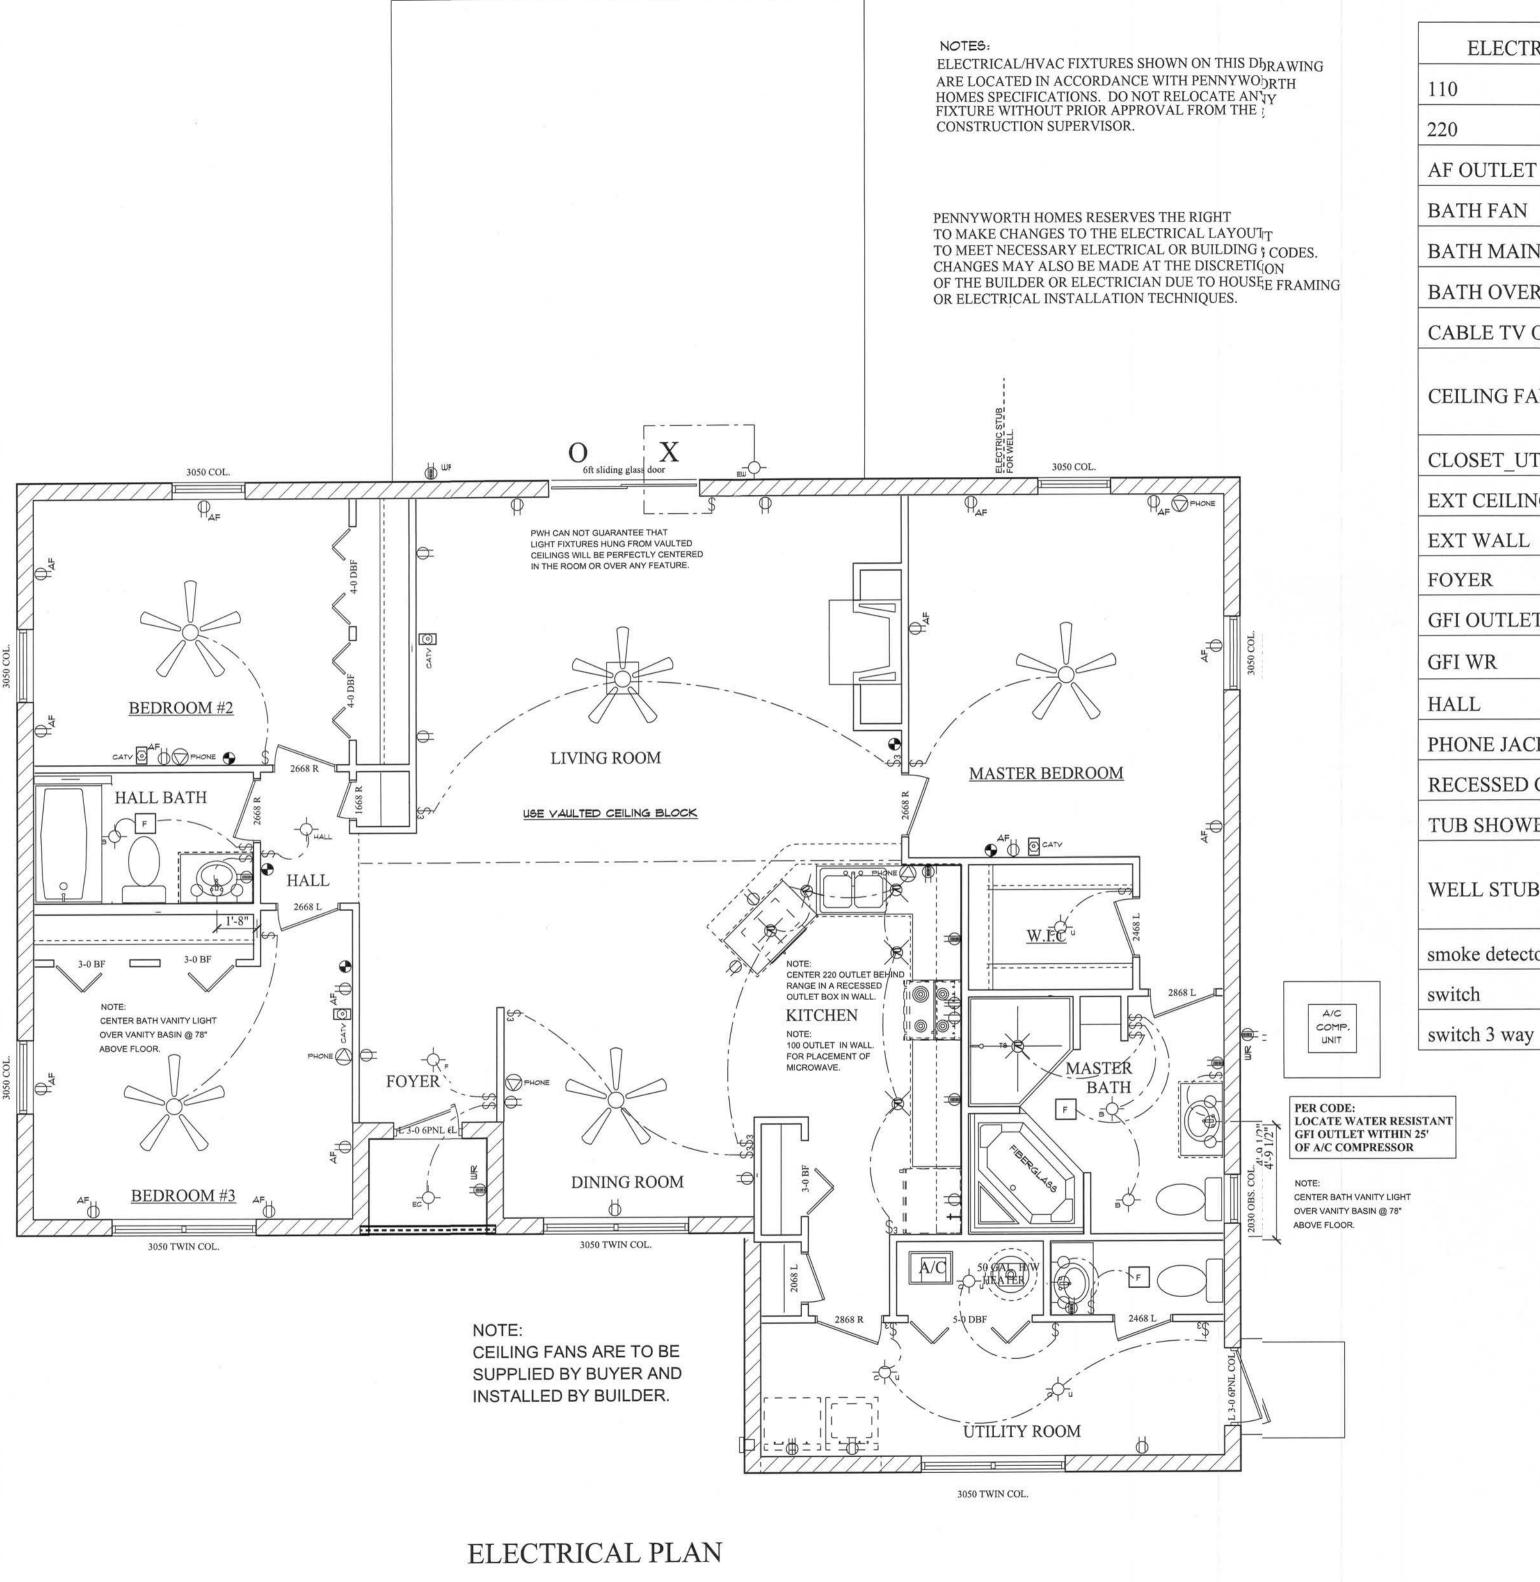
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ELECTRICAL	COUNT	SYMBOL
110	14	Ф
220	2	Ф
AF OUTLET	15	AF.
BATH FAN	3	F
BATH MAIN	3	<u>-</u>
BATH OVER MIRROR	3	999
CABLE TV OUTLET	4	CATY 0
CEILING FAN	5	
CLOSET_UTILITY	4	-φ-
EXT CEILING	1	EC \$
EXT WALL	1	EW -
FOYER	1	- \$ -,
GFI OUTLET	6	dib
GFI WR	3	¥ ⊞
HALL	1	-\$\rightarrow{\pi_{HALL}}
PHONE JACK	5	PHONE
RECESSED CAN LIGHT	5	×
TUB SHOWER RECESS	1	75
WELL STUB	1	ELEÇTRIC STUB FOR WELL.
smoke detector	5	•
switch	17	\$
switch 3 way	8	\$3

SCALE: 1/4" = 1'-0"

REV.# REV. DATE: DRAWN BY: DISCRIPTION OF REVISION

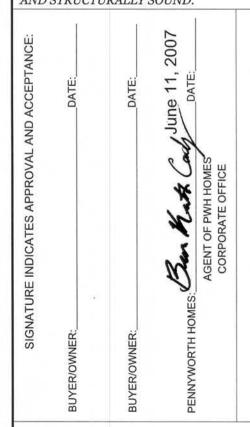Pennyworth Homes

Got Land? Let's Buildle PennyworthHomes.com FL-CRCO

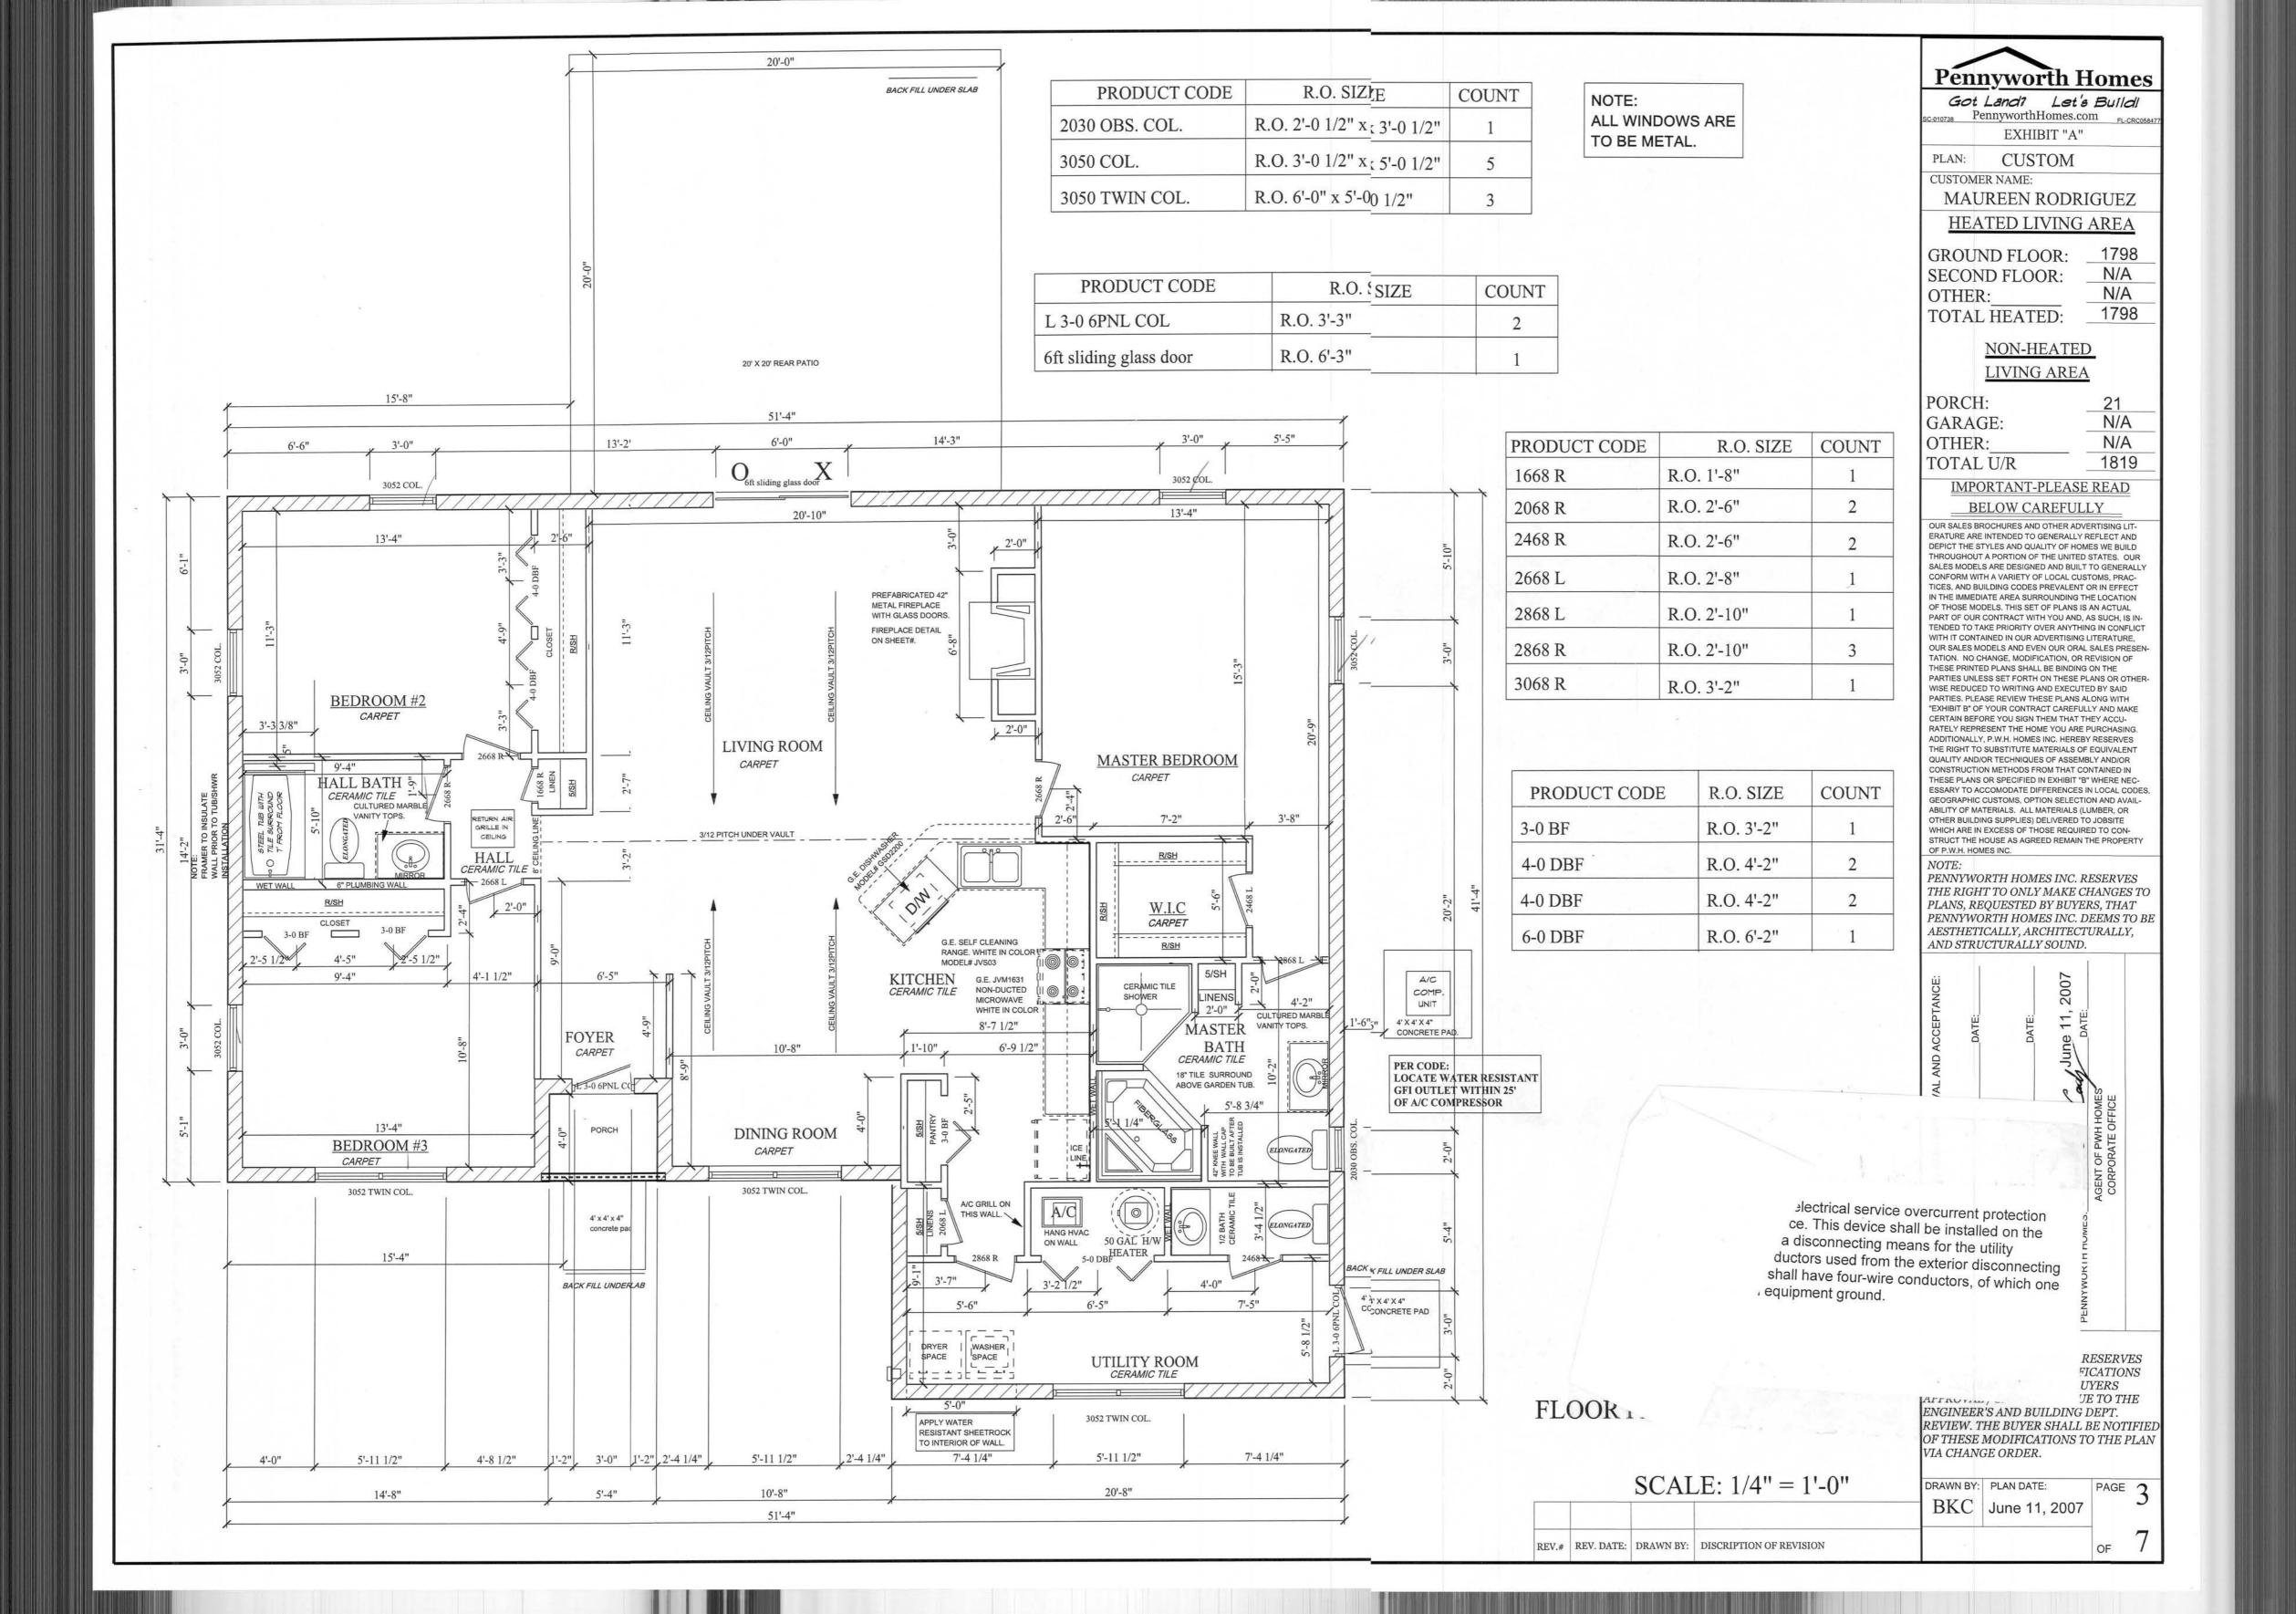PLAN:
CUSTOMER NAME:

HEATED LIVING AREA

GROUND FLOOR: ____ SECOND FLOOR: ____ OTHER: ___ TOTAL HEATED: ___


NON-HEATED LIVING AREA

PORCH: GARAGE: OTHER:____ TOTAL U/R

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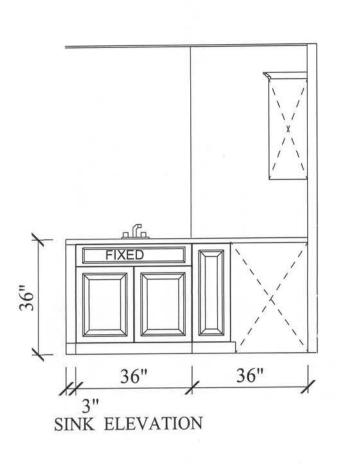



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DRAWN BY:	PLAN DATE:	PAGE	
BKC	June 11, 2007		
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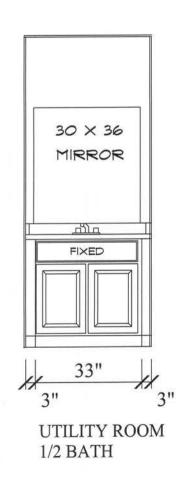
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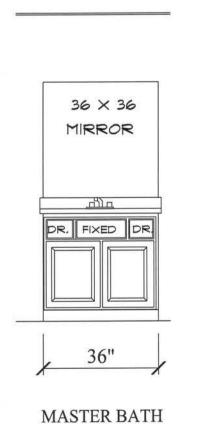




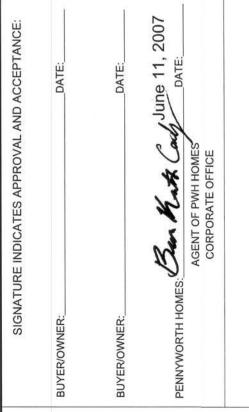

KITCHEN ELEVATIONS



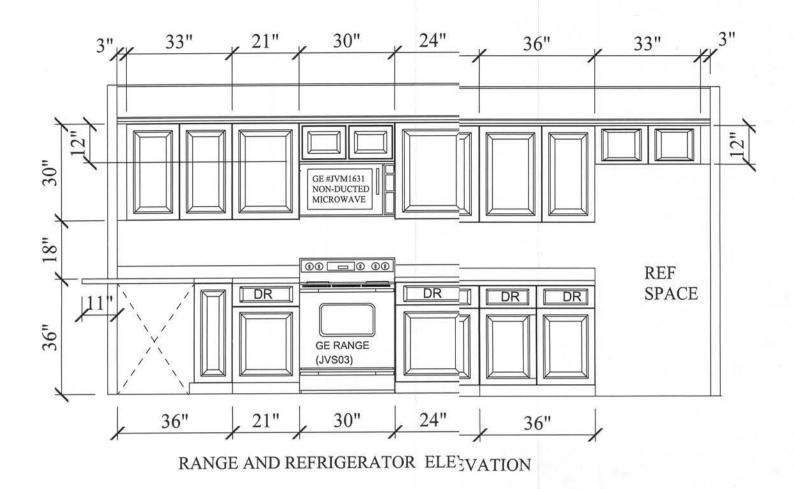



BATH ELEVATIONS

Penny	worth	Homes
	TI OI CII	11011105

Got Land? Let's Buildl sc-010738 PennyworthHomes.com FL-CRC058

EXHIBIT "A"

PLAN:

CUSTOMER NAME:

HEATED LIVING AREA

GROUND FLOOR: SECOND FLOOR: OTHER:

TOTAL HEATED:

NON-HEATED LIVING AREA


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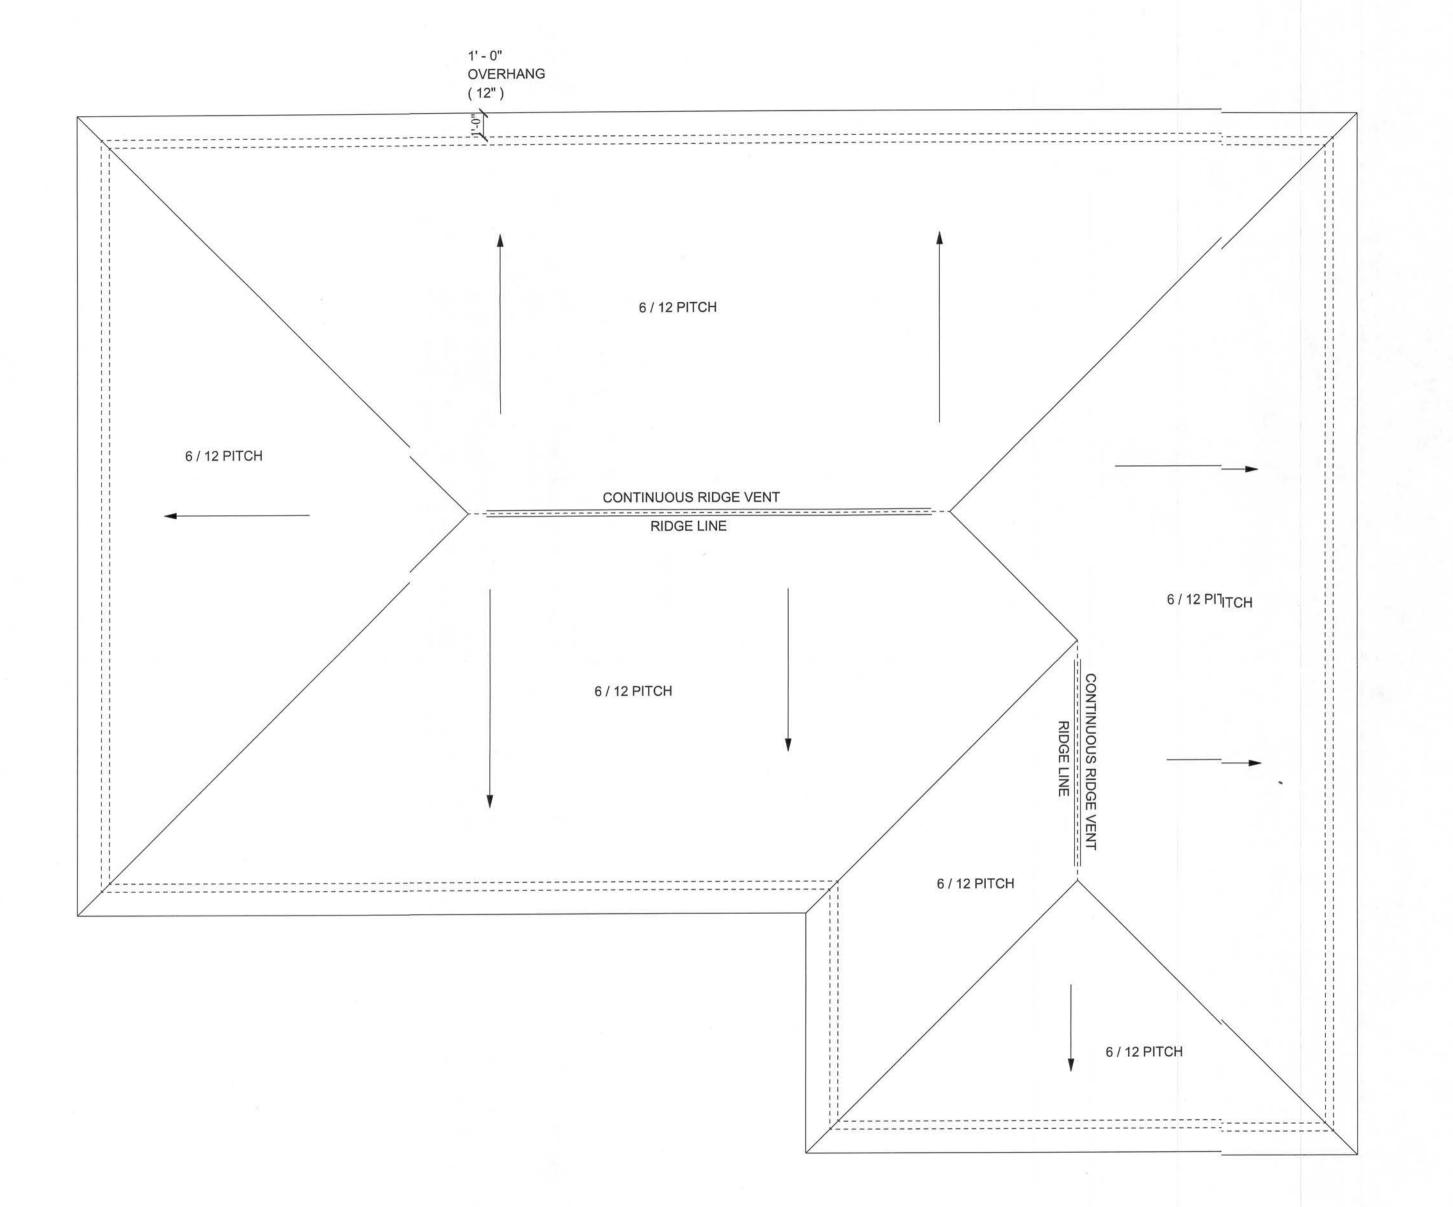
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SCALE: 1/4'' = 1'-0''

DRAWN BY: PLAN DATE: BKC June 11, 2007 REV.# REV. DATE: DRAWN BY: DISCRIPTION OF REVISION OF



ROOF LAYOUT

Pennyworth Homes

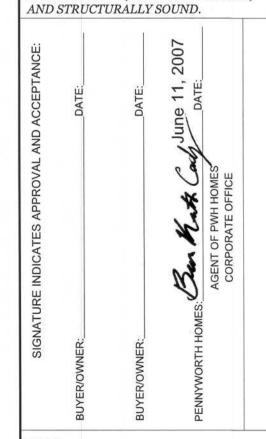Got Land? Let's Build!

SC-010738 PennyworthHomes.com FL-CRC05847

EXHIBIT "A"

PLAN: CUSTOM

CUSTOMER NAME:

MAUREEN RODRIGUEZ

HEATED LIVING AREA

GROUND FLOOR: 1798
SECOND FLOOR: N/A
OTHER: N/A
TOTAL HEATED: 1798

NON-HEATED LIVING AREA

 PORCH:
 21

 GARAGE:
 N/A


 OTHER:
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 TOTAL U/R
 1819

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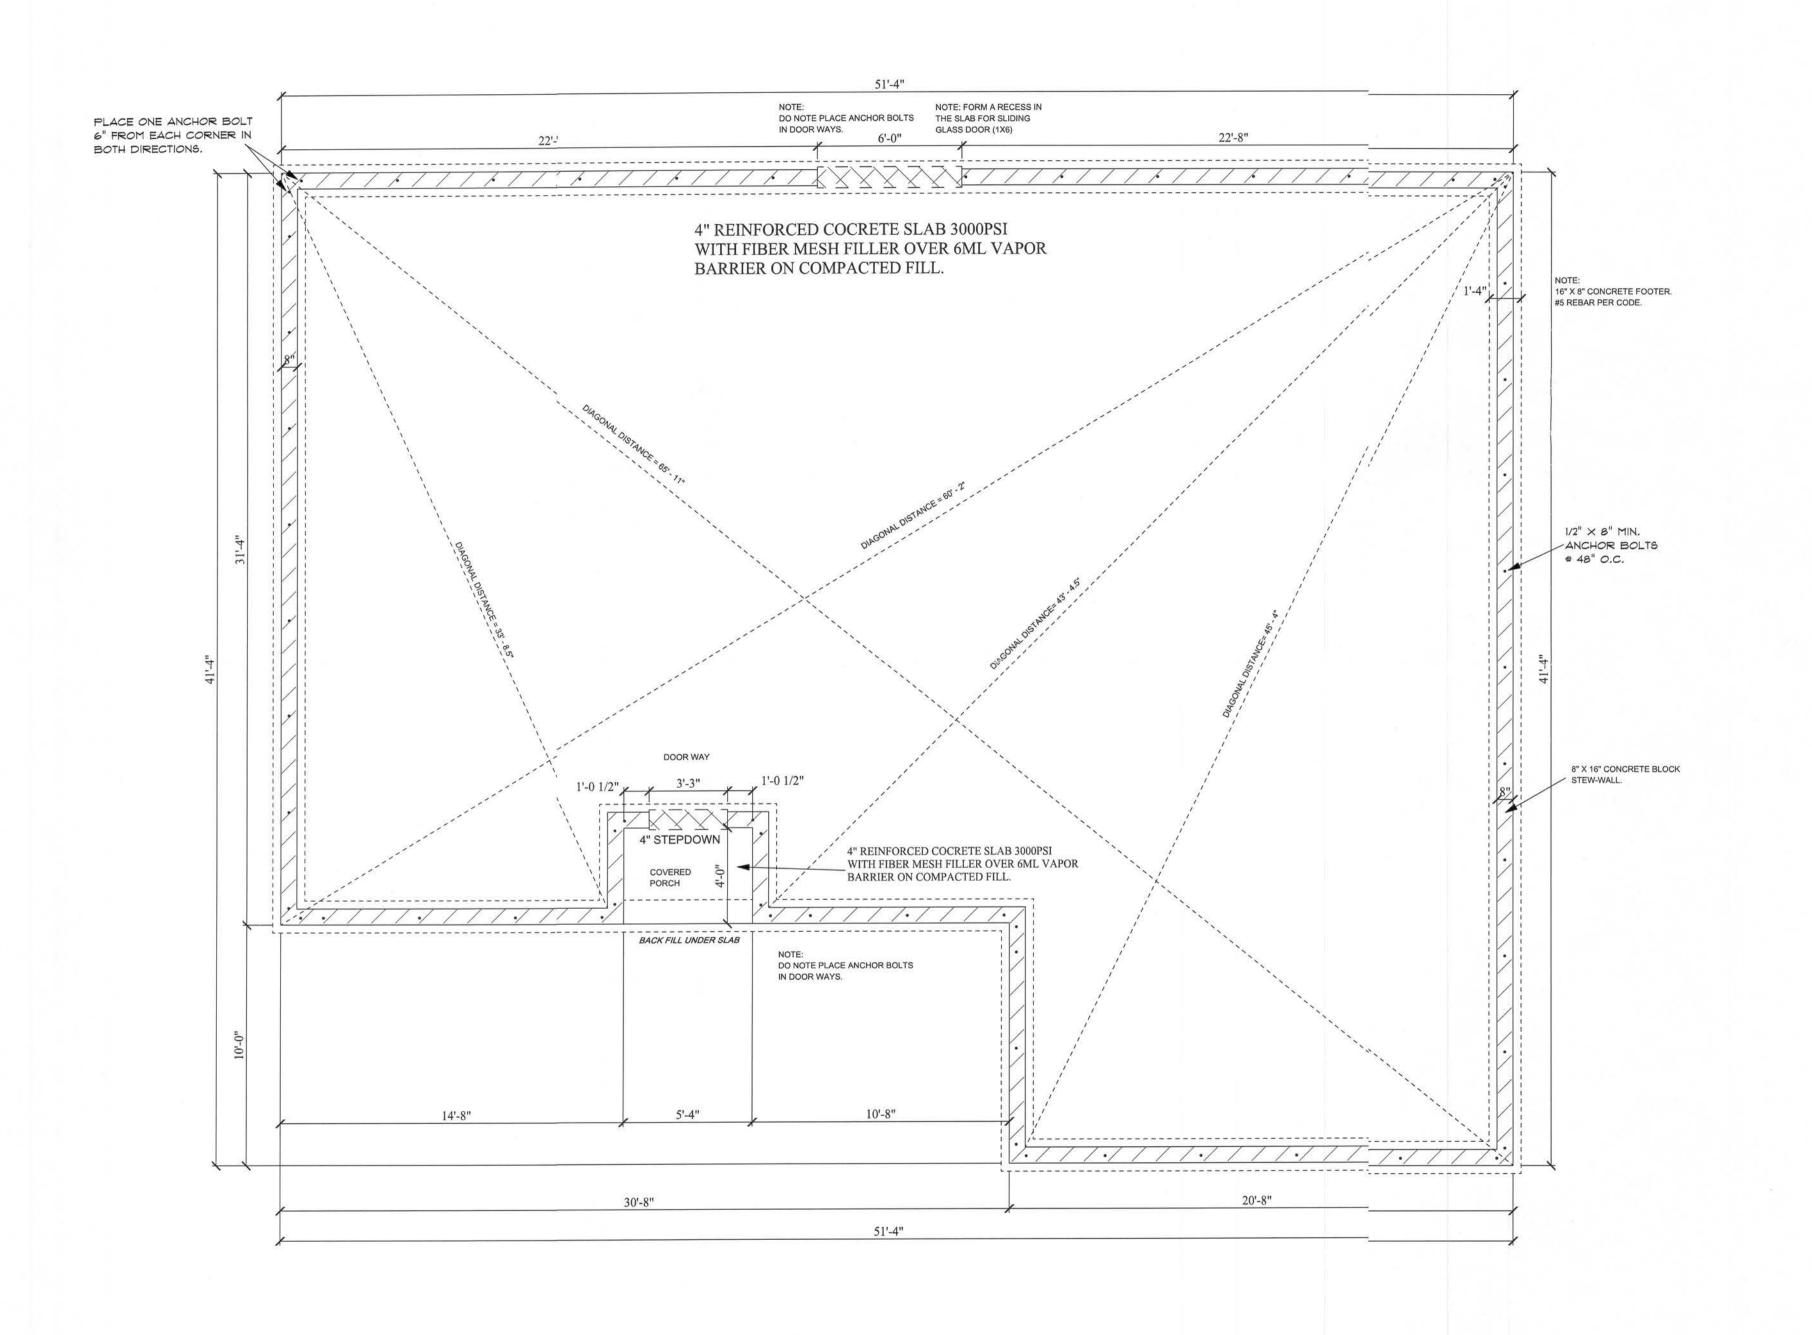
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SCALE: 1/4" = 1'-0"

REV.# REV. DATE: DRAWN BY: DISCRIPTION OF REVISION

DRAWN BY: PLAN DATE:
BKC June 11, 2007

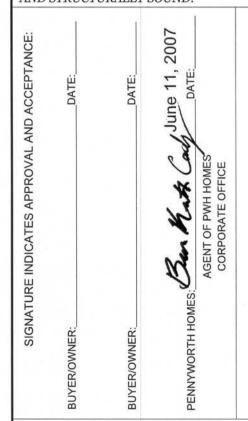

FOUNDATION PLAN

SCALE: 1/4'' = 1'-0''

REV.# REV. DATE: DRAWN BY: DISCRIPTION OF REVISION

Pennyworth Homes

Got Land? Let's Buildl GC-010738 PennyworthHomes.com FL-CRC051

PennyworthHomes.com
EXHIBIT "A"

PLAN: CUSTOM

CUSTOMER NAME:

MAUREEN RODRIGUEZ

HEATED LIVING AREA

GROUND FLOOR: SECOND FLOOR: OTHER:

TOTAL HEATED:

N/A N/A 1798

NON-HEATED LIVING AREA

 PORCH:
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 GARAGE:
 N/A

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 TOTAL U/R
 1819

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SIGNATURE INDICATES APPROVAL AND ACCEPTANCE:

UYER/OWNER:

DATE:

DATE:

DATE:

AGENT OF PWH HOMES

CORPORATE OFFICE


CORPORATE OFFICE

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PLAN DATE:	PAGE_
June 11, 2007	7

of 7




FOUNDATION PLAN

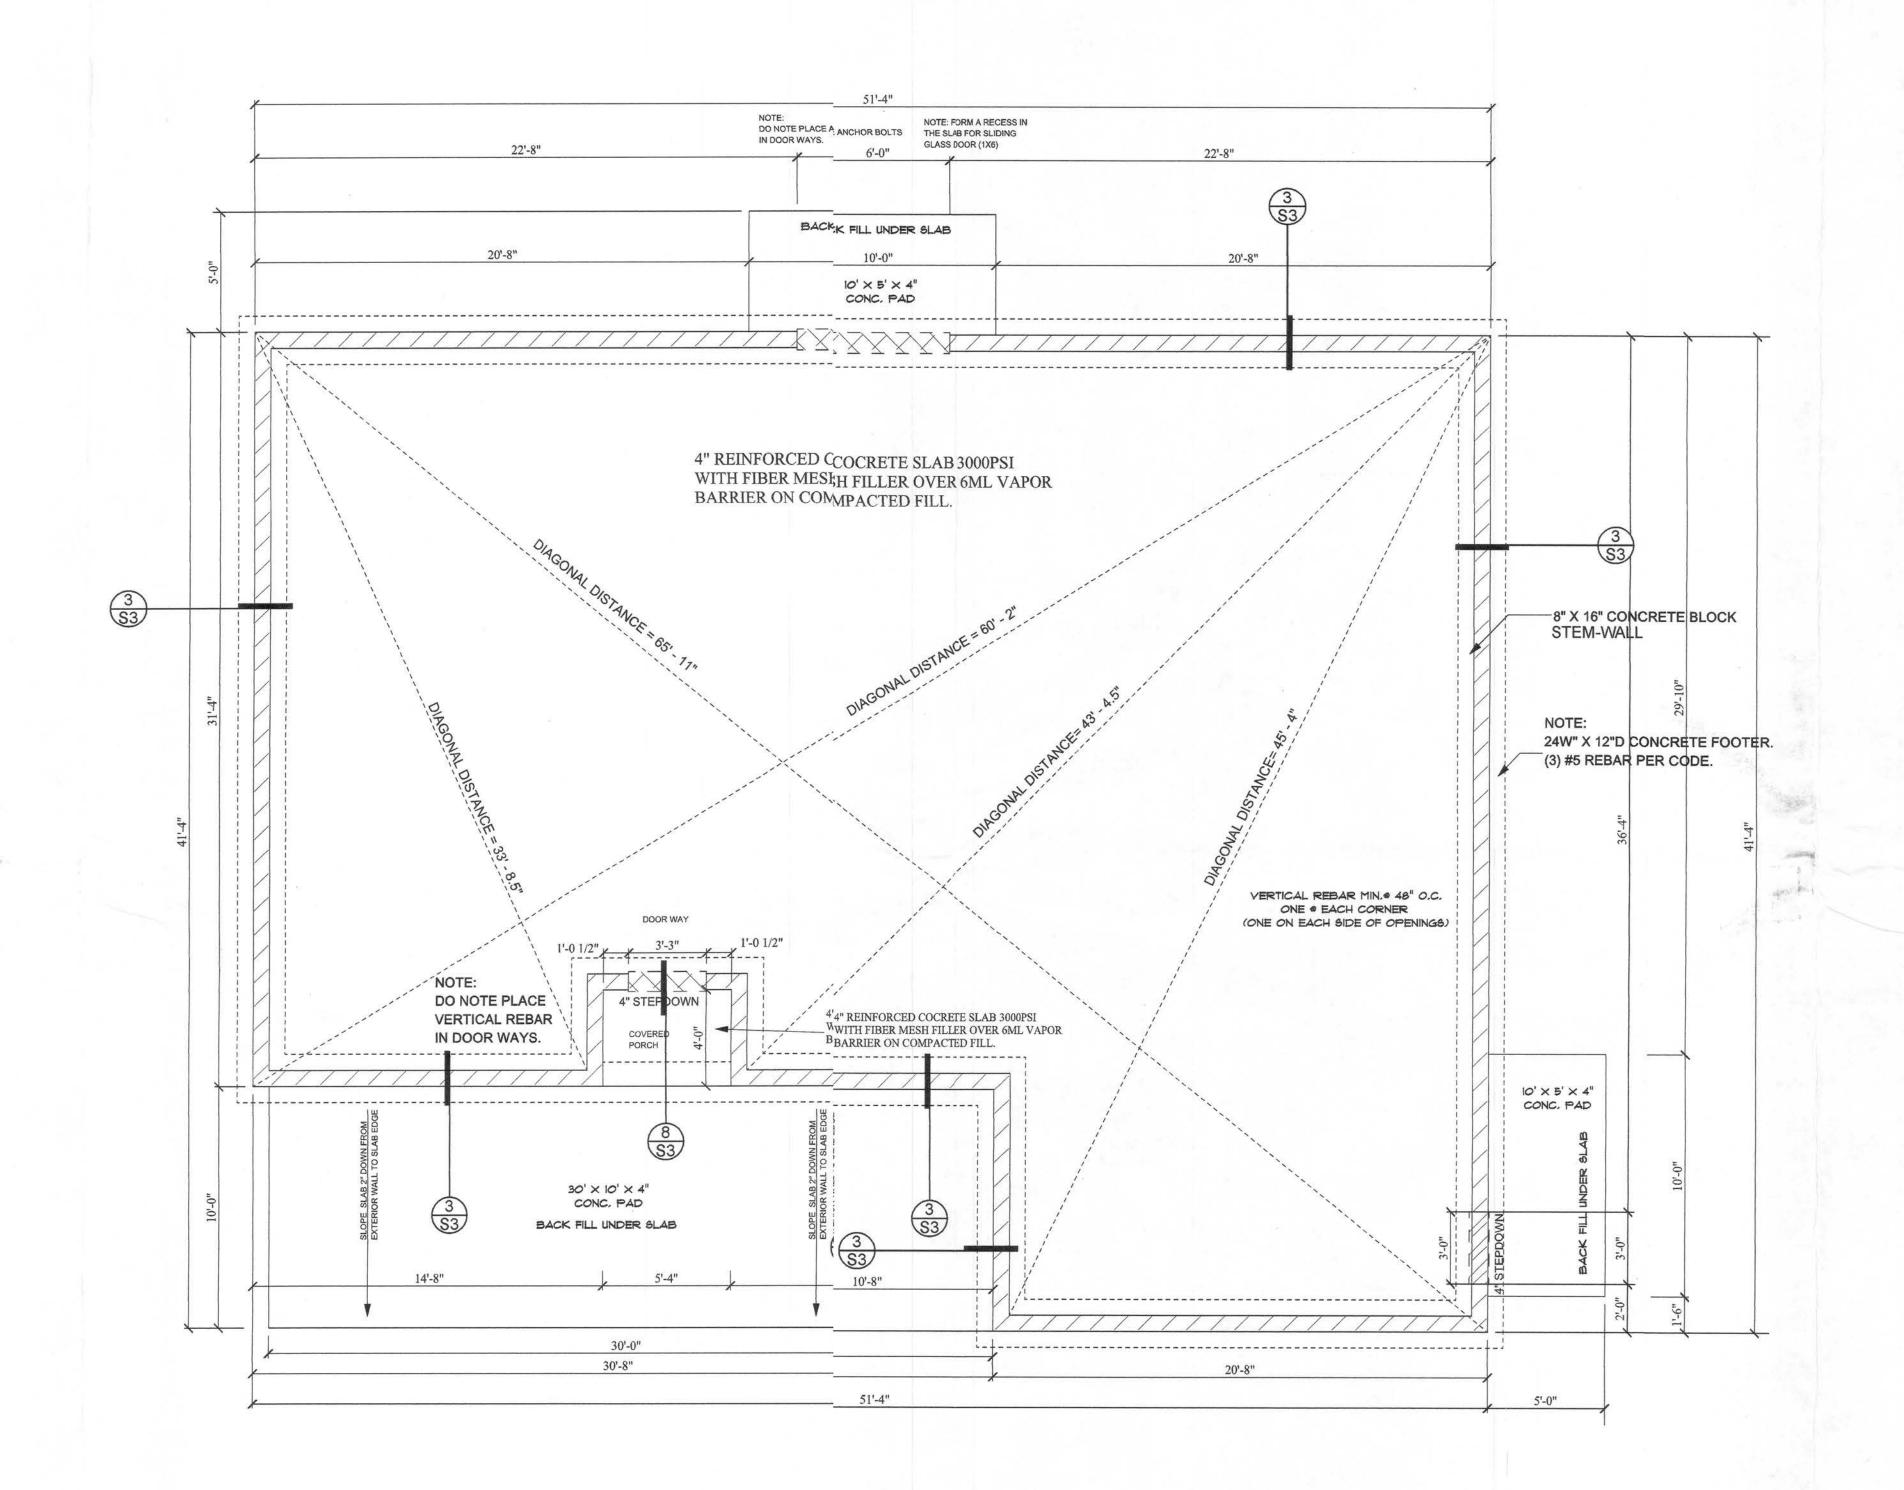STRUCTURAL ONLY THOMAS E. BEITELMAN LICENSE #51870

High Springs, I

Engineering,

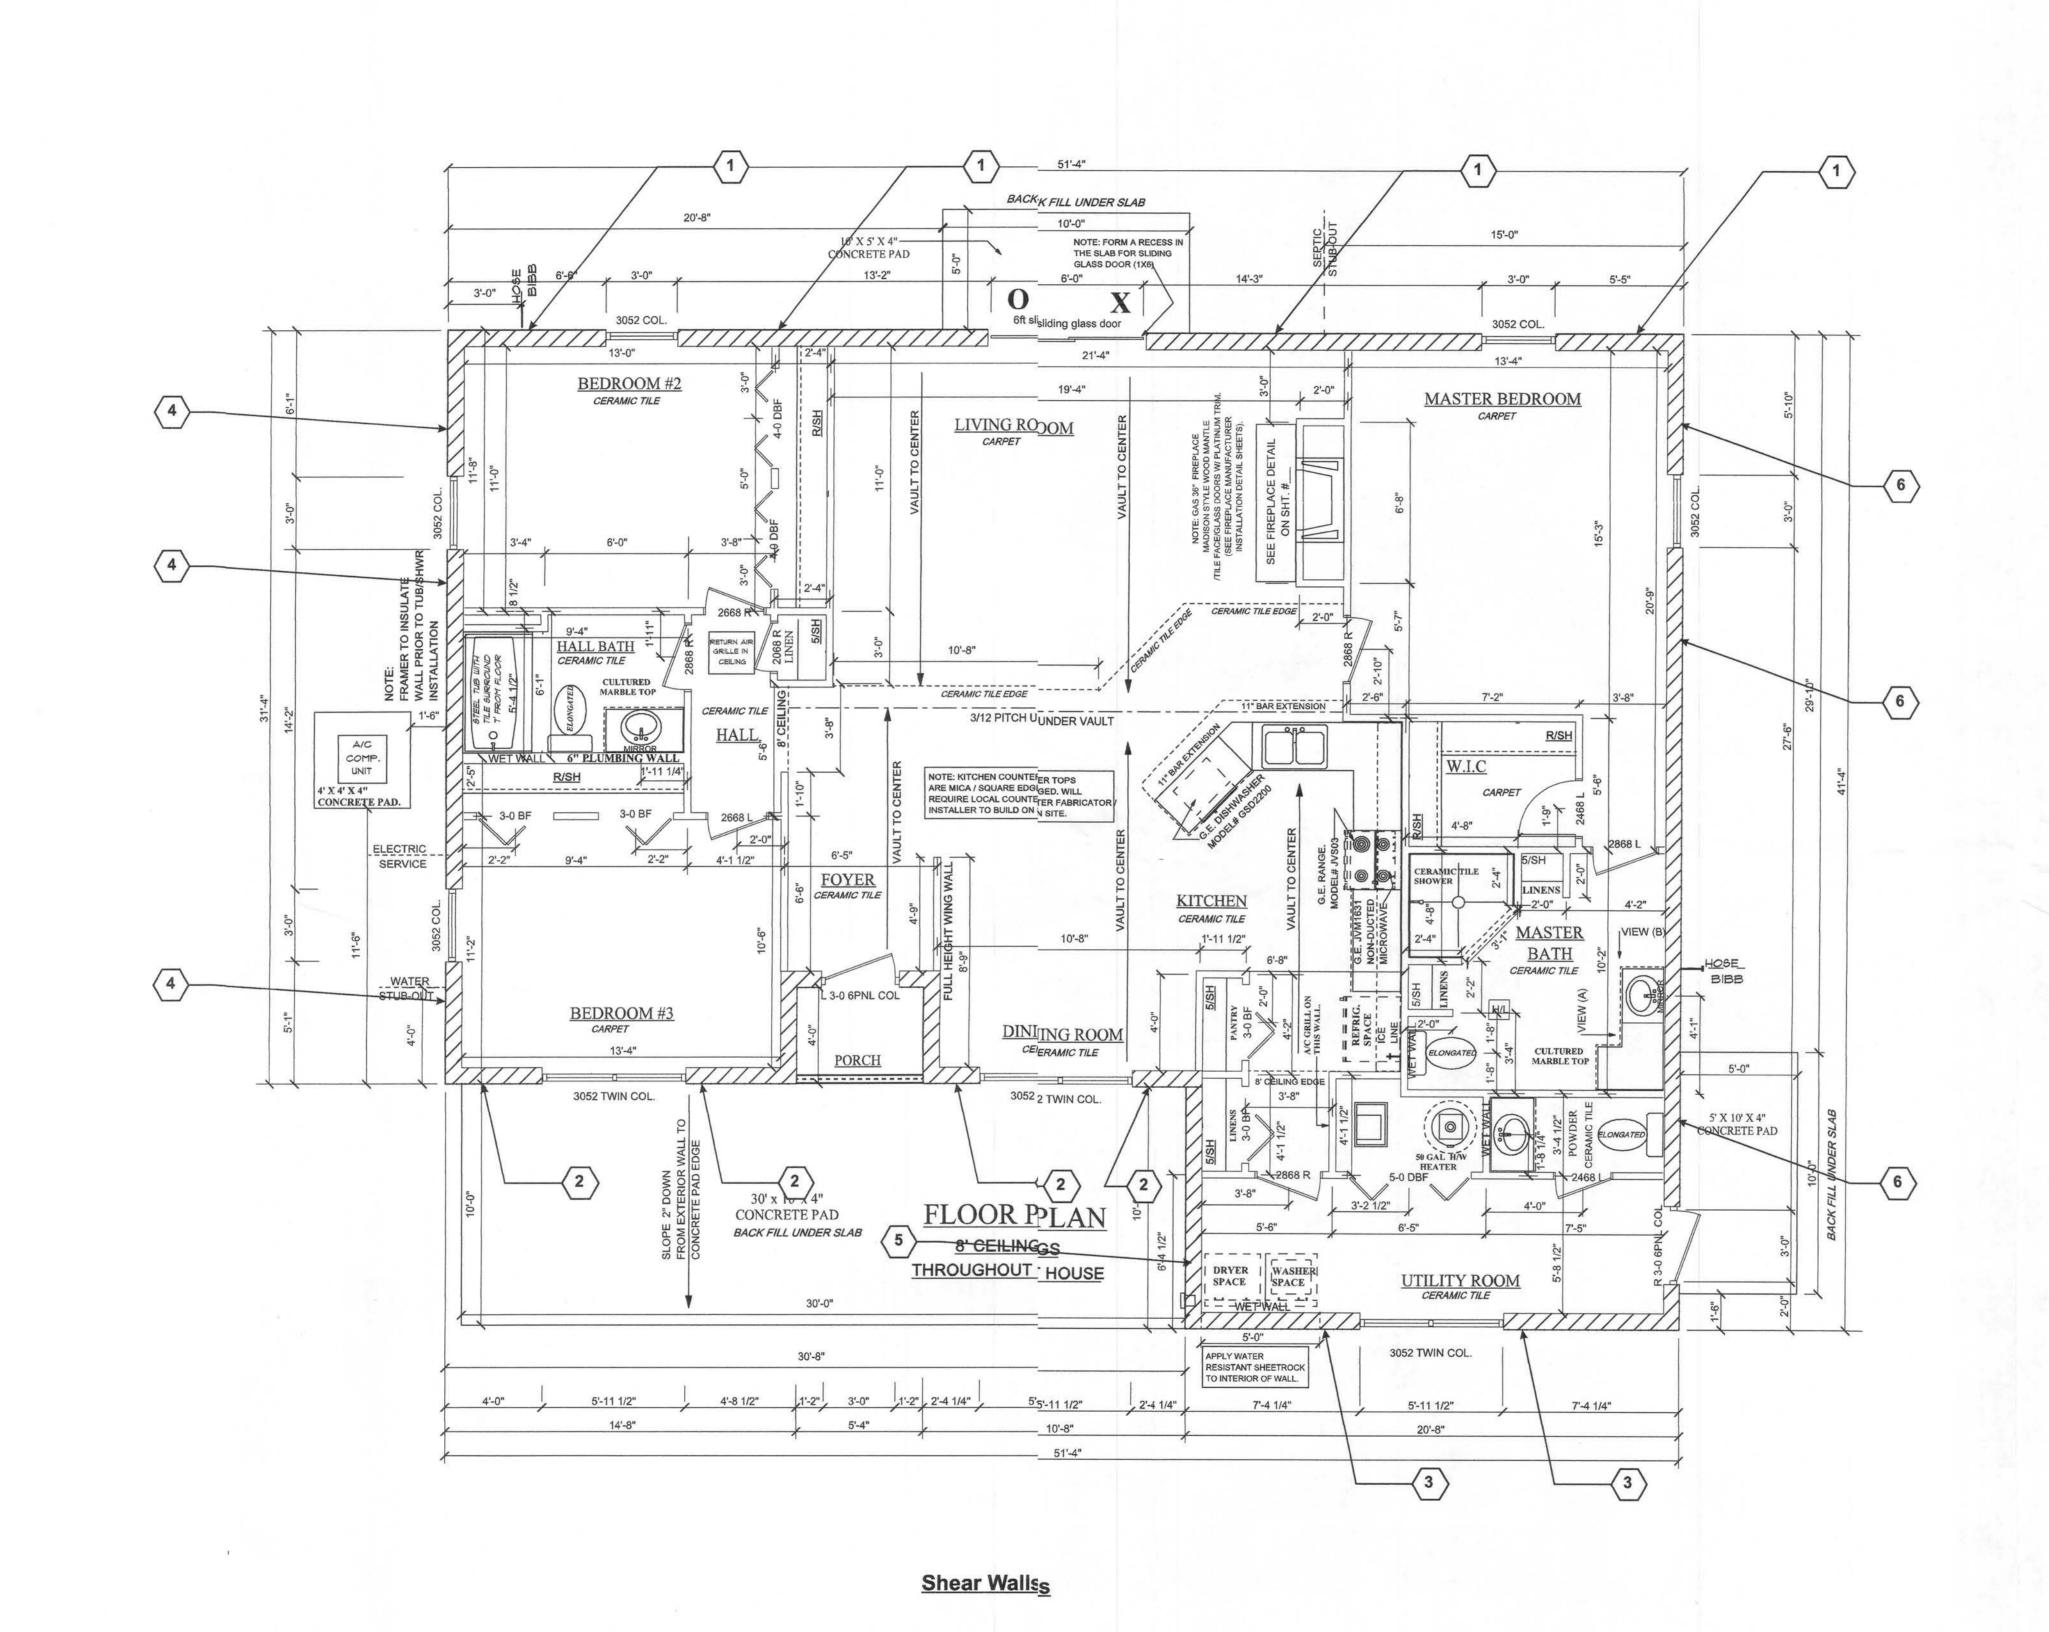

Shear-Wall Identification Number See Sheet S2 for specifications


Engineering Structural E. William E. Douglas Sound


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Sheet S12 of 3 0(S-567


STRUCTURAL ONLY THOMAS E. BEITELMAN LICENSE #51870

Copyright Sound Structures Engineering, Inc. 2004



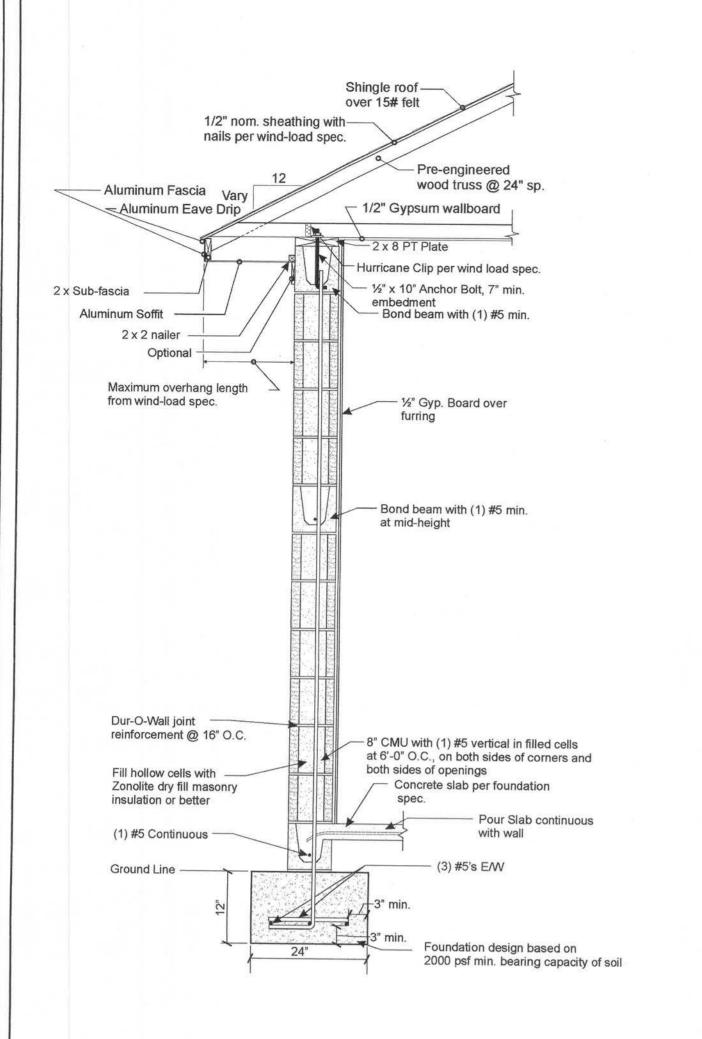

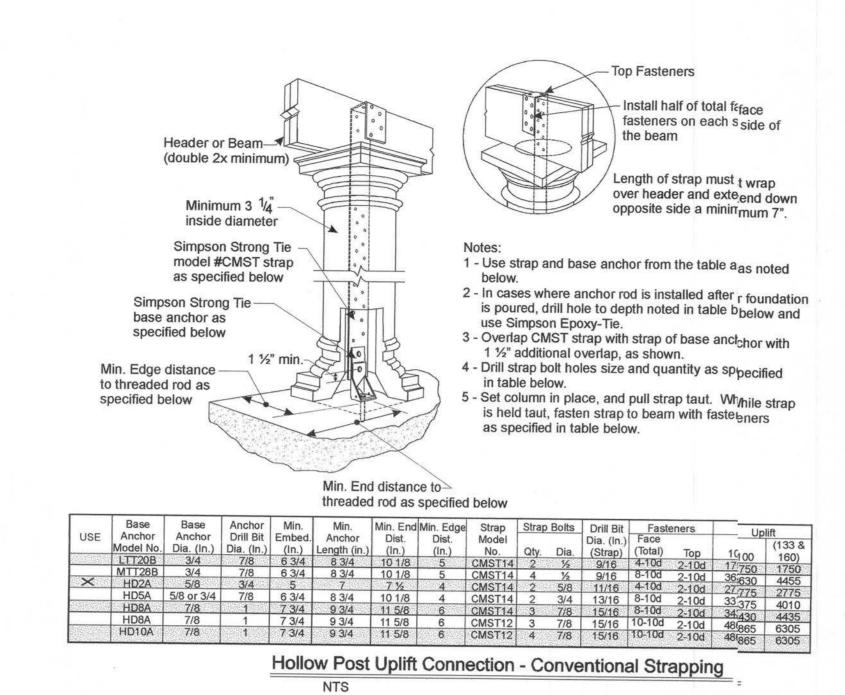Typical Exterior Wall Section
Scale: 3/4"=1'-0"

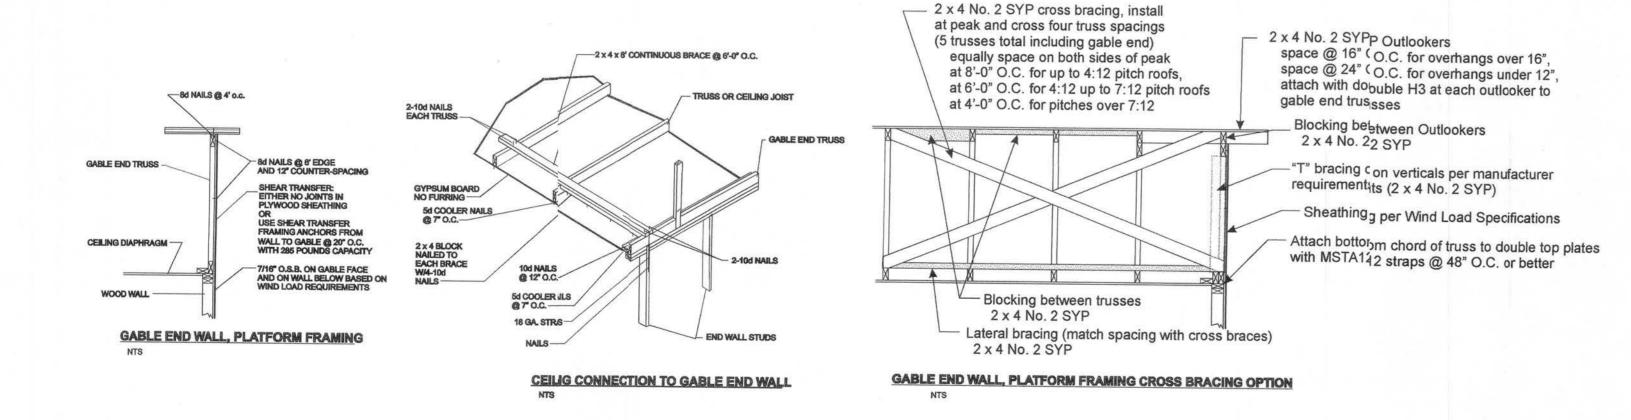

GABLE DETAILS

WIND ANALYSIS - 110 MPH, 3 Second Gust Wind Velocity

ANCHOR BOLTS: 1/2" dia. X 10" LONG w/2" washers


Prepared By:		Thomas E. Bei	itelman			Design Professiona	d EL Lie #	4.	5107	0
Importance fa		Building Catego	ory:	П		Wind Exposure (s)			5187	
Internal Press	sure Coefficie	ent:	0.18			white Exposure (s)	-		Exposure B	ř.
Plans may be	used as a ma	ster plan by the above	contractor:	Yes	or	No (circle one)	Init	ials:	Т	EB
Mean Roof H	leight:	22.2 ft	i			Stud Species:	CDI			
Species for To		SPF or		- Masonry				or	SYP	NA - Masonry
End Zone Lea		6.3 ft	211 1111	wiasomy		Max. Stud Ht. (exc. Stud Spacing:	\$2.50 P. S. S.			Masonry
Roof Slope:	32.5-5-5-	6 : 12	2			Max. Overhang Lei		NA - Maso		12 "
HURRICAN Brand: Simpson Stro		Truss Span or Lo	ocation Truss Location	ns		Model # @ Zone 1 - META	End	Mod	el # @ or Zone ETA12	
	**Note: Tri	**Top Plate	not required the at time of and	when TSS	Tru ane c	ass Seat Snap in is ins clip sizes above are based	stalled with	this conne	ector! ned hip roof!	7
ROOF SHEA						3 Sheathing				
Fastener	8d	NAILING	Eda	es (perimet				(D6	specific suc	h as 7/16" OSB)

	PATTERN:	6"	0.C.	12"	o.c.	
WALL BRACING:	8" (CMU		100% continuous o	r as required:	See Note 1, below.
Fastener	NAILING	Edges (perimeter)		Field	- uo requireu.	Sec Note 1, below.
	PATTERN:		0.C.		o.c.	
STRAPS: Brand NA - Masonry	Specing Let ELD	Тор			I	Bottom
Model	Spacing 1st FLR 2nd FLR	-		0.C.		O.C.
	ZIIU FLR			0.c.		0.C.
Nailing:						

Wind Load Analysis Results

First Story Level

Wall Number	Length (ft)	Unit Shear (plf)	Capacity (lbs)	Actual Load (lbs)	% Used	Location
		Lc	ongitudinal Wai	lls		
1	39.3	100.3	47200.0	3946.8	8.4	Exterior
2	13.3	101.5	16000.0	1353.9	8.5	Exterior
3	14.7	114.6	17600.0	1681.4	9.6	Exterior
		T	ransverse Wall.	S	0	LACTIO
4	25.3	117.3	30400.0	2971.9	9.8	Exterior
5	10.0	98.8	12000.0	987.9	8.2	Exterior
6	33.3	112.4	40000.0	3747.0	9.4	Exterior

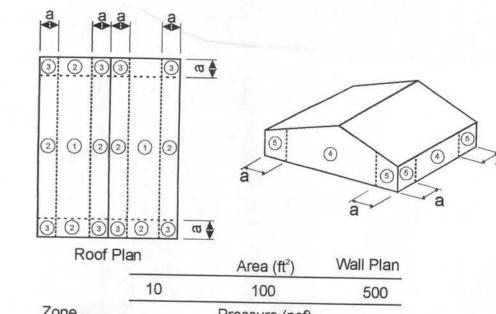

Roof F	Plan	Area (ft²)	Wall Pla
	10	100	500
Zone			
1	-19.9	Pressure (psf) -18.1	-18.1
2	-34.7	-25.5	-25.5
3	-51.3	-40.2	-40.2
1,2 and 3	12.5	8.9	8.9
2 (Overhang)	-43.9	-43.9	-43.9
3 (Overhang)	-71.6	-49.4	-49.4
4	-23.6	-20.3	-18.1
5	-29.1	-22.7	-18.1
4 and 5	21.8	18.4	16.2

Component and Cladding Design Pressures
(Worst Case Only)

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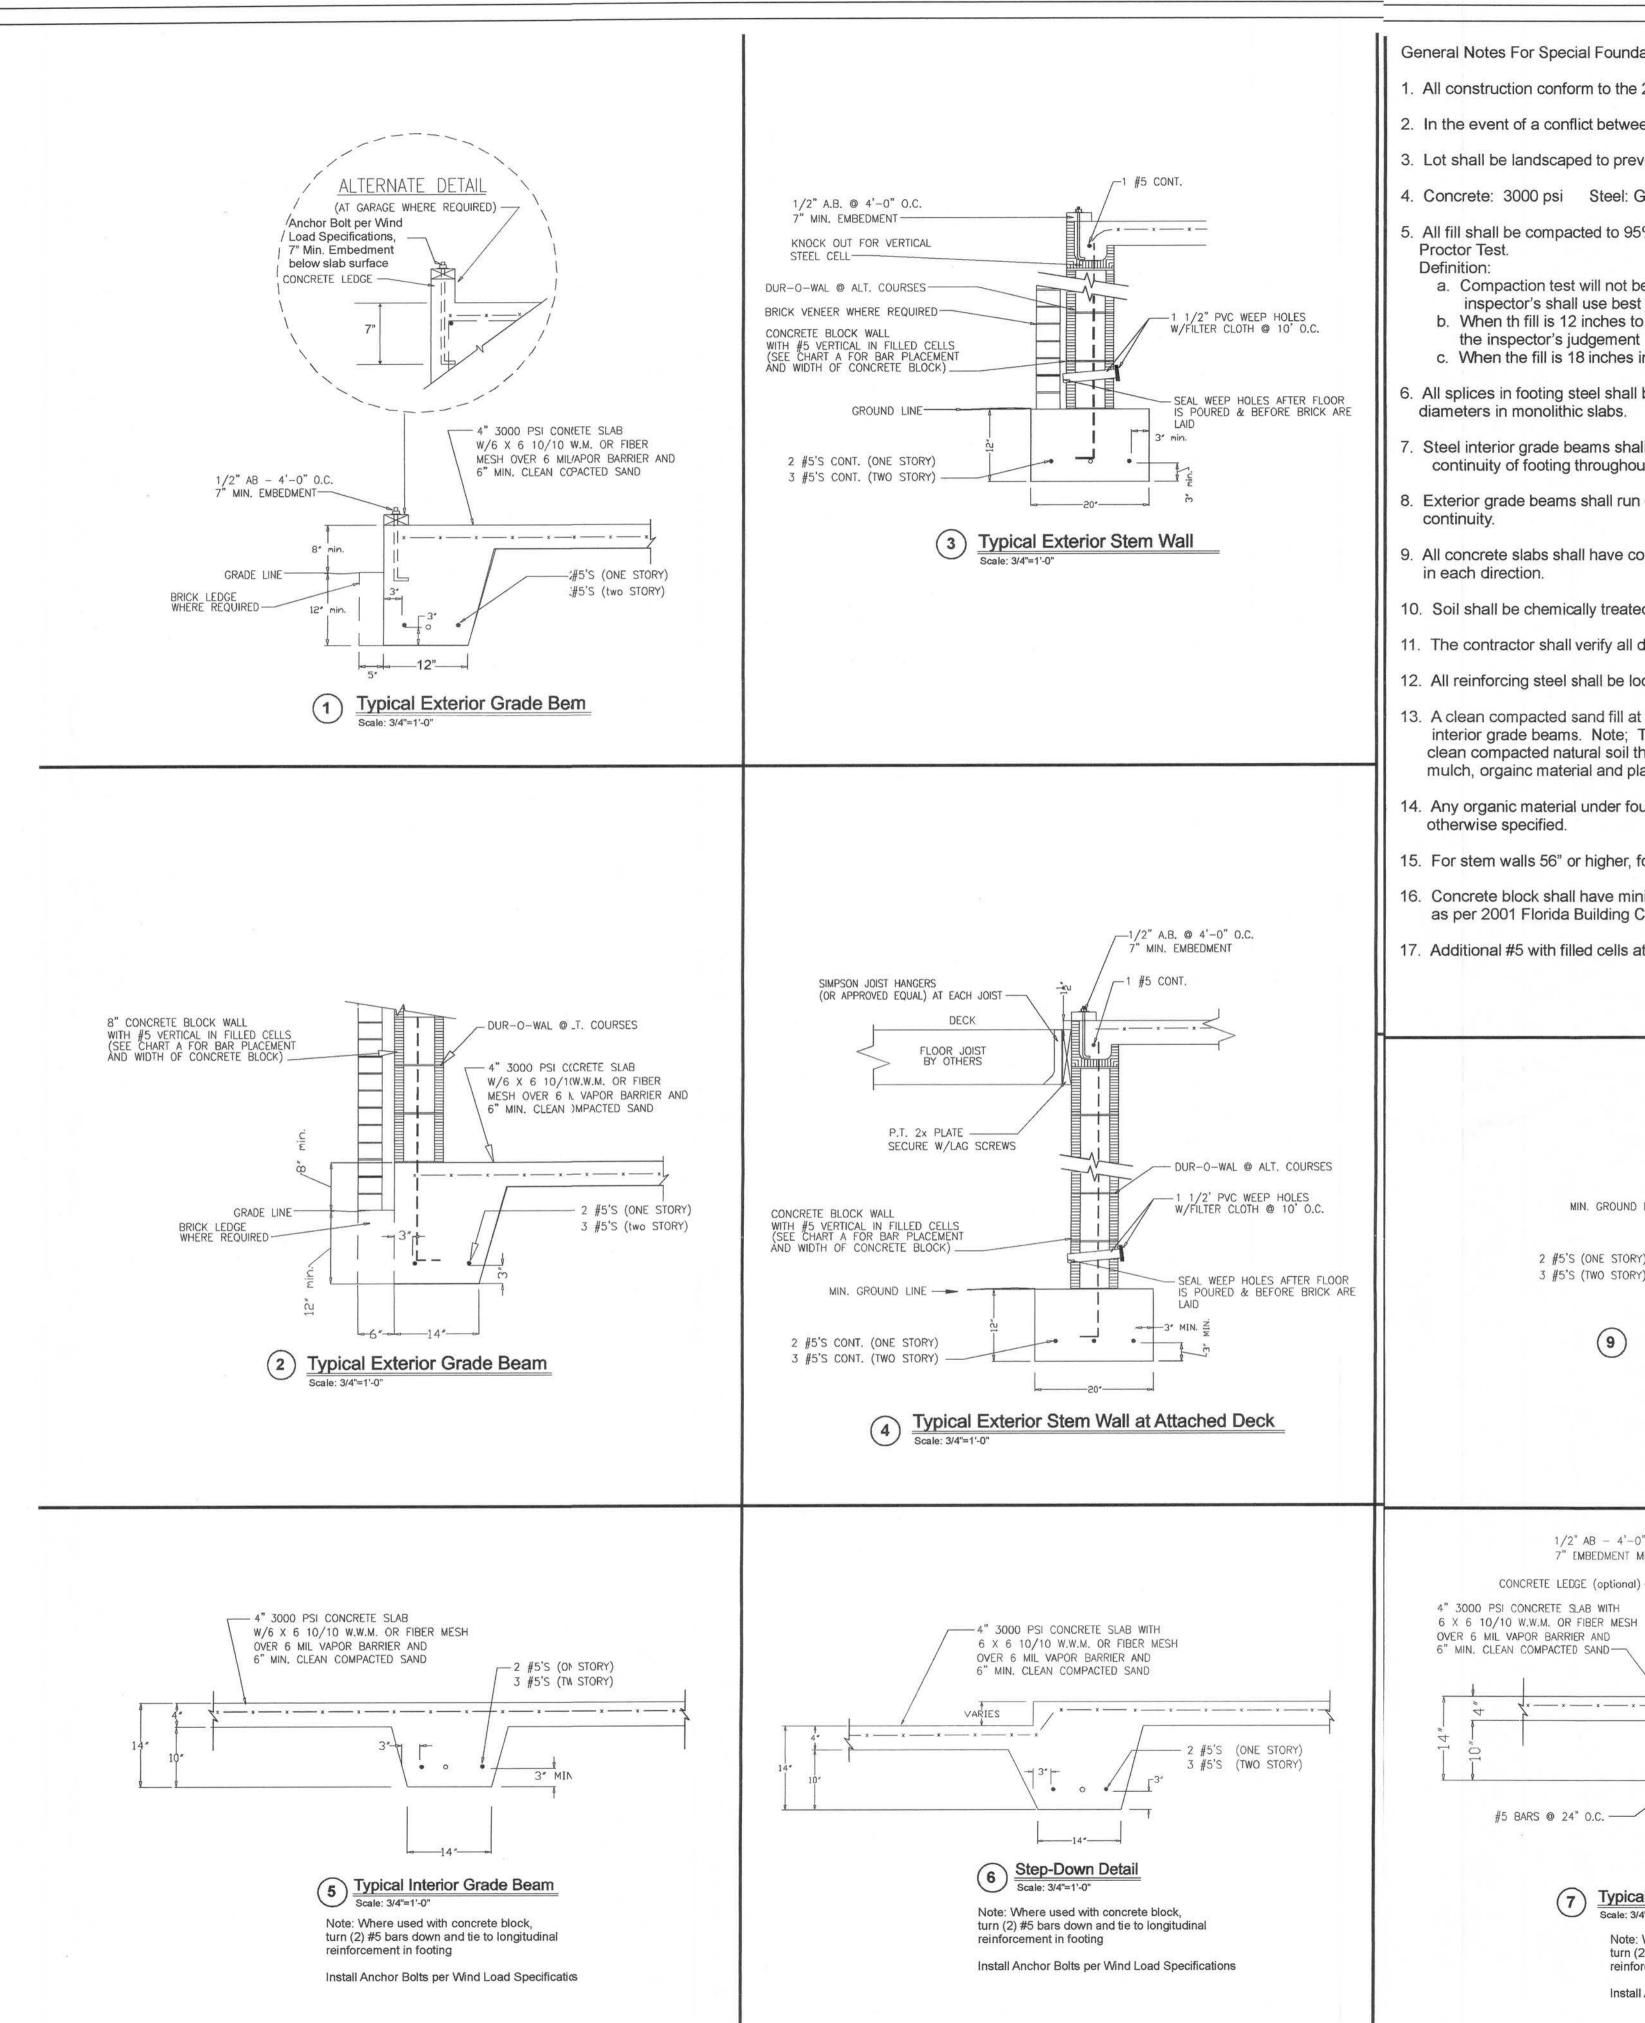
From Each Corner

S

High

PROJEC
TITLE: Structu
File Name: 06S-567.0
Designed: TEB
Drawn: TEB
Checked: TEB
Checked: 6/7/07 Sheet S2 of 3

)6S-567




General Notes For Special Foundation

- 1. All construction conform to the 2004 Florida Building Code with 2006 revisions.
- 2. In the event of a conflict between plans and the codes, the codes shall govern.
- 3. Lot shall be landscaped to prevent the detention of surface water.
- 4. Concrete: 3000 psi Steel: Grade 60
- 5. All fill shall be compacted to 95% of maximum dry density as determined by the Modified Proctor Test. Definition:
- a. Compaction test will not be required when the fill is less than 12 inches in depth, the inspector's shall use best judgement.
- b. When th fill is 12 inches to 18 inches in depth, compaction test will be required only if the inspector's judgement is that the compaction is questionable.
- c. When the fill is 18 inches in depth or more, compaction test will be required.
- 6. All splices in footing steel shall be lapped 40 bar diameters in concrete block and 30 bar diameters in monolithic slabs.
- 7. Steel interior grade beams shall be spliced to steel in exterior grade beams to assure continuity of footing throughout structure.
- 8. Exterior grade beams shall run continuous around the perimeter of the structure to assure continuity.
- 9. All concrete slabs shall have control joints to control cracking spaced maximum of 15 feet in each direction.
- 10. Soil shall be chemically treated for termites.
- 11. The contractor shall verify all dimensions at the site prior to beginning construction.
- 12. All reinforcing steel shall be located ma min. 3" from concrete surface.
- 13. A clean compacted sand fill at least 18 inches thick shall be placed under all exterior and interior grade beams. Note; This may be omitted in areas that have at least 30 inches of clean compacted natural soil that has minimum bearing capacity of 2000 psf and is free of mulch, orgainc material and plastic clays and consist of at least 50% sand (ext.)
- 14. Any organic material under foundation shall be removed prior to construction, unless otherwise specified.
- 15. For stem walls 56" or higher, formwork shall be braced before backfilling.
- 16. Concrete block shall have minimum compressive strength of 1500 psi (Grade N-1 or better) as per 2001 Florida Building Code Table 2106.2.
- 17. Additional #5 with filled cells at load bearing points on walls.

1/2" AB - 4'-0" O.C. 7" EMBEDMENT MINIMUM

CONCRETE LEDGE (optional) —

#5 BARS @ 24° O.C. -

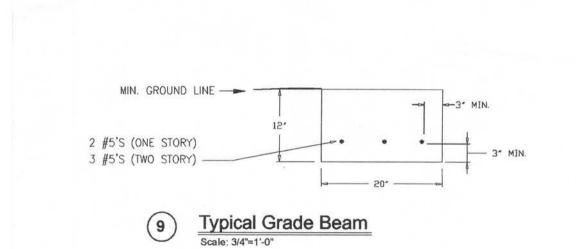

Typical Interior Grade Beam With Optional Curb

Note: Where used with concrete block,

reinforcement in footing

turn (2) #5 bars down and tie to longitudinal

Install Anchor Bolts per Wind Load Specifications

- 2 #5'S (ONE STORY)

3 #5'S (TWO STORY)

CHART A VERTICAL BAR PLACEMENT FOR BLOCK WALL WITH CONCRETE FLOOR SLAB OR JOIST DESIGN

For floor joist design use bond beam with (1) #5 reinforced bar continuous for slab floor, pour into block with welded wire mesh. (See chart below)

In all cases vertical bars shall be placed at either side of openings in wall and at each corner. Vertical bars shall be bent 24" into slab, each reinforced cell shall be filled with concrete.


***Floor system to be placed before backfilling

8"	No. 5 @ 72" O.C.
8"	No. 5 @ 48" O.C.
8"	No. 5 @ 32" O.C.
12"	No. 5 @ 32" O.C. with bond beam with (1) #5 at mid-height
8"*	No. 5 @ 32" O.C. *(8" block may be used only if neither side of wall has soil bearing pressure. A bond beam with (1) #5 shall be provided at mid-height.
12"	No. 5 @ 24" O.C. with bond beam with (1) #5 at mid-height
8"*	No. 5 @ 24" O.C. *(8" block may be used only if neither side of wall has soil bearing pressure. A bond beam with (1) #5 shall be provided at mid-height.
12"	No. 5 @ 16" O.C. (All cells filled with 3000 psi concrete) with bond beam with (1) #5 at mid-height
8"*	No. 5 @ 24" O.C. *(8" block may be used only if neither side of wall has soil bearing pressure. A bond beam with (1) #5 shall be provided at mid-height.
12"	No. 5 @ 8" O.C. (All cells filled with 3000 psi concrete) with bond beam with (1) #5 at mid-height
8"*	No. 5 @ 24" O.C. *(8" block may be used only if neither side of wall has soil bearing pressure. A bond beam with (1) #5 shall be provided at mid-height.
	8" 12" 8"* 12" 8"* 12" 12"

PHYSICAL PROPERTIES OF MASONRY CEMENTS

Masonry Cement Type	N	*S	*M
Time of setting			
Initial set, minimum, hr.	2	1 1/2	1 1/2
Final set, maximum, hr.	2 24	24	24
Compressive strength			
(average of 3 cubes, min.)		1	
7 days, (psi)	500	1300	1800
28 days (psi)	900	2100	2900

*For the purpose of these plans, use grade "S" or "M"

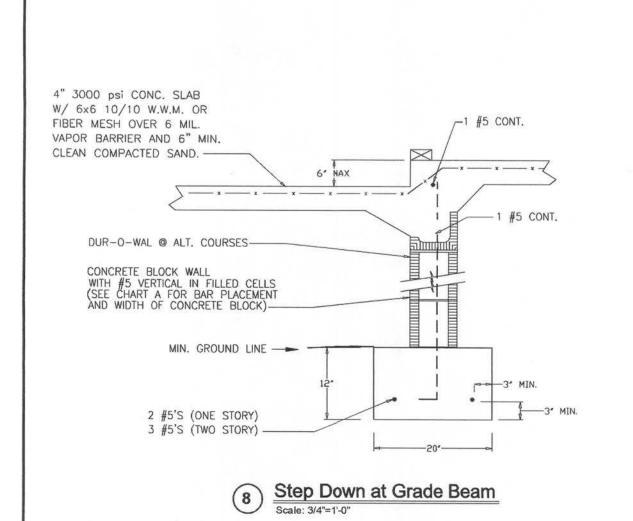

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