T--Mobile * stick together*

WHITE SPRINGS


26972 NORTH US HIGHWAY 441 WHITE SPRINGS, FLORIDA 32096 (COLUMBIA COUNTY)

9JK1918A

NEXTOWER NAME/SITE#: SW HWY 47 / NXFL-171

MICROWAVE PROJECT

PROPOSED MODIFICATION TO EXISTING T-MOBILE ANTENNAS ON A 250' SELF-SUPPORT TOWER

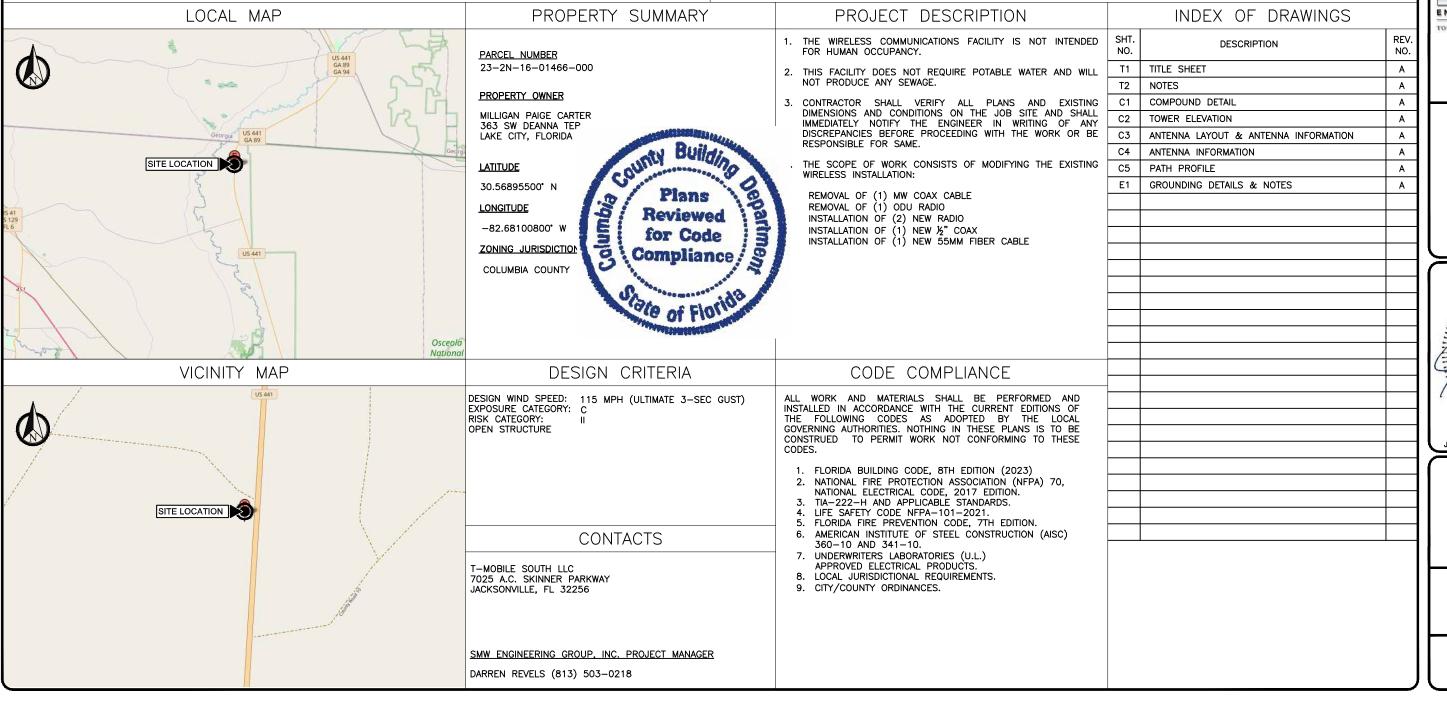

	01/02/27		I INCLIMITEDING
0	02/05/24		CONSTRUCTION
PROJ	ECT NO.:		17-5641.1
	DRAWN BY:		RA
PRO	JECT MANAG	ER:	D. REVELS
	CHECKED BY	· .	D. REVELS

THIS DRAWING IS COPYRIGHTED AND IS THE SOLE PROPERTY OF THE OWNER. IT IS PRODUCED SOLELY FOR USE BY THE OWNER AND ITS AFFILIATES. REPRODUCTION OR USE OF THIS DRAWING AND/OR THE INFORMATION CONTAINED IN IT IS FORBIDDEN WITHOUT THE WRITTEN PERMISSION OF THE OWNER.



12979 N TELECOM PARKWAY TEMPLE TERRACE, FLORIDA 33637 (813) 615-1422

CERTIFICATE OF AUTHORIZATION 33693



7025 A.C. SKINNER PARKWAY



JEREMY D. SHARIT PE FL LIC 75137

WHITE SPRINGS

9JK1918A

26972 NORTH US HIGHWAY 441 WHITE SPRINGS, FLORIDA 32096 (COLUMBIA COUNTY)

SHEET NAME

TITLE SHEET

SHEET NUMBER

T1

1. FOR THE PURPOSES OF THESE CONSTRUCTION DRAWINGS, THE FOLLOWING DEFINITIONS SHALL APPLY:

OWNER - T-MOBILE SOUTH LLC

ENGINEER - SMW ENGINEERING GROUP, INC.

CONTRACTOR - GENERAL CONTRACTOR (CONSTRUCTION)

- PRIOR TO SUBMITTING HIS BID, THE CONTRACTOR SHALL VISIT THE JOB SITE IN ORDER TO (1) VERIFY ALL
 EXISTING CONDITIONS, (2) CONFIRM WHETHER ALL DIMENSIONS ARE AS SHOWN ON THE PLANS AND (3)
 CONFIRM WHETHER THE WORK MAY BE ACCOMPLISHED AS SHOWN. ANY DISCREPANCIES SHALL BE BROUGHT
 TO THE ATTENTION OF THE CONSTRUCTION MANAGER.
- 3. A 20-FOOT HORIZONTAL CLEARANCE DISTANCE SHALL BE MAINTAINED FROM ALL EXISTING POWER LINES.
- 4. THE CONTRACTOR'S USE OF A CONSTRUCTION STAGING AREA SHALL BE COORDINATED WITH THE OWNER WELL IN ADVANCE OF THE CONSTRUCTION START DATE.
- 5. LABOR, MATERIAL, TOOLS, EQUIPMENT, TRANSPORTATION AND TEMPORARY POWER SERVICES NECESSARY FOR AND INCIDENTAL TO COMPLETION OF ALL WORK SHALL BE PROVIDED AS INDICATED ON THE DRAWINGS AND/OR AS SPECIFIED HEREIN. LABOR AND MATERIALS SHALL BE FURNISHED AS REQUIRED FOR COMPLETE SYSTEMS, INCLUDING ALL ELEMENTS OBVIOUSLY OR REASONABLY INCIDENTAL TO A COMPLETE INSTALLATION, WHETHER OR NOT SPECIFICALLY INDICATED ON THE PLANS.
- 6. FOR TASKS REQUIRED TO BE PERFORMED BUT NOT CLEARLY DEFINED OR IDENTIFIED BY THE CONTRACT DOCUMENTS, THE CONTRACTOR SHALL NOT START WORK ON SUCH TASKS WITHOUT HAVING RECEIVED WRITTEN AUTHORIZATION FROM THE CONSTRUCTION MANAGER TO PROCEED.
- 7. THE DRAWINGS ARE DIAGRAMMATIC AND INDICATE THE GENERAL ARRANGEMENT OF SYSTEMS AND EQUIPMENT UNLESS OTHERWISE INDICATED BY DIMENSIONS OR DETAILS. EXACT EQUIPMENT LOCATIONS MAY BE MODIFIED AS REQUIRED BY ACTUAL FIELD CONDITIONS. IF THE SPECIFIED EQUIPMENT CANNOT BE INSTALLED AS SHOWN ON THESE DRAWINGS, CONTRACTOR SHALL PROPOSE AN ALTERNATIVE INSTALLATION FOR APPROVAL BY THE ENGINEER AND THE CONSTRUCTION MANAGER.
- 8. THE CONTRACTOR SHALL OBTAIN, PAY FOR AND DELIVER ALL REQUIRED PERMITS, CERTIFICATES OF INSPECTION, INCLUDING UTILITY CONNECTION FEES, ETC., REQUIRED BY THE AUTHORITIES HAVING JURISDICTION AND SHALL DELIVER SUCH DOCUMENTS TO THE OWNER PRIOR TO FINAL ACCEPTANCE OF THE WORK
- 9. THE CONTRACTOR'S OPERATIONS SHALL BE CONFINED TO AREAS OF NEW CONSTRUCTION.
- 10. ALL NECESSARY PROVISIONS SHALL BE MADE TO PROTECT EXISTING IMPROVEMENTS, LANDSCAPING, PAVING, CURBS, GALVANIZED SURFACES, ETC, AND THE CONTRACTOR SHALL BE RESPONSIBLE FOR ANY DAMAGE TO SAME RESULTING FROM THE CONSTRUCTION WORK. ALL DISTURBED AND DAMAGED AREAS SHALL BE RESTORED TO THEIR ORIGINAL CONDITION OR BETTER UPON COMPLETION OF ALL WORK TO THE SATISFACTION OF THE CONSTRUCTION MANAGER.
- 11. THE FOLLOWING CLEANUP TASKS SHALL BE PERFORMED AS FOLLOWS: (1) ON A DAILY BASIS, KEEP THE GENERAL AREA CLEAN AND HAZARD FREE, REMOVING ALL WASTE, DEBRIS AND TRASH FROM THE SITE AND DISPOSING OF SAME IN A LEGAL MANNER. (2) UPON COMPLETION, LEAVE THE PREMISES IN A CLEAN CONDITION AND FREE FROM PAINT SPOTS, DUST, OR SMUDGES OF ANY NATURE.
- 12. ALL EQUIPMENT AND MATERIALS SHALL BE INSTALLED IN ACCORDANCE WITH THE RESPECTIVE MANUFACTURER'S RECOMMENDATIONS EXCEPT WHERE IT IS SPECIFICALLY INDICATED OTHERWISE IN THE CONTRACT DOCUMENTS OR WHERE LOCAL CODES OR REGULATIONS TAKE PRECEDENCE.
- 13. ALL WORK PERFORMED AND MATERIALS INSTALLED SHALL BE IN STRICT ACCORDANCE WITH ALL APPLICABLE CODES, REGULATIONS AND ORDINANCES. THE CONTRACTOR SHALL GIVE ALL NOTICES AND COMPLY WITH ALL LAWS, ORDINANCES, RULES, REGULATIONS AND LAWFUL ORDERS OF ANY PUBLIC AUTHORITY HAVING JURISDICTION OVER THE PERFORMANCE OF THE WORK. MECHANICAL AND ELECTRICAL SYSTEMS SHALL BE INSTALLED IN ACCORDANCE WITH ALL APPLICABLE MUNICIPAL AND UTILITY COMPANY SPECIFICATIONS AS WELL AS LOCAL AND STATE CODES, ORDINANCES AND APPLICABLE REGULATIONS.
- 14. THE CONTRACTOR SHALL SUPERVISE AND DIRECT THE WORK AT ALL TIMES, USING THE BEST SKILLS AND ATTENTION. HE SHALL BE SOLELY RESPONSIBLE FOR ALL OF THE CONSTRUCTION MEANS, METHODS, TECHNIQUES, SEQUENCES AND PROCEDURES AND FOR COORDINATING ALL PORTIONS OF THE WORK, INCLUDING CONTACT AND COORDINATION WITH THE CONSTRUCTION MANAGER AND WITH THE OWNER'S AUTHORIZED REPRESENTATIVE.
- 15. WITHIN TEN (10) WORKING DAYS AFTER PROJECT COMPLETION, THE CONTRACTOR SHALL PROVIDE A COMPLETE SET OF AS—BUILT DRAWINGS, SWEEP TEST, CYLINDER TESTS, LIEN RELEASES, AND OTHER CLOSEOUT DOCUMENTATION AS REQUIRED BY THE OWNER. ALL SYSTEMS SHALL BE COMPLETELY ASSEMBLED, TESTED. ADJUSTED AND DEMONSTRATED TO BE READY FOR OPERATION PRIOR TO THE OWNER'S ACCEPTANCE.

- THE APPROPRIATE UTILITY LOCATING SERVICES SHALL BE CONTACTED PRIOR TO THE START OF CONSTRUCTION IN ORDER TO VERIFY THE EXACT LOCATION OF ALL EXISTING UNDERGROUND UTILITIES.
- 2. THE INSTALLATION OF NEW UTILITIES SHALL BE COORDINATED WITH LOCAL AUTHORITIES
- 3. ALL EXISTING ACTIVE SEWER, WATER, GAS, ELECTRIC AND OTHER UTILITIES, WHERE ENCOUNTERED IN THE WORK, SHALL BE PROTECTED AT ALL TIMES. WHERE REQUIRED FOR THE PROPER EXECUTION OF THE WORK, SUCH UTILITIES SHALL BE RELOCATED AS DIRECTED BY THE CONSTRUCTION MANAGER. EXTREME CAUTION SHALL BE USED WHEN EXCAVATING OR DRILLING PIERS AROUND OR NEAR UTILITIES.
- I. RUBBISH, STUMPS, DEBRIS, STICKS, STONES AND OTHER REFUSE SHALL BE REMOVED FROM THE SITE AND DISPOSED OF LEGALLY.
- . ALL EXISTING INACTIVE SEWER, WATER, GAS, ELECTRIC AND OTHER UTILITIES THAT INTERFERE WITH THE EXECUTION OF THE WORK SHALL BE REMOVED AND/OR CAPPED, PLUGGED OR OTHERWISE DISCONTINUED AT POINTS THAT WILL NOT INTERFERE WITH THE EXECUTION OF THE WORK, SUBJECT TO THE APPROVAL OF THE LANDLORD AND/OR LOCAL UTILITIES.
- 6. DISTURBANCE TO THE EXISTING SITE DURING CONSTRUCTION SHALL BE MINIMIZED.
- 7. ANY AREAS OF THE CONSTRUCTION SITE DISTURBED BY THE WORK AND NOT COVERED BY THE TOWER, EQUIPMENT OR DRIVEWAY, SHALL BE GRADED TO A UNIFORM SLOPE. SUCH GRADING SHALL CAUSE SURFACE WATER TO FLOW AWAY FROM ANY EQUIPMENT SHELTER AND TOWER AREAS AND THE SOIL SHALL BE STABILIZED TO PREVENT EROSION. EROSION CONTROL MEASURES,IF REQUIRED DURING CONSTRUCTION, SHALL BE IN CONFORMANCE WITH THE LOCAL GUIDELINES FOR EROSION AND SEDIMENT CONTROL.
- 8. THE SUB-GRADE SHALL BE COMPACTED AND BROUGHT TO A UNIFORM GRADE PRIOR TO FINISHED SURFACE APPLICATION.
- 9. BACKFILL SHALL CONSIST OF CLEAN SAND FILL APPROVED FOR USE BY THE ENGINEER. NO UNAPPROVED MATERIAL WILL BE ALLOWED. CLEAN SAND FILL SHALL BE FREE OF ALL ROOTS. BOULDERS. OR OTHER DELETERIOUS MATERIAL.
- 10. THE CONTRACTOR SHALL RESTORE ALL DISTURBED AREAS TO EQUAL TO OR BETTER CONDITION THAN ORIGINAL.
- 11. SITE SIGNAGE SHALL BE PROVIDED IN ACCORDANCE WITH THE TECHNICAL SPECIFICATIONS FOR SUCH SIGNAGE AS MAY BE CONTAINED IN THESE DRAWINGS.

SITE WORK NOTES

2 | 7

1. ALL STRUCTURAL STEEL WORK SHALL CONFORM TO THE LATEST EDITION OF THE AISC "STEEL CONSTRUCTION MANUAL".

2. MATERIAL:

- A. ALL STRUCTURAL STEEL WF BEAMS SHALL BE ASTM A992 AND "HOT DIPPED" GALVANIZED IN ACCORDANCE WITH ASTM A123 AND ASTM A153 STANDARDS.
 B. ALL STRUCTURAL PLATES, ANGLES, AND CHANNELS SHALL BE ASTM A36 AND "HOT DIPPED" GALVANIZED IN ACCORDANCE WITH ASTM A123 AND ASTM A153 STANDARDS. UNLESS NOTED OTHERWISE.
- C. ALL HSS/TS MEMBERS SHALL BE ASTM A500 GRADE B (Fy=46ksi), AND "HOT DIPPED" GALVANIZED IN ACCORDANCE WITH ASTM A123 AND ASTM A153 STANDARDS.
- D. ALL STRUCTURAL PIPE MEMBERS SHALL BE ASTM A500 GRADE B (Fy=42ksi), AND "HOT DIPPED" GALVANIZED IN ACCORDANCE WITH ASTM A123 AND ASTM A153 STANDARDS, UNLESS NOTED OTHERWISE
 E. ALL NON-STRUCTURAL PIPE MEMBERS SHALL BE ASTM A53 GRADE B, AND "HOT DIPPED" GALVANIZED IN ACCORDANCE WITH ASTM A123 AND ASTM A153
- E. ALL NON-STRUCTURAL PIPE MEMBERS SHALL BE ASTM A53 GRADE B, AND "HOT DIPPED" GALVANIZED IN ACCORDANCE WITH ASTM A123 AND ASTM A153 STANDARDS.
- 2. DESIGN, FABRICATION, AND CONSTRUCTION OF ALL CONNECTIONS SHALL CONFORM TO AISC STEEL CONSTRUCTION MANUAL.

WELDING:

- . ALL WELDS, WELDERS, AND WELD INSPECTIONS SHALL CONFORM TO THE REQUIREMENTS OF AWS D 1.1, LATEST REVISION.
- B. ALL WELDS SHALL BE MADE WITH E70XX LOW HYDROGEN ELECTRODES.
- C. ALL STEEL SHALL BE SPRAY GALVANIZED AFTER WELDING.
- 4. ALL BOLTS SHALL BE GALVANIZED 3/4" DIAMETER, A325-N, UNLESS NOTED OTHERWISE AND TIGHTENED TO A "SNUG TIGHT" CONDITION AS DEFINED BY AISC. SECURE NUT WITH LOCKING WASHER.
- 5. THE CONTRACTOR/STEEL FABRICATOR SHALL LOCATE ANY REINFORCEMENT IN THE STRUCTURAL MEMBERS IN SUCH A MANNER SO THAT THERE WILL NOT BE CONFLICT WITH THE REINFORCEMENT WHEN INSTALLING ANCHORS. THE ANCHORS SHALL BE INSTALLED PER THE MANUFACTURER'S INSTRUCTION.
- 6. THE CONTRACTOR/STEEL FABRICATOR SHALL CONFORM TO THE MINIMUM EDGE DISTANCE REQUIREMENTS IN ACCORDANCE WITH THE AISC MANUAL OF STEEL CONSTRUCTION.
- 7. ALL STRUCTURAL STEEL SHALL BE FABRICATED TO FIT AT BOLTED CONNECTIONS WITHIN 1/16 INCH TOLERANCE, STRUCTURAL STEEL SHALL NOT BE FLAME CUT UNDER ANY CIRCUMSTANCES WITHOUT APPROVAL OF THE ENGINEER.
- 8. THE CONTRACTOR/STEEL FABRICATOR SHALL CAP OR SEAL ALL PIPES AS REQUIRED TO PREVENT WATER INTRUSION.
- 9. THE CONTRACTOR/STEEL FABRICATOR SHALL SUBMIT SHOP DRAWINGS FOR REVIEW PRIOR TO ANY STEEL FABRICATION. AT THE CONTRACTOR'S OPTION, FIELD SPLICES MAY BE USED FOR ERECTION PURPOSES. IF FIELD SPLICES ARE USED, THE SHOP DRAWINGS SHALL INCLUDE ALL DETAILS FOR THE PROPOSED FIELD SPLICES.
- 10. AT THE CONTRACTOR'S OPTION, SHOP WELDS MAY BE USED INSTEAD OF FIELD WELDS.
- . SUBMIT ORIGINAL SHOP DRAWINGS, INCLUDING COMPLETE DETAILS, SCHEDULES OF FABRICATION AND ASSEMBLY, PROCEDURES, AND DIAGRAMS. INCLUDE DETAILS OF CUTS, CONNECTIONS, CAMBER, HOLE, AND OTHER PERTINENT DATA. INDICATE WELDS BY STANDARD AWS A2.1 AND A2.4 SYMBOLS, AND SHOW SIZE, LENGTH, AND TYPE OF WELD. PROVIDE SETTING DRAWINGS, TEMPLATES, AND DIRECTIONS FOR INSTALLATION OF ANCHOR BOLTS AND OTHER ANCHORAGES TO BE INSTALLED AS WORK OF OTHERS' SECTIONS.

A 01/02/24 PRELIM PLANS
0 02/05/24 CONSTRUCTION

PROJECT NO.: 17-5641.1

DRAWN BY: RA

PROJECT MANAGER: D. REVELS

CHECKED BY: D. REVELS

DESCRIPTION

REV DATE

THIS DRAWING IS COPYRIGHTED AND IS THE SOLE PROPERTY OF THE OWNER. IT IS PRODUCED SOLELY FOR USE BY THE OWNER AND ITS AFFILIATES.
REPRODUCTION OR USE OF THIS DRAWING AND/OR THE INFORMATION CONTAINED IN IT IS FORBIDDEN WITHOUT THE WRITTEN PERMISSION OF THE OWNER.



12979 N TELECOM PARKWAY TEMPLE TERRACE, FLORIDA 33637 (813) 615-1422

CERTIFICATE OF AUTHORIZATION 33693

T - Mobile - stick together

7025 A.C. SKINNER PARKWAY JACKSONVILLE, FL 32256

THIS DOCUMENT HAS BEEN FLECTRONICALLY SIGNED AND SEALED BY JEREMY D. SHARIT, PE (#75137) USING A DIGITAL SIGNATURE IN ACCORDANCE WITH F.A.C. 61G15-23.004, WITH A DIGITAL CERTIFICATE ISSUED BY ENTRUST, INC. PLEASE REFERENCE SHEET TI TO VIEW THE SIGNATURE AND VERIEY ITS PROPERTIES. PRINTED COPIES OF THIS DOCUMENT ARE NOT CONSIDERED SIGNED AND SEALED AND THE SIGNATURE MUST BE VERIFIED ON ANY ELECTRONIC COPIES.

JEREMY D. SHARIT PE FL LIC 75137

WHITE SPRINGS

9JK1918A


26972 NORTH US HIGHWAY 441 WHITE SPRINGS, FLORIDA 32096 (COLUMBIA COUNTY)

SHEET NAME

NOTES

SHEET NUMBER

T2

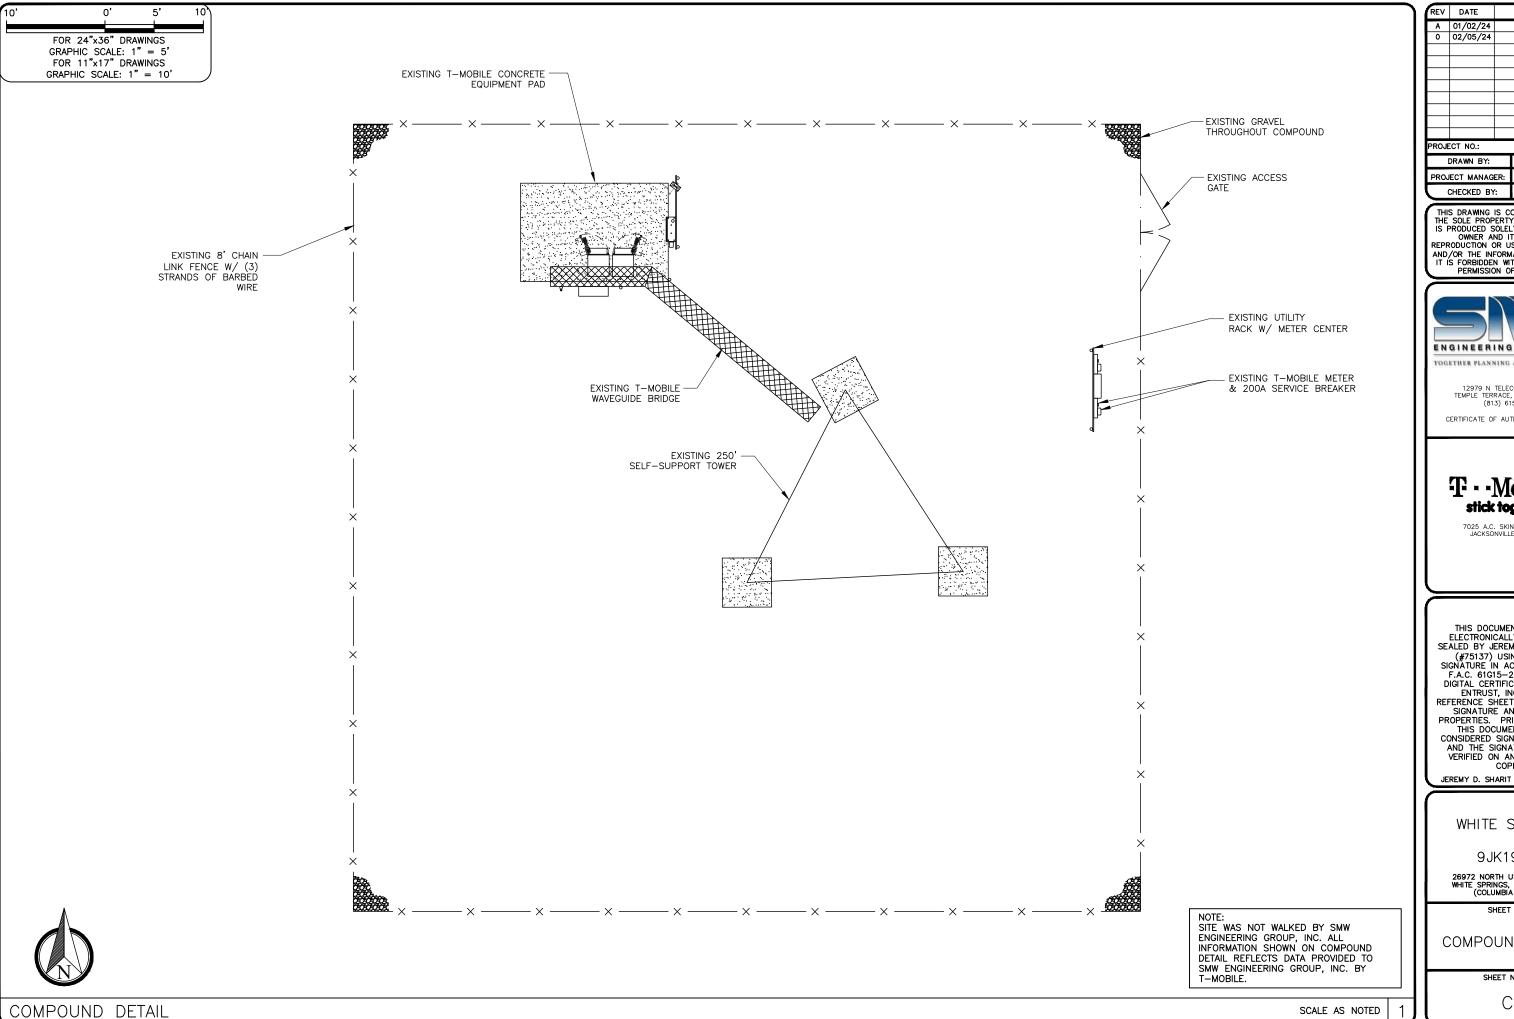

A	01/02/24	PRELIM PLANS
0	01/02/24	CONSTRUCTION
PROJ	ECT NO.:	17-5641.1
	DRAWN BY:	RA

CHECKED BY:

DESCRIPTION

D. REVELS

D. REVELS

THIS DRAWING IS COPYRIGHTED AND IS THE SOLE PROPERTY OF THE OWNER. IT IS PRODUCED SOLELY FOR USE BY THE OWNER AND ITS AFFILIATES. REPRODUCTION OR USE OF THIS DRAWING AND/OR THE INFORMATION CONTAINED IN IT IS FORBIDDEN WITHOUT THE WRITTEN PERMISSION OF THE OWNER.



12979 N TELECOM PARKWAY TEMPLE TERRACE, FLORIDA 33637 (813) 615-1422

CERTIFICATE OF AUTHORIZATION 33693

T · · Mobile · stick together

THIS DOCUMENT HAS BEEN ELECTRONICALLY SIGNED AND SEALED BY JEREMY D. SHARIT, PE SEALED BY JEREMY D. SHARIT, PE
(#75137) USING A DIGITAL
SIGNATURE IN ACCORDANCE WITH
F.A.C. 61G15—23.004, WITH A
DIGITAL CERTIFICATE ISSUED BY
ENTRUST, INC. PLEASE
REFERENCE SHEET TI TO VIEW THE
SIGNATURE AND VERIFY ITS
PROPERTIES. PRINTED COPIES OF
THIS DOCUMENT ARE NOT
CONSIDERED SIGNED AND SEALED
AND THE SIGNATURE MUST BE
VERIFIED ON ANY ELECTRONIC
COPIES.

JEREMY D. SHARIT PE FL LIC 75137

WHITE SPRINGS

9JK1918A

26972 NORTH US HIGHWAY 441 WHITE SPRINGS, FLORIDA 32096 (COLUMBIA COUNTY)


SHEET NAME

COMPOUND DETAIL

SHEET NUMBER

C1

SCALE AS NOTED

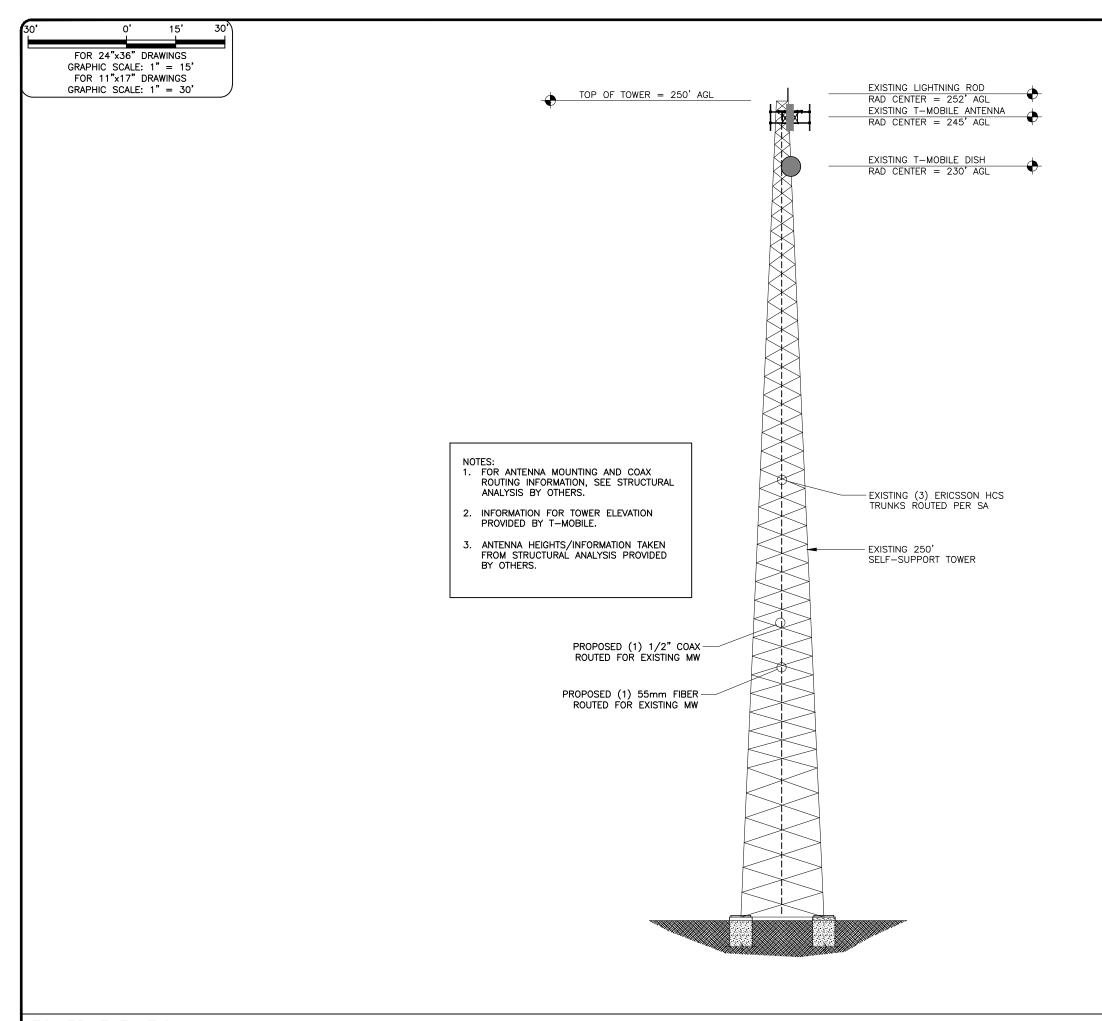

REV	DATE		DESCRIPTION
Α	01/02/24		PRELIM PLANS
0	02/05/24		CONSTRUCTION
PROJE	CT NO.:		17-5641.1
	DRAWN BY:		RA
PROJ	PROJECT MANAGER:		D. REVELS
	CHECKED BY	· .	D. REVELS

THIS DRAWING IS COPYRIGHTED AND IS THE SOLE PROPERTY OF THE OWNER. IT IS PRODUCED SOLELY FOR USE BY THE OWNER AND ITS AFFILIATES.
REPRODUCTION OR USE OF THIS DRAWING AND/OR THE INFORMATION CONTAINED IN IT IS FORBIDDEN WITHOUT THE WRITTEN PERMISSION OF THE OWNER.



12979 N TELECOM PARKWAY TEMPLE TERRACE, FLORIDA 33637 (813) 615-1422

CERTIFICATE OF AUTHORIZATION 33693

T·Mobile stick together

7025 A.C. SKINNER PARKWAY JACKSONVILLE, FL 32256

THIS DOCUMENT HAS BEEN ELECTRONICALLY SIGNED AND SEALED BY JEREMY D. SHARIT, PE SEALED BY JEREMY D. SHARIT, PE

(#75137) USING A DIGITAL

SIGNATURE IN ACCORDANCE WITH
F.A.C. 61G15-23.004, WITH A

DIGITAL CERTIFICATE ISSUED BY
ENTRUST, INC. PLEASE

REFERENCE SHEET TI TO VIEW THE

SIGNATURE AND VERIFY ITS

PROPERTIES. PRINTED COPIES OF
THIS DOCUMENT ARE NOT

CONSIDERED SIGNED AND SEALED

AND THE SIGNATURE MUST BE

VERIFIED ON ANY ELECTRONIC

COPIES.

JEREMY D. SHARIT PE FL LIC 75137

WHITE SPRINGS

9JK1918A


26972 NORTH US HIGHWAY 441 WHITE SPRINGS, FLORIDA 32096 (COLUMBIA COUNTY)

SHEET NAME


TOWER ELEVATION

SHEET NUMBER

C2

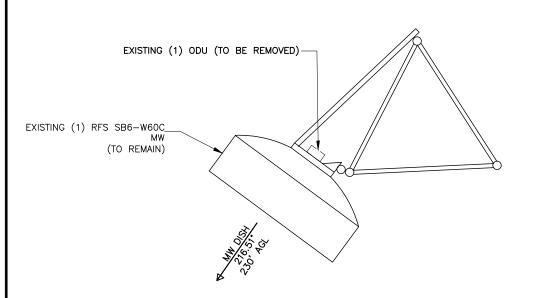

EXISTING MW LAYOUT (RAD 230') NOT TO SCALE

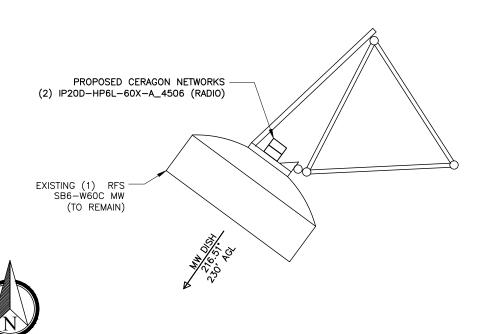

EXISTING T-MOBILE TO	WER INVENTORY AT 245'
# OF EXISTING ANTENNAS:	(3) FFVV-65C-R3 V1 (NO CHANGES)
# OF EXISTING RRUS:	(3) 4480 RRUS (NO CHANGES)
# OF EXISTING CABLES:	(3) 1.996" HYBRID CABLE (NO CHANGES)

EXISTING T-MOBILE TO	OWER INVENTORY AT 230'
# OF EXISTING ANTENNAS:	RFS SB6-W60C MW (TO REMAIN)
# OF EXISTING RRUS:	(1) ODU (TO BE REMOVED)
# OF EXISTING CABLES:	(1) COAX CABLE (TO BE REMOVED)

PROPOSED T-MOBILE TO	OWER INVENTORY AT 230'
# OF ANTENNAS:	RFS SB6-W60C MW (EXISTING)
# OF RRUS:	(2) CERAGON IP20 RADIOS
# OF CABLES:	(1) ½" COAX CABLE (1) 55MM FIBER CABLE

	0	02/05/24		CONSTRUCTION
	-			
	PROJE	ECT NO.:		17-5641.1
		DRAWN BY:		RA
1	PROJ	ECT MANAG	ER:	D. REVELS
	\Box	CHECKED BY	:	D. REVELS

DESCRIPTION

REV DATE

A 01/02/24

THIS DRAWING IS COPYRIGHTED AND IS THE SOLE PROPERTY OF THE OWNER. IT IS PRODUCED SOLELY FOR USE BY THE OWNER AND ITS AFFILIATES. REPRODUCTION OR USE OF THIS DRAWING AND/OR THE INFORMATION CONTAINED IN IT IS FORBIDDEN WITHOUT THE WRITTEN PERMISSION OF THE OWNER.



12979 N TELECOM PARKWAY TEMPLE TERRACE, FLORIDA 33637 (813) 615-1422

CERTIFICATE OF AUTHORIZATION 33693

T · Mobile stick together

7025 A.C. SKINNER PARKWAY JACKSONVILLE, FL 32256

THIS DOCUMENT HAS BEEN ELECTRONICALLY SIGNED AND SEALED BY JEREMY D. SHARIT, PE SEALED BY JEREMY D. SHARIT, PE
(#75137) USING A DIGITAL
SIGNATURE IN ACCORDANCE WITH
F.A.C. 61G15—23.004, WITH A
DIGITAL CERTIFICATE ISSUED BY
ENTRUST, INC. PLEASE
REFERENCE SHEET TI TO VIEW THE
SIGNATURE AND VERIFY ITS
PROPERTIES. PRINTED COPIES OF
THIS DOCUMENT ARE NOT
CONSIDERED SIGNED AND SEALED
AND THE SIGNATURE MUST BE
VERIFIED ON ANY ELECTRONIC
COPIES.

JEREMY D. SHARIT PE FL LIC 75137

WHITE SPRINGS

9JK1918A

26972 NORTH US HIGHWAY 441 WHITE SPRINGS, FLORIDA 32096 (COLUMBIA COUNTY)

SHEET NAME

ANTENNA LAYOUT & ANTENNA INFORMATION

SHEET NUMBER

	Transmission details	
SITE ID:	9JK0088A	9JK1918A
CLUSTER_ID:	9JK0088A	9JK0088A
CALL_SIGN:	WRAP547	WRAP545
ASR #:	1001548	1301983
AAV CONTRACT ID:	WST185-	TMW01
AAV_CONTRACT_STATUS:	Selected	Selected
Ethernet Installed:	Ethernet	Ethernet
Latitude:	30-22- 2.8 N	30-34- 8.2 N
Longitude:	82-51-10.5 W	82-40-51.6 W
	36.42 Deg	216.51 Deg
Azimuth (deg):		
Vertical angle (deg):	0.10 Down	0.09 Down
Elevation:	122.05 ft	125.00 ft
Antenna model:	SB6-W60C	SB6-W60C
Antenna manufacturer:	RFS	RFS
Antenna Id:	109	109
Antenna gain (dBi):	39.40 dBi	39.40 dBi
Antenna diameter:	5.91 ft	5.91 ft
Antenna CL:	239.99 ft AGL	229.99 ft AGL
Diversity Antenna model:		
Diversity Antenna manufacturer:		
Diversity Antenna Id:		
Diversity Antenna gain (dBi):		
Diversity Antenna diameter:		
Diversity Antenna CL:		
Branch Loss Tx/Rx (dB):	1.60/1.60	1.60/1.60
Attenuator Common/Tx/Rx (dB):	0.00 0.00 0.00	0.00 0.00 0.00
Waveguide #1 Model, Len, Loss(dB):		
Waveguide #2 Model, Len, Loss(dB):		
Waveguide #3 Model, Len, Loss(dB):		
Total Waveguide Loss (dB):		
Other Losses (dB):	0.00	0.00
Frequency (GHz):	6.10	GHz
Path length:	17.2	26 mi
Free space loss (dB):	137.0	03 dB
Atmospheric absorption loss (dB):	0.29	5 dB
Obstruction Loss (dB):	0.00 dB	7-1-1-1-1-1-1-1-1
Field margin (dB):	1.00	CONTRACTOR
Net path loss (dB):	61.08 dB	61.08 dB
Configuration:	2+0/DP/DM/OMT	2+0/DP/DM/OMT
Radio model:	IP20D-HP6L-60X-A_4506	IP20D-HP6L-60X-A_4506
Radio manufacturer:	Ceragon Networks	Ceragon Networks
Radio III Radio Id:	756	756
Frequency Plan: Frequency (MHz):	Low: N/A	High: N/A
Polarization:	N/A	N/A
	-10	
Emission designator:	60M0D7W	60M0D7W
Climatic factor:	1.	
Terrain roughness factor:	4.	WALKET THE PARTY OF THE PARTY O
Average annual temperature:		degF
Design Path Polarity:		tical
Rain region:		lle, Florida
0.01% Rain Rate:	72.9 ι	mm/hr

Modulation / Throughput	Tx Power	A/B (dBm)	EIRP A/	B (dBm)	Receive Signal A/B (dBm)		Composite Fade Margin A/B (dB)		Radio Threshold/ ACM Drop Level A/B (dBm)	
BPSK 49.00 Mbps	38.00	38.00	75.80	75.80	-23.68	-23.68	63.82	63.82	-88.50	-88.50
4QAM 103.00 Mbps	37.00	37.00	74.80	74.80	-24.68	-24.68	56.12	56.12	-81.80	-81.80
8QAM 152.00 Mbps	37.00	37.00	74.80	74.80	-24.68	-24.68	52.32	52.32	-78.00	-78.00
16QAM 212.00 Mbps	37.00	37.00	74.80	74.80	-24.68	-24.68	49.12	49.12	-74.80	-74.80
32QAM 280.00 Mbps	37.00	37.00	74.80	74.80	-24.68	-24.68	45.82	45.82	-71.50	-71.50
64QAM 344.00 Mbps	36.00	36.00	73.80	73.80	-25.68	-25.68	41.72	41.72	-68.40	-68.40
128QAM 417.00 Mbps	36.00	36.00	73.80	73.80	-25.68	-25.68	38.92	38.92	-65.60	-65.60
256QAM 481.00 Mbps	35.00	35.00	72.80	72.80	-26.68	-26.68	34.72	34.72	-62.40	-62.40
512QAM 518.00 Mbps	34.00	34.00	71.80	71.80	-27.68	-27.68	31.22	31.22	-59.90	-59.90
1KLQAM 564.00 Mbps	33.00	33.00	70.80	70.80	-28.68	-28.68	26.92	26.92	-56.60	-56.60
1KHQAM 599.00 Mbps	33.00	33.00	70.80	70.80	-28.68	-28.68	26.12	26.12	-55.80	-55.80
2KQAM 649.00 Mbps	33.00	33.00	70.80	70.80	-28.68	-28.68	23.82	23.82	-53.50	-53.50
4KQAM 668.00 Mbps	31.00	31.00	68.80	68.80	-30.68	-30.68	18.02	18.02	-49.70	-49.70

	REV	DATE	DESCRIPTION
	Α	01/02/24	PRELIM PLANS
	0	01/02/24 02/05/24	CONSTRUCTION
11			

ROJECT NO.:	17-5641.1
DRAWN BY:	RA
PROJECT MANAGER:	D. REVELS
CHECKED BY:	D. REVELS

THIS DRAWING IS COPYRIGHTED AND IS THE SOLE PROPERTY OF THE OWNER. IT IS PRODUCED SOLELY FOR USE BY THE OWNER AND ITS AFFILIATES.
REPRODUCTION OR USE OF THIS DRAWING AND/OR THE INFORMATION CONTAINED IN IT IS FORBIDDEN WITHOUT THE WRITTEN PERMISSION OF THE OWNER.



12979 N TELECOM PARKWAY TEMPLE TERRACE, FLORIDA 33637 (813) 615-1422

CERTIFICATE OF AUTHORIZATION 33693

T - Mobile - stick together

7025 A.C. SKINNER PARKWAY JACKSONVILLE, FL 32256

THIS DOCUMENT HAS BEEN ELECTRONICALLY SIGNED AND SEALED BY JEREMY D. SHARIT, PE SEALED BY JEREMY D. SHARIT, PE

(#75137) USING A DIGITAL
SIGNATURE IN ACCORDANCE WITH
F.A.C. 61G15—23.004, WITH A
DIGITAL CERTIFICATE ISSUED BY
ENTRUST, INC. PLEASE
REFERENCE SHEET TI TO VIEW THE
SIGNATURE AND VERIFY ITS
PROPERTIES. PRINTED COPIES OF
THIS DOCUMENT ARE NOT
CONSIDERED SIGNED AND SEALED
AND THE SIGNATURE MUST BE
VERIFIED ON ANY ELECTRONIC
COPIES.

JEREMY D. SHARIT PE FL LIC 75137

WHITE SPRINGS

9JK1918A


26972 NORTH US HIGHWAY 441 WHITE SPRINGS, FLORIDA 32096 (COLUMBIA COUNTY)

SHEET NAME

ANTENNA INFORMATION

SHEET NUMBER

ANTENNA INFORMATION

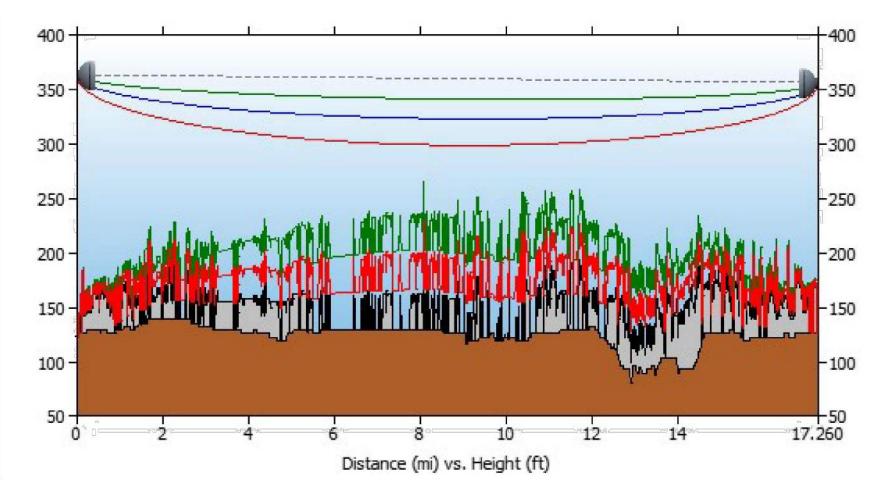

Path length (17.26 mi)

9JK0088A		
Latitude:	30-22- 2.8 N	
Longitude:	82-51-10.5 W	
Azimuth:	36.42 Deg	
Elevation:	122.05 ft	
Antenna CL:	239.99 ft AGL	

Frequency (GHz) = 6.10 GHz					
K1:	1.33				
%F1:	0.60				
K2:	0.67				
%F2:	0.30				
K3:	1.33				
%F3:	1.00				

9JK1918A			
Latitude:	30-34- 8.2 N		
Longitude:	82-40-51.6 W		
Azimuth:	216.51 Deg		
Elevation:	125.00 ft		
ntenna CL:	229.99 ft AGL		

1	Α	01/02/24		PRELIM PLANS
1	0	02/05/24		CONSTRUCTION
1				
1				
1				
1				
1				
1				
1				
1				
1	PROJ	PROJECT NO.: DRAWN BY:		17-5641.1
1				RA
	PROJECT MANAGER:		D. REVELS	
	CHECKED BY:			D. REVELS

REV DATE

THIS DRAWING IS COPYRIGHTED AND IS THE SOLE PROPERTY OF THE OWNER. IT IS PRODUCED SOLELY FOR USE BY THE OWNER AND ITS AFFILIATES. REPRODUCTION OR USE OF THIS DRAWING AND/OR THE INFORMATION CONTAINED IN IT IS FORBIDDEN WITHOUT THE WRITTEN PERMISSION OF THE OWNER.



12979 N TELECOM PARKWAY TEMPLE TERRACE, FLORIDA 33637 (813) 615-1422

CERTIFICATE OF AUTHORIZATION 33693

T · · Mobile · stick together

THIS DOCUMENT HAS BEEN ELECTRONICALLY SIGNED AND SEALED BY JEREMY D. SHARIT, PE SEALED BY JEREMY D. SHARIT, PE
(#75137) USING A DIGITAL
SIGNATURE IN ACCORDANCE WITH
F.A.C. 61G15—23.004, WITH A
DIGITAL CERTIFICATE ISSUED BY
ENTRUST, INC. PLEASE
REFERENCE SHEET TI TO VIEW THE
SIGNATURE AND VERIFY ITS
PROPERTIES. PRINTED COPIES OF
THIS DOCUMENT ARE NOT
CONSIDERED SIGNED AND SEALED
AND THE SIGNATURE MUST BE
VERIFIED ON ANY ELECTRONIC
COPIES.

JEREMY D. SHARIT PE FL LIC 75137

WHITE SPRINGS


9JK1918A


26972 NORTH US HIGHWAY 441 WHITE SPRINGS, FLORIDA 32096 (COLUMBIA COUNTY)

SHEET NAME

PATH

PROFILE SHEET NUMBER

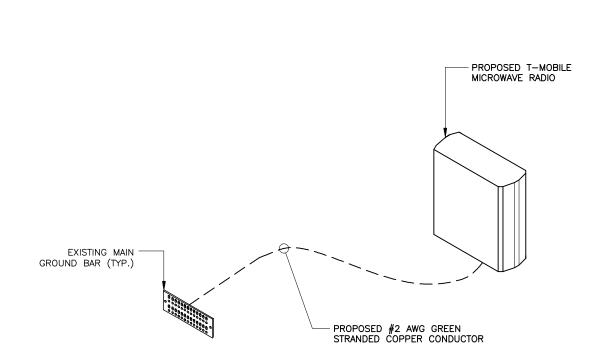

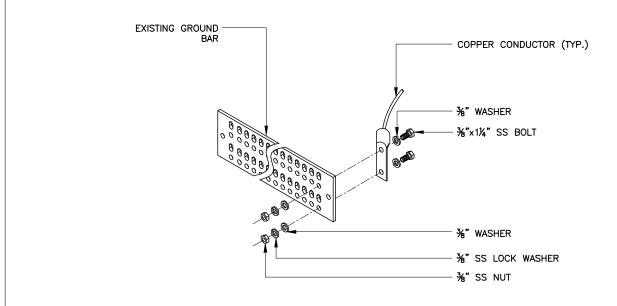

TYPICAL GROUND BAR CONNECTION DETAIL

NTS 2

- RECORD DRAWINGS: MAINTAIN A RECORD OF ALL CHANGES, SUBSTITUTIONS BETWEEN WORK AS SPECIFIED AND INSTALLED. RECORD CHANGES ON A CLEAN SET OF CONTRACT DOCUMENTS WHICH SHALL BE TURNED OVER TO THE CONSTRUCTION MANAGER UPON COMPLETION OF THE PROJECT.
- 2. GUARANTEE/WARRANTY: GUARANTEE INSTALLATION TO BE FREE OF DEFECTS, SHORTS, GROUNDS, ETC., FOR A PERIOD OF ONE YEAR. FURNISH WARRANTY SO THE DEFECTIVE MATERIAL AND/OR WORKMANSHIP WILL BE REPAIRED/REPLACED IMMEDIATELY UPON NOTIFICATION AT NO COST TO THE OWNER FOR PERIOD OF WARRANTY.
- ALL TIE WRAPS SHALL BE CUT FLUSH WITH APPROVED CUTTING TOOL TO REMOVE SHARP EDGES.
- 4. ELECTRICAL METALLIC TUBING (EMT) OR RIGID NONMETALLIC CONDUIT (I.E., RIGID PVC SCHEDULE 40, OR RIGID PVC SCHEDULE 80 FOR LOCATIONS SUBJECT TO PHYSICAL DAMAGE) SHALL BE USED FOR EXPOSED INDOOR LOCATIONS.
- 5. LIQUID-TIGHT FLEXIBLE METALLIC CONDUIT (LIQUID-TITE FLEX) SHALL BE USED INDOORS AND OUTDOORS, WHERE VIBRATION OCCURS OR FLEXIBILITY IS NEEDED.
- WIREWAYS SHALL BE EPOXY—COATED (GRAY) AND INCLUDE A HINGED COVER, DESIGNED TO SWING OPEN DOWNWARD; SHALL BE PANDUIT TYPE E (OR EQUAL); AND RATED NEMA 1 (OR BETTER) INDOORS, OR NEMA 3R (OR BETTER) OUTDOORS.
- EQUIPMENT CABINETS, TERMINAL BOXES, JUNCTION BOXES, AND PULL BOXES SHALL BE GALVANIZED OR EPOXY—COATED SHEET STEEL, SHALL MEET OR EXCEED UL 50, AND RATED NEMA 1 (OR BETTER) INDOORS, OR NEMA 3R (OR BETTER) OUTDOORS.
- METAL RECEPTACLE, SWITCH, AND DEVICE BOXES SHALL BE GALVANIZED, EPOXY—COATED, OR NON—CORRODING; SHALL MEET OR EXCEED UL 514A AND NEMA OS 1; AND RATED NEMA 1 (OR BETTER) INDOORS, OR WEATHER PROTECTED (WP OR BETTER) OUTDOORS.
 - NONMETALLIC RECEPTACLE, SWITCH, AND DEVICE BOXES SHALL MEET OR EXCEED NEMA OS 2; AND RATED NEMA 1 (OR BETTER) INDOORS, OR WEATHER PROTECTED (WP OR BETTER) OUTDOORS.

0	02/05/24		CONSTRUCTION
PROJ	ECT NO.:		17-5641.1
	DRAWN BY:		RA
PRO	PROJECT MANAGER:		D. REVELS
CHECKED BY:			D. REVELS

DESCRIPTION

PRELIM PLANS

REV DATE

A 01/02/24

THIS DRAWING IS COPYRIGHTED AND IS THE SOLE PROPERTY OF THE OWNER. IT IS PRODUCED SOLELY FOR USE BY THE OWNER AND ITS AFFILIATES. REPRODUCTION OR USE OF THIS DRAWING AND/OR THE INFORMATION CONTAINED IN IT IS FORBIDDEN WITHOUT THE WRITTEN PERMISSION OF THE OWNER.



12979 N TELECOM PARKWAY TEMPLE TERRACE, FLORIDA 33637 (813) 615-1422

CERTIFICATE OF AUTHORIZATION 33693

T - Mobile - stick together

7025 A.C. SKINNER PARKWAY JACKSONVILLE, FL 32256

THIS DOCUMENT HAS BEEN ELECTRONICALLY SIGNED AND SEALED BY JEREMY D. SHARIT, PE (#75137) USING A DIGITAL SIGNATURE IN ACCORDANCE WITH F.A.C. 61G15-23.004, WITH A DIGITAL CERTIFICATE ISSUED BY ENTRUST, INC. PLEASE REFERENCE SHEET TI TO VIEW THE SIGNATURE AND VERIFY ITS PROPERTIES. PRINTED COPIES OF THIS DOCUMENT ARE NOT CONSIDERED SIGNATURE MUST BE VERIFIED ON ANY ELECTRONIC COPIES.

JEREMY D. SHARIT PE FL LIC 75137

WHITE SPRINGS

9JK1918A

26972 NORTH US HIGHWAY 441 WHITE SPRINGS, FLORIDA 32096 (COLUMBIA COUNTY)

SHEET NAME

GROUNDING DETAILS
AND NOTES

SHEET NUMBER

E1

1 GROUNDING NOTES