
A BOUNDARY SURVEY IN SECTION 16,17, TOWNSHIP 4 RANGE 17 EAST, COLUMBIA COUNTY, FLORIDA

Curve number 1 Rodlus = 1030.00 Delta= 02*29'46' Arc= 44.87 Tangent= 22.44 Chord= 44.87 Chord Brg. S.00°54'39'W.,

IS 1' WEST

SCALE: 1" = 60'

SYMBOL LEGEND 4 X4 CONCRETE MUNUMENT FOUND 4 X4 CONCRETE MUNUMENT SET 150N PIPE FOUND IRON PIN AND CAP SET WATER METER EENTERLINE SATELLITE DISH TELEPHONE BOX ELECTRIC LINES VIRE FENCE SHAIN LINK FENCE WOUDEN FENCE

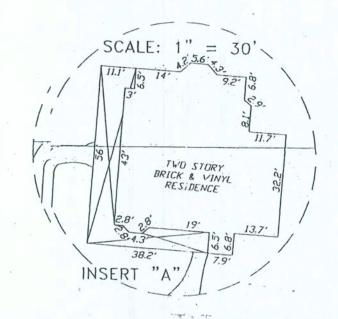

DESCRIPIPIJON: LOTS 4 & 5 DF 'MILL CREEK' AS PER PLAT THEREOF RECORDED IN PLAT BOOK 5, PAGES 127 & 12 127A OF THE PUBLIC RECORDS OF COLUMBIA COUNTY, FLORIDA.

SURVEYEYOR'S NOTES:

1. BOUNJADARY BASED ON MONUMENTATION FOUND IN ACCORDANCE WITH THE RETRACEMENT OF THE E ORIGINAL SURVEY FOR SAID PLAT OF RECORD.

2. BEARARINGS ARE BASED ON SAID PLAT OF RECORD.

3. SOMEME PORTIONS OF THIS PARCEL ARE IN ZONE "A" AND MAY BE SUBJECT TO FLOODING. OF THIS PARCEL ARE IN ZONE "A" AND MAY BE SUBJECT TO FLOODING. OF THIS PARCEL ARE IN ZONE "A" AND ARE DETERMINED FOR ZONE "A". SOME PORTIONS PLAININ AS PER FLOOD INSURANCE RATE MAP, DATED 6 JAN. 1988 COMMUNITY BANEL NO. 120070 0200 0 B. & 120070 0175 B. HUWEVER, THE FLOOD INSURANCE RATE MAPS ARE SUBJECT TO CHANGE. DATETE OF FIELD SURVEY AS SHOWN HEREON.

5. IF THE OF FIELD SURVEY AS SHOWN HEREON.

6. THIS S SURVEY EXCEPT AS SHOWN HEREON.

6. THIS S SURVEY EXCEPT AS SHOWN HEREON.

CERTIFIED TO:

L.E. BRITT.

P.L.S. 1079

21.00

IS 2' SOUTH & 6' EAST

P.L.S. 1079

282.49

ASPHALT

WALL

FENCE CORNER

IS 3.09' NORTH-

& 6.18' EAST

ZONE 'X'

GROUND ELEVATION = 101.06'

-203.79'-GROUND ELEVATION = 100.97

ELEVATION = 101.11

ZONE 'X'

L.E. BRITT P.L.S. 1079

FENCE CORNER IS 2.26' NORTH & 4.40' WEST

GROUND

ELEVATION = 100.56'

GROUND

JOHN W. & DANETTE D'NEAL DARBY, PEELE BOWDOIN & PAYNE STAFFORD L. SCAFF JR. & ANNE C. SCAFF ATTORNEYS' TITLE INSURANCE FUND, INC. OLD REPUBLIC NATIONAL TITLE INSURANCE COMPANY FIRST AMERICAN TITLE INSURANCE CO.

FIELD BOOK: 223 PAGE(S)

SURVEYOR'S CERTIFICATION:

HEREBY CERTIFY THAT THIS SURVEY WAS MADE UNDER MY RESPONSIBLE CHARGE AND MEETS THE MINIMUM THNICAL STANDARDS AS SET FORTH BY THE FLORIDA BOARD OF PROFESSIONAL SURVEYORS AND MAPPERS ICHAPTER 61617-6, FLORIDA ADMINISTRATIVE CODE, PURSUANT TO SECTION 472.027, FLORIDA STATUTES.

ZONE 'X'

(N.89°28'12'E. 633.21' PLAT) N.89°25'54"E. 633.11' FIELD

-APPROXIMATE

TOP OF BANK

L.E. BRITT P.L.S. 1079

FIEL SURVEY DATE

п в

POND

WOOD DECK

ZONE 'A'

INSER

GROUND ELEVATION = 99.9

DNE STOR BRICK & VIL

1/15/02)

NEW:4'X35' CARPORT

ZONE 'X'

LOT 5

(N.89°28'12'E. 632.74' PLAT) N.89'26'09"E. 632.44' CALC.

ZONE 'AE'

ZONE 'A'

GROUND

ELEVATION = 100.86'

ASPHALT

ZONE 'A'

P.R.M.

SEPTIC

03/31/04 DRAWING DATE

-369.87

ZONE 'A'

5.88°46'52"W. 482.75' FIELD (S.88°48'23'W. 482.97' PLAT)

CERTIFICATION # 5757

L.E. BRITT P.L.S. 1079

FENCE CORNER IS 0.5' NORTH & 0.5' WE'ST

P.R.M.

NOTEINLESS IT BEARS THE SIGNATURE AND THE ORIGINAL RAISED SEAL OF A FLORIDA LICENSED SURVEYOR AND MAPP! THIS DRAWING, SKETCH, PLAT OR MAP IS FOR INFORMATIONAL PURPOSES ONLY AND IS NOT VALID.




BRITT SURVEYING

LAND SURVEYORS AND MAPPERS

830 WEST DUVAL STREET LAKE CITY, FLORIDA 32055

TELEPHONE: (386) 752-7163 FAX: (386) 752-5573

WORK ORDER # L-14788

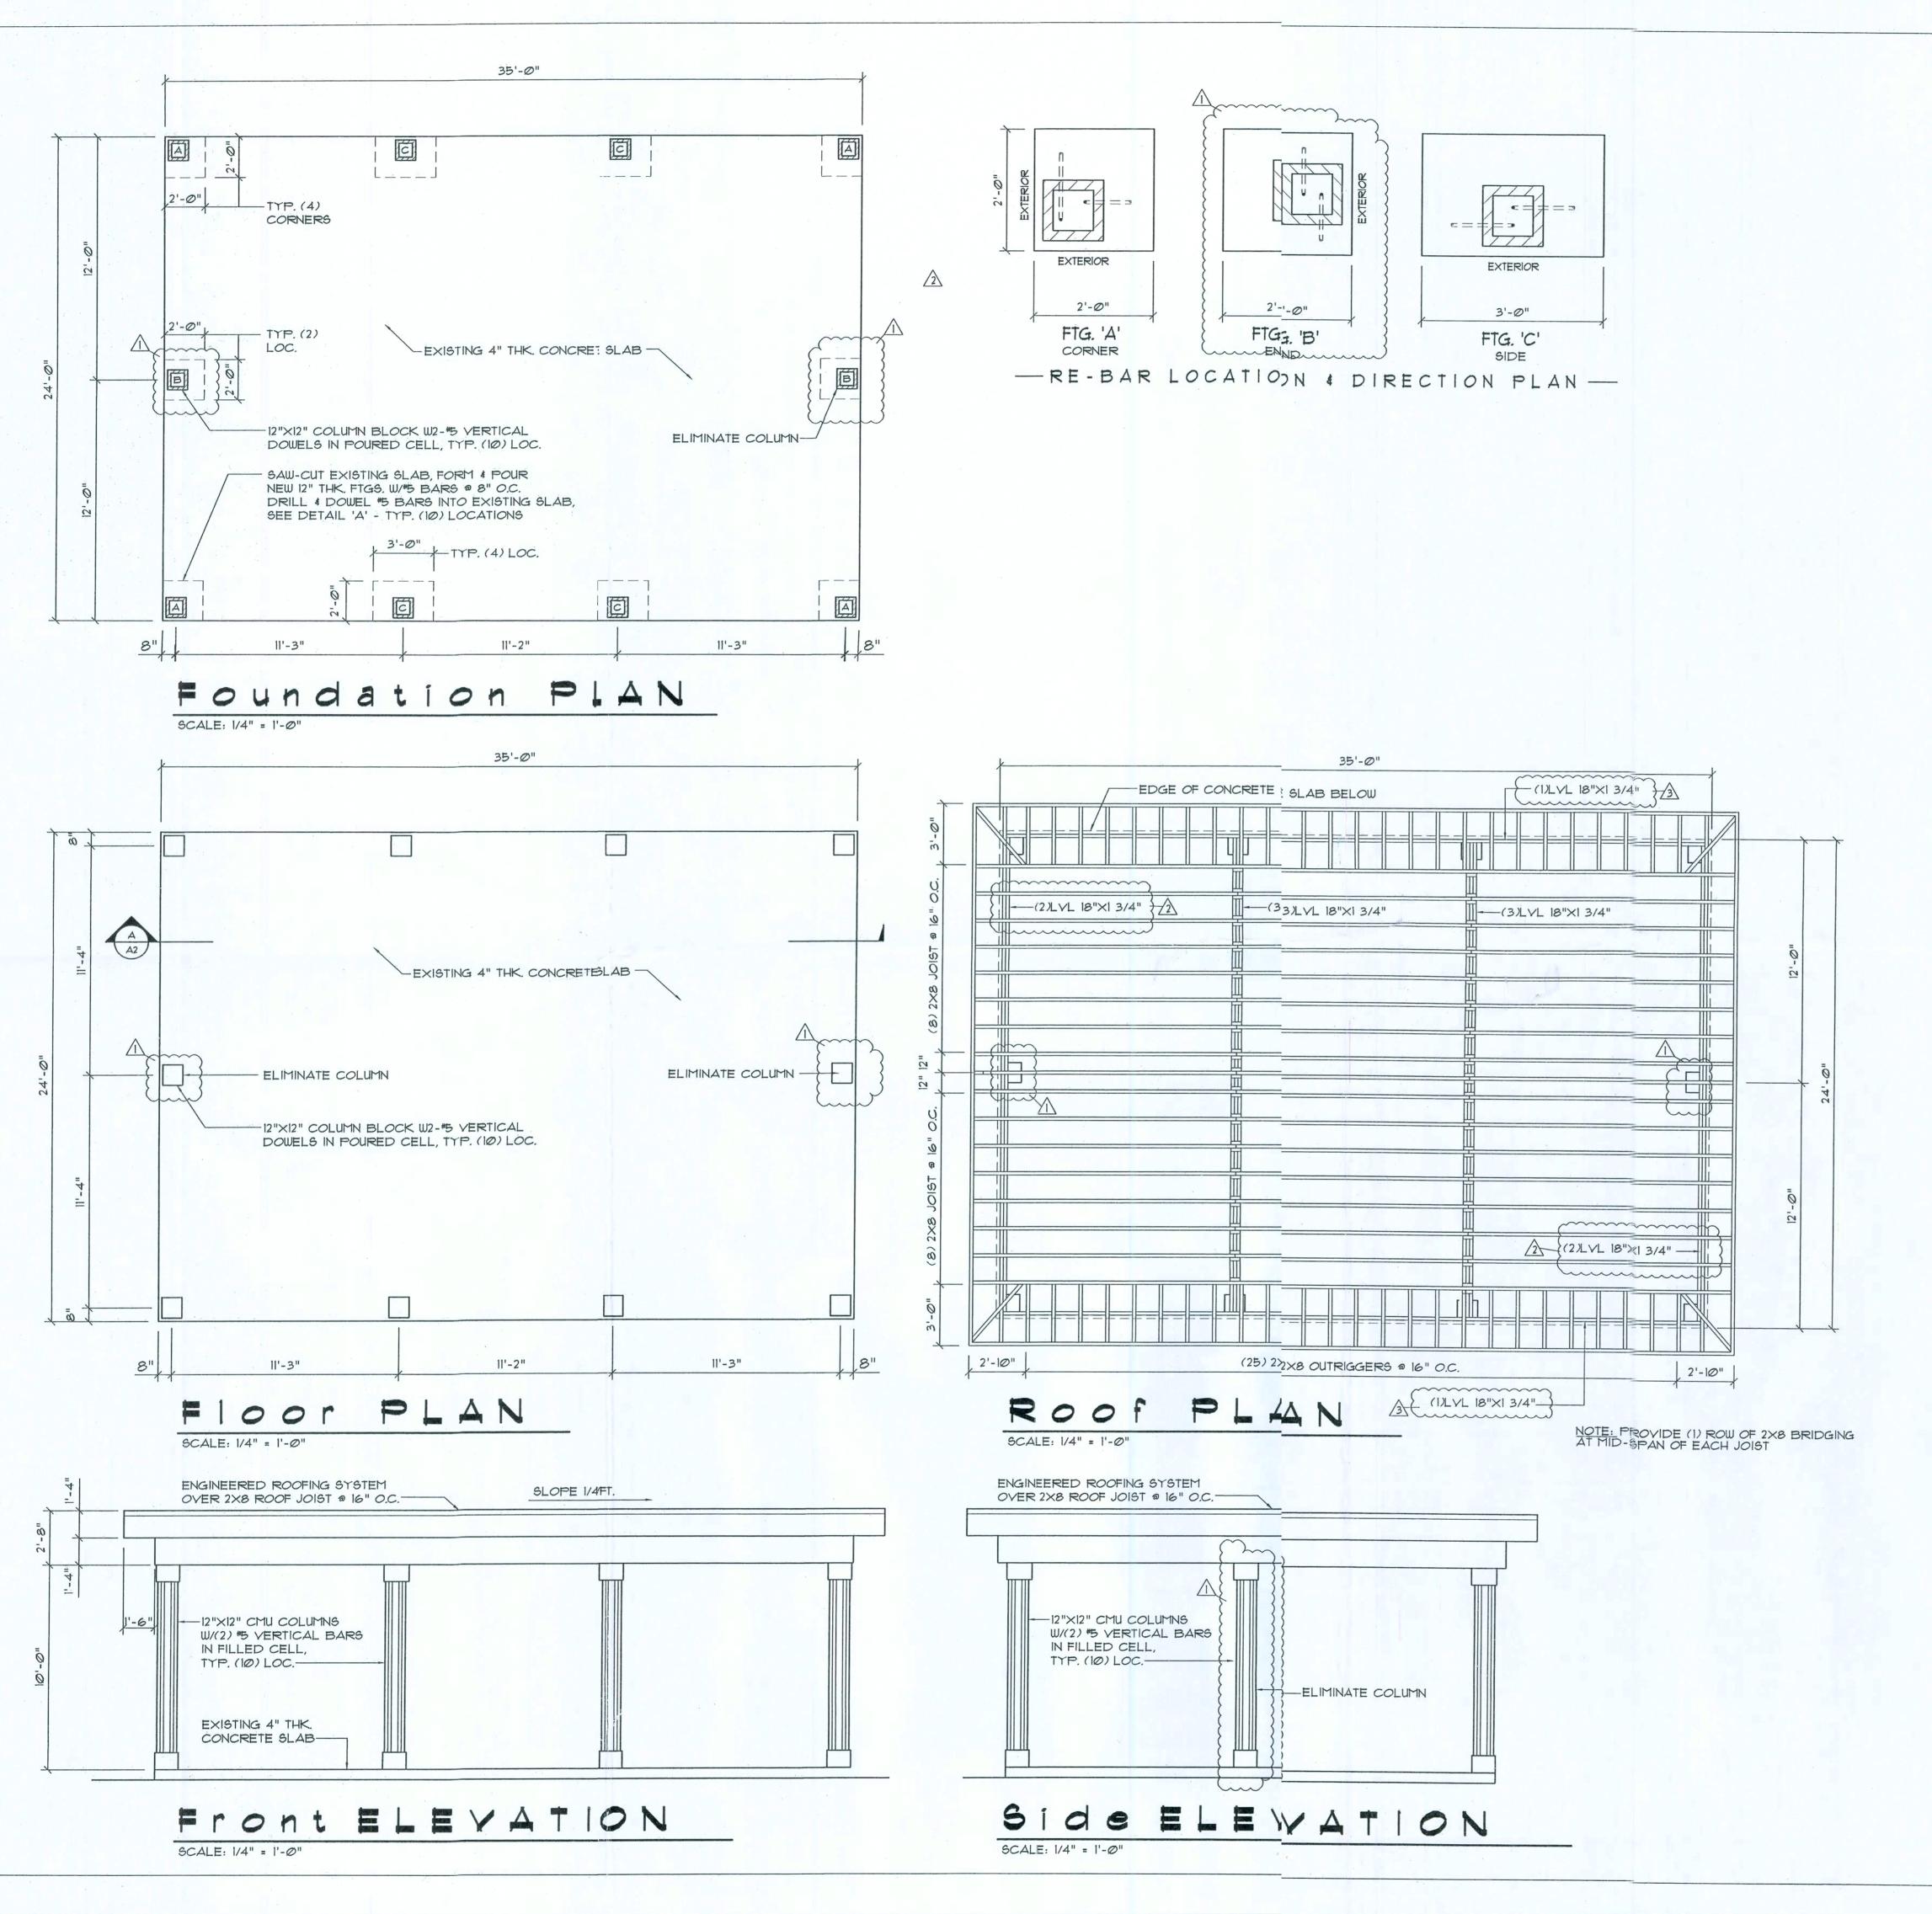

FLORIDA BUILDING CODE SUMMARY

ALL WIND LOADS ARE IN ACCORDANCE WITH SECTION 1609, FLORIDA BUILDING CODE, 2007 EDITION. BASIC WIND SPEED: 110 MPH WIND IMPORTANCE FACTOR (1): 1 = 1.00 BUILDING CATAGORY: CATAGORY II WIND EXPOSURE: INTERNAL PRESSURE COEFFICIENT: +/- 0.18 MWFRS PER TABLE 1609.2A (FBC 2001) ROOF: - 23.1 PSF DESIGN WIND PRESSURES: WALLS: + 26.6 PSF EAVES: - 32.3 PSF COMPONENTS & CLADING PER TABLES OP'NGS: + 21.8 / - 29.1 PSF 1609.2B # 1609.2C (FBC 2007) EAVES: - 683 PSF DESIGN WIND PRESSURES: ROOF: + 19.9 / - 25.5 PSF

TYPE OF CONSTRUCTION

Roof: Engineered Roof System over Wood Joist @ 16" O.C.
Columns: 12"X12" Concrete Column Blocks w/(2) #5 Dowels in filled cell
Floor: Existing 4" Thk Concrete Slab
Foundation Piers: 12" Thk Concrete Pads w/* Bars @ 8" o.c., e.w.

ROOF DECKING

Material: 5/8" CDX Plywood
Sheet Size: 48"x96" Sheets Perpendicular to Roof Framing
Fasteners: 8d Common Nails® 8" O.C. along Rafter

HURRICANE UPLIFT CONNECTORS

Beam to Rafters: Simpson H3 @ Ea. Rafter

Beam to Column: Simpson HGLBA Beam Seat ca. end (LVL Only)
Beam to Column: Simpson STHDIØ ca. Column (LON.)

NOT

All Anchors shall be secured w/Nails as prescribed by the Manufacturer for Maximum Joins Strength

GENERAL NOTES:

- 1. THE CONTRACTOR SHALL INDEMNIFY THE OWNER AGAINST ALL CLAIMS, WHETHER FROM PERSONAL INJURY OR PROPERTY DAMAGE, ARISING FROM EVENTS ASSOCIATED WITH THE WORK PERFORMED UNDER THE CONTRACT FOR THIS PROJECT.
- 2. THE CONTRACTOR AND/OR SUB-CONTRACTORS SHALL WAR-RANT ALL WORK FOR A PERIOD OF ONE YEAR FOLLOWING THE DATE OF FINAL COMPLETION AND ACCEPTANCE BY THE OWNER. DEFECTS IN MATERIALS, EQUIPMENT, COMPONENTS AND WORK-MANSHIP SHALL BE CORRECTED AT NO FURTHER COST TO THE OWNER DURING THE ONE YEAR WARRANTY PERIOD.
- 3. AT THE OWNER'S OPTION, A WARRANTY INSPECTION SHALL BE PERFORMED DURING THE ELEVENTH MONTH FOLLOWING THE COMMENCEMENT OF THE WARRANTY PERIOD, FOR THE PURE-POSE OF DETERMINING ANY WARRANTY WORK THAT MAY BE REQUIRED. THE CONTRACTOR SHALL BE PRESENT DURING THIS INSPECTION IF REQUESTED BY THE OWNER.
- 4. THE CONTRACTOR SHALL PAY FOR ALL PERMITS, LICENSES, TESTS AND THE LIKE THAT MAY BE REQUIRED BY THE VARIOUS AUTHORITIES HAVING JURISDICTION OVER THIS PROJECT BE THEY CITY, COUNTY, STATE OR FEDERAL.
- 5. THE OWNER SHALL FILE A "NOTICE OF COMMENCEMENT" PRIOR TO THE BEGINNING THE THE PROJECT AND THE CONTRACTOR(S) SHALL FILE "NOTICE TO OWNER" AND PROVIDE "RELEASE OF LIEN" FOR ALL PAYMENT REQUESTS PRIOR TO DISBURSEMENT OF ANY FUNDS.
- 6. ANY AND ALL DISPUTES ARISING FROM EVENTS ASSOCIATED WITH THE CONSTRUCTION OF THIS PROJECT BETWEEN THE OWNER, CONTRACTOR(S) AND SUPPLIERS SHALL BE RESOLVED THROUGH BINDING ARBITRATION.
- 1. ALL WORK SHALL BE IN ACCORDANCE W/ APPLICABLE CODES AND LOCAL REGULATIONS, INCLUDING APPLICABLE ENERGY CODES. ALL COMPONENTS OF THE BUILDING SHALL MEET WITH THE MINIMUM ENERGY REQUIREMENTS OF THE BUILDING CODE. ANY DISCREPANCIES SHALL BE REPORTED TO THE ARCHITECT IN WRITING PRIOR TO THE COMMENCEMENT OF THE WORK.
- 8. ALL INSULATION SHALL BE LEFT EXPOSED AND ALL LABLES LEFT INTACT ON THE WINDOWS AND DOORS UNTIL INSPECTED BY THE BUILDING OFFICIAL.
- 9. ALL WOOD IN CONTACT WITH CONCRETE OR MASONRY SHALL BE PRESSURE TREATED.

REVISION:

REMOVE COLUMN
ADD DBL. 18" LV.
ADD 18" LVL

Copyright 2005 © N.P. Geisler, Architect

DRAWN:

Leton Designed Carport for:

UNIN ON MEAL

COLUMBIA COUNTY, FLORIDA

ARCHITECTURAL DRAFTING & DESIGN, INC.


PAUL ISLER 1758 NW Brown Rd. FL 32055 Certified 386-755-9021

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SHEET:

A1

1858249 AR0007005

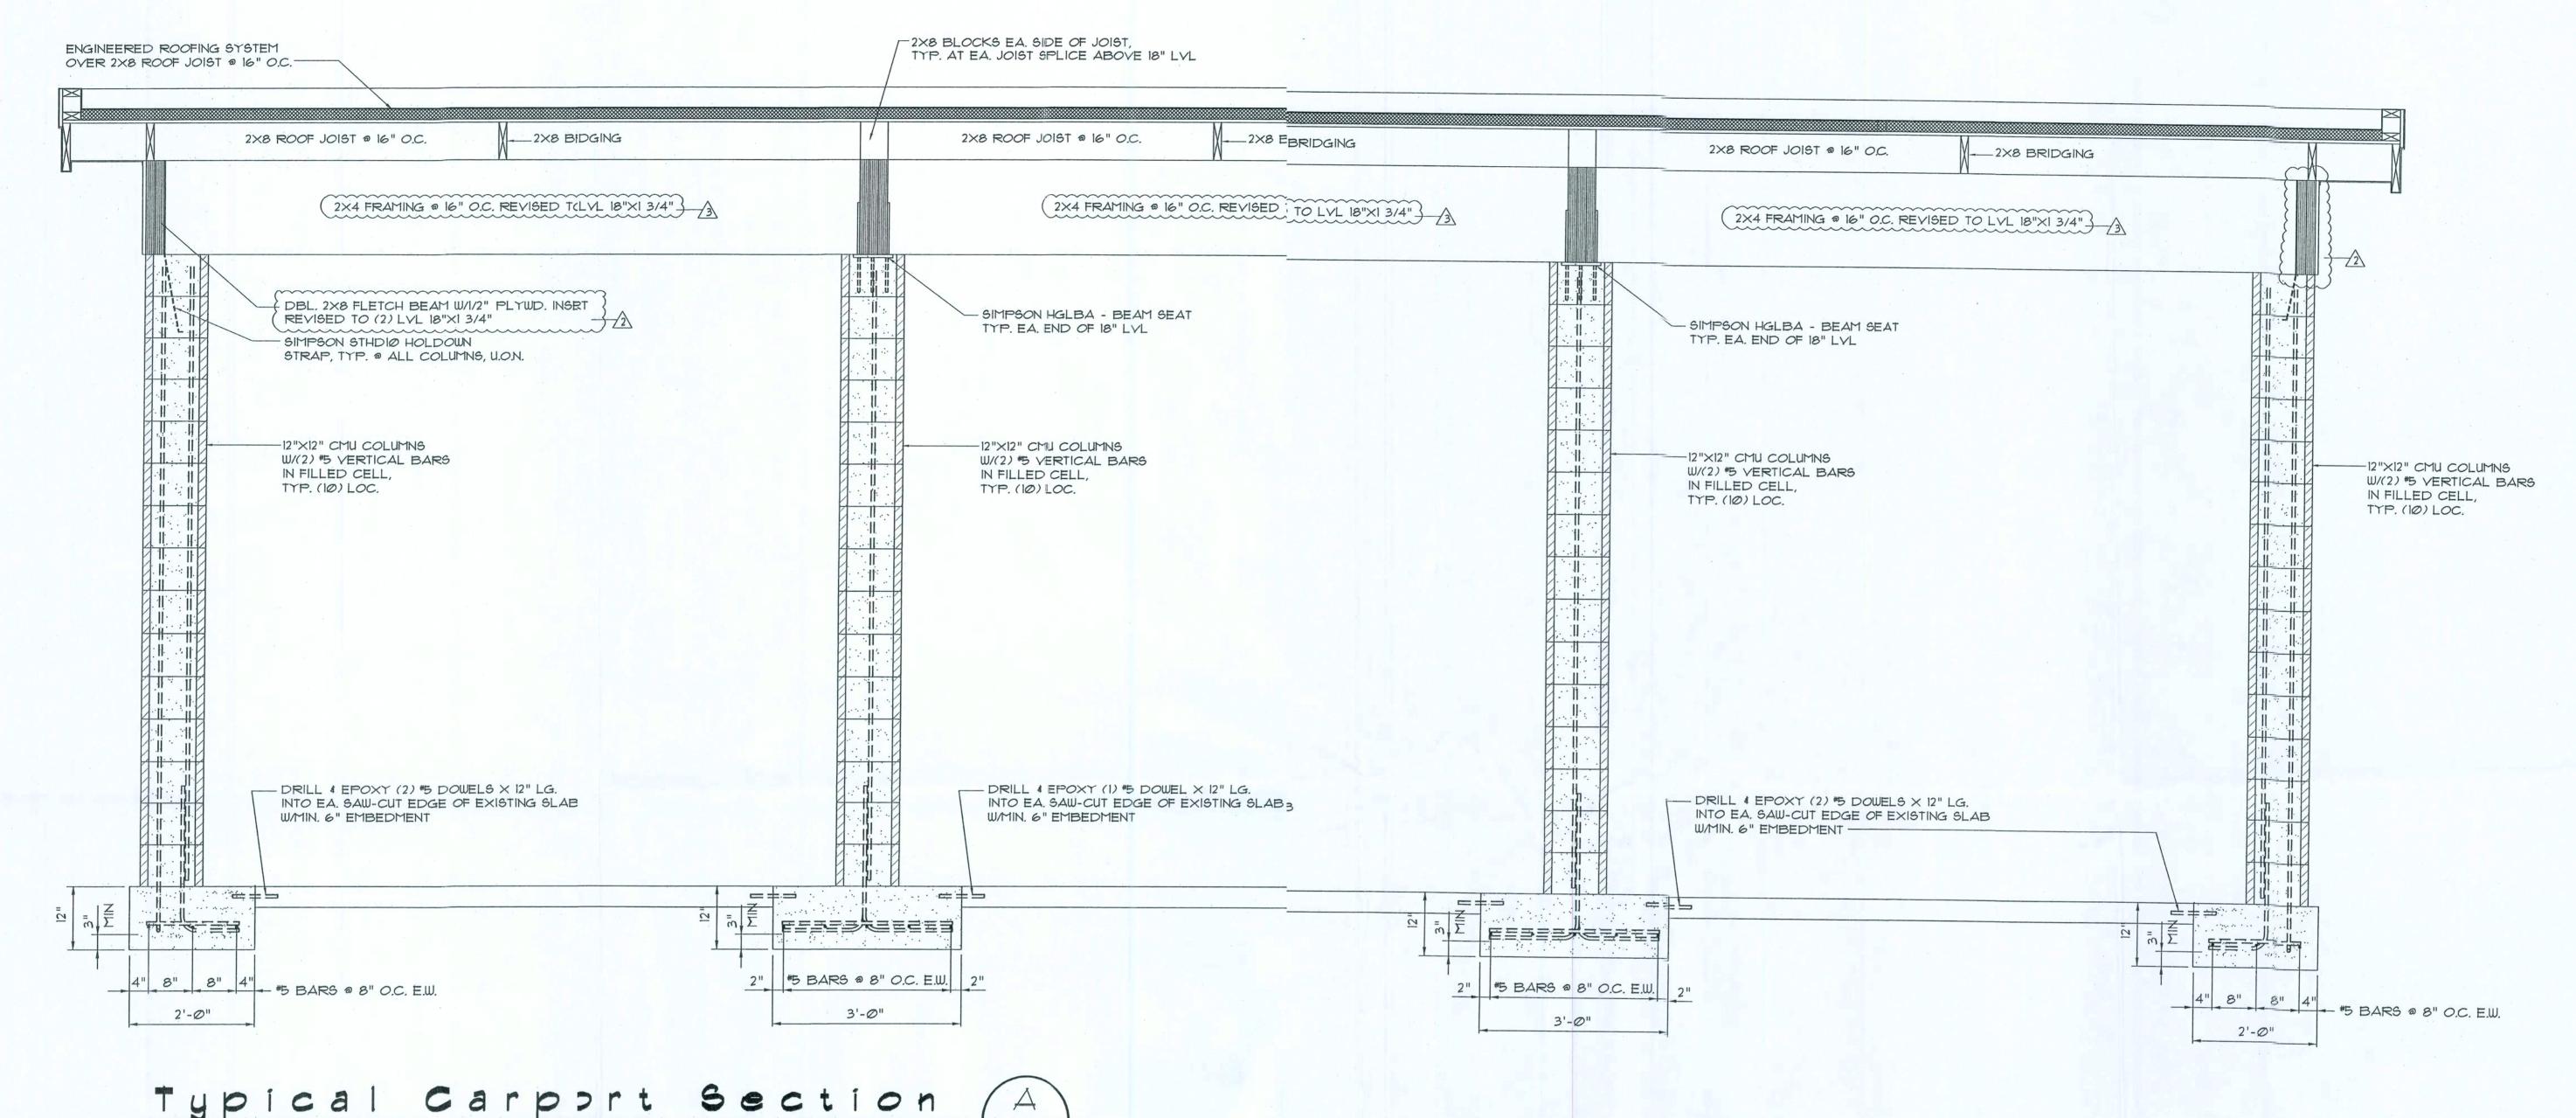

CONCRETE / MASONRY / METALS GENERAL NOTES:

1. DESIGN SOIL BEARING PRESSURE: 1000 PSF.

SCALE: 3/4" = 1'-0"

- 2. EXPANSIVE SOILS: WHERE DIRECTED BY THE SOILS ENGIEER, SOIL AUGMENTATION PER THE SOILS ENGINEER'S SPECIFICATIOS SHALL BE IMPLEMENTED PRIOR TO PLACING ANY FOUNDATIONS TESTS AS SPECIFIED SHALL BE PREFORMED TO DETERMINE THE SITABILITY OF THE SUB-GRADE TO SUPPORT THE DESIGN LOADS.
- 3. CLEAN SAND FILL OVER STRIPPED AND COMPACTED EXTING GD. SHALL BE PLACED IN 12" LIFTS. BOTH SUB-SOIL AND FILLCOMPACTION SHALL BE NOT LESS THAN 98% AS MEASURED BY AMODIFIED PROCTOR TEST AT THE RATE OF ONE TEST FOR EACH 150 SF OF BUILDING PAD AREA, OR FRACTION THEREOF, FOR EACH?" LIFT.
- 4. REINFORCING STEEL SHALL BE GRADE 60 AND MEET THI REQUIRE-MENTS OF ASTM AGIS, ALL BENDS SHALL BE MADE COLD
- 5. WELDED WIRE MESH SLAB REINFORCING SHALL MEET THEREQUIRE-MENTS OF ASTM A185 - MIN. YEILD STRESS = 85 KSI.
- 6. CONCRETE SHALL BE STANDARD MIX F'C = 3000 PSI FOR ALL FTGS, SLABS, COLUMNS AND BEAMS OR SHALL BE STANDARD PUMP MIX F'C = 3000 PSI. STRENGTH SHALL BE ATTAINED WITHIN 28 DAYS OF PLACE-MENT. MIXING, PLACING AND FINISHING SHALL BE AS PER ACI STANDARDS.
- 7. CONCRETE BLOCK SHALL BE AS PER MANUFACTURER'S PRODUCT GUIDE FOR ASTM C-90 REQUIREMENTS WITH MEDIUM SURFACE FINISH F'm = 1500 PSI.
- 8. MORTAR SHALL BE TYPE "M" OR "N" FOR ALL MASONRY UNITS.
- 9. STRUCTURAL STEEL SHALL CONFORM TO ASTM A36 STANDARDS FOR STRENGTH, BOLTS SHALL BE ASTM A307 / GRADE I OR A325, AS PER PLAN REQUIREMENTS.
- 10. WELDS SHALL BE AS PER "AMERICAN WELDING SOCIETY" STANDARDS FOR STRUCTURAL STEEL APPLICATIONS.

REVISION:

9/21/Ø9

REMOVE COLIMN

ADD DBL. 18'LVL

ADD 18" LVL

Copyright 2005 N.P. Geisler, Architect

DRAWN:

COLUMBIA COUNTY, FLORIDA

RCHITECTURAL DRAFTING & DESIGN INC

NICHOLAS
PAUL
GEISLER
1758 NW Brown R

DATE: Ø4SEPT2ØØ9

SHEET:

A2 2 of 2

18 EP 2109 AR0007005

Roof: Engineered Roof System over Wood Joist @ 16" O.C.
Columns: 12"X12" Concrete Column Blocks w/(2) #5 Dowels in filled cell Floor: Existing 4" Thk Concrete Slab Foundation Piers: 12" The Concrete Pads w/#5 Bars @ 8" o.c., e.w.

Material: 5/8" CDX Plywood Sheet Size: 48"x96" Sheets Perpendicular to Roof Framing Fasteners: 8d Common Nails@ 8" O.C. along Rafter

Beam to Column: Simpson HGLBA Beam Seat ea. end (LVL Only) Beam to Column: Simpson STHDIØ ea. Column (U.O.N.)

GENERAL NOTES:

- 1. THE CONTRACTOR SHALL INDEMNIFY THE OWNER AGAINST ALL CLAIMS, WHETHER FROM PERSONAL INJURY OR PROPERTY DAMAGE, ARISING FROM EVENTS ASSOCIATED WITH THE WORK
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- TESTS AND THE LIKE THAT MAY BE REQUIRED BY THE VAR-
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COMPONENTS & CLADING PER TABLES OP'NGS: + 21.8 / - 29.1 PSF 1609.2B \$ 1609.2C (FBC 2007) EAVES: - 68.3 PSF DESIGN WIND PRESSURES: ROOF: + 19.9 / - 25.5 PSF TYPE OF CONSTRUCTION

ROOF DECKING

HURRICANE UPLIFT CONNECTORS Beam to Rafters: Simpson H3 @ Ea. Rafter

All Anchors shall be secured w/Nails as prescribed by the Manufacturer for Maximum Joint Strength

- PERFORMED UNDER THE CONTRACT FOR THIS PROJECT.
- OWNER DURING THE ONE YEAR WARRANTY PERIOD.
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ENGINEERED ROOFING SYSTEM SLOPE/4"/FT. OVER 2X8 ROOF JOIST @ 16" O.C.-12"X12" CMU COLUMNS W/(2) #5 VERTICAL BARS IN FILLED CELL, TYP. (10) LOC.-EXISTING 4" THK. CONCRETE SLAB-

Front ELEVATION

SCALE: 1/4" = 1'-0"

SCALE: 1/4" = 1'-0"

2'-10"

Roof

ENGINEERED ROOFING SYSTEM

OVER 2X8 ROOF JOIST @ 16" O.C.

-12"X12" CMU COLUMNS

IN FILLED CELL,

TYP. (10) LOC.-

W/(2) #5 VERTICAL BARS

SCALE: 1/4" = 1'-0"

EXTERIOR

2'-0"

FTG. 'A'

CORNER

2'-0"

FFTG. 'B'

END

- RE-BAR LOCATION & DIRECTION PLAN -

35'-0"

—(3)L∨L |8"×1 3/4"

(255) 2X8 OUTRIGGERS @ 16" O.C.

-EDGE OF CONCRETE SLAB BELOW

de ELEVATION

€=

EXTERIOR

3'-0"

FTG. 'C'

SIDE

-(3)LVL 18"X1 3/4"

2'-10"

NOTE: PROVIDE (1) ROW OF 2X8 BRIDGING AT MID-SPAN OF EACH JOIST

REVISION:

DRAWN:

DJR


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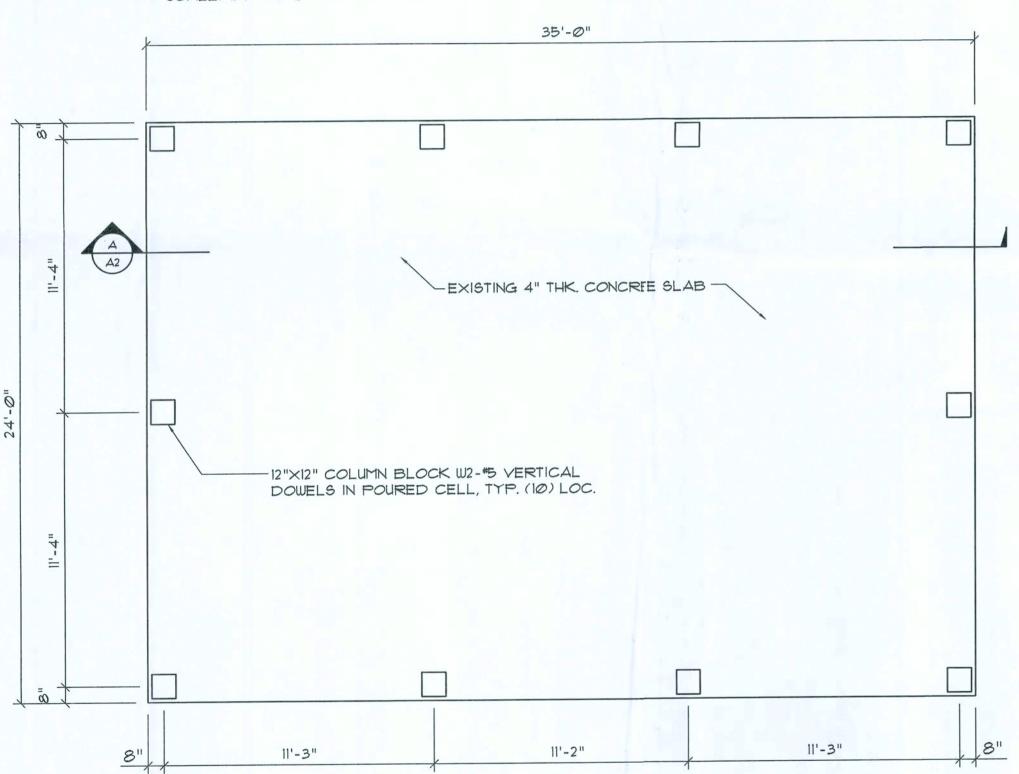
OF





CORNERS

2'-0"

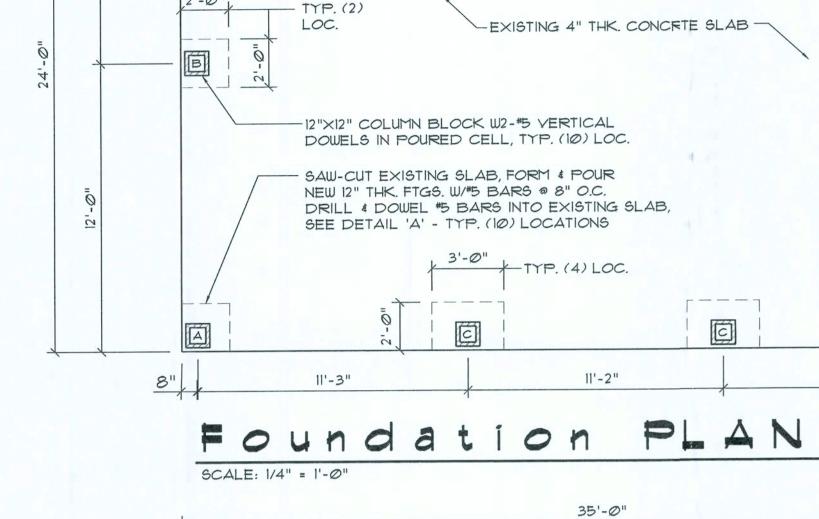


35'-0"

11'-3"

PLAN 0 0 r

SCALE: 1/4" = 1'-0"

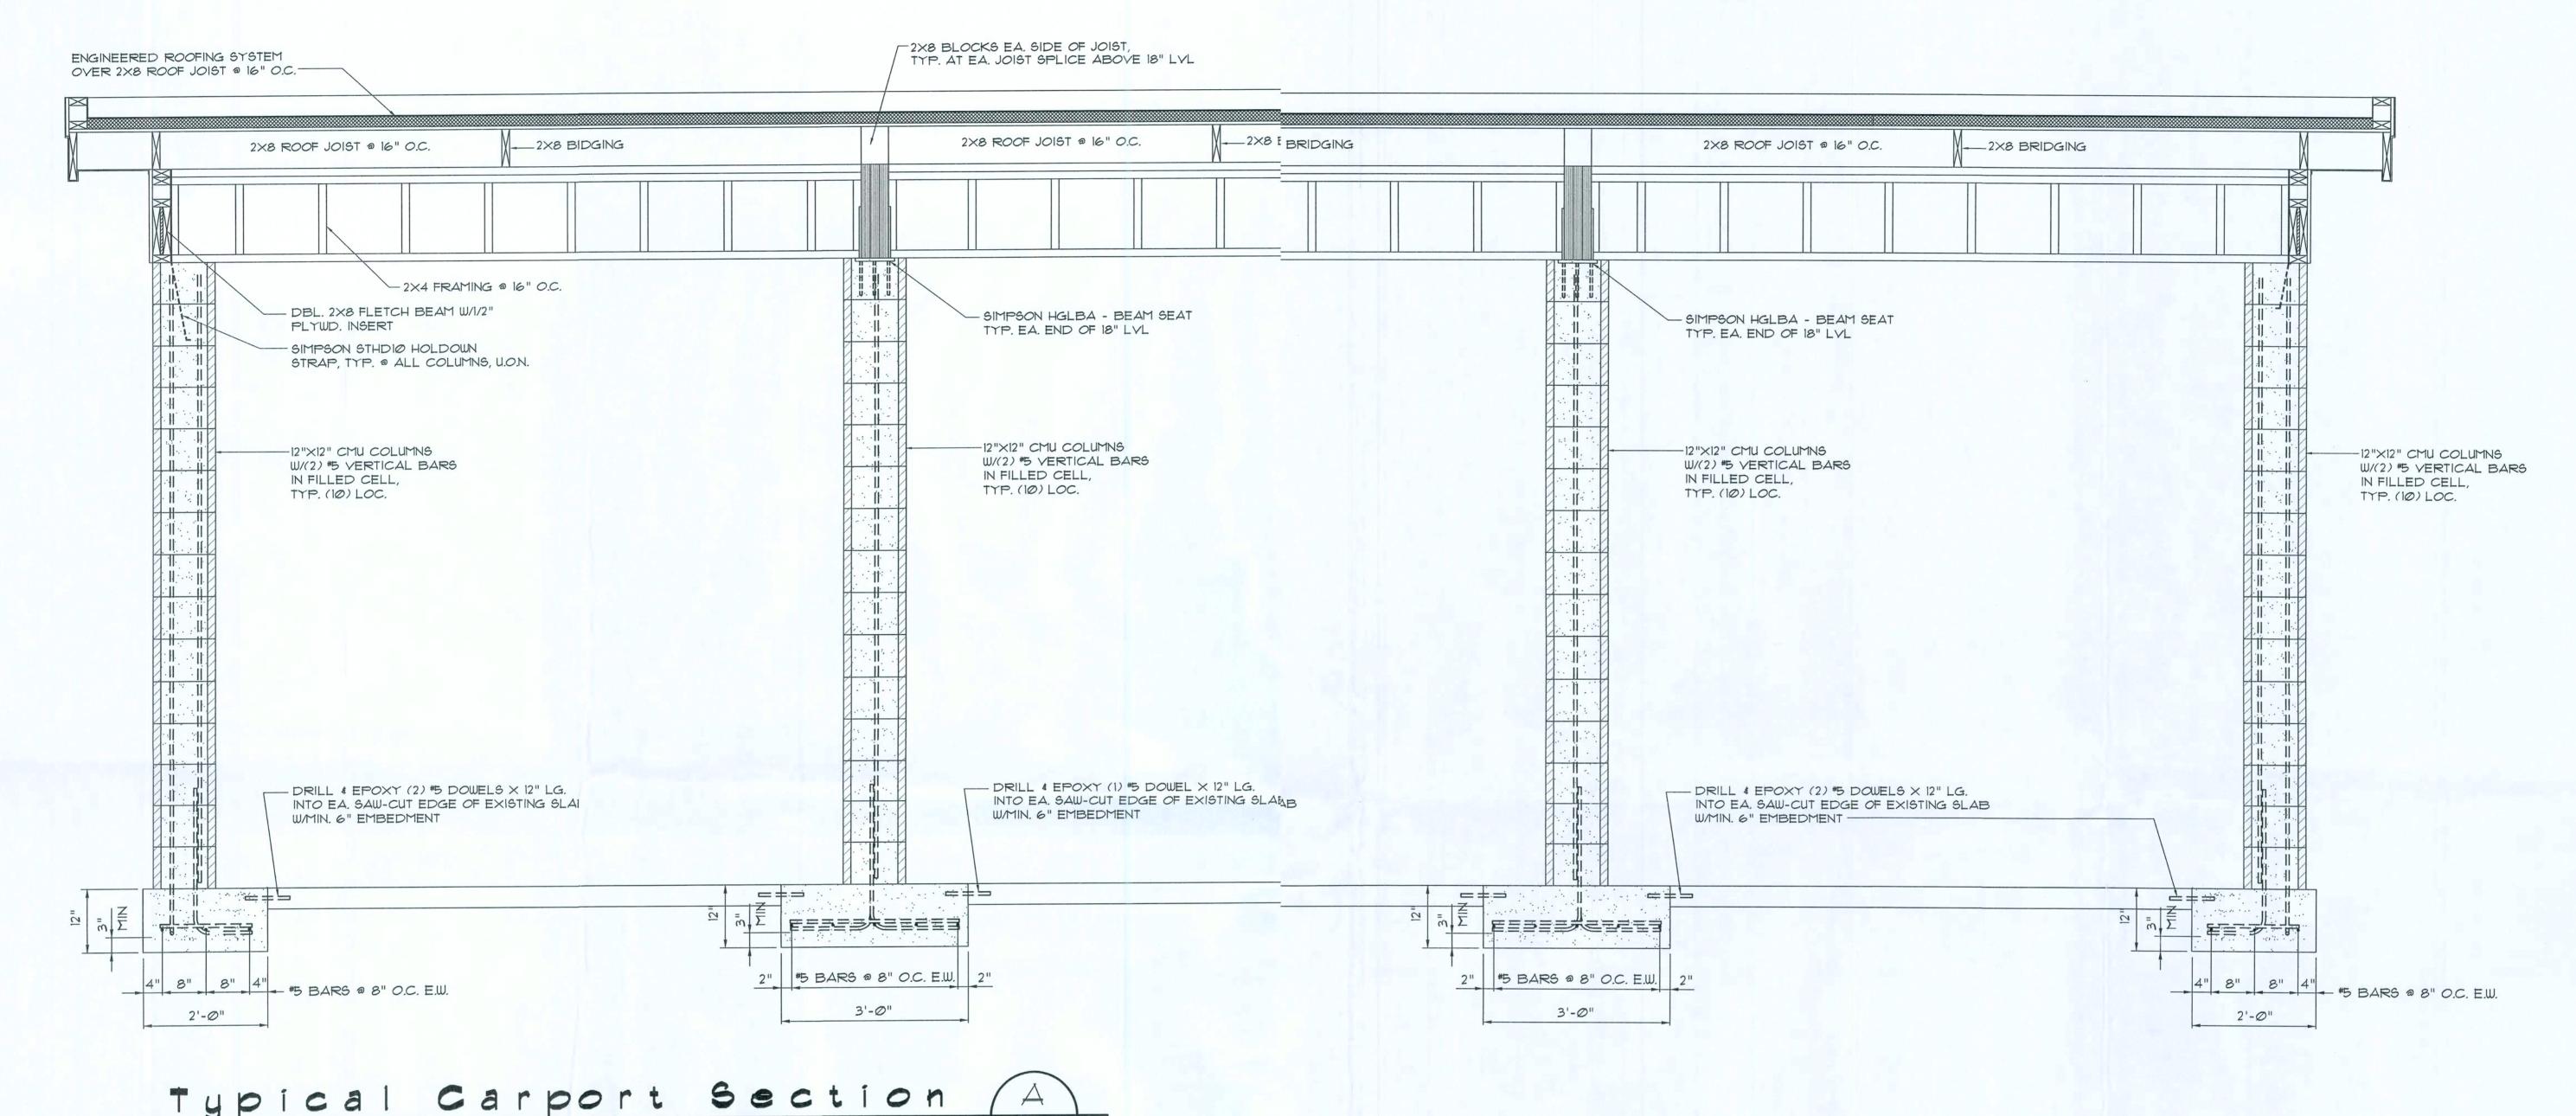

CONCRETE / MASONRY / METALS GENERAL NOTES:

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- 10. WELDS SHALL BE AS PER "AMERICAN WELDING SOCIETY" STANDARDS FOR STRUCTURAL STEEL APPLICATIONS.

REVISION:

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DJR

ton Designed Carport for:

UNINO ON TO THE ORIDA

COLUMBIA COUNTY, FLORIDA

ICHOLAS
PAUL
GEISLER
CHITECT (1/20 INW. DIOWIL RG.

DATE:

Ø4SEPT2ØØ9 COMM:

SHEET:

2 of 2

09/09/09 AR0007005