



PARTIAL MECHANICAL FLOOR PLAN - NEW SCALE 1/4" = 1'-0"

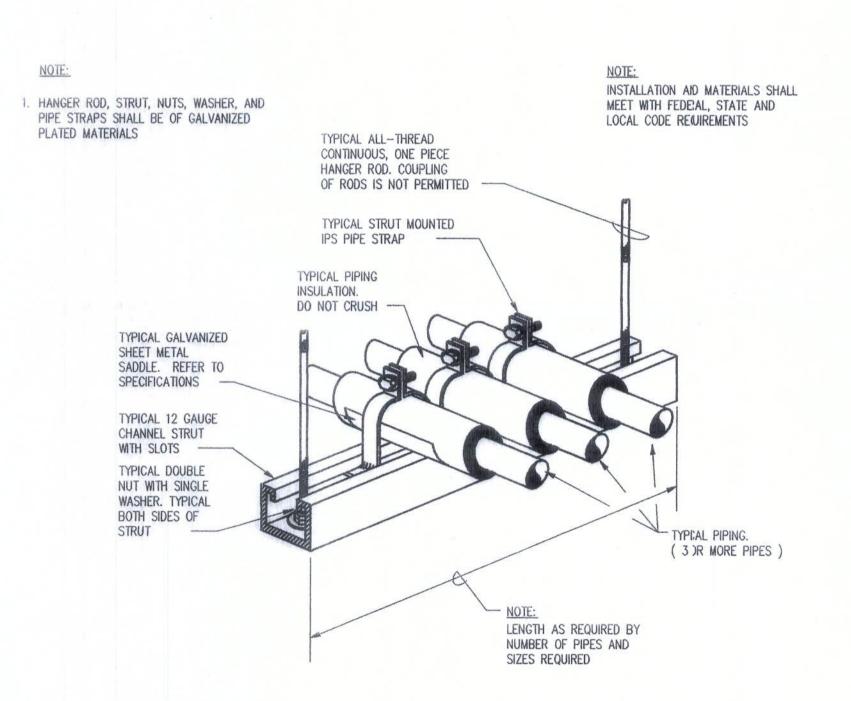

DETAIL NO SCALE

MULTIPLE PIPING STRUT HANGER DETAIL

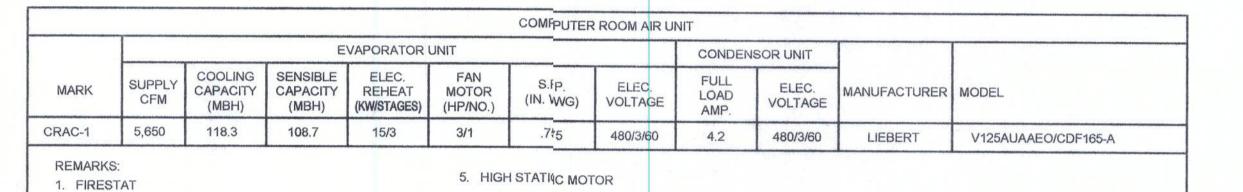

GENERAL NOTES

2. STANDARD MICROPROCESSOR CONTROL

3. NON-LOCKING EVAPORATOR DISCONNECT

4. UNDERFLOOR WATER DETECTION-(2) LIQUITECTS

- 1. ALL MECHANICAL SYSTEMS ARE TO BE INSTALLED IN ACCORDANCE WITH ALL APPLICABLE SECTIONS OF THE NFPA STANDARDS, ALNSI STANDARDS, THE LOCAL BUILDING CODE, PLANS AND SPECIFICATIONS.
- 2. ALL MATERIALS SHALL BE NEW AND ALL WORKMANSHIP AND MATERIALS SHALL BE IN STRICT ACCORDANCE WITH APPLICABLE LOCAL CODES, PRODUCT APPROVAL, RULES AND ORDINANCES. ANY DAMAGED EQUIPMENT SHALL BE REPLACED OR RESTORED TO ORIGINAL CONDITION.
- 3. THE CONTRACTOR SHALL PROVIDE ALL LABOR, MATERIALS, EQUIPMENT, ACCESS
- PANELS, CONTROL SYSTEMS, DEVICES, PERMITS AND SERVICES NECESSARY FOR FURNISHING AND INSTALLING A COMPLETE SERVICEA, BLE MECHANICAL SYSTEM.

 4. ALL LOUVERS, GRILLES, PIPING, ETC. SHALL BE PAINTED TO MATCH SURROUNDING COLOR AND TEXTURES AS REQUIRED BY ARCHITECT. VERIFY COLOR AND TEXTURE WITH ARCHITECT. PAINT ALL EXPOSED MECHANICAL EQUIPMENT WITH BENJAMIN MOORE EPOXY ENAMEL 182.
- 5. ALL CUTTING, PATCHING, STRUCTURAL STEEL, WEATHER PROOFING, PAINTING,
- AND WALL OPENINGS SHALL BE BY THE GENERAL CONTRACTOR. 6. ALL OPENINGS IN BUILDING STRUCTURE FOR DUCTWORK, PIPING, ETC. TO BE 1/2" LARGER (ON ALL SIDES) THAN THE OUTSIDE IDIMENSIONS. FILL VOIDS WITH FIRE RETARDANT SILICONE FOAM (I.E., CHASE-FOAM CTC PR-855 BY CHASE
- 7. BUILDING HVAC CALCULATIONS ARE BASED ON THE FOLLOWING: INDOOR DESIGN - SUMMER 75°F DB/50% RH, WINTER 70°F DB. B. OUTDOOR DESIGN - SUMMER 94°F DB/76° FWEB, WINTER 37°F DB.
- 8. PROVIDE FLEXIBLE DUCT CONNECTORS, RATED AS REQUIRED, TO ALL FANS, A/C UNITS, OR MECHANICAL EQUIPMENT, EXCEPT HOOD EXHAUST FANS.


DUCTWORK & ACCESSORIES NOTES

- 1. ALL DUCTWORK TO BE SHEET METAL.
- A. SUPPLY SHEET METAL WITH INSULATION.
- 2. ALL DUCTWORK AND DIFFUSERS SHALL BE RATED FOR THE USE, PRESSURE AND TEMPERATURE SPECIFIED AND AS REQUIRED BY THE CEILING SYSTEM RATING.
- 3. ALL DUCTWORK SHALL BE BUILT AND INSTALLED IN ACCORDANCE WITH "SMACNA"
- STANDARDS AND LOCAL BUILDING CODES. 4. ALL DUCT SIZES ARE CLEAR INSIDE DIMENSIONS.
- 5. SEAL ALL DUCTS, JOINTS AND BEAMS IN AN APPROVED MANNER AND INSURE
- 6. INSULATION:

INSULATION FOR DUCT SYSTEMS

INSULATE WITH A MINIMUM OF 2 INCH THICK FIBERGLASS BLANKET WRAP APPLIED OVER CLEAN, DRY SHEET METAL DUCTWORK INSTALLED) TO ALLOW MAXIMUM FULLNESS AT CORNERS (AVOID EXCESSIVE COMPRESSION). ADHERE DUCT INSULATION TO METAL AND PROVIDE CONTINUITY OF VALPOR RETARDANT IN ACCORDANCE WITH THE MANUFACTURER'S RECOMMENDATIONS. WHERE DUCT WIDTH EXCEEDS 24 INCHES, THE INSULATION SHALL BEE ADDITIONALLY SECURED TO THE BOTTOM OF THE DUCT USING MECHANICAL FASTENIERS SPACED 1 FOOT ON CENTER TO PREVENT SAGGING OF THE INSULATION.

DUCTWORK INSULATION SHALL BE INORGANIC FIBROUS GLASS, FLEXIBLE BLANKET OF GLASS FIBER FACTORY LAMINATED TO A REINFORCETD FOIL KRAFT (FRK) VAPOR RETARDANT WITH A MINIMUM 2 INCH TAPING AND STAPPLING FLANGE ON ONE EDGE. SUITABLE FOR OPERATION AT TEMPERATURES FROM 40 DEGREES F. TO 250 DEGREES F. THERMAL CONDUCTIVITY OF 0.31 AT 75 DIEGREES F. MINIMUM DENSITY

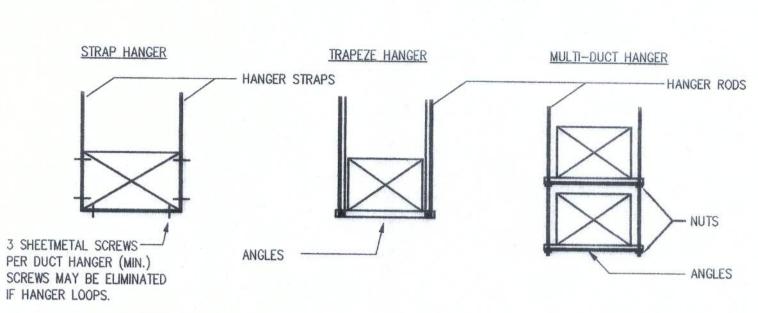

MAXIMUM DUCT WIDTH	MAXIMUM SPACING	WIRE SIZE	ROD SIZE	STRAP SIZE	TRAPEZE SIZE
24	10'-0"	10 GAUGE		1"x22 GAUGE	1x1x16 GAUGE
58	10'-0"	400 May 1000	3/8"	1"x18 GAUGE	1x1x1/8
77	10'-0"		3/8"	1"x16 GAUGE	1.5x1.5x1/8
96	10'-0"		1/2"	1-1/2"x16 GAUGE	1.5x1.5x1/4
134	10'-0"		1/2"	1-1/2"x16 GAUGE	2.5x2.5x1/8
154	8'-0"		1/2"	1-1/2"x16 GAUGE	2.5x2.5x3/16
155					

- 1. STRAPS ARE GALVANIZED STEEL; RODS ARE UNOATED OR GALVANIZED STEEL; WIRE IS BLACK ANNEALED, BRIGHT BASIC OR GALVANIZED STEEL. ALL ARE ALTERNATIVES.
- 2. TABLE ALLOWS FOR CONVENTIONAL WALL THICKNESS, AND JOINT SYSTEMS PLUS ONE LB/SF OF INSULATION WEIGHT. IF HEAVIER DUCTS ARE TO BE INSTALLED, ADJUST HANGER SIZES TO BE WITHIN THIER LOAD LIMITS.

RECTANGULAR DUCT HANGERS

- 3. WHEN STRAP HANGERS ARE LAP JOINED USE THES MINIMUM FASTENERS: 1"x 18, 20, 2GUAGE 2-#10 OR OR 1-1/4" BOLT
- 1"x 16 GUAGE 2-1/4" BOLTS 1"x 14 GUAGE

2-3/8" BOLTS 4. REFER TO SMACNA HVAC CONSTRUCTION STANDARDS FOR ADDITIONAL INFORMATION.


DETAIL NO SCALE

AIR DISTRIBUTION LEGEND

	— DIFFUSER
	DIFFUSER TYPE. SEE SCHEDULE
A12"ø	DIFFUSER NECK SIZE. FLEXIBLE DUCT SIZE EQUAL TO DIFFUSER NECK SIZE.
	- AIR QUANTITY (CFM)
	- FLEXIBLE DUCT. SIZE EQUAL TO DIFFUSER NECK SIZE

AIR DISTRIBUTION SCHEDULE

TYPE	DESCRIPTION	
(A)	24X24 SQUARE LOUVERED FACE DIFFUSER WITH ROUND NECK. TITUS MODEL TMS-AA. COLOR: WHITE	
B		
0		
0		
E		
(F)		

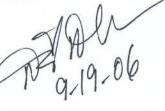

TELECOMMUNICATIONS M FOR CLIENT LOGIC

NEW

CONTRACT SHEET NO. W.W. GAY SHEET NO. CAD FILE NAME

M101. DWG DRAFTING JOB NUMBER DRAWING NUMBER:

M101