

REAR ELEVATIONS

৹ঠ FRONT


CONTRACTING Rolling
Aorning Glory Drive Lot 10, Rollin
Address: 311 Morning Glory
GIBRALTAR 2145 (L **10,** 311 M


© WN DESGN &
ASSICIATES, INC.
426 SW COMMERCE DR, STE 130
LAKESITY, FL 32025
(386) 758-8406
will@willmyers.net



JOBNUMBER 20200505

SHEET NUMBER A.1 OF4 SHEETS

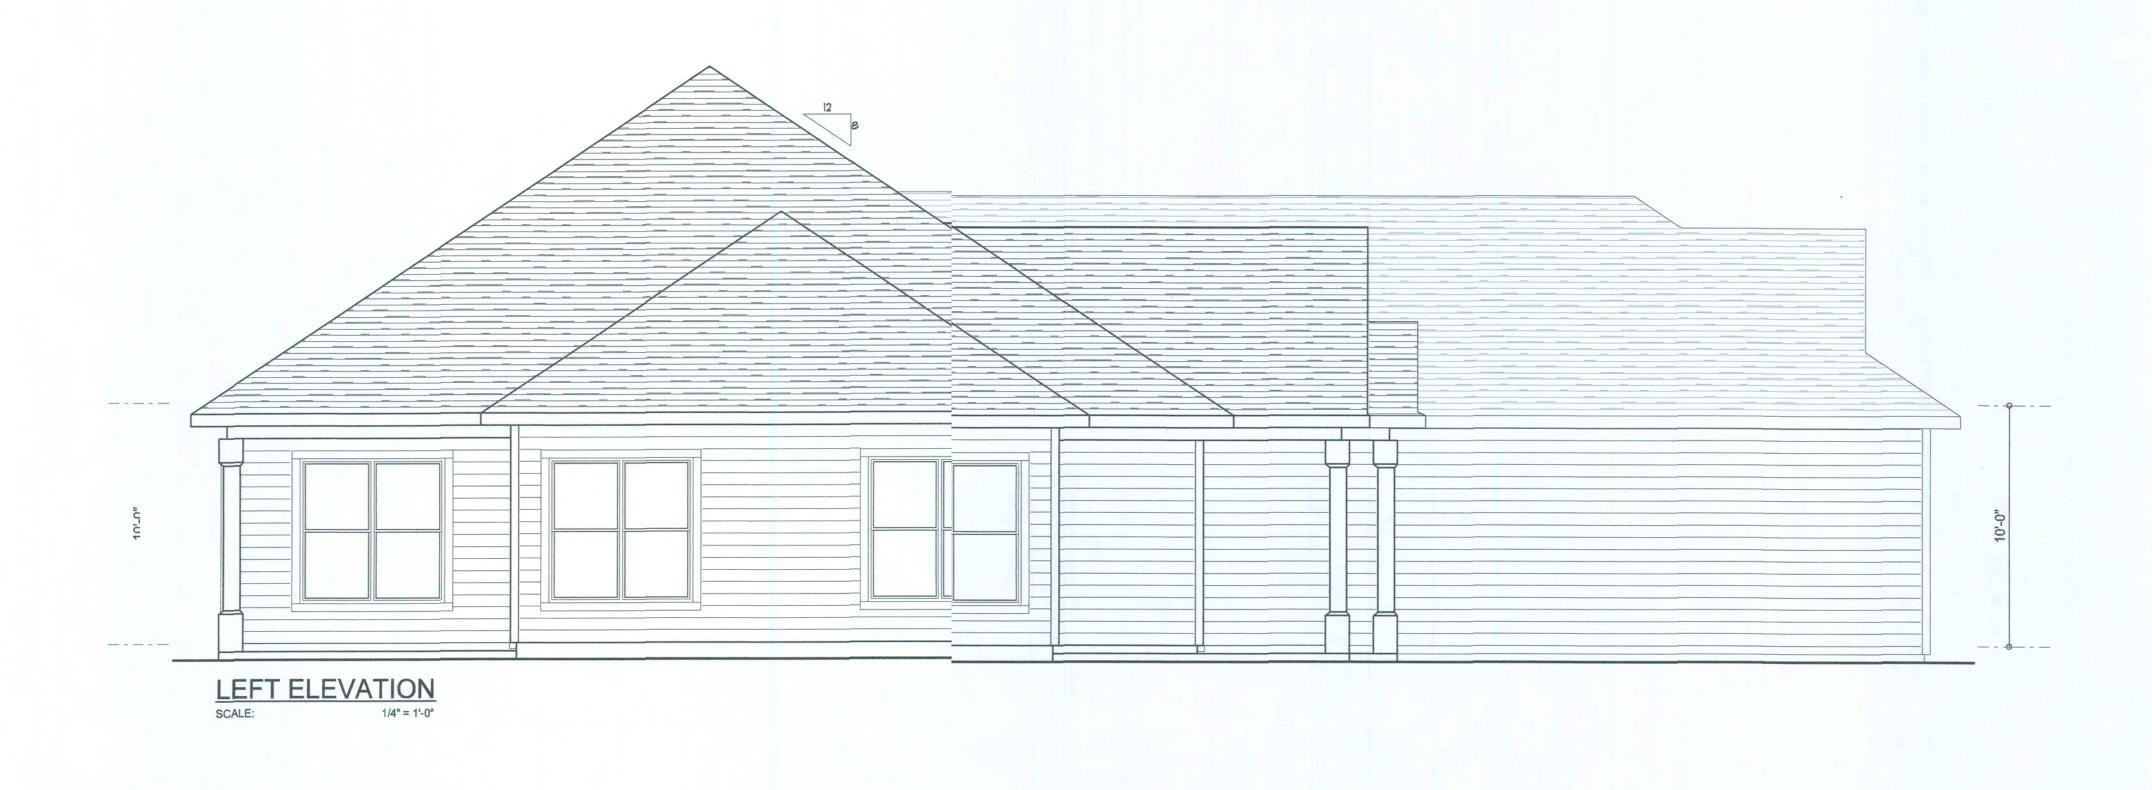

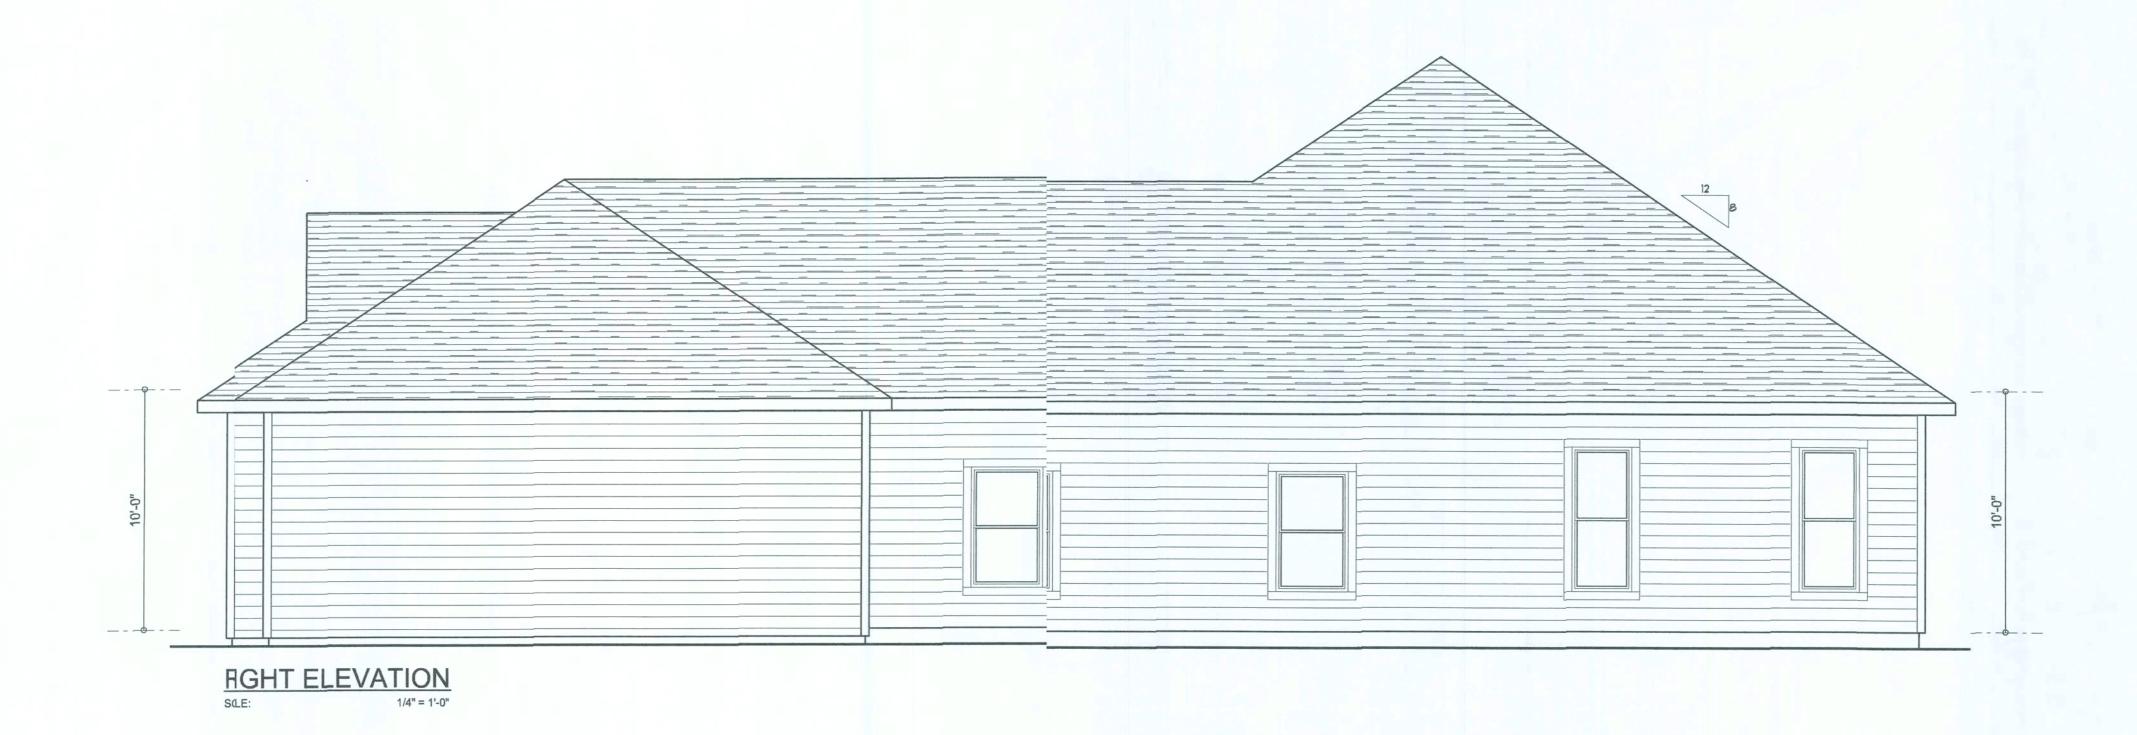

Parcel # 15-4S-16-03023-510)
TYPICAL WALL SCALE:

SC-TPLYN ARCHITETURAL DESIGN SOFTWARE

SECTION 1"=1:0"


MODEL 2145 (LEFT-HAND, 3-car) FOR:

Lot 10, Rolling Moadows

Address: 311 Morning Glory Drive, Lake City, Florida 32024 (Parcel # 15-48-GIBRALTAR CONTRACTING, LLC.


LIC# 1259633 HIGH SPRINGS, FLORIDA

© WI DESIGN &
ASSIGNATES, INC.
426 SW COMMERCE DR, STE 130
LAKECITY, FL 32025
(386) 758-8406
wil@willmyers.net

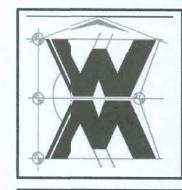

JOI NUMBER 20200505

A.2
OF 4 SHEETS

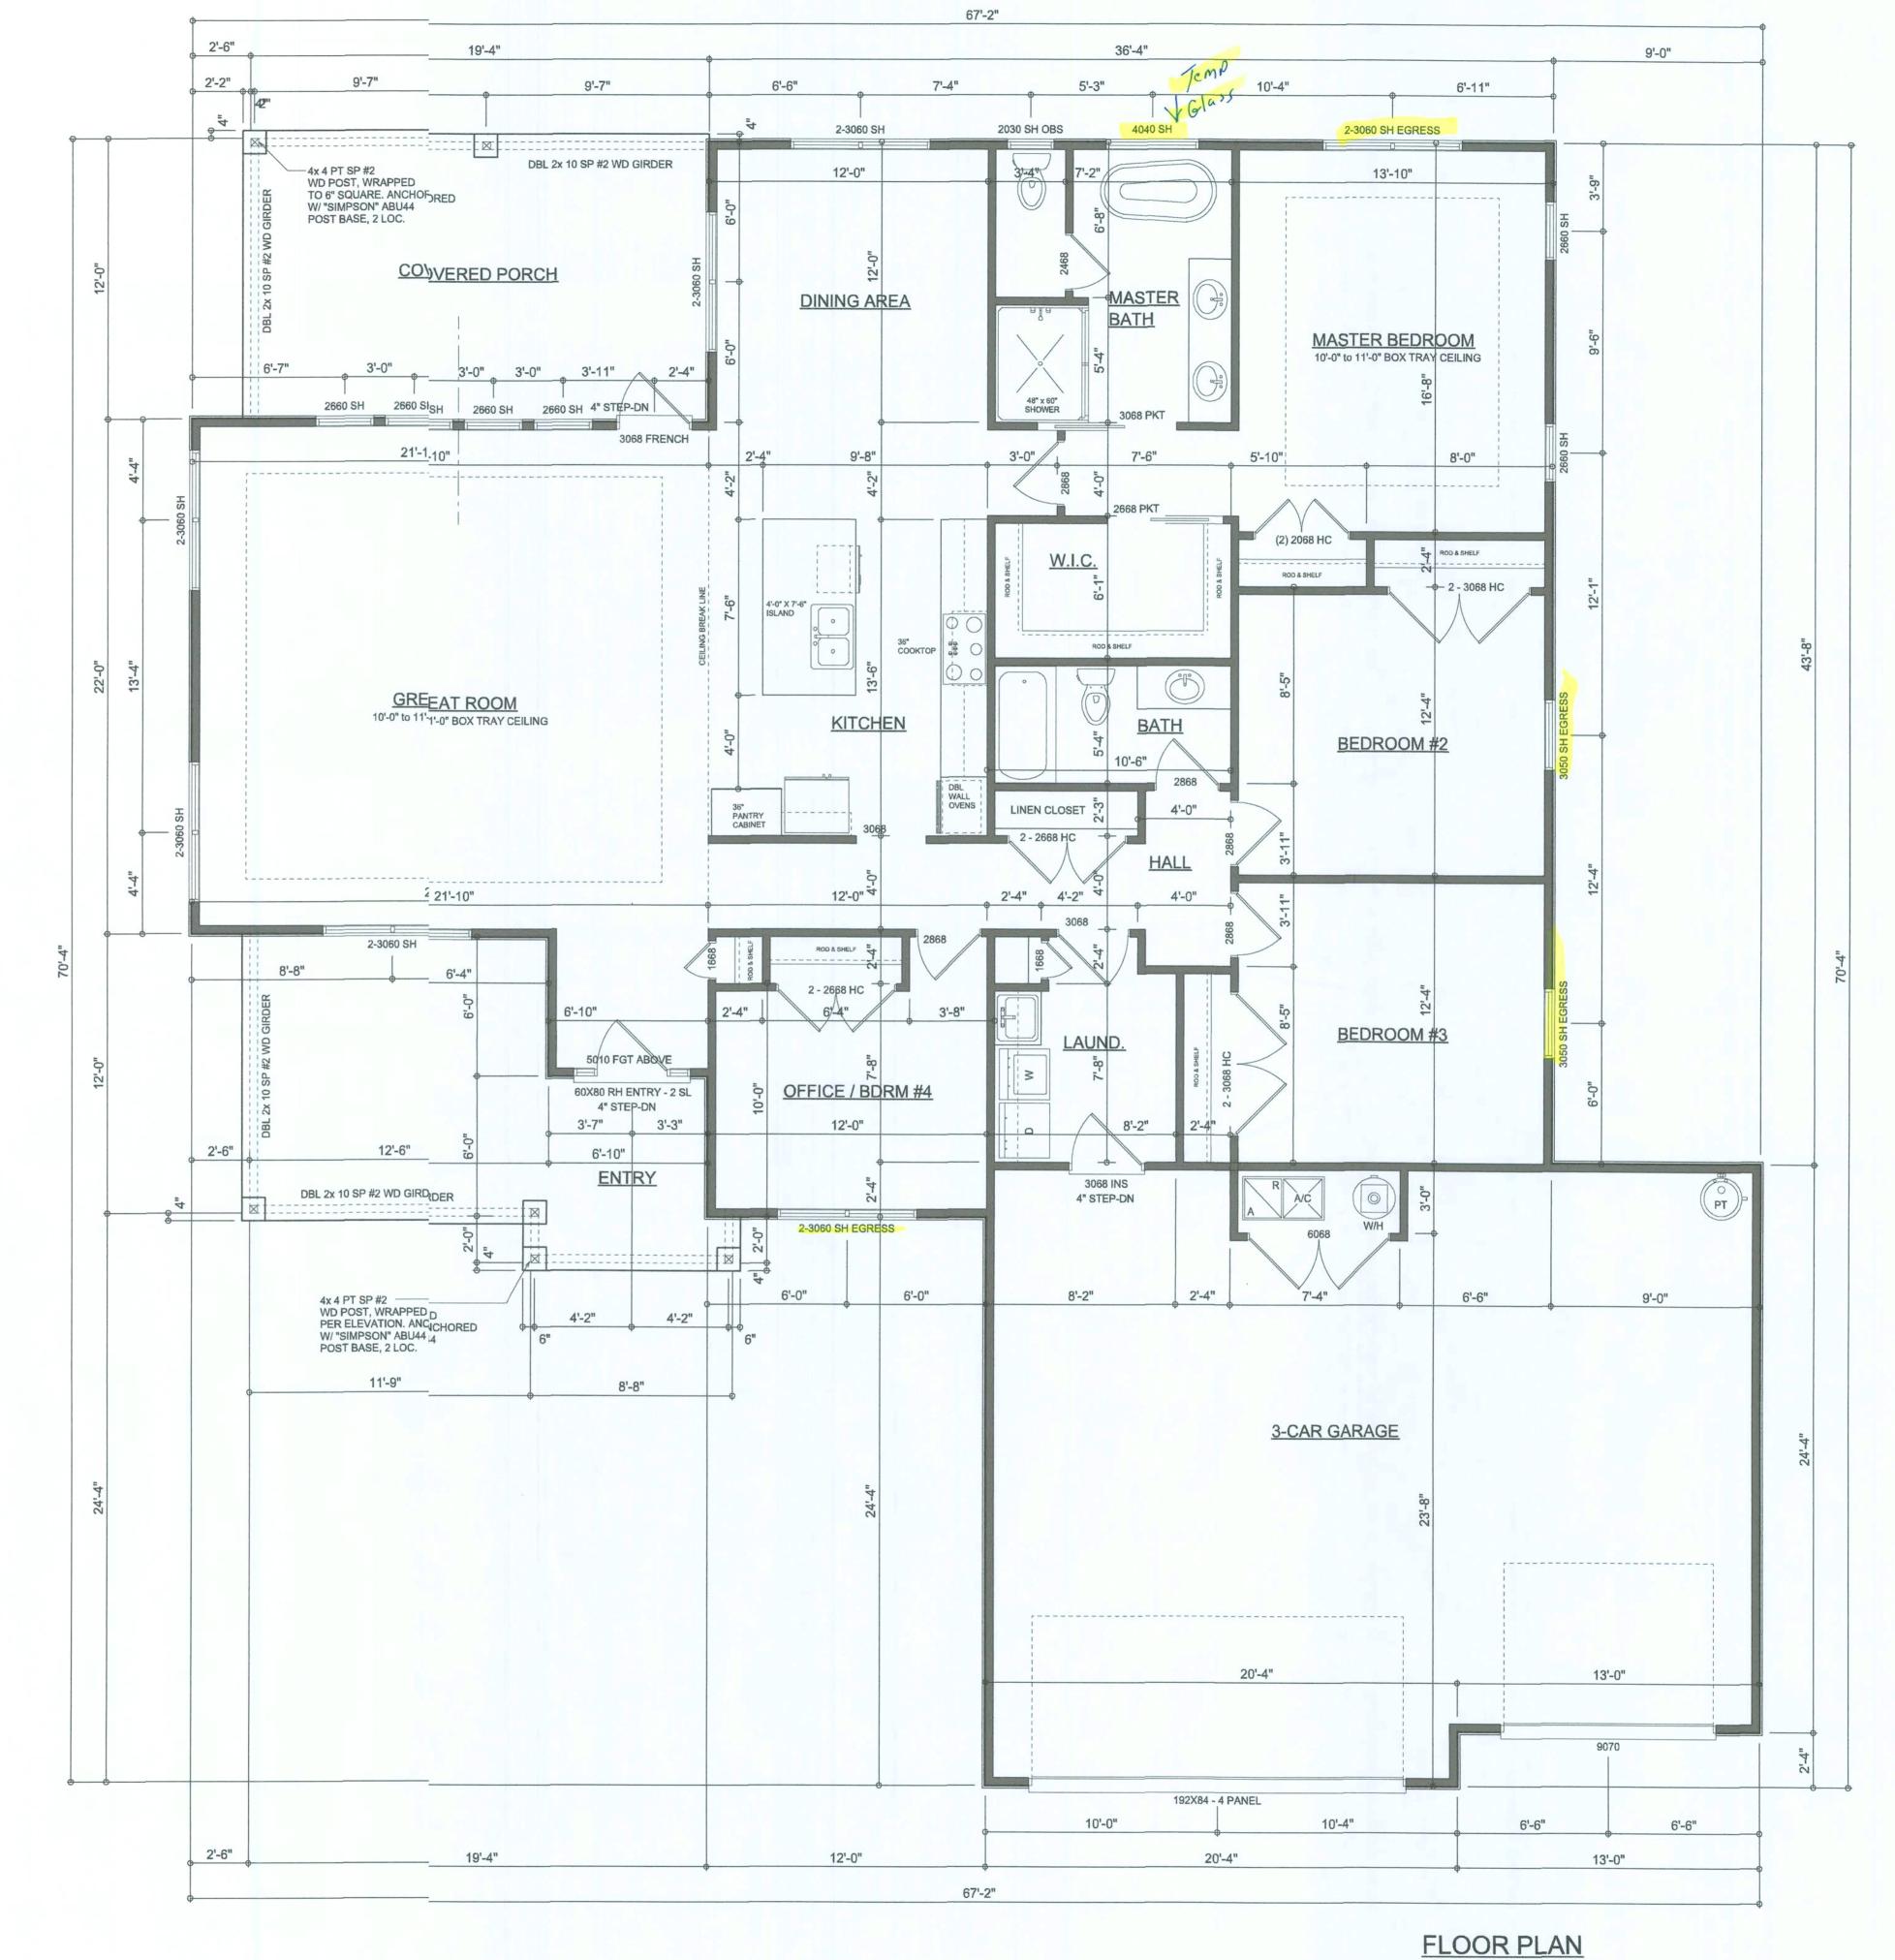

AREA SUMMARY

LIVING AREA 2,145 S.F.
GARAGE AREA 850 S.F.
COVERED PORCH AREA 232 S.F.
ENTRY PORCH AREA 208 S.F.
TOTAL AREA 3,435 S.F.

Garage fire separations shall comply with the fllowing:

1. The private garage shall be separated from the dwelling ur and its attic area by means of a minimum ½-inch (12.7 mm) gypsum board applied to the arage side. Garages beneath habitable rooms shall be separated from all habitable rooms above by not less than 5/8-inch Type X gypsum board or equivalent. Door openings between a privatgarage and the dwelling unit shall be equipped with either solid wood doors, or solid or honeycombore steel doors not less than 13/8 inches (34.9 mm) thick, or doors in compliance with Section 715.3.3. Opengs from a private garage directly into a room used for sleeping purposes shall not be permitted.

- Ducts in a private garage and ducts penetrating the walls oceilings separating the dwelling unit from the garage shall be constructed of a minimu 0.019-inch (0.48 mm) sheet steel and shall have no openings into the garage.
- 3. A separation is not required between a Group R-3 and U caport provided the carport is entirely open on two or more sides and there are not enclosed reas above.
- 4. When installing an attic access and/or pull-down stair unit ithe garage, devise shall have a minimum 20 min. fire rating.

FLOOR PLAN

SCALE: 1/4" = 1'-0"

NOTE: ALL WALLS SHALL BE 10'-0" UNLESS OTHERWISE NOTED.

Vul C-Any

LCAA OF 4 SHEETS

3 VAICE SIGN &

A550CIATE 5. NC. 426 SWCOMMERCE DR, STE 130 LKE CITY, FL 32025

(36) 758-8406 vill@willmyers.net

JOB NUMBER

20200505


SHEET NUMBER

SOFTPLAN

FLOOR PLAN

DIMENSIONED SCALE:

NOTE: ALL DRAWINGS NOT TO BE SCALED, WRITTEN DIMENSIONS TAKE PRECEDENCE OVER SCALED DIMENSIONS

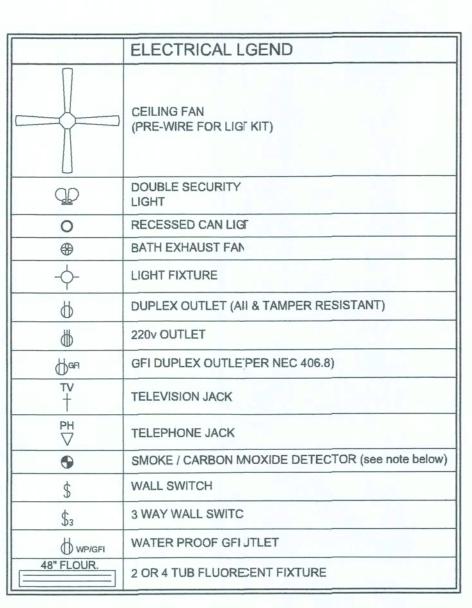


ALL INTERIOR RECEPTACLES SHALL BE &I (ARC FAULT CIRCUIT INTERRUPT) PER NE210.12 & TAMPER RESISTANT PER

ALL SMOKE DETECTORS BE A COMBO SMKE & CARBON MONOXIDE DETECTOR AND SHALL HAVE BATTERY BACKUP POWR AND ALL WIRED TOGETHER SO IF ANY ON UNIT IS ACTUATED THEY ALL ACTIVATE.

THE ELECTRICAL SERVICE OVERCURRENPROTECTION DEVICE SHALL BE INSTALLED ON THE EXTERIOR OF STRUCIRES TO SERVE AS A DISCONNECT MEANS. CONDUCTORS USED FROM THE EXTERIODISCONNECTING MEANS TO A PANEL OR SUB PANEL SHALL HAVE FOUR-WIRE CONDUCTRS, OF WHICH ONE CONDUCTOR SHALL BE USED AS AN EQUIPMENT GROUD.

IT IS THE LICENSED ELECTRICAL CONTRATORS RESPONSIBILITY TO INSURE THAT ALL WORK PERFORMED AND EQUIPMENT INSILLED MEETS OR EXCEEDS THE NFPA70 2014 NATIONAL ELECTRIC CODE AND ALL OTHER LOCAL DDES AND ORDINANCES.

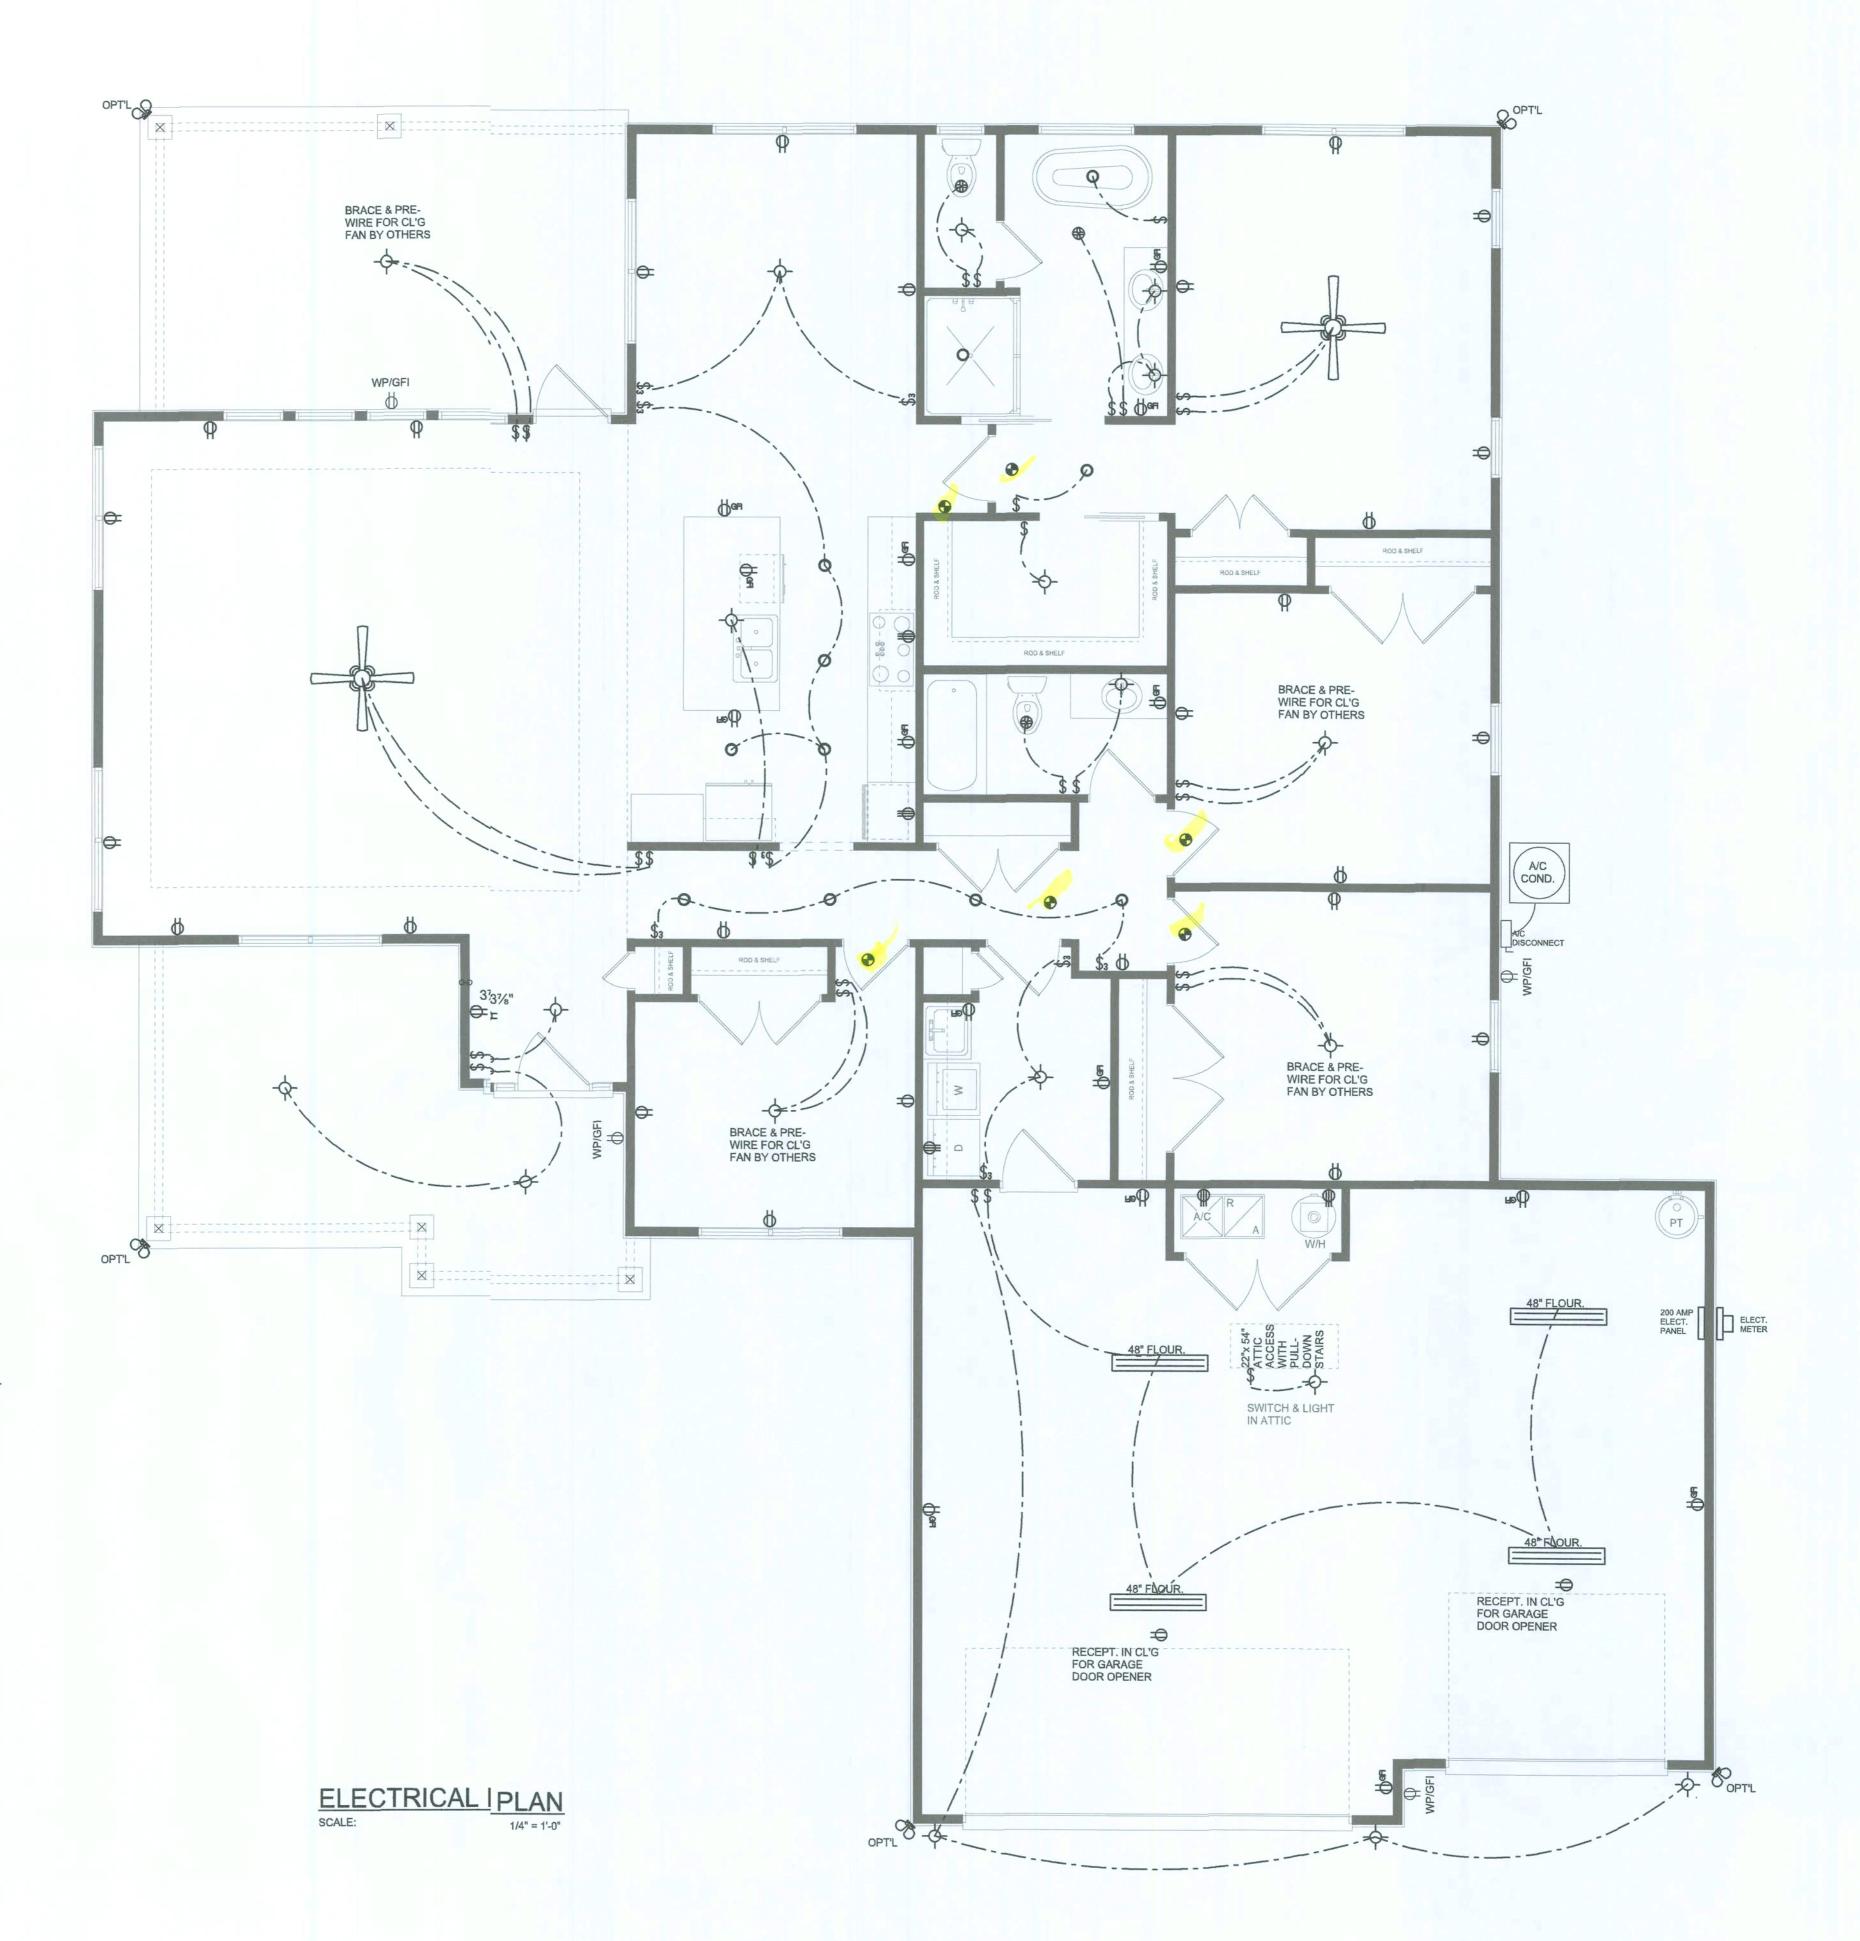

SHEET NUMBER A.4 **OF4 SHEETS**

SOFTPEN ARCHITECURAL DESIGN SOFTWARE

PLAN 1/4" = 1'-0"

A

ELECTRIC/ SCALE:

ACTING,

Meadows

L 2145 (LEFT-HAND, 3-car) . **10, Rolling** s: 311 Morning Glory Drive

Lot Address:


© WN DESIGN &
ASSIGNATES, INC.
426 SW COMMERCE DR, STE 130
LAKE SITY, FL 32025
(386 758-8406
will will mill more not


will@willmyers.net

JOBNUMBER 20200505

GIBI

NOTE: ALL DRAWINGS NOT TO BE SCALED, WRITTEN DIMENSIONS TAKE PRECEDENCE OVER SCALED DIMENSIONS

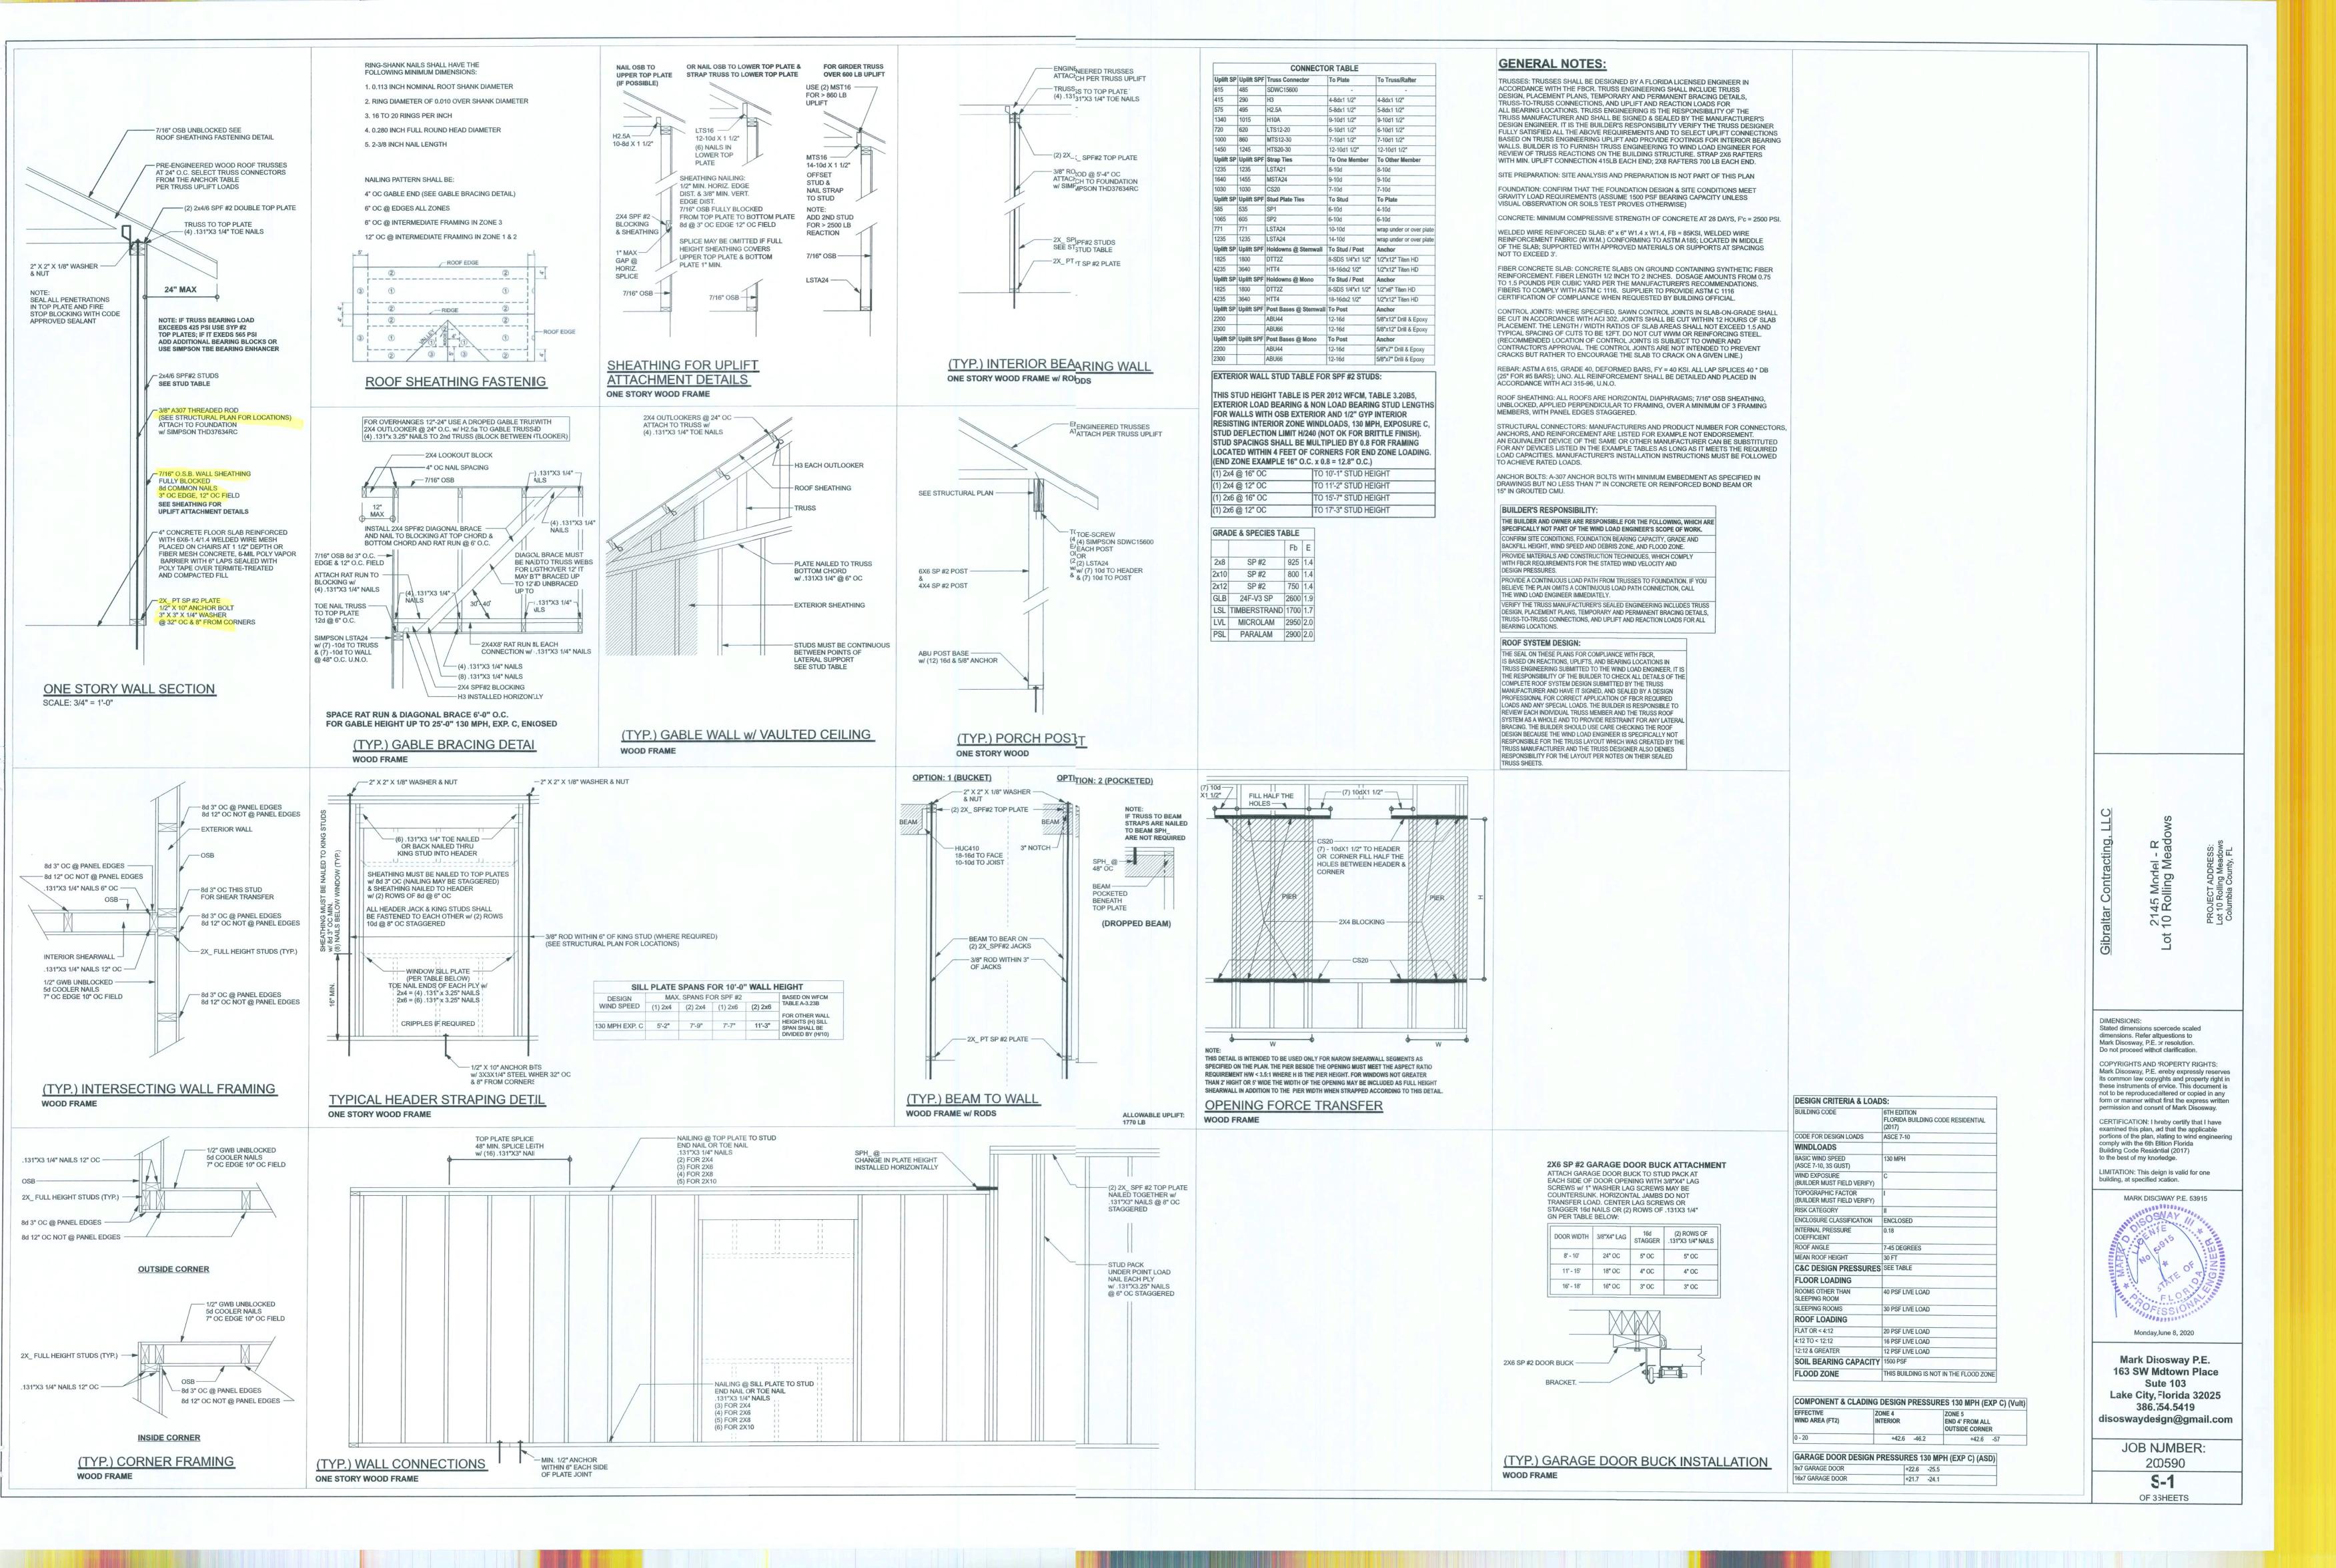


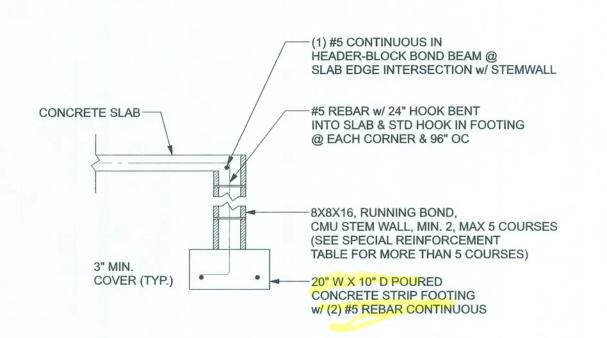


F1 OPTIONAL STEM WALL FOOTING S-2 SCALE: 1/2" = 1'-0"

CONCRETE SLAB	
	12" W X 20" D FOR HOUSE & 12" W X 16" D FOR PORCH MONO FOOTING w/ (2) #5 CONTINUOUS


F1 MONOLITHIC FOOTING
S-2 SCALE: 1/2" = 1'-0"

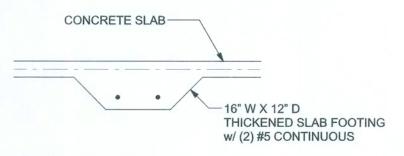


F2 INTERIOR BEARING FOOTING
S-2 SCALE: 1/2" = 1'-0"

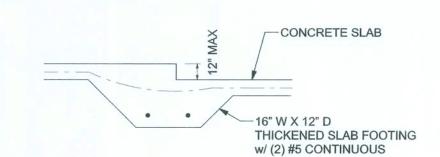

F3 INTERIOR BEARING STEP FOOTING
S-2 SCALE: 1/2" = 1'-0"

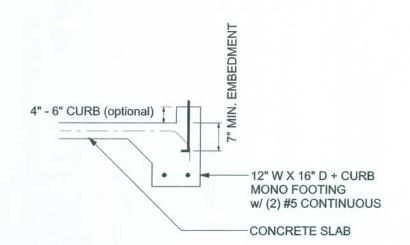

F4 MONOLITHIC CURB FOOTING S-2 SCALE: 1/2" = 1'-0"

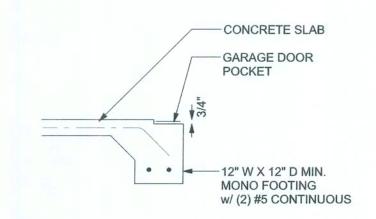

F5 GARAGE DOOR POCKET FOOTING
S-2 SCALE: 1/2" = 1'-0"

TALL S:M WALL TABLE:
The tab assumes 60 ksi reinforcing bars with 6" hook in the footing and bent 24" into the reinford slab at the top. The vertical steel is to be placed toward the tension side of the CMU w (away from the soil pressure, within 2" of the exterior side of the wall). If the wall is over high, add Durowall ladder reinforcement at 16"OC vertically or a horizontal bond beam w 1#5 continuous at mid height. For higher parts of the wall 12" CMU may be used with reinrocement as shown in the table below.


HEIGH B	UNBALANCED BACKFILL HEIGHT	VERTICAL REINFORCEMENT FOR 8" CMU STEMWALL (INCHES O.C.)			VERTICAL REINFORCEMENT FOR 12" CMU STEMWALL (INCHES O.C.)		
		#5	#7	#8	#5	#7	#8
3.	3.0	96	96	96	96	96	96
4.0	3.7	96	96	96	96	96	96
4.7	4.3	88	96	96	96	96	96
5.3	5.0	56	96	96	96	96	96
6.0	5.7	40	80	96	80	96	96
6.7	6.3	32	56	80	56	96	96
7.3	7.0	24	40	56	40	80	96
8.0	7.7	16	32	48	32	64	80
8.7	8.3	8	24	32	24	48	64
9.3	9.0	8	16	24	16	40	48

MASO SHAL FOR I THE O PROO BETW ANY I	L'ONFORM TO ALL REQUESONRY STRUCTURES" CNTRACTOR AND MASOI CEDING, NOTIFY THE ENG VEN ACI 530.1-02 AND TH	D MATERIALS FOR THIS PROJECT JIREMENTS OF "SPECIFICATION (ACI 530.1/ASCE 6/TMS 602). N MUST IMMEDIATELY, BEFORE GINEER OF ANY CONFLICTS ESE DESIGN DRAWINGS. -02 MUST BE APPROVED BY		
	CI530.1-02 Section	Specific Requirements		
1.4A	ompressive strength	8" block bearing walls F'm = 1500 psi		
2.1	Iortar	ASTM C 270, Type N, UNO		
2.2	irout	ASTM C 476, admixtures require approval		
2.3	:MU standard	ASTM C 90-02, Normal weight, Hollow, medium surface finish, 8"x8"x16" running bond and 12"x12" or 16"x16" column block		
2.3	lay brick standard	ASTM C 216-02, Grade SW, Type FBS, 5.5"x2.75"x11.5"		
2.4	einforcing bars, #3 - #11	ASTM 615, Grade 40, Fy = 40 ksi, Lap splices min 40 bar dia. (25" for #5)		
2.4F	oating for corrosion protection	Anchors, sheet metal ties completely embedded in mortar or grout, ASTM A525, Class G60, 0.60 oz/ft2 or 304SS		
2.4F	oating for corrosion protection	Joint reinforcement in walls exposed to moisture or wire ties, anchors, sheet metal ties not completely embedded in mortar or grout, ASTM A153, Class B2, 1.50 oz/ft2 or 304SS		
3.3.E.2	ipes, conduits, and accessories	Any not shown on the project drawings require engineering approval.		
3.3.E.7	ovement joints	Contractor assumes responsibility for type and location of movement joints if not		


MASORY NOTE:

BODM OF EXTERIOR FOOTINGS SHALL BE A MINIMUM OF 12" ELOW UNDISTURBED SOIL OR ENGINEERED FILL PERBC 2014-RES. SECTION R403.1.4

detailed on project drawings.

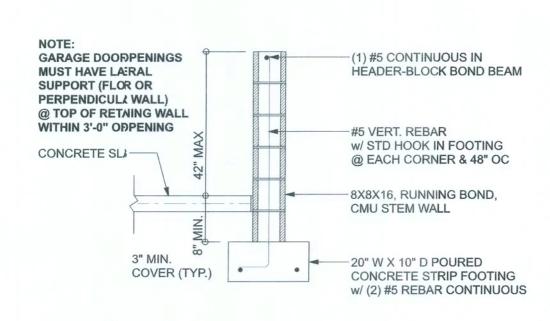

F4 OPTIONAL STEM WALL CURB FOOTING
S-2 SCALE: 1/2" = 1'-0"

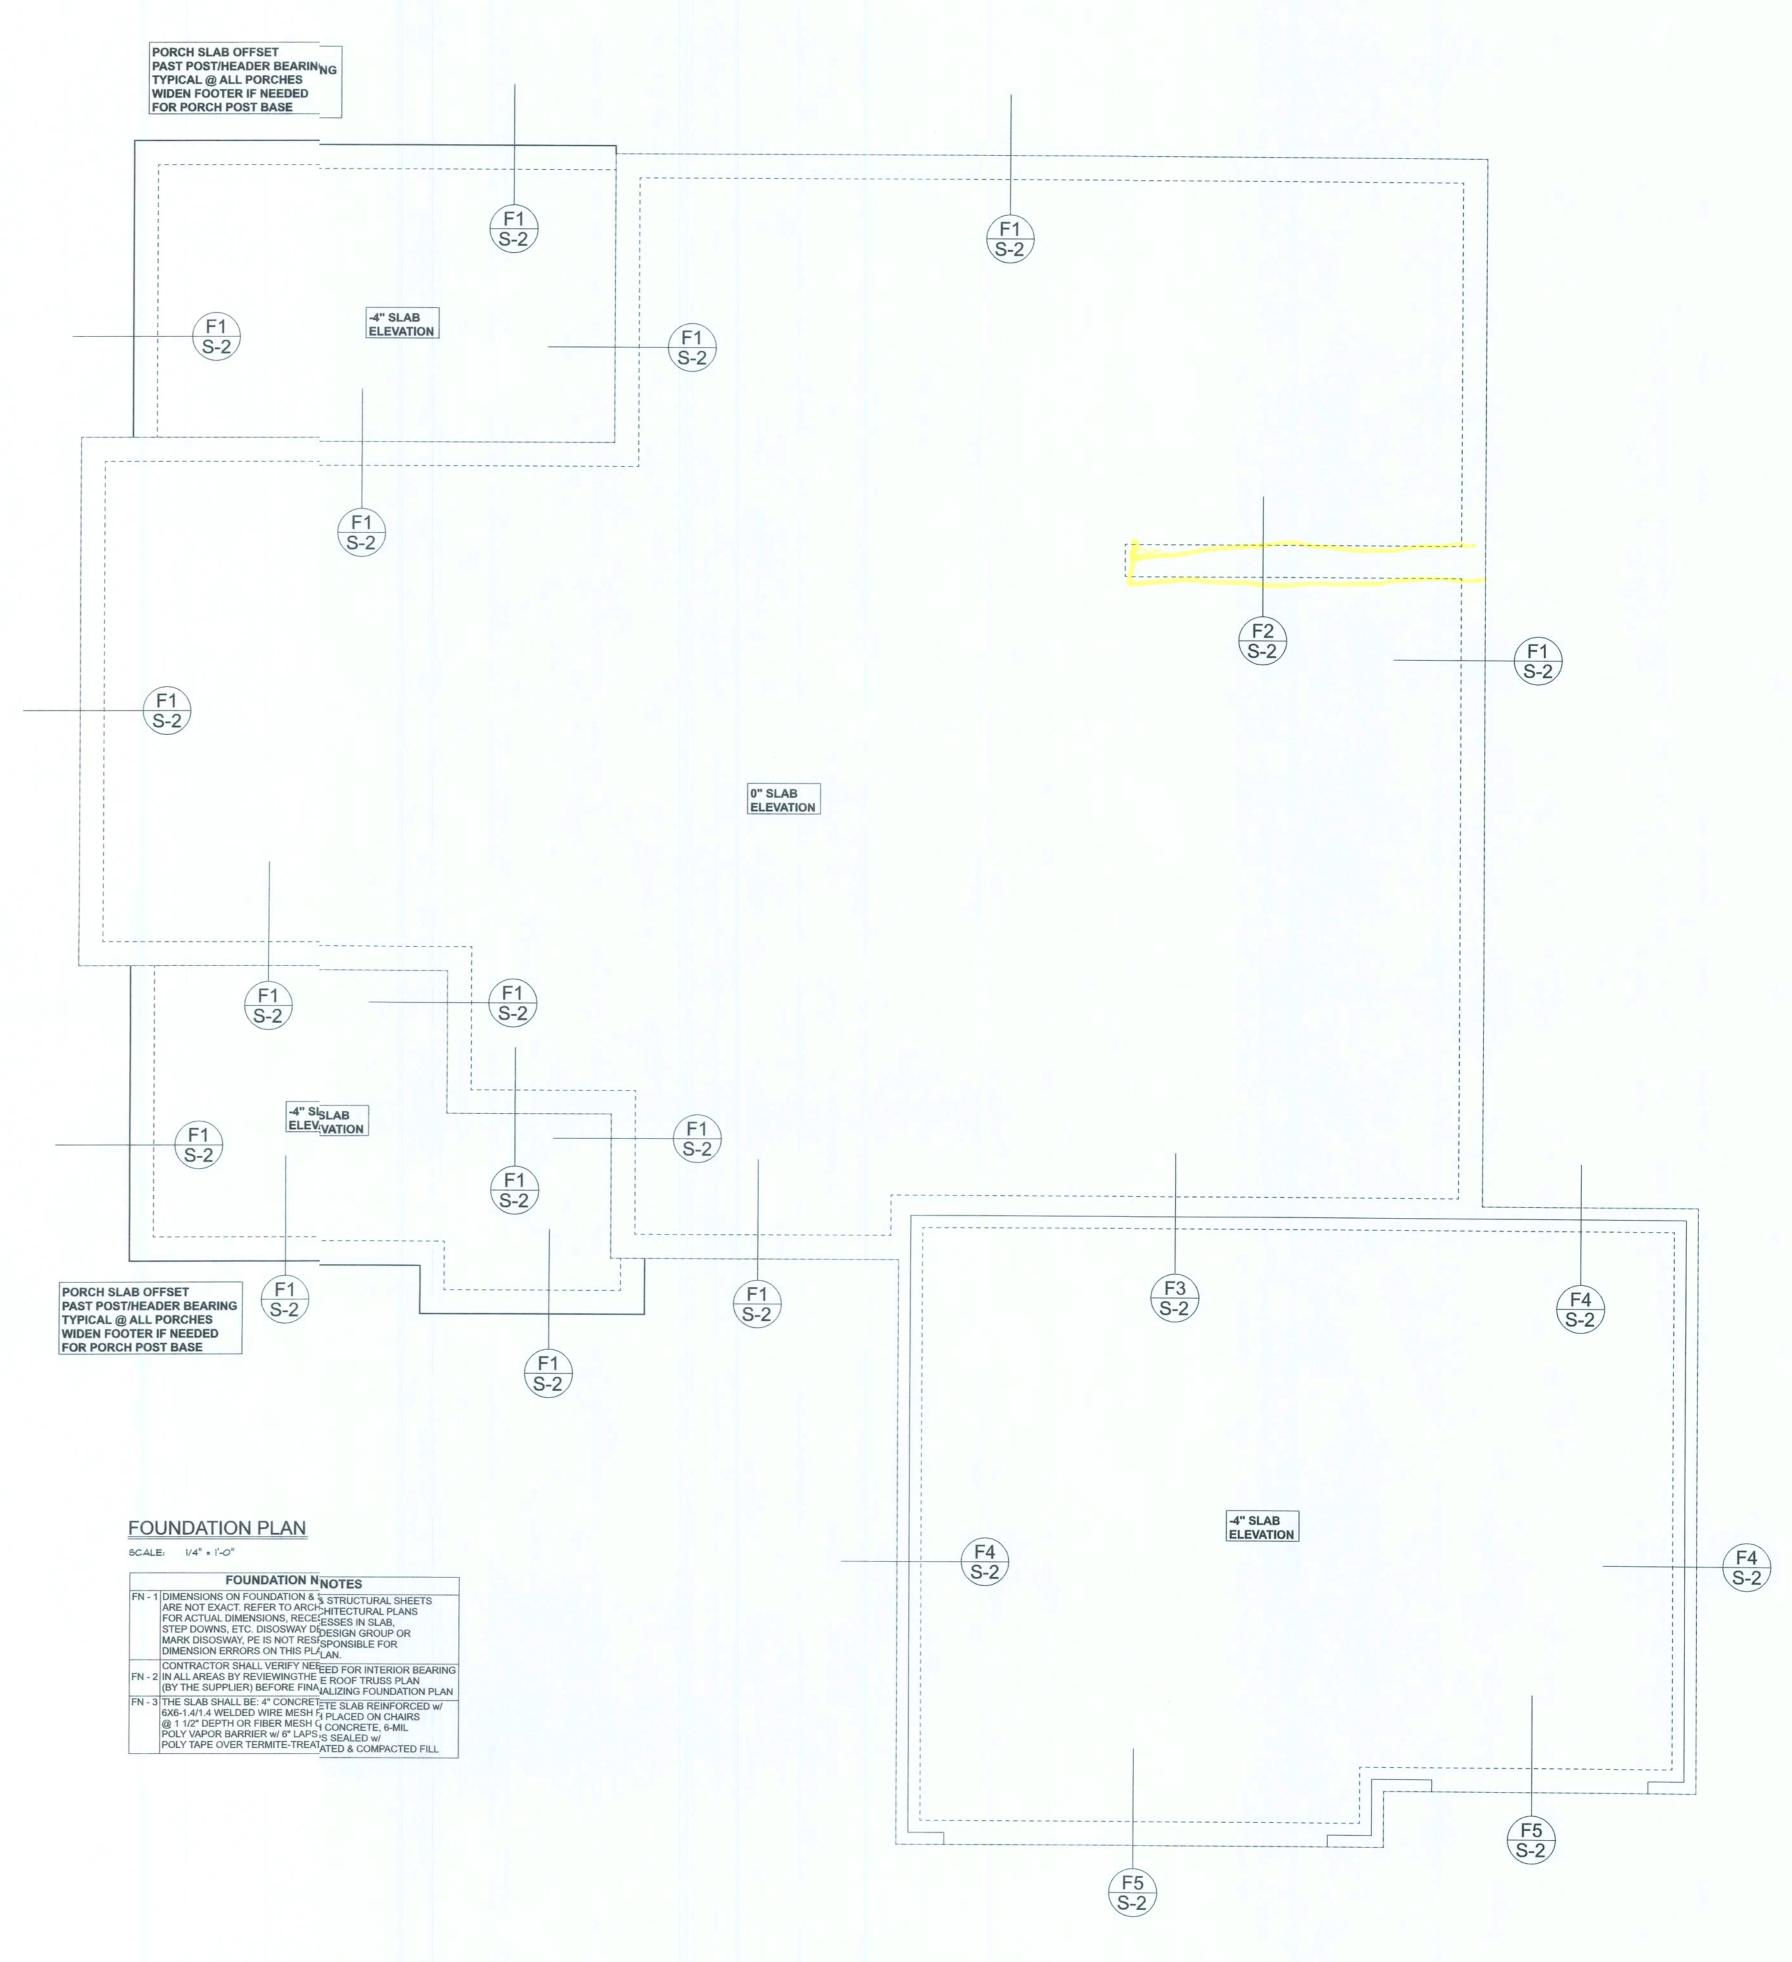

DIMENSIONS: Stated dimensions supecede scaled dimensions. Refer all questions to Mark Disosway, P.E. foresolution. Do not proceed without larification. COPYRIGHTS AND PROPERTY RIGHTS:
Mark Disosway, P.E. heeby expressly reserves
its common law copyrights and property right in
these instruments of serice. This document is not to be reproduced, alered or copied in any form or manner without rst the express written permission and consent Mark Disosway. CERTIFICATION: I herey certify that I have examined this plan, and hat the applicable portions of the plan, relaing to wind engineering comply with the 6th Edibn Florida Building Code Residentil (2017) to the best of my knowledge. LIMITATION: This desig is valid for one building, at specified loction. MARK DISOSVAY P.E. 53915 Monday, Jue 8, 2020 Mark Disosway P.E. 163 SW Midown Place Suit∈ 103 Lake City, Fbrida 32025 386.751.5419 disoswaydesi@gmail.com JOB NUMBER: 200590 S-2 OF 3 SHEETS

