


DIMENSIONS ON STRUCTURAL SHEETS ARE NOT EXACT. REFER TO ARCHITECTURAL FLOOR PLAN FOR ACTUAL DIMENSIONS

> 6"X6" W1.4XW1.4 W.W.M. PLACED AT 2"
> DEPTH ON CHAIRS OR FIBERMESH CONCRETE 4" CONCRETE SLAB 3000 - PSI AIT 28 DAYS 6 MIL VAP(OR BARRIER WITH 6" LAPS SEALED WITH POLY TAPE TERMITE TIREATED COMPACTED FILL (2) #5 CONTINUOUS

MONOLITHIC FOOTING

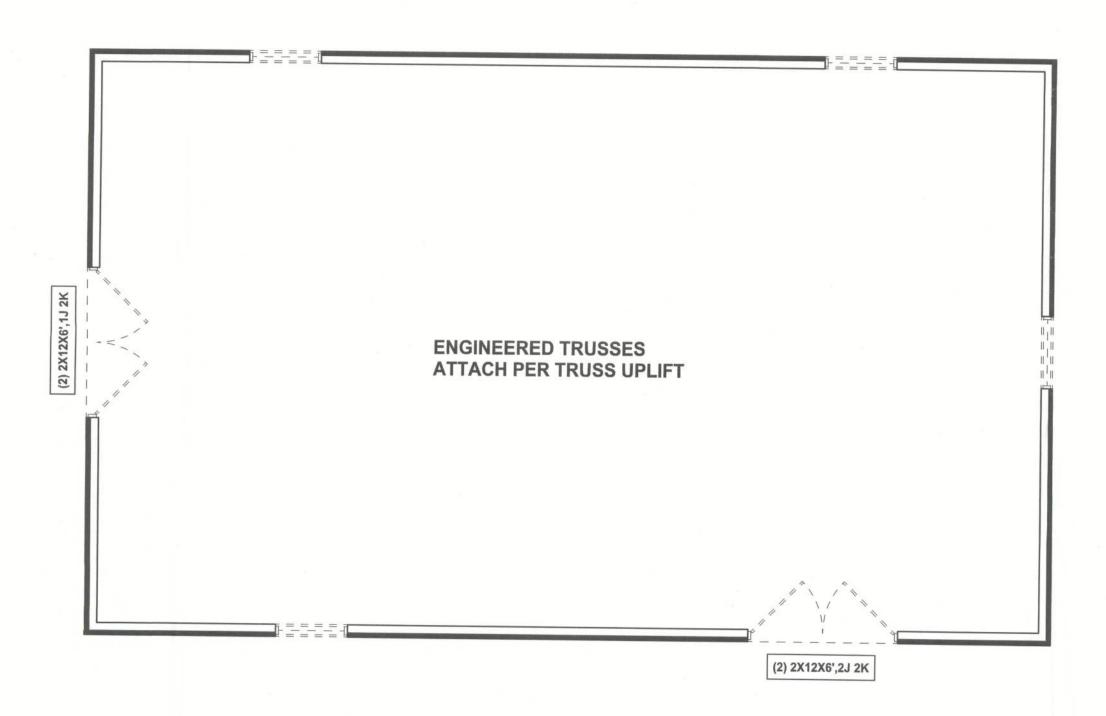

# STRUCTURAL PLAN SCALE: 1/4" = 1'-0"

### STRUCTURAL PLAN NOTES

SN-1 ALL LOAD BEARING FRAME WALL & PORCH HEADERS SHALL BE A MINIMUM OF (2) 2X12 SYP #2 (U.N.O.)

ALL LOAD BEARING FRAME WALL HEADERS SN-2 SHALL. HAVE (1) JACK STUD & (1) KING STUD EACH (SIDE (U.N.O.)

DIMENISIONS ON STRUCTURAL SHEETS SN-3 ARE NOT EXACT. REFER TO ARCHITECTURAL FLOOR PLAN FOR ACTUAL DIMENSIONS

PERMANENT TRUSS BRACING IS TO BE INSTALLED AT LOCATIONS AS SHOWN ON THE SEALED TRUSS DRAWINGS. LATERIAL BRACING IS TO BE RESTRAINED PER BCSI1-03, BCSI-Bi1, BCSI-B2, & BCSI-B3. BCSI-B1, BCSI-B2, & BCSI-B3 ARE FURNISHED BY THE TRUSS SUPPLIER, WITH THE SEALED TRUSS PACKAGE

#### **HEADER LEGEND**

——NUMBER OF KING STUDS (FULL LENGTH) —NUMBER OF JACK STUDS (UNDER HEADER) ----SPAN OF HEADER SIZE OF HEADER MATERIAL ----NUMBER OF PLIES IN HEADER

#### WALL LEGEND

EXTERIOR WALL
INTERIOR NON-LOAD BEARING WALL
INTERIOR LOAD BEARING WALL w/ NO UPLIFT
INTERIOR LOAD BEARING WALL w/ UPLIFT

## TOTAL SHEAR WALL SEGMENTS

INDICATES SHEAR WALL SEGMENTS REQUIRED ACTUAL

TRANSVERSE 31.1' 39.0' LONGITUDINAL 16.0'

WINDLOAD ENGINEER: Mark Disosway, PE No.53915, POB 868, Lake City, FL 32056, 386-754-5419

**REVISIONS** 

SOFTPD ARCHITECTURAL DESIGN SOFTWARE

DIMENSIONS: Stated dimensions supercede scaled dimensions. Refer all questions to Mark Disosway, P.E. for resolution. Do not proceed without clarification.

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permission and consent of Mark Discourage. permission and consent of Mark Disosway.

CERTIFICATION: I hereby certify that I have examined this plan, and that the applicable portions of the plan, relating to wind engineering comply with section R301.2.1, 2010 Florida Building Code Residential to the best of my knowledge.

building, at specified location



Stanley Crawford Construction

Jones

ADDRESS: Columbia County, Florida

Mark Disosway P.E. P.O. Box 868 Lake City, Florida 32056 Phone: (386) 754 - 5419 Fax: (386) 269 - 4871

PRINTED DATE: March 29, 2012

DRAWN BY:

FINALS DATE:

STRUCTURAL BY: David Disosway

7Mar12 JOB NUMBER: 1203022

DRAWING NUMBER

**S-2** OF 2 SHEETS