
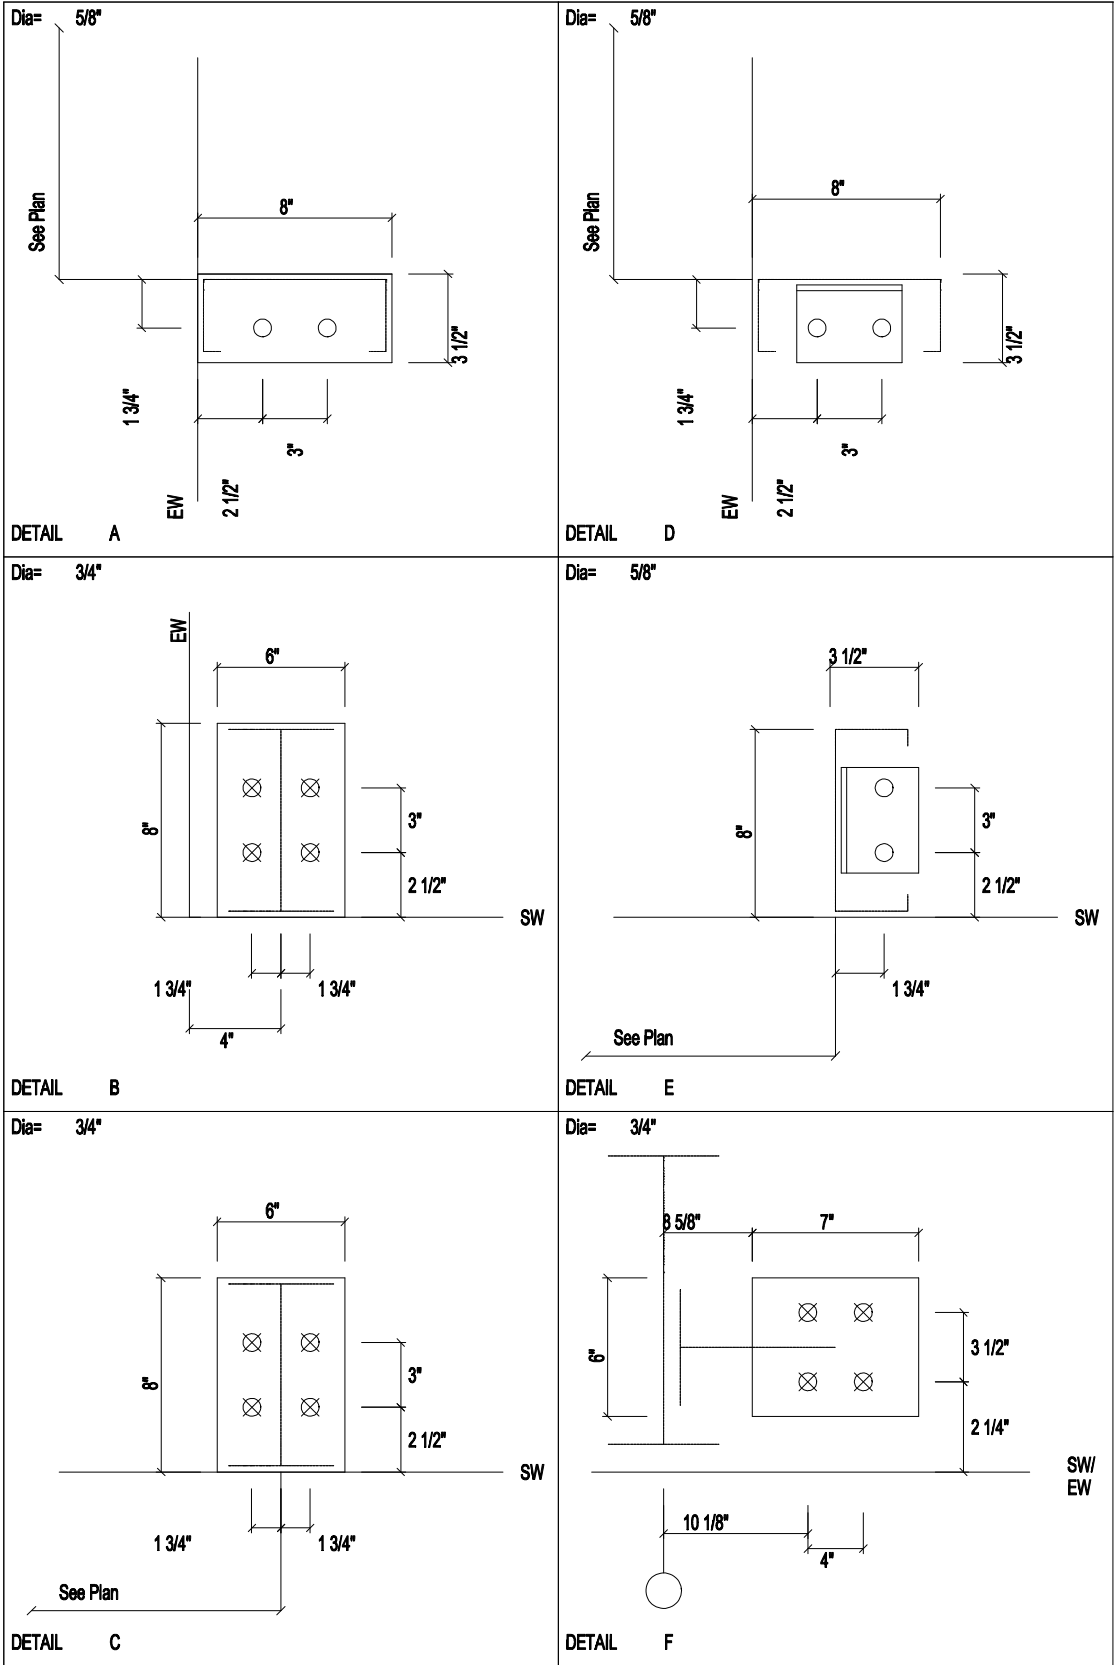


ANCHOR ROD PLAN
NOTE: All Base Plates @ 100'-0" (FINISH FLOOR)(UNLESS NOTED)

 <div>120 Connor St NE Live Oak, FL 32064 Ph. 800-231-0026 www.apex-mbs.com</div>	DESCRIPTION: Anchor Rod Plan						SHEET 2 of 15	
	CUSTOMER: LarryLaird					PROJECT: LarryLaird		
	LOCATION: FL 32038							
	DRN. BY APX	CK'D BY SUN	DATE 7/18/21	SCALE N.T.S.	REV. 00	QUOTATION NO. 21-875	SHEET NO. OF	



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DESCRIPTION: ANCHOR BOLT DETAILS						SHEET 3 of 15	
CUSTOMER: LarryLaird					PROJECT: LarryLaird		
LOCATION: FL 32038							
DRN. BY APX	CK'D BY SUN	DATE 7/18/21	SCALE N.T.S.	REV. 00	QUOTATION NO. 21-875	SHEET NO. OF	

NOTES FOR REACTIONS

1. All loading conditions are examined and only maximum/minimum H or V and the corresponding H or V are reported.
2. Positive reactions are as shown in the sketch. Foundation loads are in opposite directions.
3. Bracing reactions are in the plane of the brace with the H pointing away from the braced bay. The vertical reaction is downward.
4. Building reactions are based on the following building data:

Width (ft)

=

30.0

Length (ft)

=

60.0

Eave Height (ft)

=

12.0/ 12.0

Roof Slope (rise/run)

=

5.0/ 5.0

Dead Load (psf)

=

2.0

Collateral Load (psf)

=

1.0

Roof Live Load (psf)

=

20.0

Frame Live Load

Min (psf)

=

12.3

Max (psf)

=

15.3

Wind Speed (mph)

=

120.0

Wind Code

=

FBC 20 (IBC 18)

Exposure

=

B

Closed/Open

=

C

Importance Wind

=

1.00

Importance Seismic

=

1.00

Seismic Zone

=

B

Seismic Coeff (Fa/Ss)

=

0.12

5. Loading conditions are:

1

Dead+Collateral+Live

2

Dead+Collateral+0.75Live+0.45Wind_Left1

3

Dead+Collateral+0.75Live+0.45Wind_Right1

4

Dead+Collateral+0.75Live+0.45Wind_Long1R

5

Dead+Collateral+0.75Live+0.45Wind_Long2R

6

0.8Dead+0.8Wind_Left1

7

0.8Dead+0.8Wind_Right1

8

0.8Dead+0.8Wind_Left2

9

0.8Dead+0.8Wind_Right2

10

0.8Dead+0.8Wind_Long1L

11

0.8Dead+0.8Wind_Long2L

12

0.8Dead+0.8Wind_Right2+0.8Wind_Suction

13

0.8Dead+0.8Wind_Pressure+0.8Wind_Long2L

14

Dead+0.8Wind_Right2+0.8Wind_Suction

ANCHOR BOLT SUMMARY


Qty	Locate	Dia (in)	Type	Total Len (in)	Bend Len (in)	Proj (in)
40	Jamb	5/8"	A307	8.00	3.00	3.00
4	Endwall	5/8"	A307	8.00	3.00	3.00
32	Frame	3/4"	A307	12.0	3.00	3.00
8	WindCol	3/4"				

BUILDING BRACING REACTIONS


Wall		Col	Reactions(k)		Seismic		Panel Shear (lb/ft)		Note
Loc	Line	Line	Horz	Vert	Horz	Vert	Wind	Seis	
L_EW	1								(h)
F_SW	A	2							(g)
R_EW	4								(h)
B_SW	C	2							(g)

(g)Wind column at column line
(h)Rigid frame at endwall

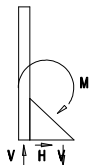WIND COLUMN REACTIONS



Wall	Col	Reactions		R/L	Load_ID	Reactions		Moment (F-k)	Anc Bolt Qty	Dia	Width	Base Plate(n) Length	Thick
Loc	Line	Line	Line			Horz (k)	Vert (k)						
F_SW	A	2	R	Wind	1.9	20.9	20.9	4	0.750	6.000	7.000	0.500	
				Seismic	0.4	4.5	4.4						
B_SW	C	2	L	Wind	1.9	20.9	20.9	4	0.750	6.000	7.000	0.500	
				Seismic	0.4	4.5	4.4						

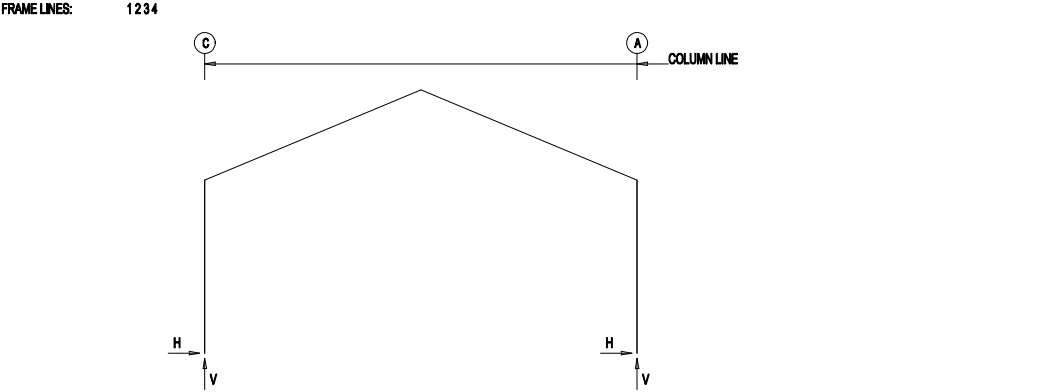

RIGID FRAME: MAXIMUM REACTIONS, ANCHOR RODS, & BASE PLATES

Frm Line	Col Line	Column_Reactions(k)						Bolt(n) Qty	Dia	Base_Plate(n)		Thick	Grout (in)
		Load Id	Hmax H	V Vmax	Load Id	Hmin H	V Vmin			Width	Length		
1	C	3	1.5	2.1	8	-1.7	-1.1	4	0.750	6.000	8.000	0.500	0.0
		1	1.3	4.0	6	-1.5	-2.0						
1	A	9	1.7	-1.1	2	-1.5	2.1	4	0.750	6.000	8.000	0.500	0.0
		1	-1.3	4.0	7	1.5	-2.0						

RIGID FRAME: MAXIMUM REACTIONS, ANCHOR RODS, & BASE PLATES

Frm Line	Col Line	Column_Reactions(k)						Bolt(n) Qty	Dia	Base_Plate(n)		Thick	Grout (in)
		Load Id	Hmax H	V Vmax	Load Id	Hmin H	V Vmin			Width	Length		
2*	C	3	2.1	2.7	8	-2.2	-1.2	4	0.750	6.000	8.000	0.500	0.0
		5	1.3	11.4	10	0.7	-14.9						
2*	A	9	2.2	-1.2	2	-2.1	2.7	4	0.750	6.000	8.000	0.500	0.0
		4	-1.3	11.4	11	-0.7	-14.9						
2*	Frame lines:		2	3									

RIGID FRAME: MAXIMUM REACTIONS, ANCHOR RODS, & BASE PLATES

Frm Line	Col Line	Column_Reactions(k)						Bolt(n) Qty	Dia	Base_Plate(n)		Thick	Grout (in)
		Load Id	Hmax H	V Vmax	Load Id	Hmin H	V Vmin			Width	Length		
4	C	3	1.6	2.1	8	-1.7	-1.2	4	0.750	6.000	8.000	0.500	0.0
		1	1.3	4.0	6	-1.6	-2.1						
4	A	9	1.7	-1.2	2	-1.6	2.1	4	0.750	6.000	8.000	0.500	0.0
		1	-1.3	4.0	7	1.6	-2.1						

RIGID FRAME: BASIC COLUMN REACTIONS (k)

Frame Line	Column Line	Dead		Collateral		Live		Wind Left1		Wind Right1		Wind Left2	
		Horz	Vert	Horz	Vert	Horz	Vert	Horz	Vert	Horz	Vert	Horz	Vert
1	A	0.2	0.7	0.1	0.2	1.0	3.0	-2.7	-4.1	1.2	-2.4	-3.0	-2.5
1	C	-0.2	0.7	-0.1	0.2	-1.0	3.0	-1.2	-2.4	2.7	-4.1	-0.9	-0.9
2*	C	0.3	1.0	0.1	0.3	1.3	3.8	-3.8	-5.4	1.7	-3.3	-3.9	-3.0
2*	A	-0.3	1.0	-0.1	0.3	-1.3	3.8	-1.7	-3.3	3.8	-5.4	-1.3	-0.8
4	C	0.2	0.7	0.1	0.2	1.0	3.0	-2.9	-4.2	1.2	-2.5	-3.1	-2.7
4	A	-0.2	0.7	-0.1	0.2	-1.0	3.0	-1.2	-2.5	2.9	-4.2	-1.0	-1.0
Frame Line	Column Line	Wind Right2		Wind Long1		Wind Long2		Seismic Left		Seismic Right		Seismic Long	
		Horz	Vert	Horz	Vert	Horz	Vert	Horz	Vert	Horz	Vert	Horz	Vert
1	C	0.9	-0.9	0.6	-3.1	0.0	-3.0	0.0	0.0	0.0	0.0	0.0	0.0
1	A	3.0	-2.5	0.0	-3.0	-0.6	-3.1	0.0	0.0	0.0	0.0	0.0	0.0
2*	C	1.3	-0.8	0.9	-25.6	0.0	-25.6	0.0	0.0	0.0	0.0	0.0	-4.4
2*	A	3.9	-3.0	0.0	-25.6	-0.9	-25.6	0.0	0.0	0.0	0.0	0.0	-4.4
4	C	1.0	-1.0	0.6	-3.1	0.0	-3.0	0.0	0.0	0.0	0.0	0.0	0.0
4	A	3.1	-2.7	0.0	-3.0	-0.6	-3.1	0.0	0.0	0.0	0.0	0.0	0.0
2*	Frame lines:		2	3									

ENDWALL COLUMN: BASIC COLUMN REACTIONS (k)

Frm Line	Col Line	Dead Vert	Wind Press Horz	Wind Suct Horz
1	B	0.1	-2.1	2.4
4	B	0.1	-2.1	2.4

ENDWALL COLUMN: MAXIMUM REACTIONS, ANCHOR BOLTS, & BASE PLATES

Frm Line	Col Line	Column_Reactions(k)						Bolt(n) Qty	Dia	Base_Plate(n)		Thick	Grout (in)
		Load Id	Hmax H	V Vmax	Load Id	Hmin H	V Vmin			Width	Length		
1	B	12	1.4	0.1	13	-1.3	0.1	2	0.625	3.500	8.000	0.375	0.0
		14	1.4	0.1									
4	B	12	1.4	0.1	13	-1.3	0.1	2	0.625	3.500	8.000	0.375	0.0
		14	1.4	0.1									



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DESCRIPTION: Reactions

SHEET 4 of 15

CUSTOMER: LarryLaird

PROJECT: LarryLaird

LOCATION: FL 32038

DRN. BY APX

CK'D BY SUN


DATE 7/18/21

SCALE N.T.S.

REV. 00

QUOTATION NO. 21-875

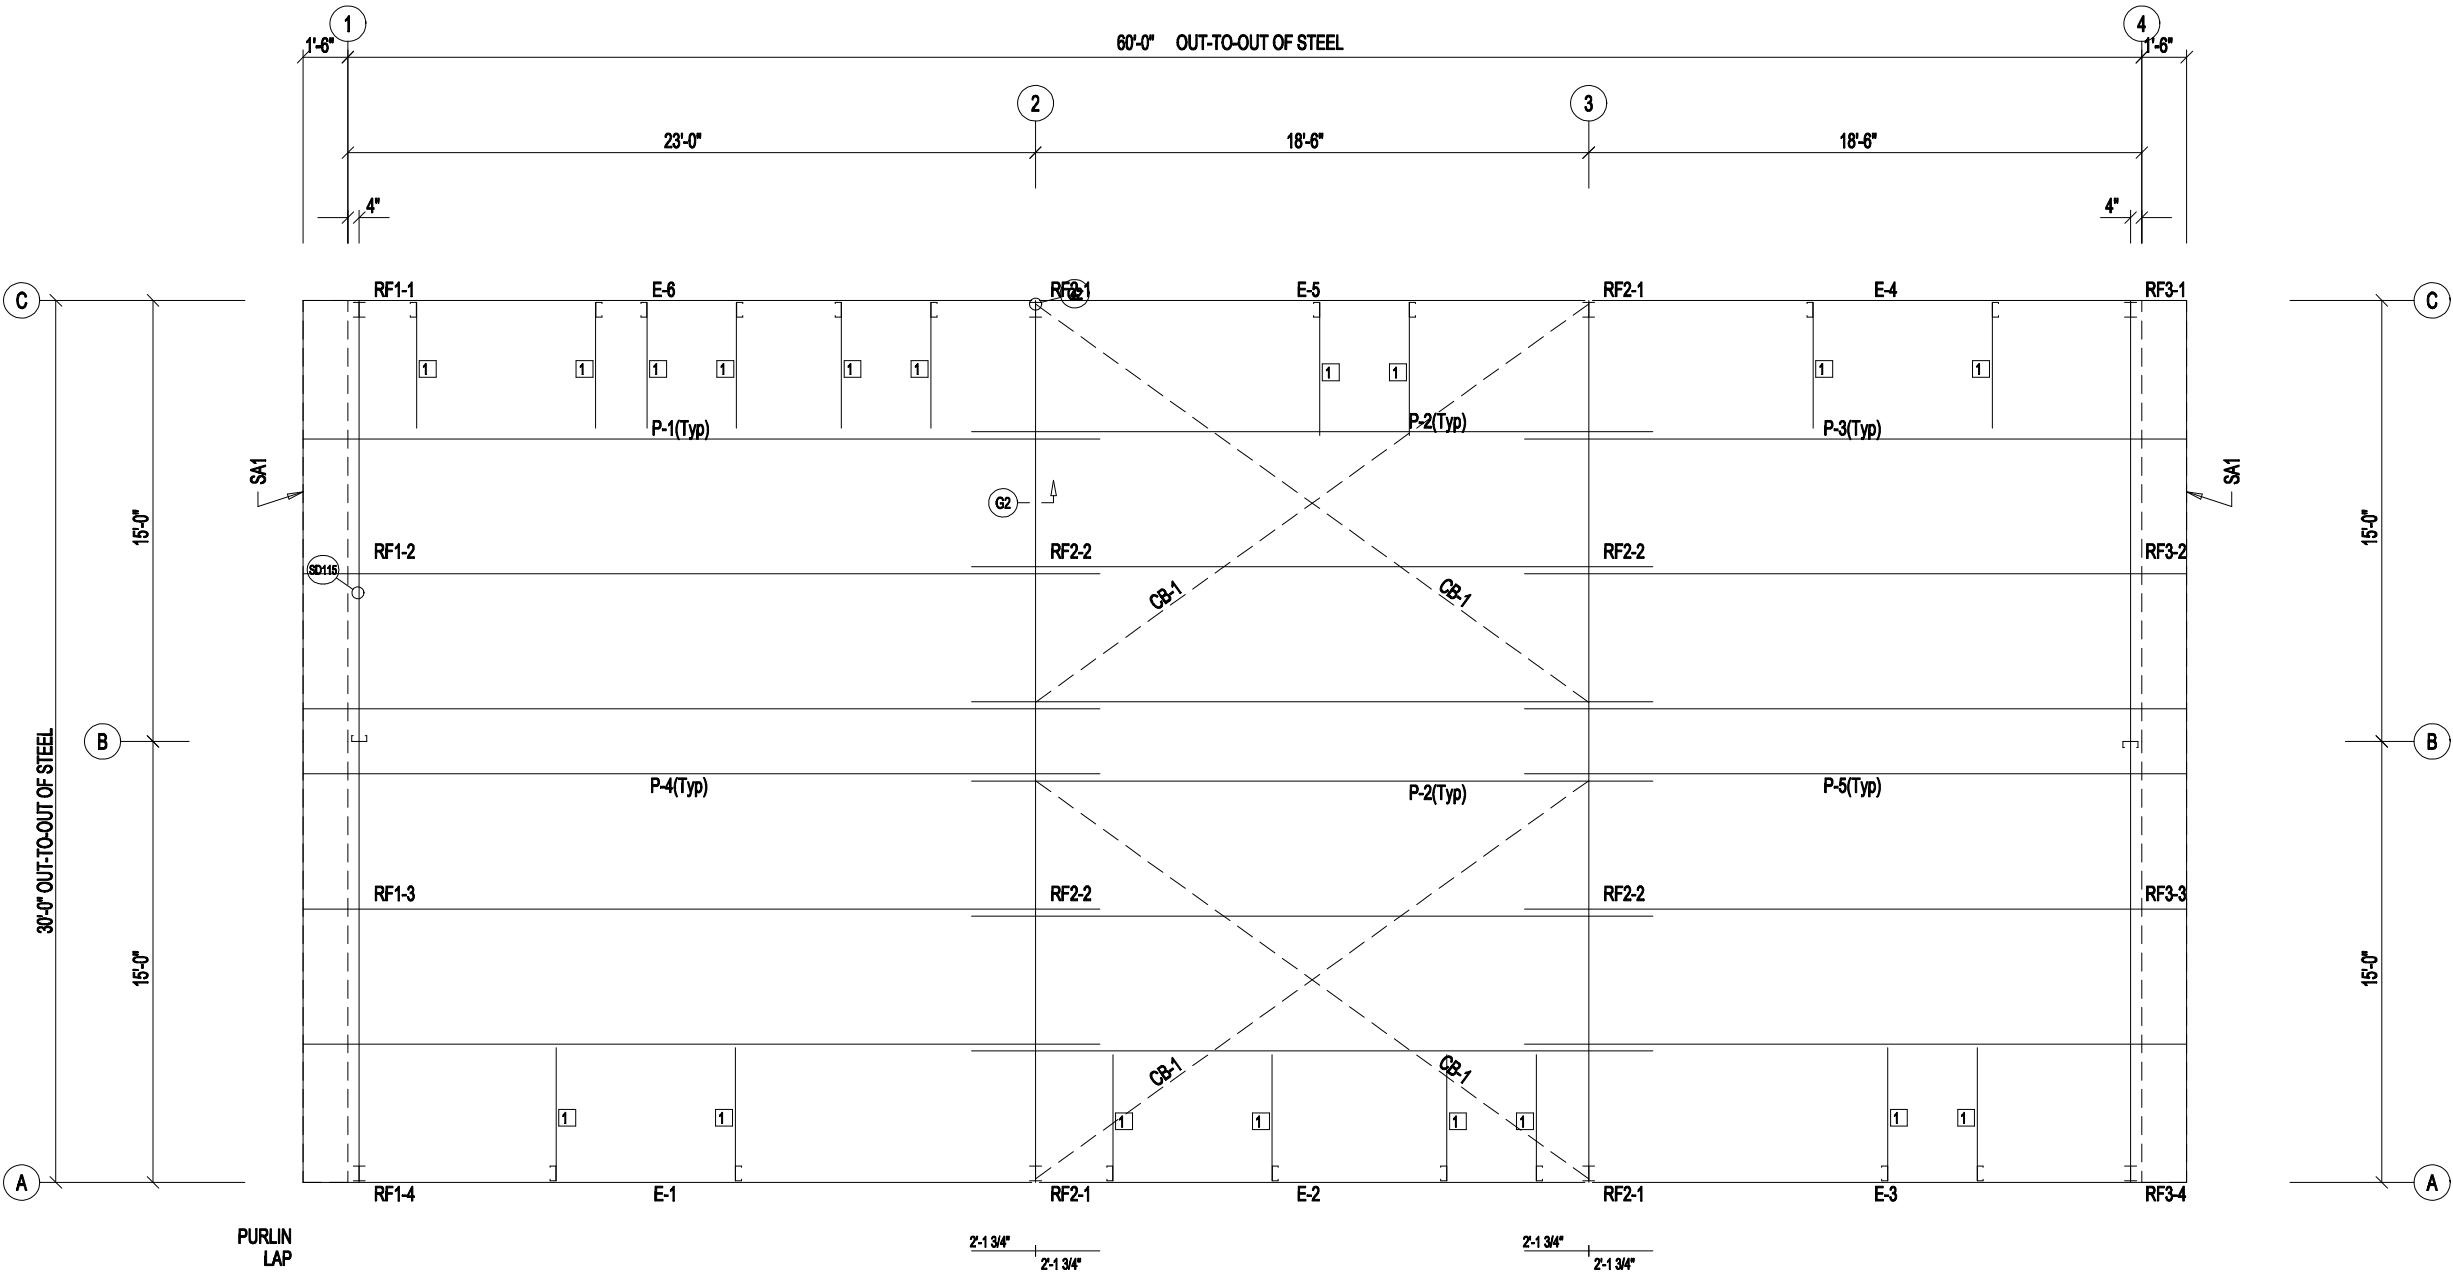
SHEET NO. OF



MEMBER TABLE		
ROOF PLAN		
MARK	PART	LENGTH
P-1	8X25Z16	26'-7 1/2"
P-2	8X25Z14	22'-9 1/2"
P-3	8X25Z16	22'-1 1/2"
P-4	8X25Z16	26'-7 1/2"
P-5	8X25Z16	22'-1 1/2"
E-1	8.50E14	24'-5 1/2"
E-2	8.50E14	18'-5 1/2"
E-3	8.50E14	19'-11 1/2"
E-4	8.50E14	19'-11 1/2"
E-5	8.50E14	18'-5 1/2"
E-6	8.50E14	24'-5 1/2"
CB-1	CB0250	23'-6"

CONNECTION PLATES	
ROOF PLAN	
ID	MARK/PART
1	JB-1

ROOF FRAMING PLAN



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DESCRIPTION: ROOF FRAMING PLAN

SHEET 5 of 15

CUSTOMER: LarryLaird

PROJECT: LarryLaird

LOCATION: FL 32038

DRN. BY: APX

CK'D BY: SUN

DATE: 7/18/21


SCALE: N.T.S.

REV. 00

QUOTATION NO. 21-875

SHEET NO. OF

TRIM TABLE		
ROOF PLAN		
◇ ID	PART	LENGTH
1	FL-56	15'-11"
2	FL-79	16'-3"
3	FL-50	16'-3"

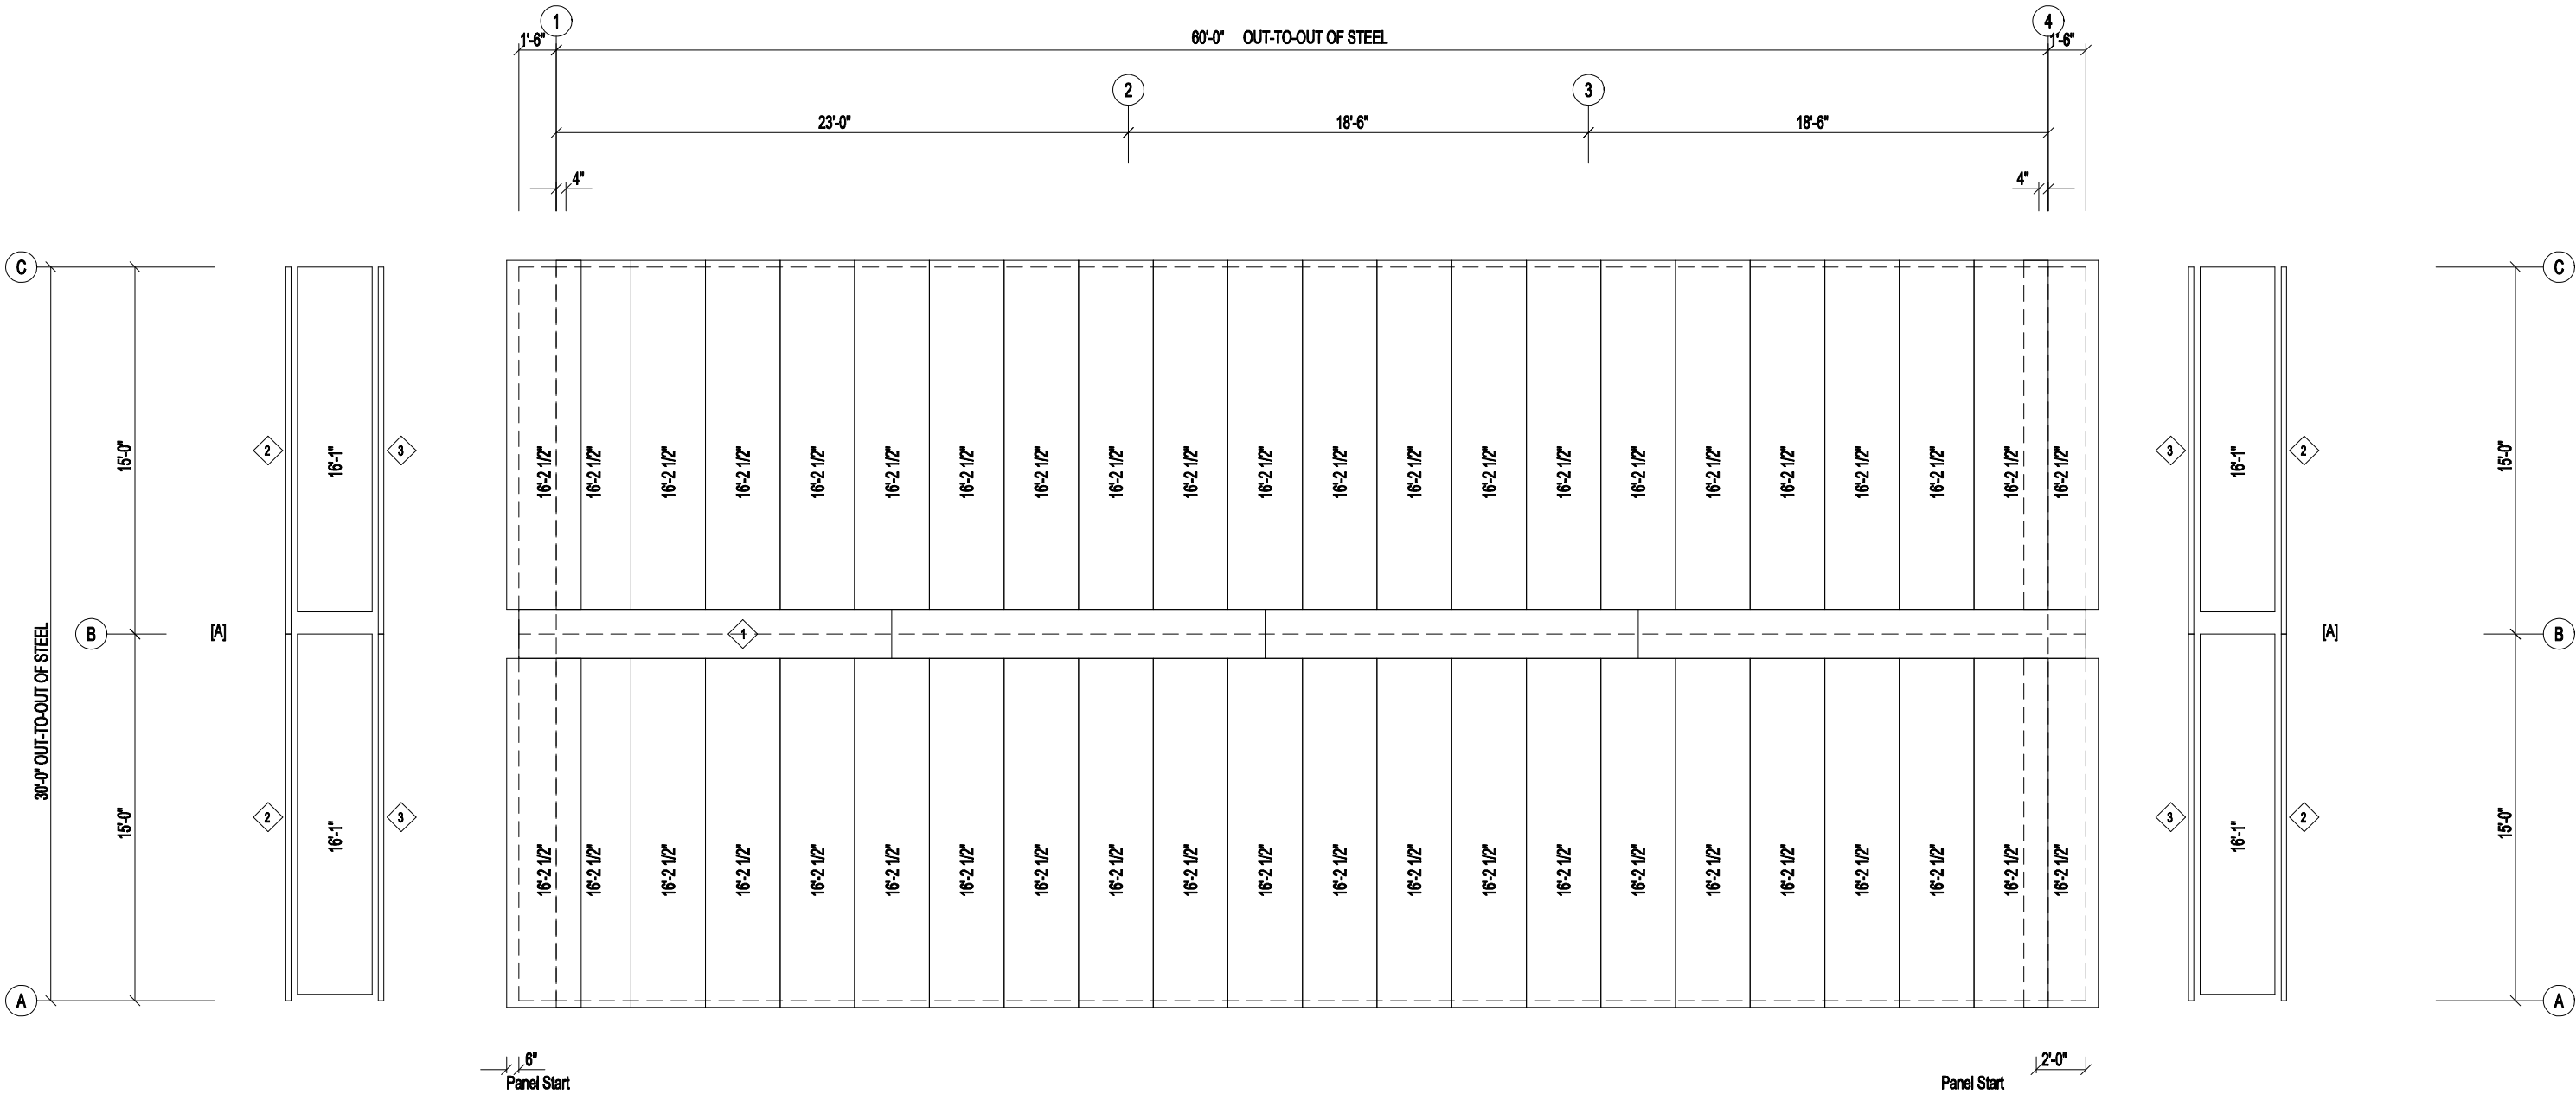

ROOF SHEETING PLAN

PANELS: 26 Ga. PBR - Galvalume 26ga.
[A] SOFFIT PANELS: 26 Ga. PBR - Need Std. Color




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DESCRIPTION: ROOF FRAMING PLAN							SHEET 6 of 15	
CUSTOMER: LarryLaird				PROJECT: LarryLaird				
LOCATION: FL 32038								
DRN. BY APX	CK'D BY SUN	DATE 7/18/21	SCALE N.T.S.	REV. 00	QUOTATION NO. 21-875	SHEET NO. OF		


SPLICE PLATE & BOLT TABLE									
Mark	Qty Top	Qty Bot	Int	Type	Dia	Length	Width	Thick	Length
SP-1	4	4	0	A325	5/8"	2"	6"	3/8"	1'-3 7/8"
SP-2	4	4	0	A325	5/8"	1 3/4"	6"	3/8"	1'-3 13/16"

FLANGE BRACES: FBxx (1 or 2)
xx=length(in)
(1) One Side; (2) Two Sides
A - 2X2X14Ga

MEMBER SIZE TABLE		
MARK	MEMBER	LENGTH
RF1-1	W8X13	11'-3 1/16"
RF1-2	W8X10	15'-5 15/16"
RF1-3	W8X10	15'-5 15/16"
RF1-4	W8X13	11'-3 1/16"

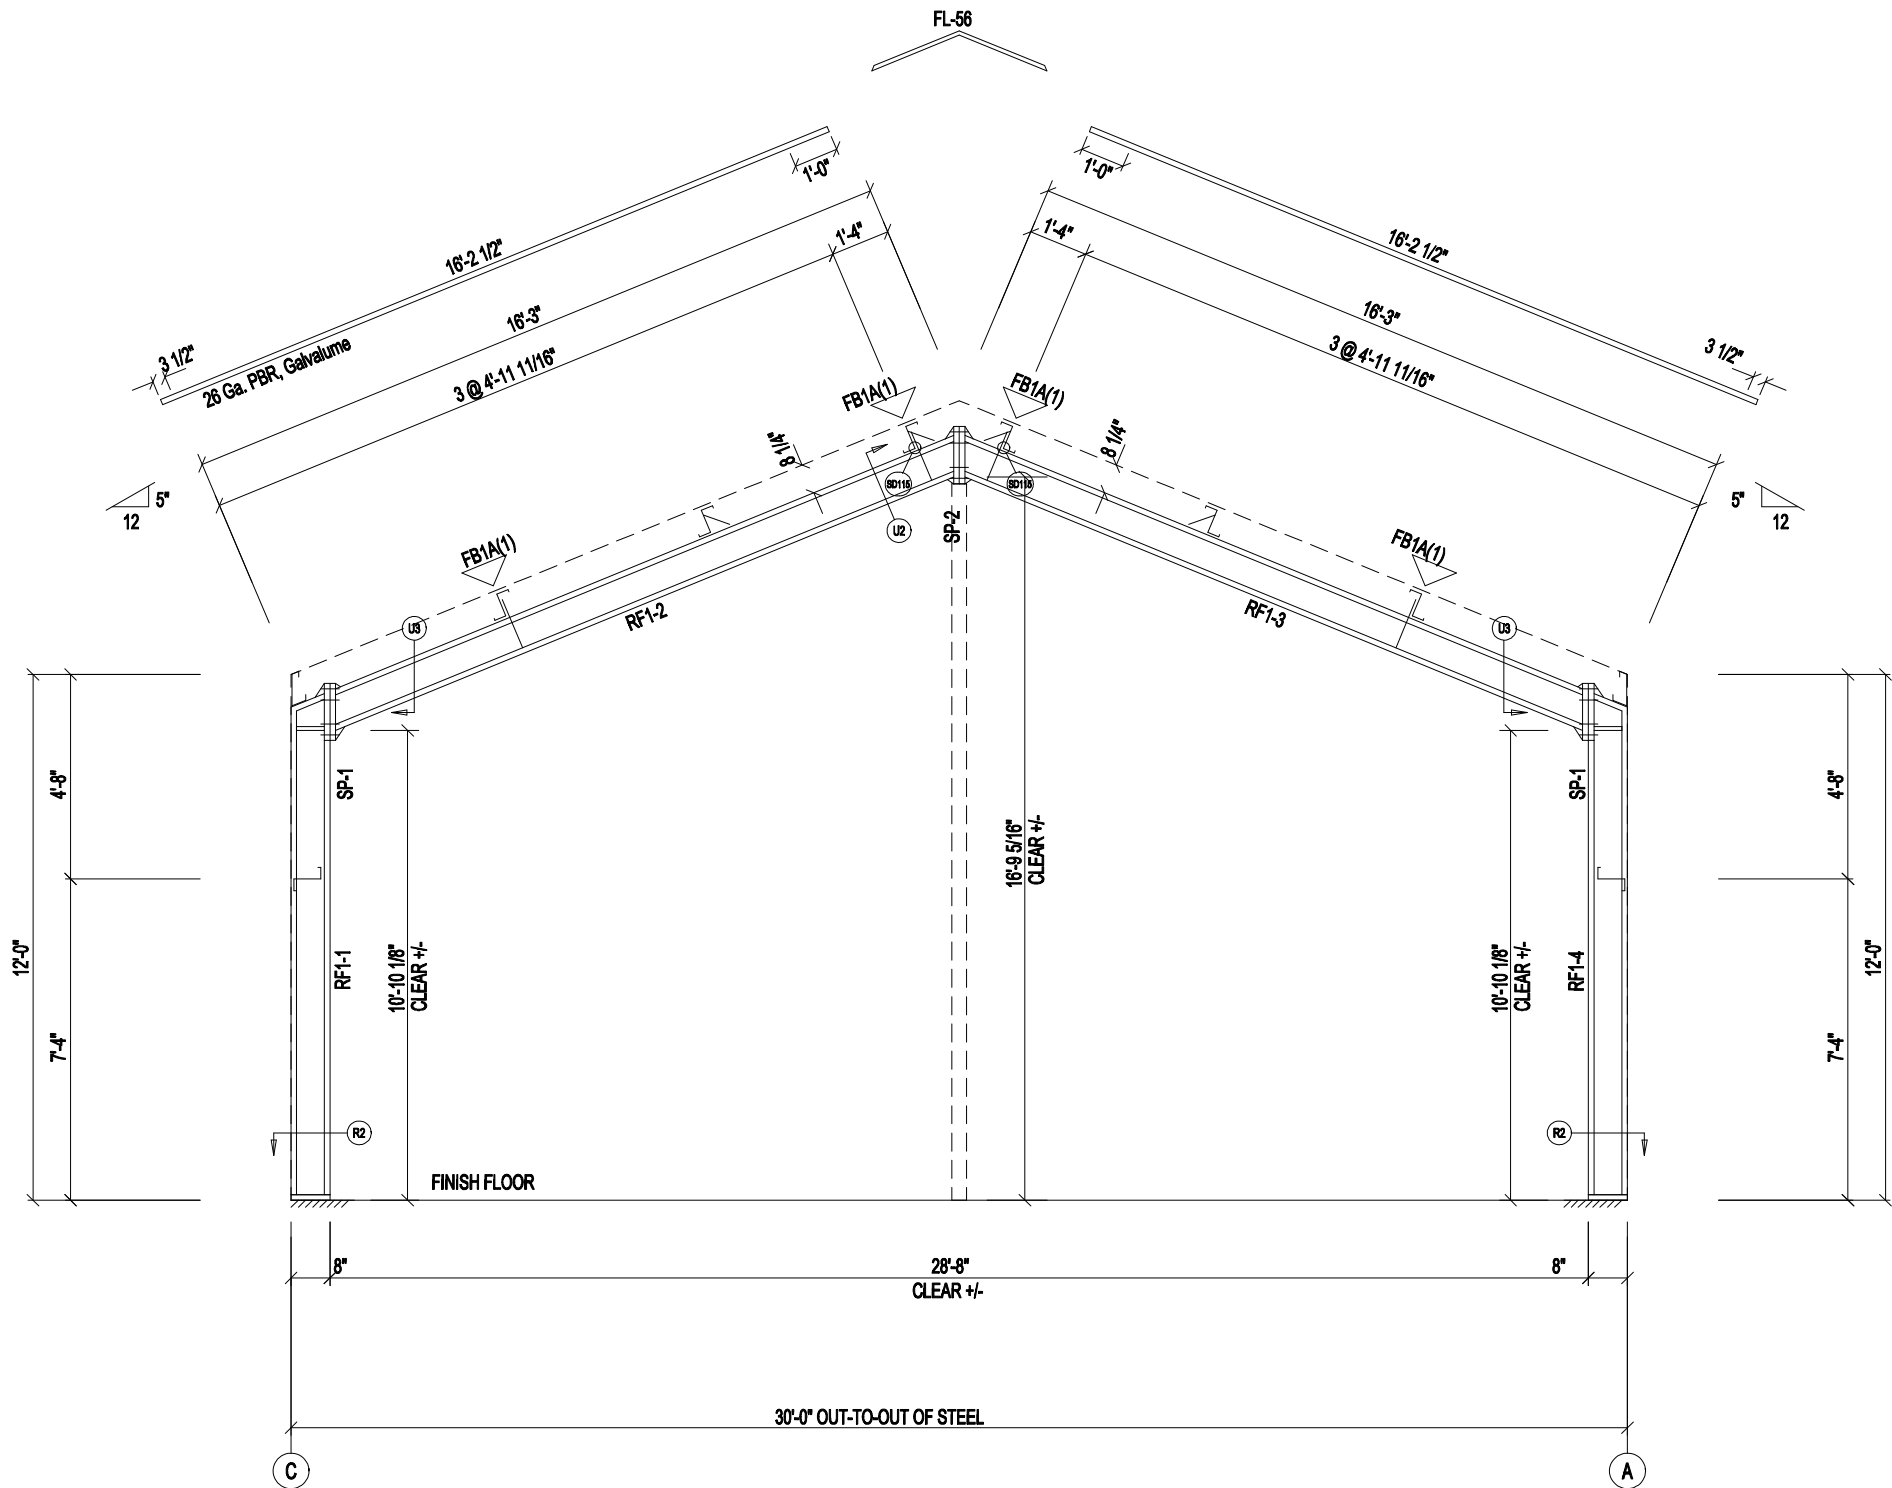

RIGID FRAME ELEVATION: FRAME LINE 1



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DESCRIPTION: CROSS SECTION

SHEET 7 of 15

CUSTOMER: LarryLaird

PROJECT: LarryLaird

LOCATION: FL 32038

DRN. BY: APX

CKD BY: SUN

DATE: 7/18/21

SCALE: N.T.S.


REV: 00

QUOTATION NO. 21-875


SHEET NO. OF

SPLICE PLATE & BOLT TABLE									
Mark	Qty		Bot	Int	Type	Dia	Length	Width	Thick
SP-1	4	4	0		A325	5/8"	2"	6"	3/8"
SP-2	4	4	0		A325	5/8"	1 3/4"	6"	3/8"

MEMBER SIZE TABLE		
MARK	MEMBER	LENGTH
RF2-1	W8X13	11'-3 1/16"
RF2-2	W8X10	15'-5 15/16"

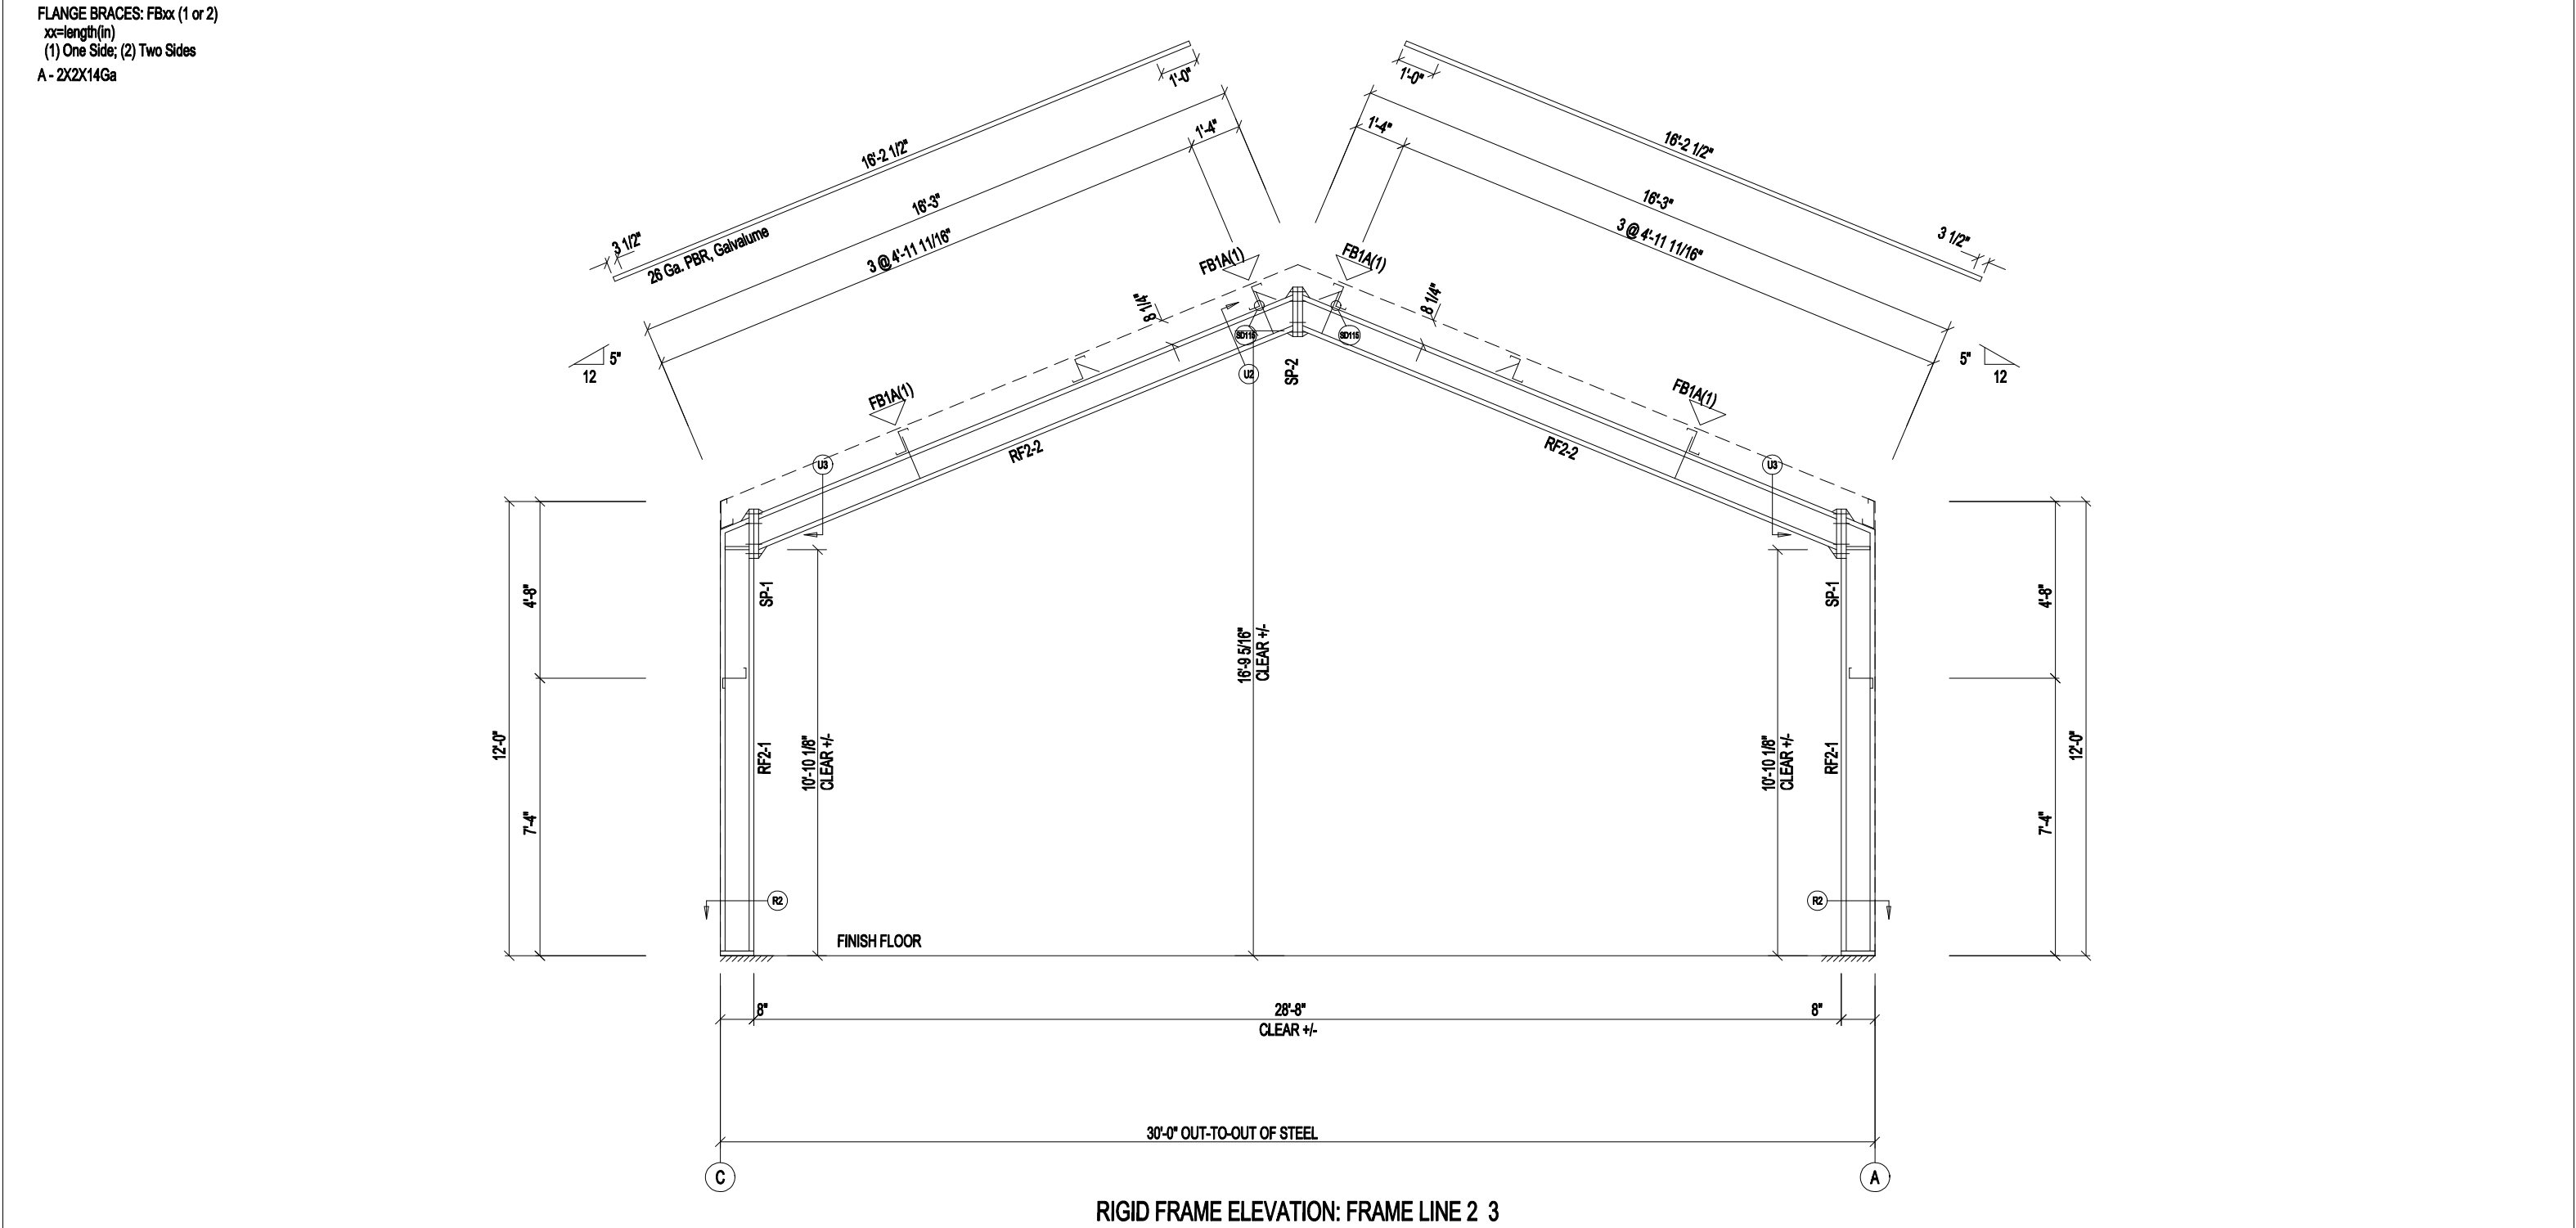

RIGID FRAME ELEVATION: FRAME LINE 2 3



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DESCRIPTION: CROSS SECTION

SHEET 8 of 15

CUSTOMER: LarryLaird

PROJECT: LarryLaird

LOCATION: FL 32038

DRN. BY: APX

CKD BY: SUN

DATE: 7/18/21

SCALE: N.T.S.

REV: 00


QUOTATION NO. 21-875

SHEET NO. OF


SPLICE PLATE & BOLT TABLE									
Mark	Qty Top	Qty Bot	Int	Type	Dia	Length	Width	Thick	Length
SP-1	4	4	0	A325	5/8"	2"	6"	3/8"	1'-3 7/8"
SP-2	4	4	0	A325	5/8"	1 3/4"	6"	3/8"	1'-3 13/16"

FLANGE BRACES: FBxx (1 or 2)
xx=length(in)
(1) One Side; (2) Two Sides
A - 2X2X14Ga

MEMBER SIZE TABLE		
MARK	MEMBER	LENGTH
RF3-1	W8X13	11'-3 1/16"
RF3-2	W8X10	15'-5 15/16"
RF3-3	W8X10	15'-5 15/16"
RF3-4	W8X13	11'-3 1/16"

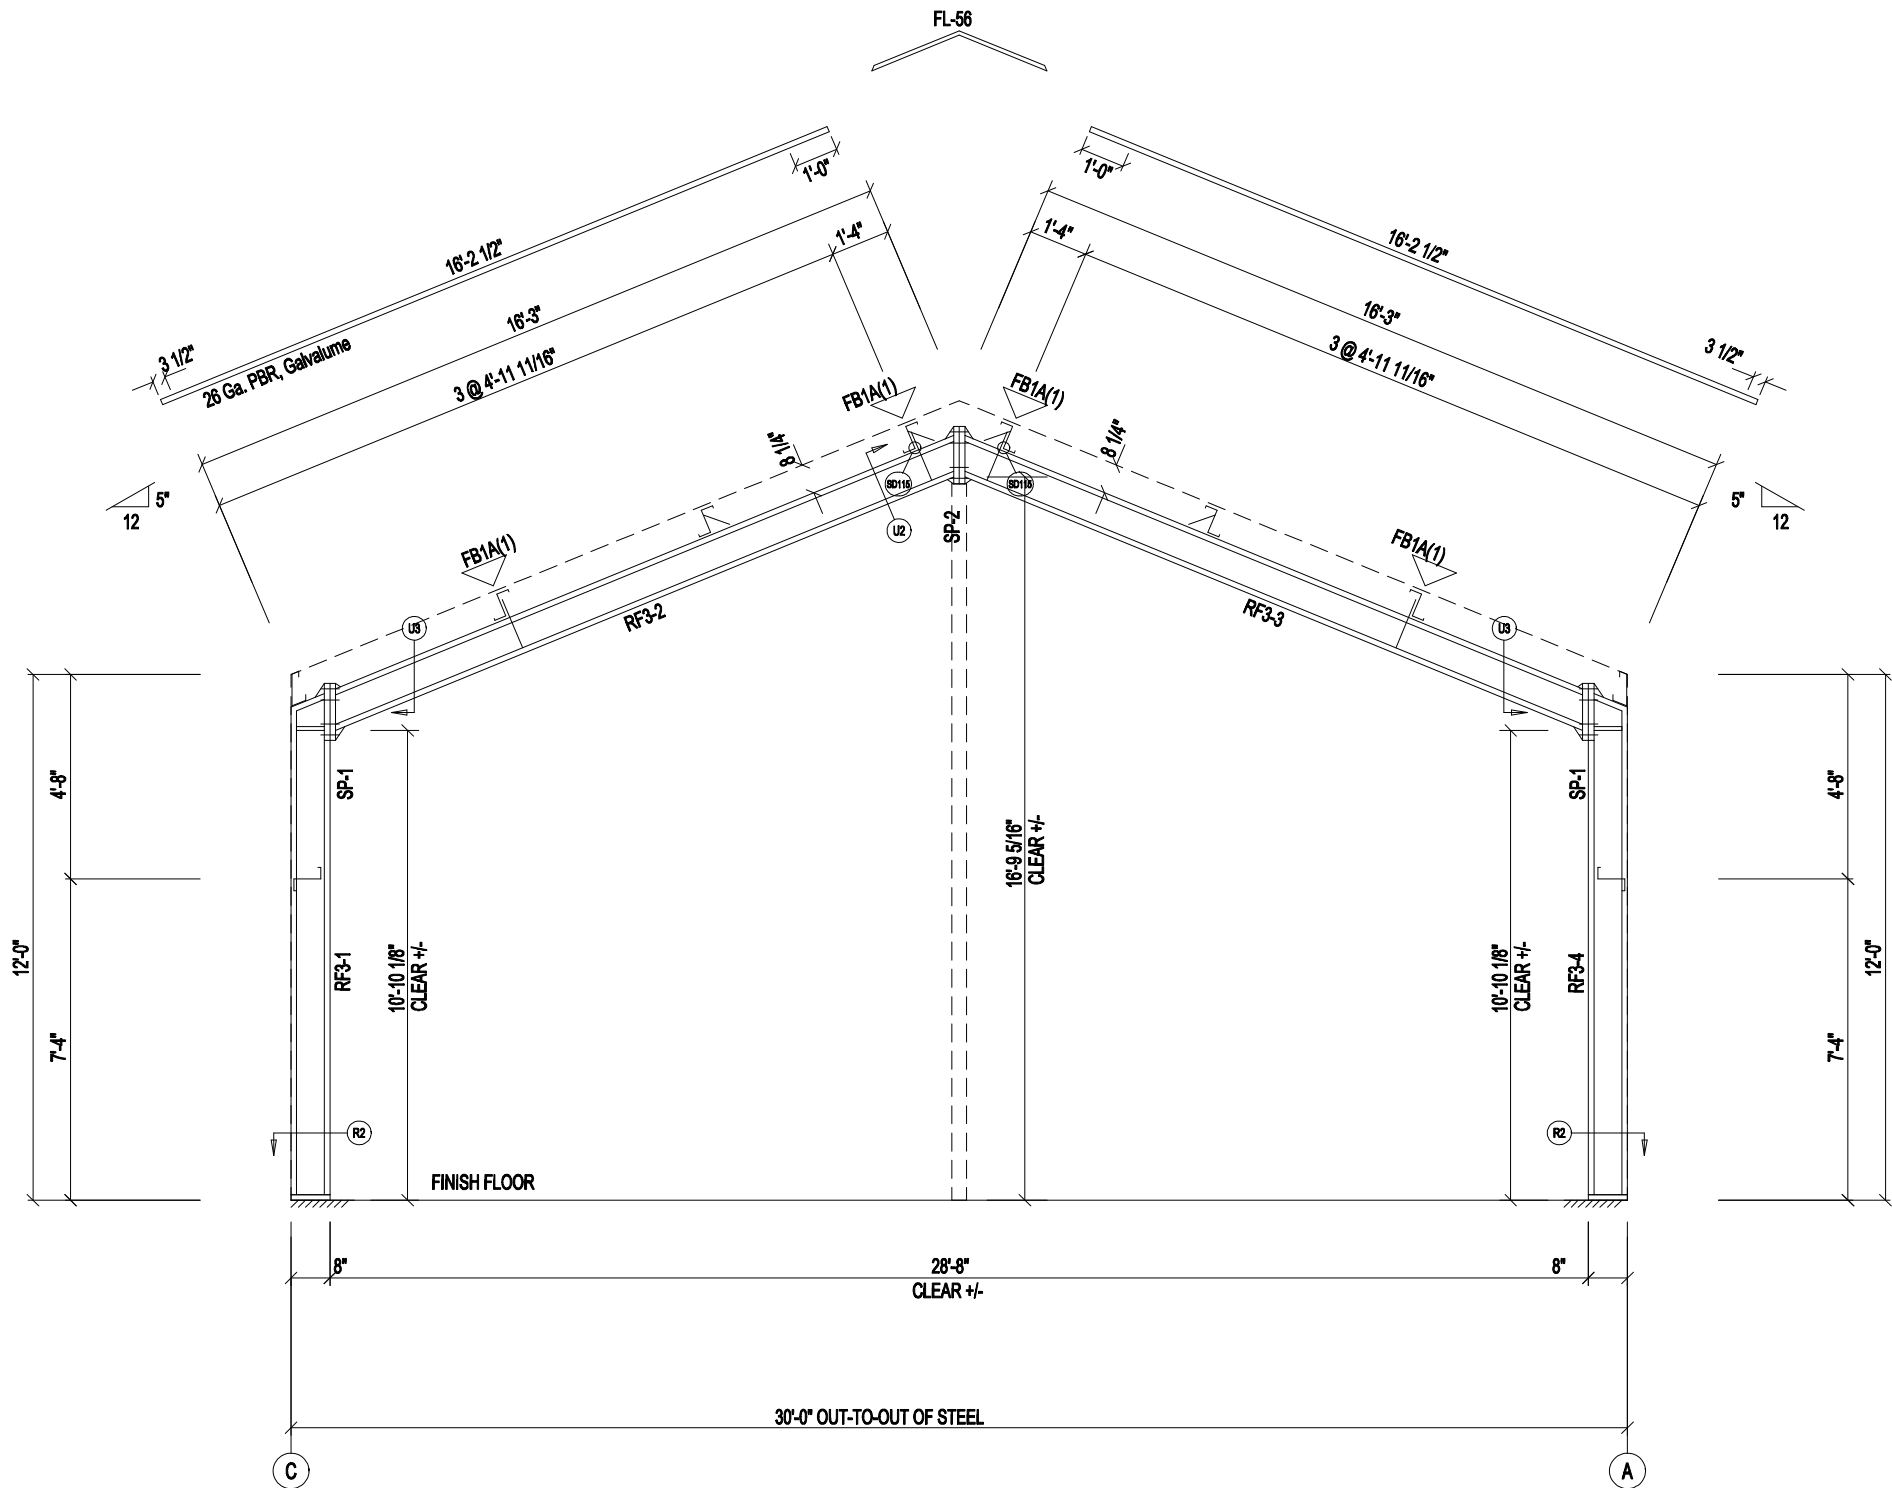

RIGID FRAME ELEVATION: FRAME LINE 4



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DESCRIPTION: CROSS SECTION

SHEET 9 of 15

CUSTOMER: LarryLaird

PROJECT: LarryLaird

LOCATION: FL 32038

DRN. BY: APX

CKD BY: SUN

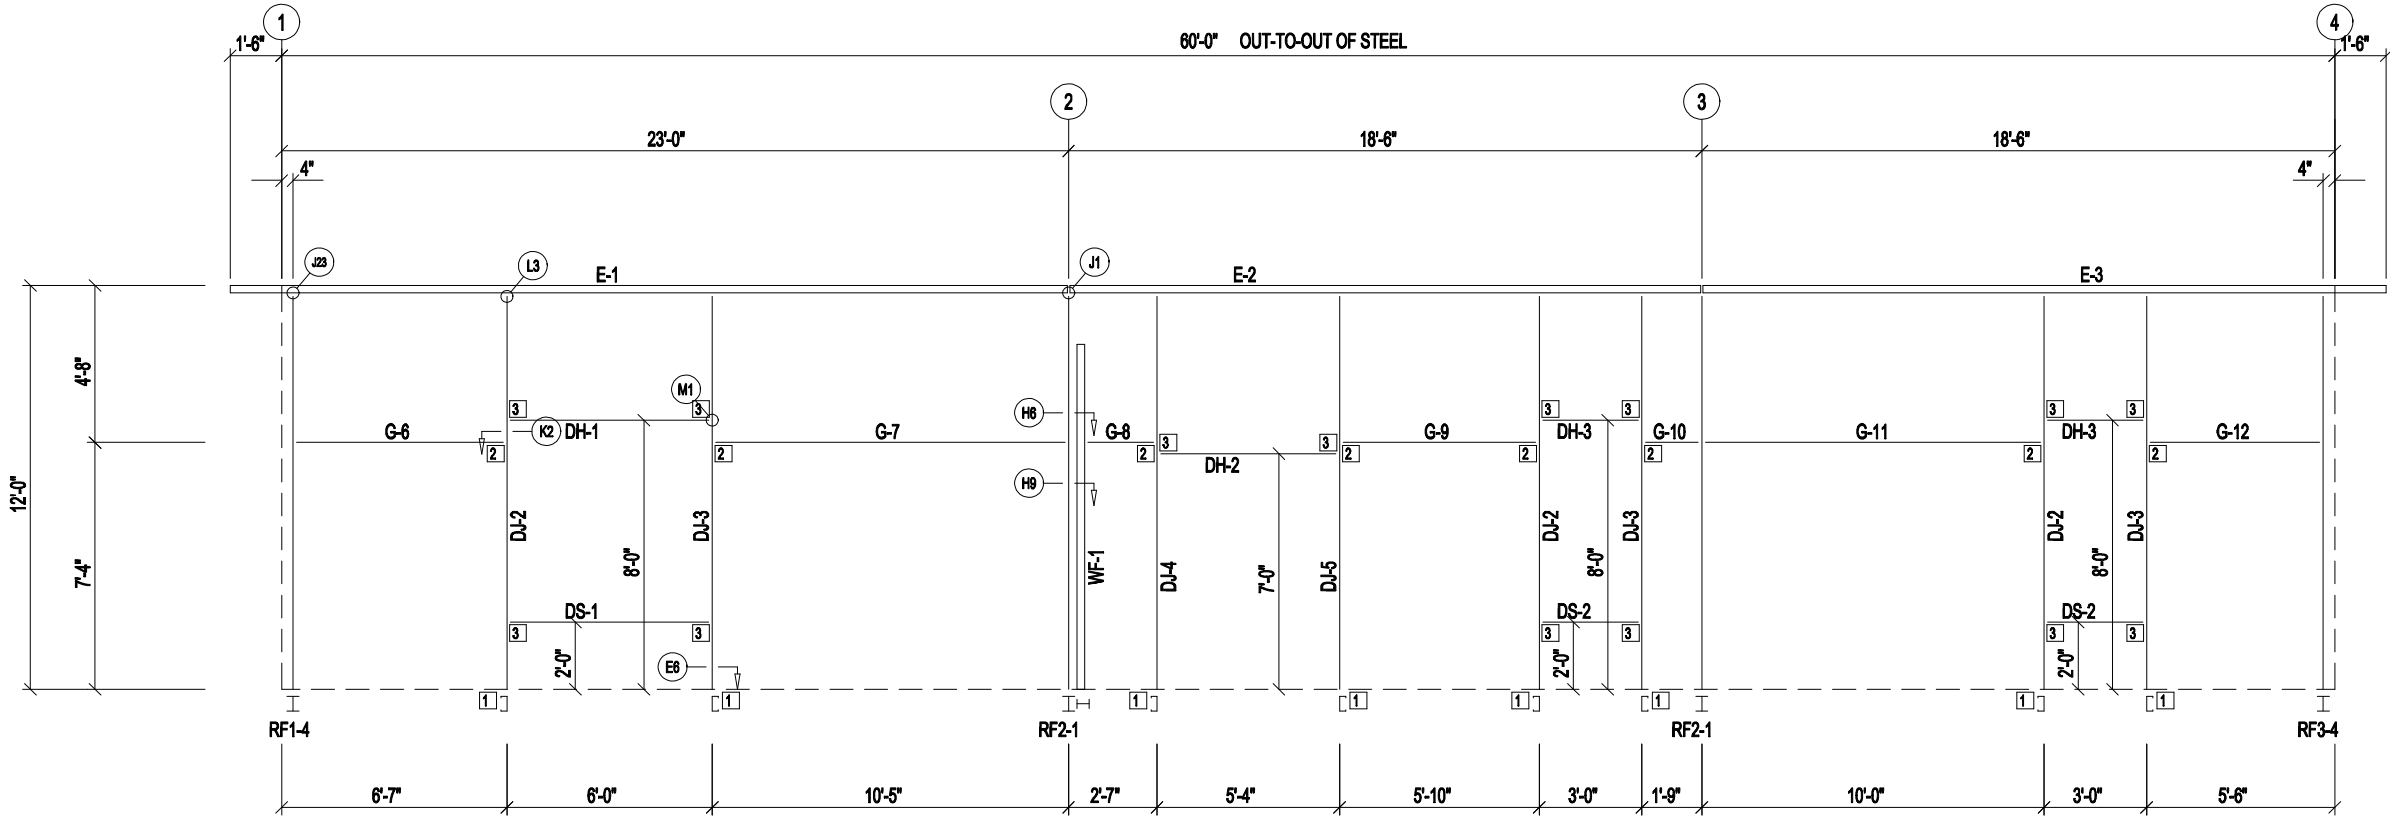
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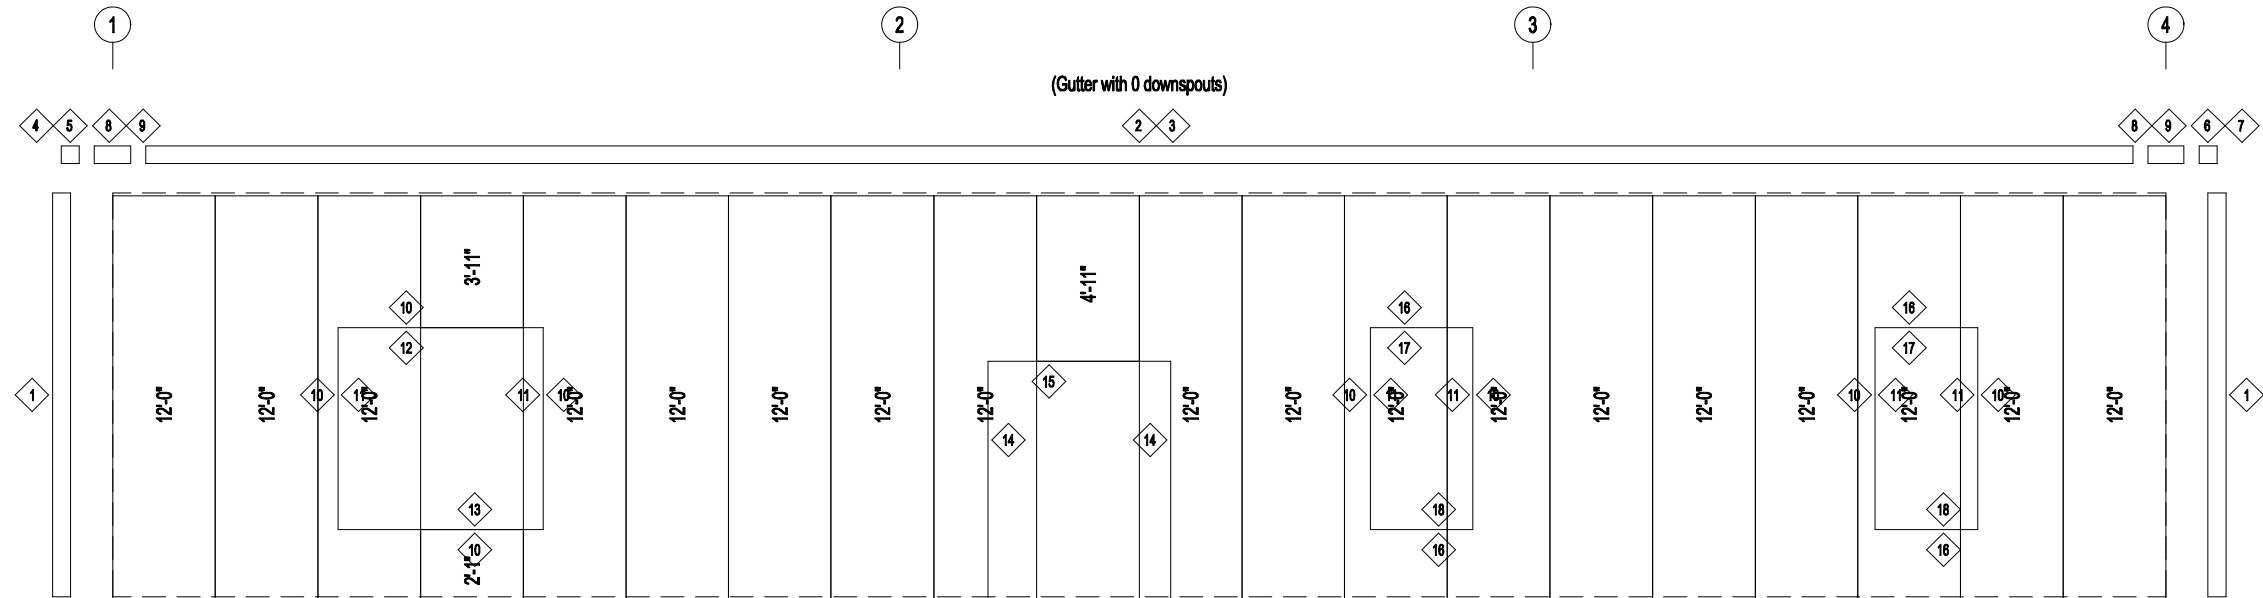
REV: 00

QUOTATION NO. 21-875

SHEET NO. OF



SIDEWALL FRAMING: FRAME LINE A



SIDEWALL SHEETING & TRIM: FRAME LINE A


PANELS: 26 Ga. PBR - Need Std. Color

BOLT TABLE				
FRAME LINE A				
LOCATION	QUAN	TYPE	DIA	LENGTH
WF-1 - RF2-1	6	A325	5/8"	1 1/2"


MEMBER TABLE		
FRAME LINE A		
MARK	PART	LENGTH
WF-1	W12X16	10'-6"
DJ-2	8X35C16	11'-6 3/8"
DJ-3	8X35C16	11'-6 3/8"
DJ-4	8X35C16	11'-6 3/8"
DJ-5	8X35C16	11'-6 3/8"
DH-1	8X25C16	5'-11 1/2"
DH-2	8X25C16	5'-3 1/2"
DH-3	8X25C16	2'-11 1/2"
DS-1	8X25C16	5'-11 1/2"
DS-2	8X25C16	2'-11 1/2"
E-1	8.50E14	24'-5 1/2"
E-2	8.50E14	18'-5 1/2"
E-3	8.50E14	19'-11 1/2"
G-6	8X25Z16	5'-7"
G-7	8X25Z16	9'-9"
G-8	8X25Z16	1'-2 3/4"
G-9	8X25Z16	5'-2"
G-10	8X25Z16	1'-1"
G-11	8X25Z16	9'-4"
G-12	8X25Z16	4'-6"

TRIM TABLE		
FRAME LINE A		
ID	PART	LENGTH
1	FL-10	12'-0"
2	FL-32	14'-6"
3	FL-31	15'-11"
4	FL-32L	11'-2"
5	FL-33L	8"
6	FL-32R	11'-2"
7	FL-33R	8"
8	FL-32	1'-6"
9	FL-80	1'-6"
10	FL-55	6'-4"
11	FL-48	6'-3"
12	FL-52	6'-4"
13	FL-53	6'-4"
14	FL-48	7'-3"
15	FL-52	5'-8"
16	FL-55	3'-4"
17	FL-52	3'-4"
18	FL-53	3'-4"

CONNECTION PLATES	
FRAME LINE A	
ID	MARK/PART
1	CL-104
2	CL-103
3	CL-100

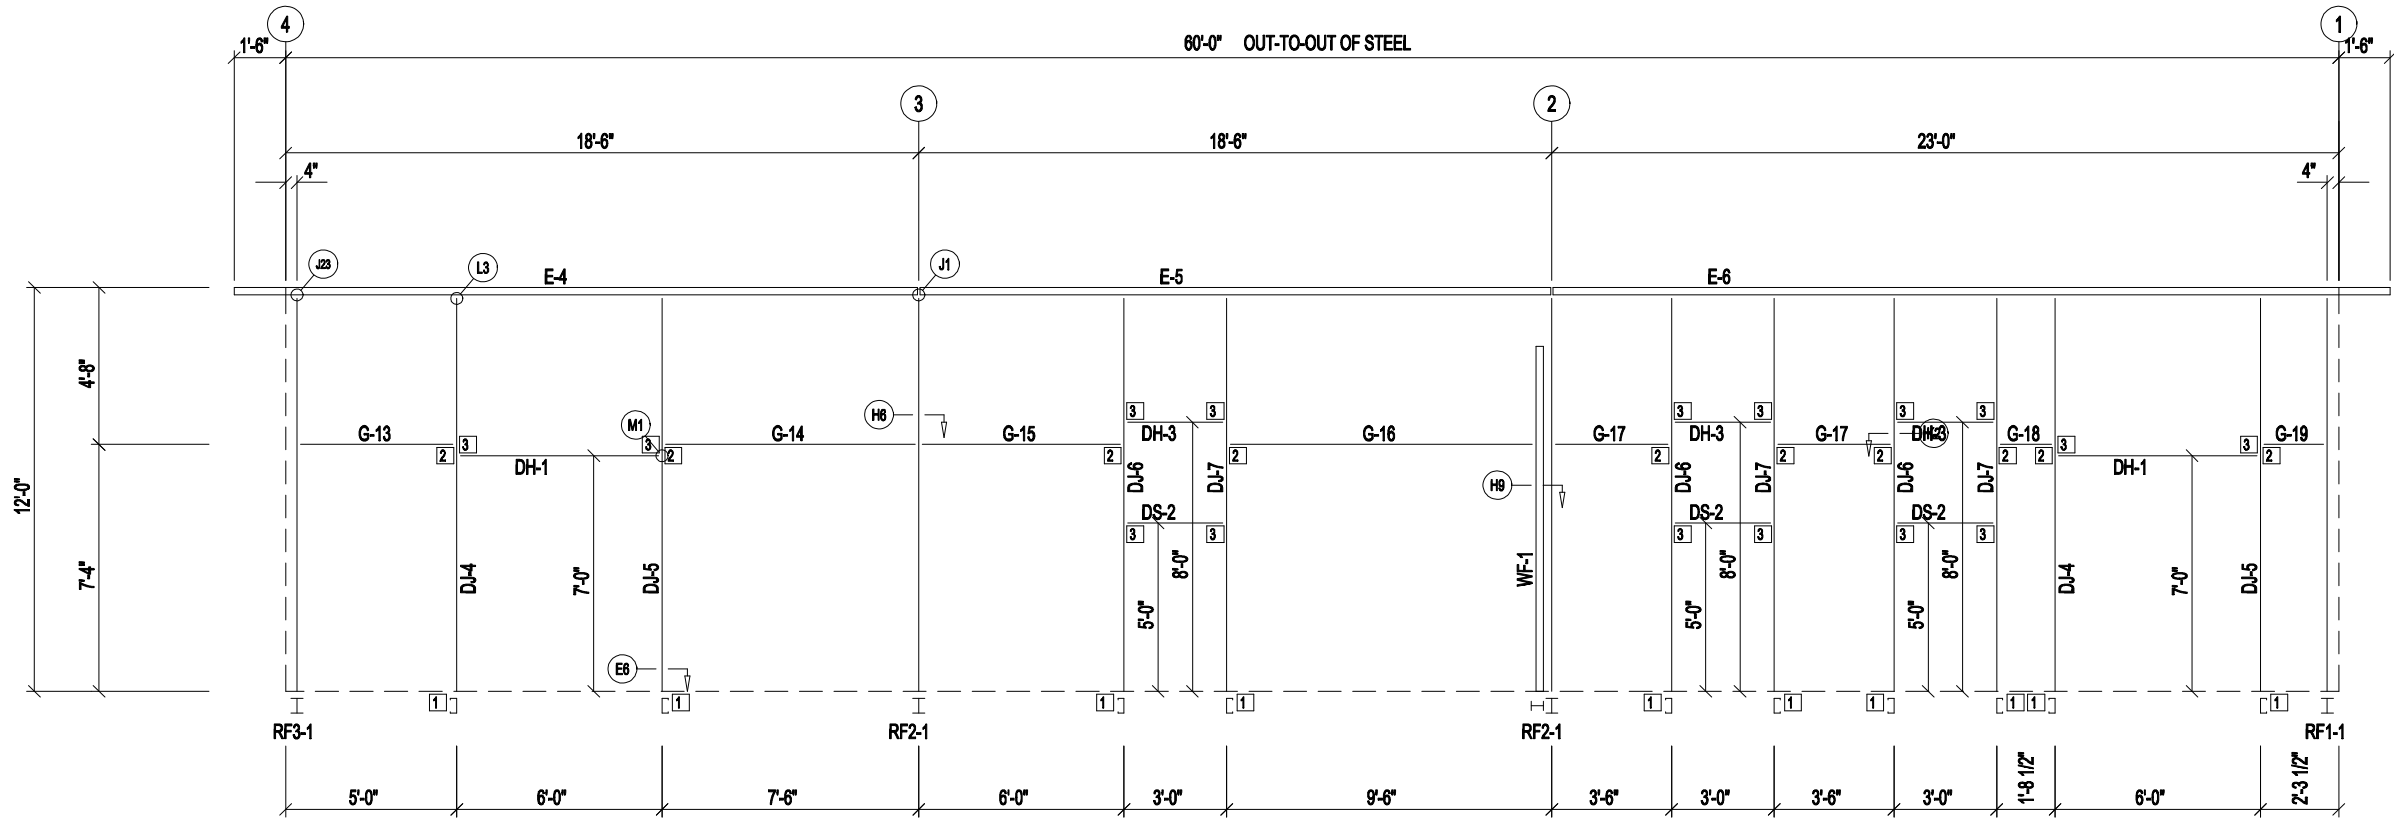

SIDEWALL FRAMING: FRAME LINE C

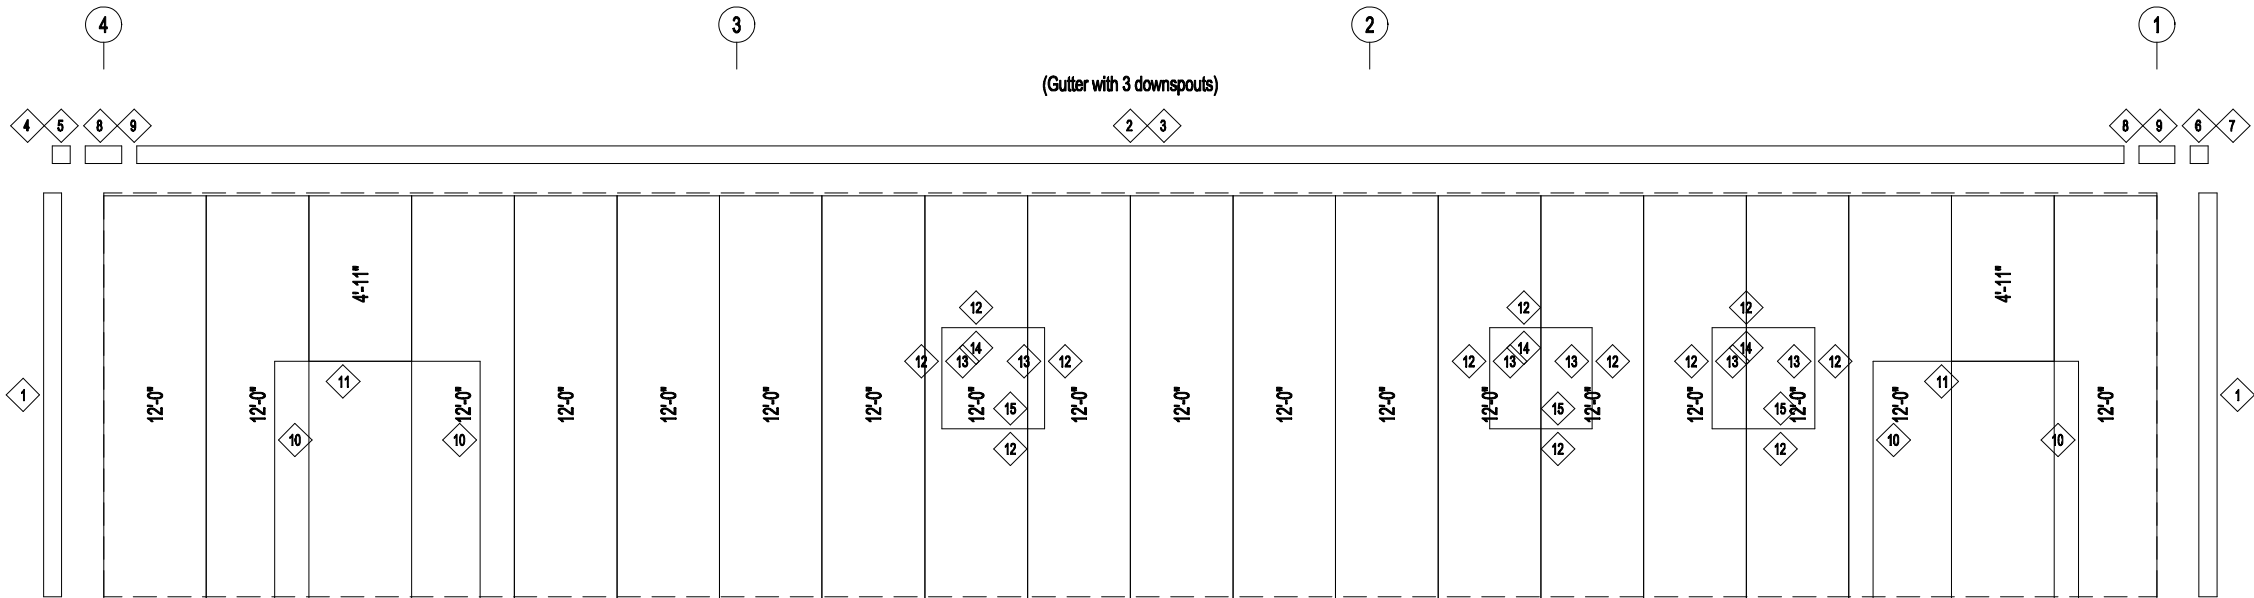

SIDEWALL SHEETING & TRIM: FRAME LINE C

PANELS: 26 Ga. PBR - Need Std. Color

BOLT TABLE FRAME LINE C				
LOCATION	QUAN	TYPE	DIA	LENGTH
WF-1 - RF2-1	6	A325	5/8"	1 1/2"

MEMBER TABLE FRAME LINE C		
MARK	PART	LENGTH
WF-1	W12X16	10'-6"
DJ-4	8X35C16	11'-6 3/8"
DJ-5	8X35C16	11'-6 3/8"
DJ-6	8X35C16	11'-6 3/8"
DJ-7	8X35C16	11'-6 3/8"
DH-1	8X25C16	5'-11 1/2"
DH-3	8X25C16	2'-11 1/2"
DS-2	8X25C16	2'-11 1/2"
E-4	8.50E14	19'-11 1/2"
E-5	8.50E14	18'-5 1/2"
E-6	8.50E14	24'-5 1/2"
G-13	8X25Z16	4'-0"
G-14	8X25Z16	6'-10"
G-15	8X25Z16	5'-4"
G-16	8X25Z16	8'-1 3/4"
G-17	8X25Z16	2'-10"
G-18	8X25Z16	1'-0 1/2"
G-19	8X25Z16	1'-3 1/2"

TRIM TABLE FRAME LINE C		
ID	PART	LENGTH
1	FL-10	12'-0"
2	FL-32	14'-6"
3	FL-31	15'-11"
4	FL-32L	11'-2"
5	FL-33L	8"
6	FL-32R	11'-2"
7	FL-33R	8"
8	FL-32	1'-6"
9	FL-80	1'-6"
10	FL-48	7'-3"
11	FL-52	6'-4"
12	FL-55	3'-4"
13	FL-48	3'-3"
14	FL-52	3'-4"
15	FL-53	3'-4"

CONNECTION PLATES FRAME LINE C	
ID	MARK/PART
1	CL-104
2	CL-103
3	CL-100



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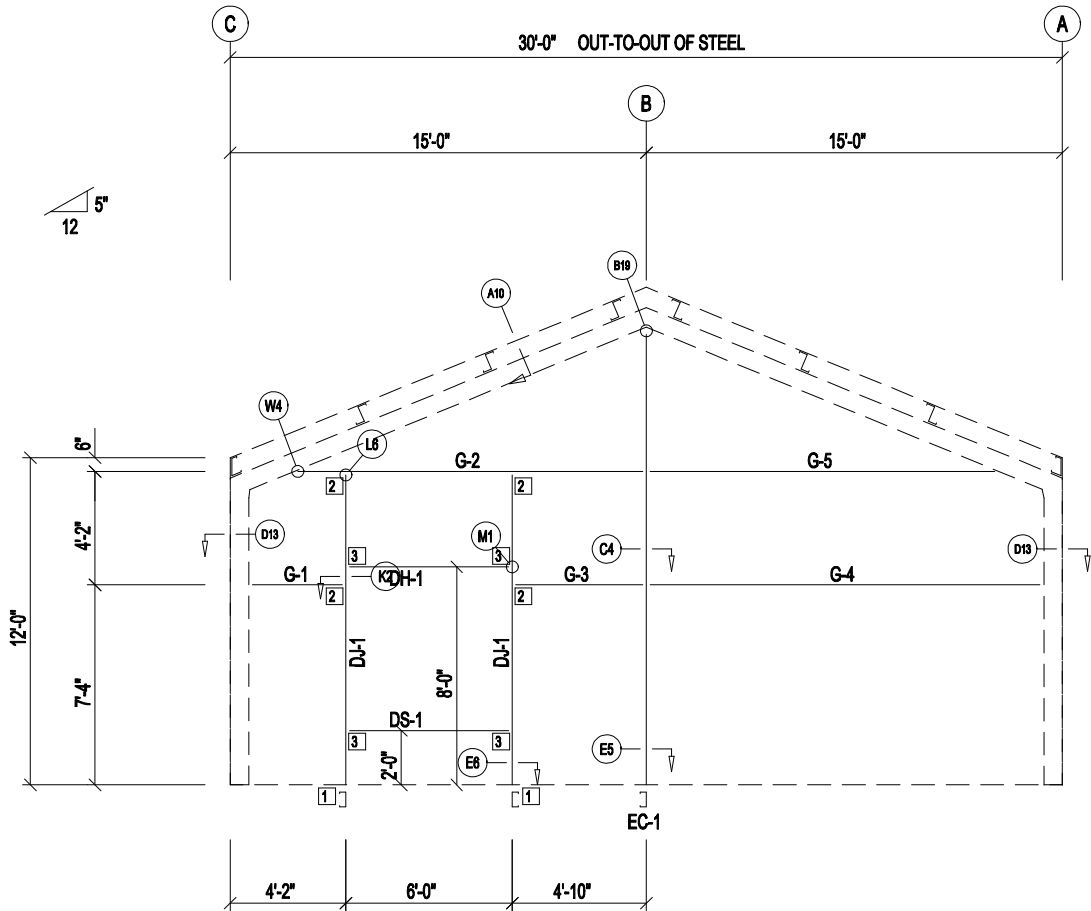
DESCRIPTION: SIDEWALL ELEVATION						SHEET 11 of 15	
CUSTOMER: LarryLaird			PROJECT: LarryLaird				
LOCATION: FL 32038							
DRN. BY APX	CKD BY SUN	DATE 7/18/21	SCALE N.T.S.	REV. 00	QUOTATION NO. 21-875	SHEET NO. OF	

BOLT TABLE FRAME LINE 1				
LOCATION	QUAN	TYPE	DIA	LENGTH
Columns/Raf	2	A325	5/8"	1 1/4"


MEMBER TABLE FRAME LINE 1		
MARK	PART	LENGTH
EC-1	8X35C12	16'-5 13/16"
DJ-1	8X35C16	11'-1 3/4"
DH-1	8X25C16	5'-11 1/2"
DS-1	8X25C16	5'-11 1/2"
G-1	8X25Z16	3'-1 3/4"
G-2	8X25Z16	12'-4 1/16"
G-3	8X25Z16	4'-2"
G-4	8X25Z16	13'-11 3/4"
G-5	8X25Z16	12'-4 1/16"

TRIM TABLE FRAME LINE 1		
◇ ID	PART	LENGTH
1	FL-10	12'-0"
2	FL-50	16'-3"
3	FL-88	1'-6"
4	FL-55	6'-4"
5	FL-48	6'-3"
6	FL-52	6'-4"
7	FL-53	6'-4"

CONNECTION PLATES FRAME LINE 1	
□ ID	MARK/PART
1	CL-104
2	CL-103
3	CL-100



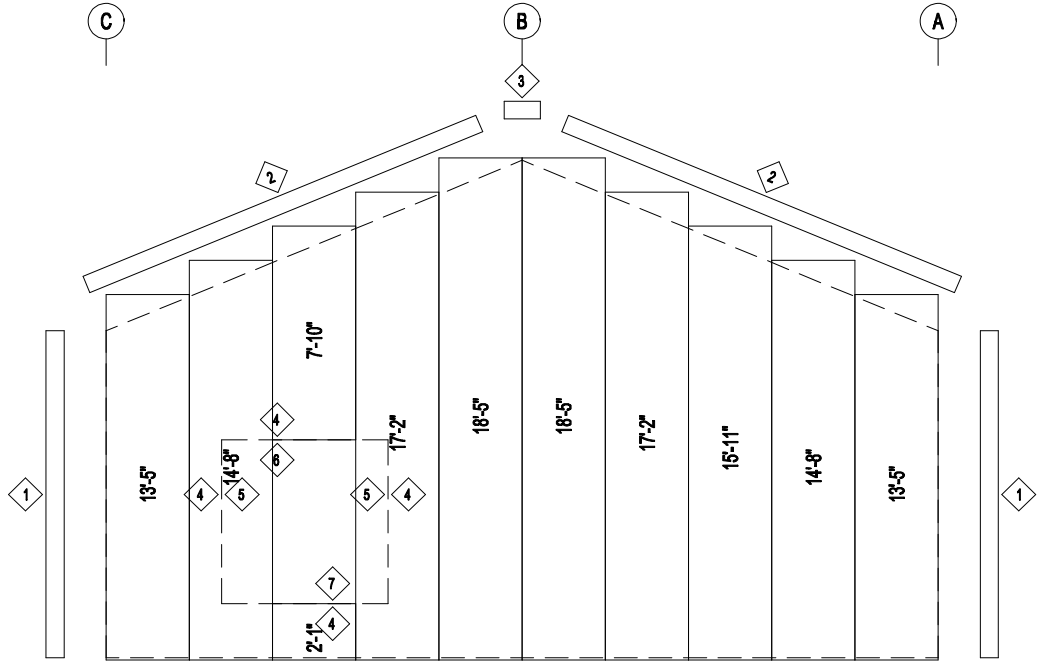ENDWALL FRAMING: FRAME LINE 1




ENDWALL SHEETING & TRIM: FRAME LINE 1

PANELS: 26 Ga. PBR - Need Std. Color




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Live Oak, FL 32064
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DESCRIPTION: ENDWALL ELEVATION							SHEET 12 of 15	
CUSTOMER: LarryLaird				PROJECT: LarryLaird				
LOCATION: FL 32038								
DRN. BY APX	CK'D BY SUN	DATE 7/18/21	SCALE N.T.S.	REV. 00	QUOTATION NO. 21-875	SHEET NO. OF		

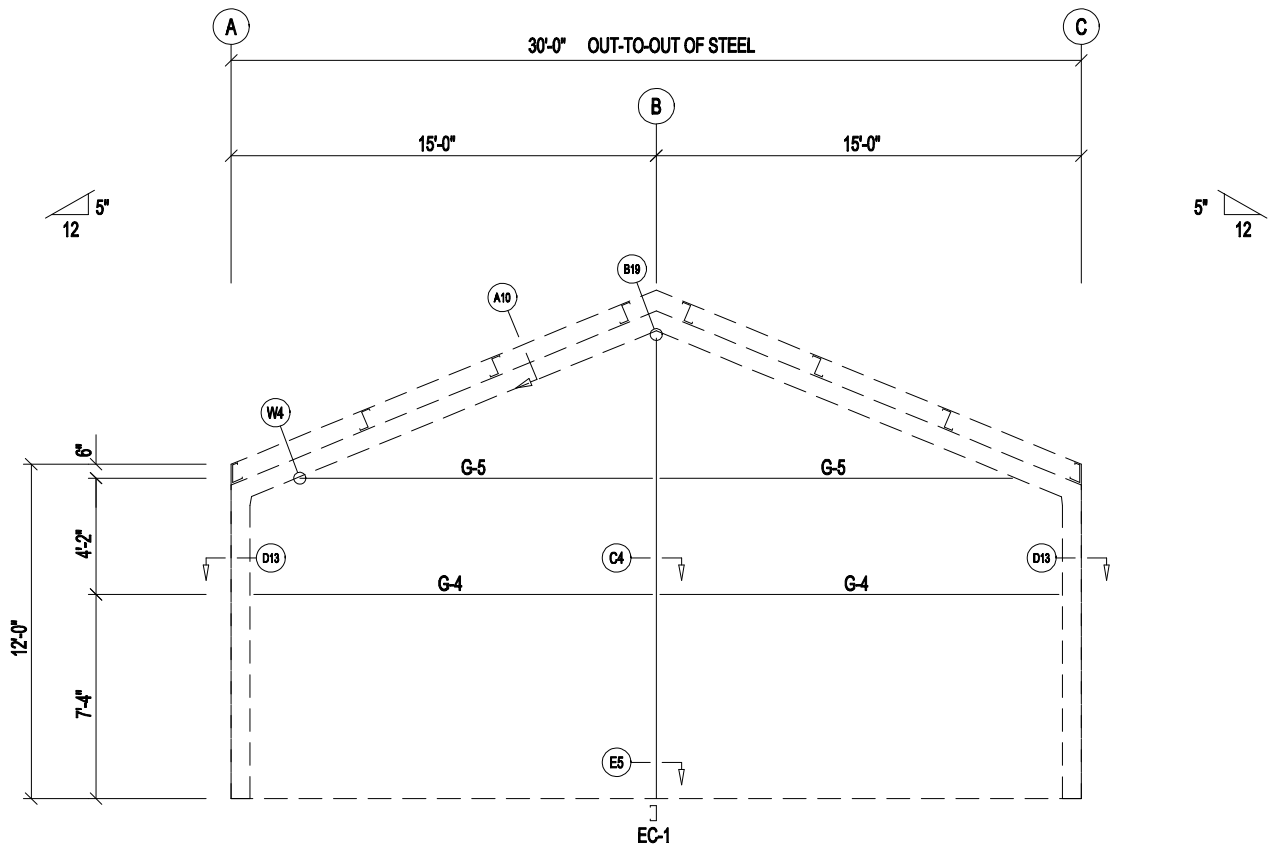

ENDWALL FRAMING: FRAME LINE 4

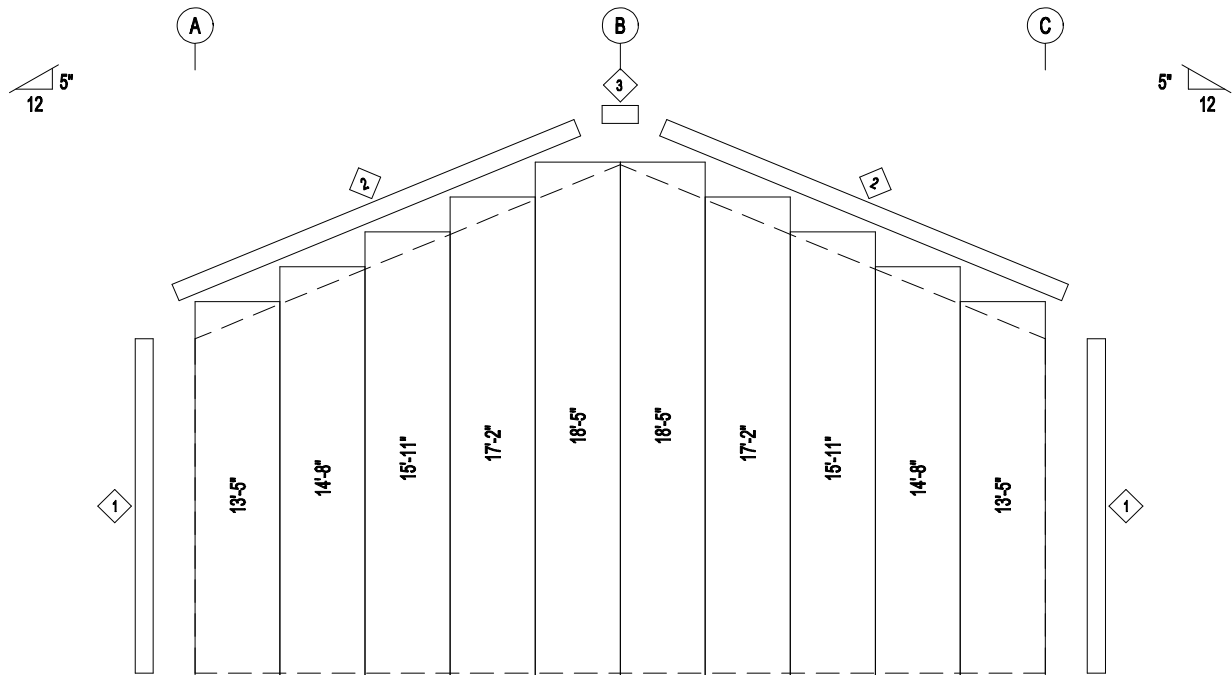

ENDWALL SHEETING & TRIM: FRAME LINE 4

PANELS: 28 Ga. PBR - Need Std. Color

BOLT TABLE FRAME LINE 4				
LOCATION	QUAN	TYPE	DIA	LENGTH
Columns/Raf	2	A325	5/8"	1 1/4"
















MEMBER TABLE FRAME LINE 4		
MARK	PART	LENGTH
EC-1	8X35C12	16'-5 13/16"
G-4	8X25Z16	13'-11 3/4"
G-5	8X25Z16	12'-4 1/16"

TRIM TABLE FRAME LINE 4		
◇ ID	PART	LENGTH
1	FL-10	12'-0"
2	FL-50	16'-3"
3	FL-88	1'-6"



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DESCRIPTION: ENDWALL ELEVATION						SHEET 13 of 15	
CUSTOMER: LarryLaird			PROJECT: LarryLaird				
LOCATION: FL 32038							
DRN. BY APX	CK'D BY SUN	DATE 7/18/21	SCALE N.T.S.	REV. 00	QUOTATION NO. 21-875	SHEET NO. OF	

 <p>A10 ROOF PURLIN TO EXPANDABLE ENDWALL RIGID FRAME</p>	 <p>B19 COLUMN TO RIGID FRAME RAFTER</p>	 <p>C4 GIRT TO COLUMN</p>	 <p>D13 CORNER COLUMN TO WALL GIRT</p>	 <p>E5 BASE PLATE TO ENDWALL COLUMN OR DOOR JAMB</p>
 <p>E6 BASE PLATE FOR ENDWALL COLUMN OR DOOR JAMB</p>	 <p>G2 ROOF PURLIN TO INTERIOR FRAME RAFTER</p>	 <p>H6 WALL GIRT TO FRAME COLUMN</p>	 <p>H9 WIND BENT OR WIND COLUMN TO BUILDING COLUMN</p>	 <p>J1 EAVE STRUT TO RIGID FRAME</p>
 <p>J23 EAVE STRUT TO RIGID FRAME</p>	 <p>K2 WALL GIRT TO DOOR JAMB</p>	 <p>L3 DOOR JAMB TO EAVE STRUT</p>	 <p>L6 DOOR JAMB TO WALL GIRT</p>	 <p>M1 HEADER TO C JAMB</p>

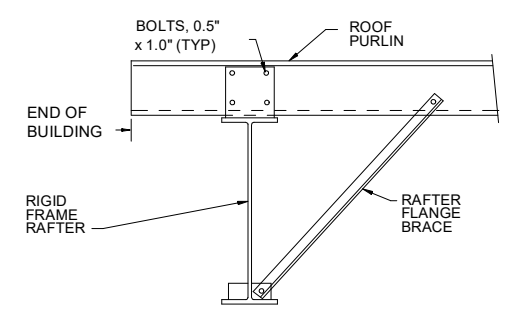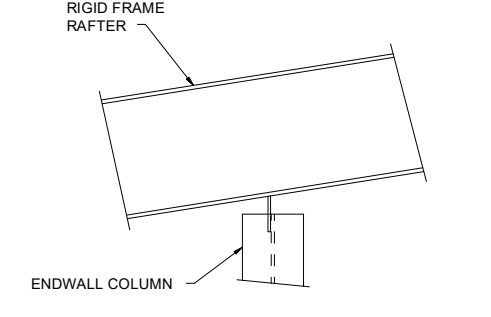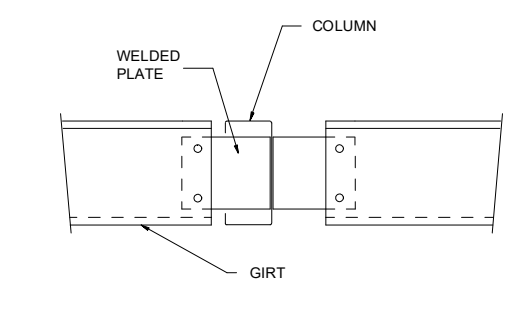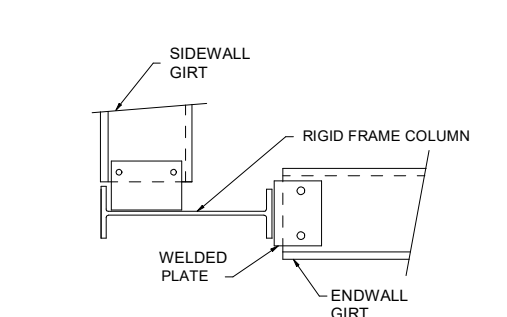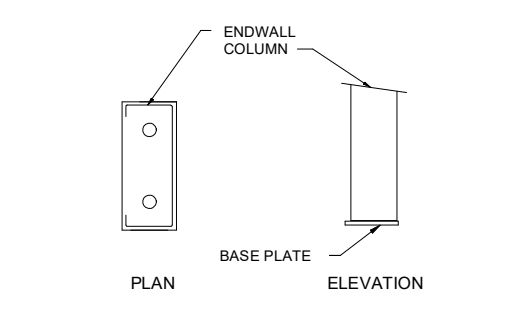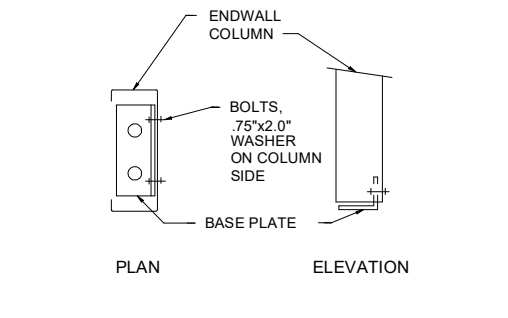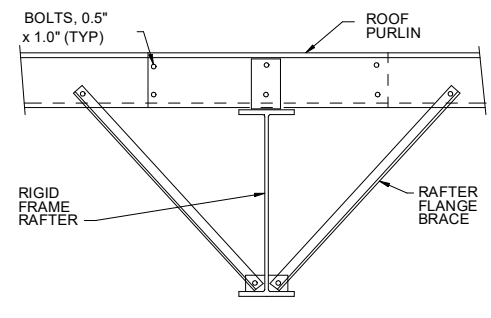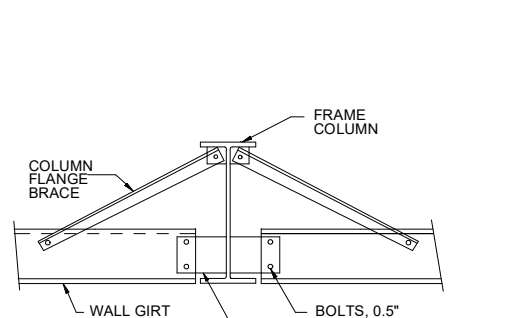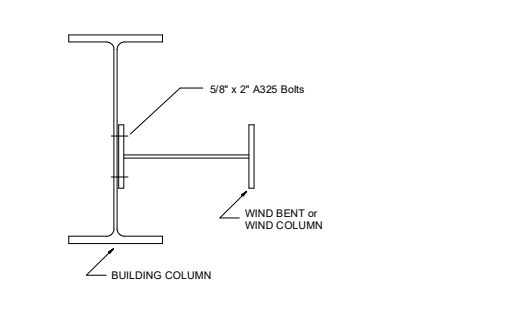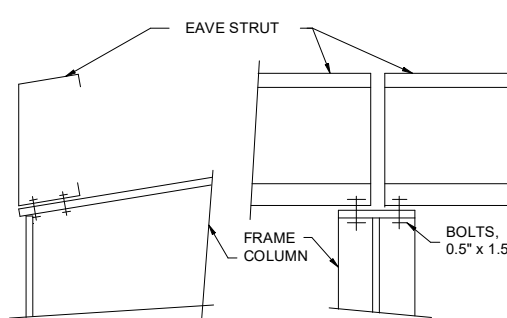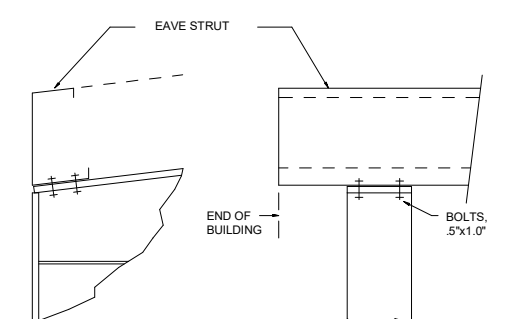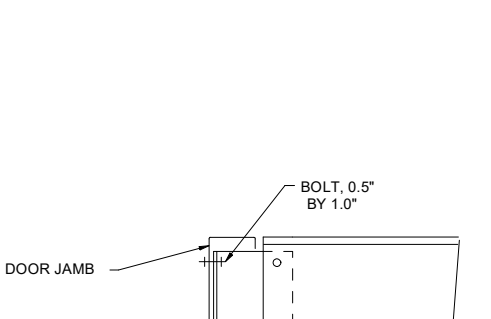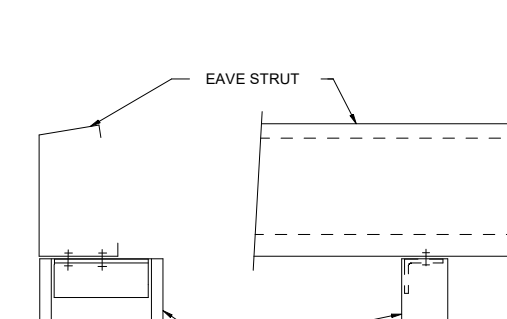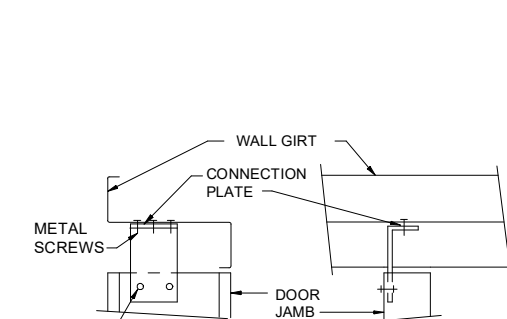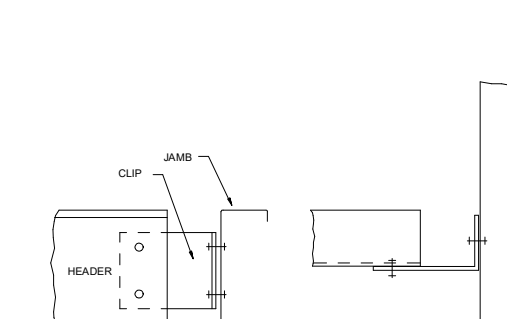Q2 DIAGONAL CABLE, EYEBOLT END

R2 ANCHOR BOLTS AT SIDEWALL COLUMN

U2 BOLTED END PLATE CONNECTION AT BUILDING PEAK

U3 BOLTS FOR RAFTER TO COLUMN CONNECTION

W4 SECTION OF ENDWALL GIRT TO RAFTER