

DIRECTIONAL/WAYFINDING SIGN

045 - TAKE 5

CAR WASH

345 W Duval St
Lake City, FL 32055



Underwriters Laboratories Inc.
UL File #E225670

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Underwriters Laboratories.

INITIAL LAYOUT:


May 09, 2022

REVISIONS:

I
II
III
IV
V



- Color Key:**
- PMS 2191 C
 - PMS 7691 C
 - PMS 107 C
 - PMS 7625 C
 - Black
 - White

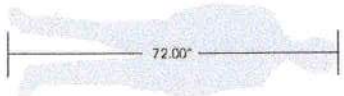

SPECIFICATIONS

**NON ILLUMINATED
DOUBLE-SIDED
POST & CHANNEL**

Size: As in drawing
Material: Aluminum square tubing
Channel

Face Color: As in drawing
Trim: 1"

Trim Color: Black

Return Color: Black



Return Depth: 3"

Face: 1/8" Acrylic

Leg Color: Black

Mounting: Into Earth

DETAIL

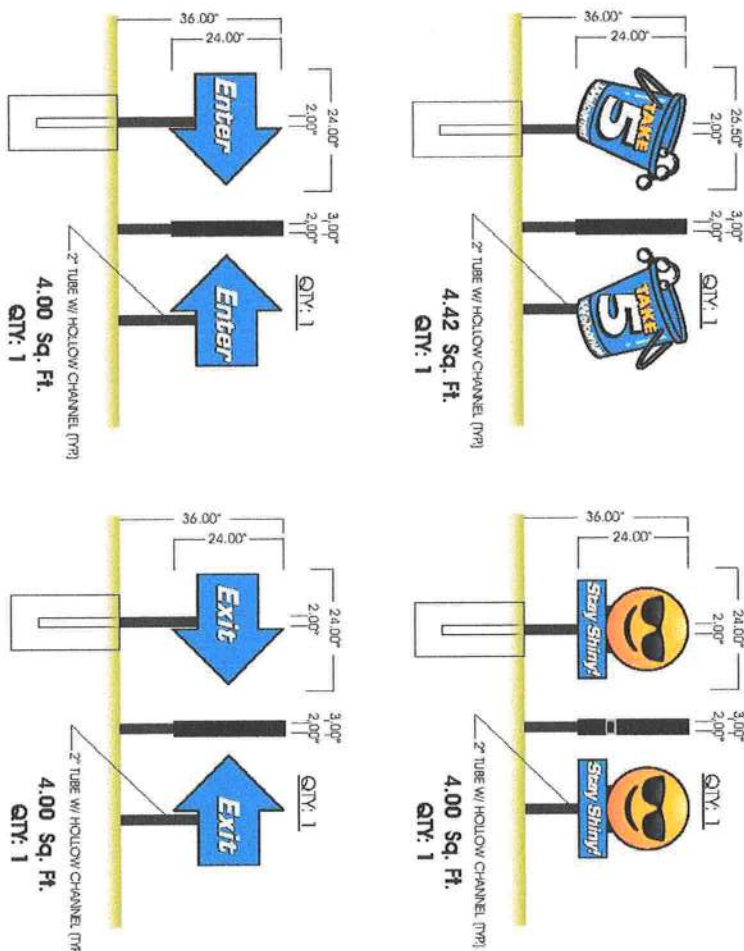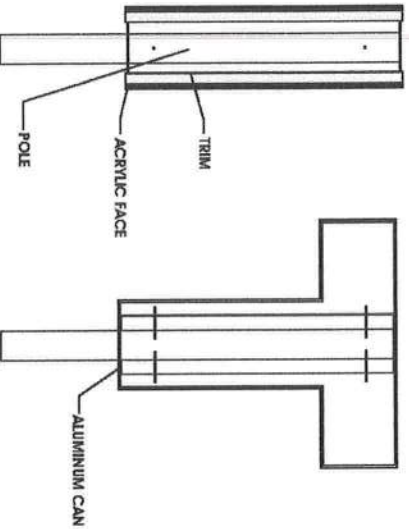

- NOTES:**
- HOLES TO BE DUG BY HAND TO AVOID DAMAGING UNMARKED UNDERGROUND LINES
 - ALL WAYFINDING SIGNS MUST BE REINFORCED WITH CONCRETE

Owner/Landlord Approval
6801 Mount Hermon Church Rd, Ste C, Durham, NC 27705 • (P) 919-552-8689 • (F) 919-557-1322

SIGNS:UNLIMITED

communicate your identity

045 - TAKE 5

345 W Duval St

Lake City, FL 32055

April 15, 2022

1

4

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UL File #E225670

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SITE PLAN

PHASE 1



CALCULATIONS INCLUDE THE FOLLOWING CONSIDERATIONS
AS OUTLINED IN THE 2020 FLORIDA BUILDING CODE (7TH ED.) :
CHAPTER 16-LOADS AND FORCES
CHAPTER 17-SPECIAL INSPECTIONS
CHAPTER 18-SOILS AND FOUNDATIONS
CHAPTER 19-CONCRETE
CHAPTER 20-ALUMINUM
CHAPTER 21-MASONRY
CHAPTER 22-STEEL
CHAPTER 23-WOOD
ALL SIGNS SHALL BE COMPLIANT WITH CURRENT NEC CODES

- NOTES
- 1.) SEE MANUFACTURERS DRAWINGS FOR ADDITIONAL DETAILS AND DIMENSIONS.
 - 2.) SIGN CABINET AND CONNECTION BY SIGNS UNLIMITED.

- * CLIENT - SIGNS UNLIMITED
- * 2020 FLORIDA BUILDING CODE 7TH ED.
- * RISK CATEGORY II
- * 120 MPH WIND SPEED, EXP. C
- * (1) POLE, (1) FOOTING

WIND DATA

Building Code	2020 Florida Buildr	Importance Factor, I	1.0	Damping Ratio, β	0.005
Wind Load Criteria	ASCE 7-16	Directionality Factor, K_d	0.85	Natural Frequency, n_s	12.87 Hz
Wind Speed, V	120 mph	Topography Factor, K_z	1.0	Gust Effect Factor, G	0.85
Exposure Category	C	Base Pressure, w_0/K_z	18.8 psf	ASD Wind Load Factor, γ	0.6
Wind Pressure Override per Jurisdiction Requirement	0 psf	Notes: (1) Loading values in chart below are based upon average K_z values for each segment. Actual values are calculated on hidden sheet using derived V-M equations. Chart is provided for information purposes only. (2) Wind directionality (K_d) factor is 0.95 for Single Pole (Round) segments instead of 0.85. The C_f value from Fig. 6-21 has been increased by 0.95/0.85 to account for this variation. (3) Wind pressures listed below have already been multiplied by the ASD Wind Load Factor, γ .			

DEFLECTION ANALYSIS

Deflection Limit	H/60
Deflection at 0.7*W	0.04 in
Deflection Ratio	H/873

GEOMETRY INPUT


No. of Poles		Monument		No	
Section	Location	Type	Height	Width	Offset
1	Base	Single Pole (Not Round)	1.00	0.17	0.2
2		Single Pole w/ Cabinet	2.00	2.21	4.4
Overall Height:			3.00 ft	Summation based upon averages above:	
				Actual base reactions based upon V-M equations:	
				0.1	0.2
				0.1	0.2

SUPPORT POLE DESIGN SUMMARY

Base Elev	Section	Axis	Required Strength Values (ASD)						Allowable Strength Values (ASD)						Unity Ratios				Interaction Ratios		Status
			V _r kips	M _r kip-ft	T _r kips	P _r kips	V _c kips	M _c kip-ft	T _c kip-ft	P _c kips	V _u /V _c	M _u /M _c	T _u /T _c	P _u /P _c	P-M	P-M-V-T					
0.00	HSS2X2X1/8	Strong	0.1	0.2	0.0	0.1	7.1	1.3	1.1	12.7	1.5%	14.9%	3.9%	0.4%	15.3%	0.0%	✓				

FOUNDATION DESIGN SUMMARY

Type	Diameter	Width	Thickness	Length	Depth	Volume	Reinforcing	Status	Allowable Soil Pressure
✓ Caisson	1.00	--	--	--	2.25	0.07		OK	300 psf/ft
Vertical Slab									
Spread									

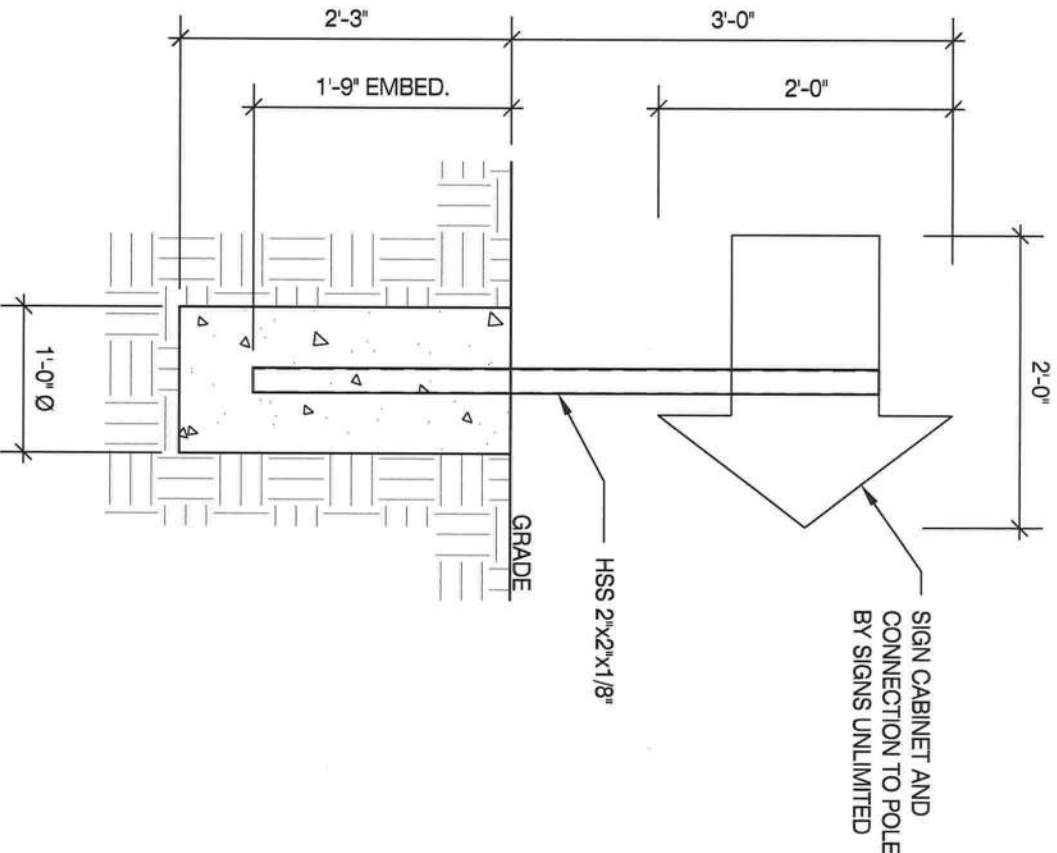

FRONT ELEVATION W/ CAISSON FOUNDATION

SCALE: N.T.S.

1

MBI COMPANIES INC.

299 N. WEISGARBER RD.
KNOXVILLE, TN 37919

PHONE: 865.584.0999
SIGN-ENGINEER.COM

PROJECT:

345 West Duval Street, Lake City, Florida, 32055

DRAWING TITLE:

TAKE 5

DRAWN BY:

DEW

CHECKED BY:

TSM

COMM. NO.

220149.164

DATE:

09/27/22

DRAWING NO.

DWG.


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- * CLIENT - SIGNS UNLIMITED
- * 2020 FLORIDA BUILDING CODE 7TH ED.
- * RISK CATEGORY II
- * 120 MPH WIND SPEED, EXP. C
- * (1) POLE, (1) FOOTING



FRONT ELEVATION W/ CAISSON FOUNDATION

SCALE: N.T.S.

1

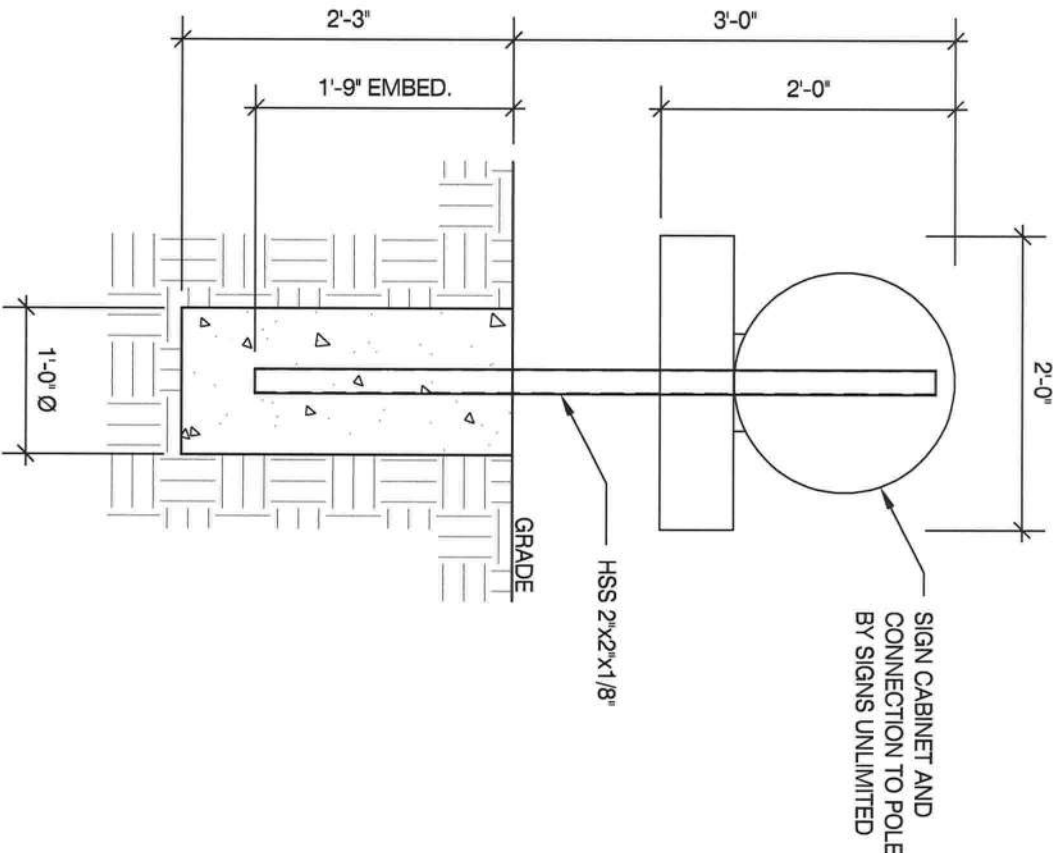WIND DATA									
Building Code	2020 Florida Building	Importance Factor, I	1.0	Damping Ratio, β	0.005	Deflection Limit	H/60		
Wind Load Criteria	ASCE 7-16	Directionality Factor, K_d ⁽²⁾	0.85	Natural Frequency, f_n	12.87 Hz	Deflection at 0.7" W	0.04 in		
Wind Speed, V	120 mph	Topography Factor, K_z	1.0	Gust Effect Factor, G	0.85	Deflection Ratio	H/873		
Exposure Category	C	Base Pressure, W_0/K_z	18.5 psf	ASD Wind Load Factor, γ ⁽³⁾	0.6				
Wind Pressure Override per									
Insulation Requirement	0 psf								
Notes:									
(1) Loading values in chart below are based upon average K_z values for each segment. Actual values are calculated on hidden sheet using derived V-M equations. Chart is provided for information purposes only.									

GEOMETRY INPUT (1)									
No. of Poles	1	No. of Footings	1	Monument	No				

SECTION									
Section	Location	Type	Height	Width	Offset	Area	Top Elev.	Centroid	K_1
1	Base	Single Pole (Not Round)	1.00	0.17		0.2	1.0	0.5	0.85
2	Base	Single Pole w/ Cabinet	2.00	2.21		4.4	3.0	2.0	0.85
			Overall Height:	3.00 ft					
						Actual base reactions based upon V-M equations:			
						0.1	0.1	0.2	0.2

SUPPORT POLE DESIGN SUMMARY									
MATERIAL = STEEL									
Base Elev	Section	Axis	Required Strength Values (ASD)			Allowable Strength Values (ASD)			Status
			V, Kips	M, Kip-ft	T, Kip-ft	V, Kips	M, Kip-ft	T, Kip-ft	
0.00	HSS2X2X1/8	Strong	0.1	0.2	0.0	0.1	7.1	1.3	OK
FOUNDATION DESIGN SUMMARY									
Type	Diameter	Width	Thickness	Length	Depth	Volume	Reinforcing		
✓ Caisson	1.00	--	--	--	2.25	0.07			
Vertical Slab									
Spread									

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KNOXVILLE, TN 37919

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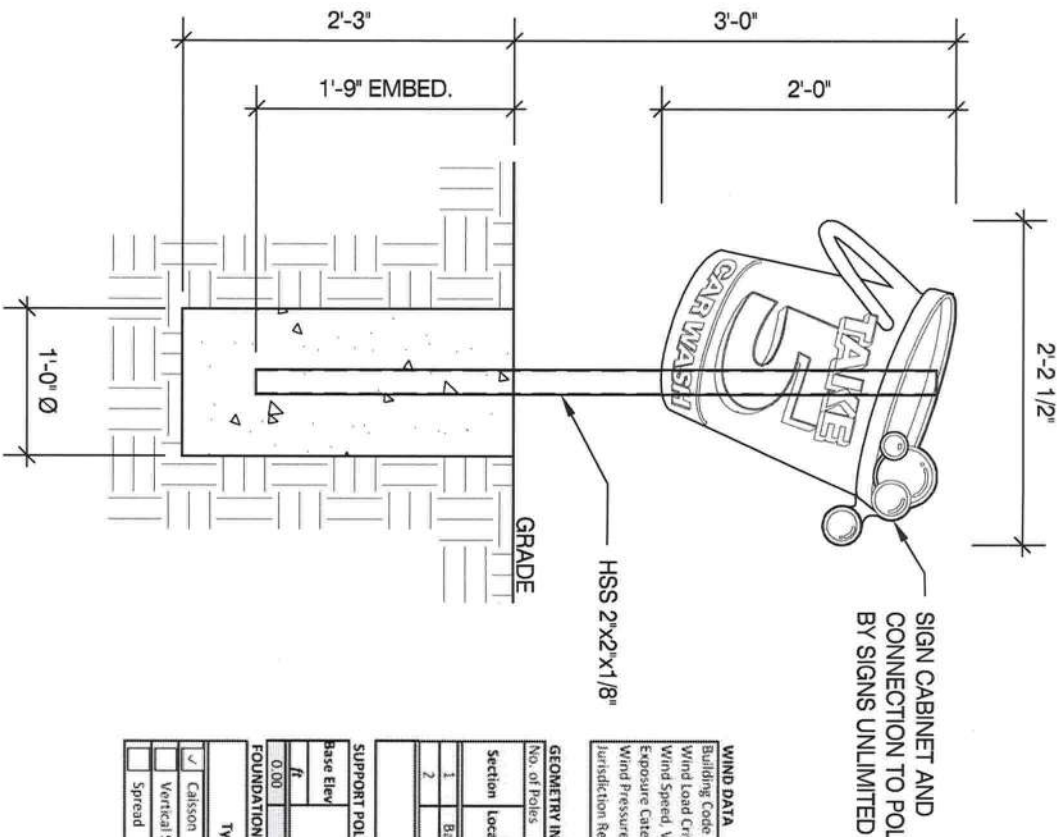
DWG.

4

DARREN S. ANTLE
P.E. LIC # 76813

GROUND SIGN DESIGN SPECIFICATIONS:

- REFER TO SIGN COMPANY'S DRAWINGS FOR MORE DETAILS. ALL DESIGNS, DETAILING FABRICATION AND CONSTRUCTION SHALL CONFORM TO: 2020 FLORIDA BUILDING CODE 7TH ED.
- ACI
- AISC
- AMERICAN WELDING SOCIETY
- LOCAL BUILDING CODES & ORDINANCES
- CONCRETE: 2500 PSI @ 28 DAYS
- STD. STEEL PIPE SECTION: ASTM A53 GRADE B (Fy=35 KSI), U.N.O.
- STEEL PIPE SECTION (> 20" Ø): ASTM A252 GRADE 3 (Fy=42 KSI MIN.), U.N.O.
- HSS ROUND SECTION: ASTM A500 GRADE B (Fy=42 KSI) U.N.O.
- HSS SQUARE/RECTANGULAR SECTION: ASTM A500 GRADE B (Fy=46 KSI)
- W SHAPES: ASTM A992 (Fy = 50 KSI)
- ANCHOR BOLTS: ASTM F1554 GRADE 36 U.N.O. (ALTERNATES GRADE 55 & 105)
- CONNECTION BOLTS: ASTM A325
- THREADED RODS: ASTM A193 GRADE B7
- STEEL ANGLES, CHANNELS, STRUCTURAL SHAPES & PLATES ASTM A36
- REINFORCING: GRADE 60 ASTM A615
- PROVIDE A MINIMUM OF THREE INCHES OF CONCRETE COVER OVER EMBEDDED STEEL.
- THE CONTRACTOR (INSTALLER) IS RESPONSIBLE FOR THE MEANS & METHODS OF CONSTRUCTION IN REGARDS TO JOBSITE SAFETY.
- NO FIELD HEATING FOR BENDING OR CUTTING OF STEEL SHALL BE ALLOWED WITHOUT THE ENGINEERS APPROVAL.
- WELDING ELECTRODES: E70XX
- ALLOWABLE SOIL BEARING PRESSURE ASSUMED: 2000 PSF
- ASSUMED HORIZONTAL (PASSIVE PRESSURE) ASSUMED AT 150 PSF/FT OF DEPTH. ISOLATED LATERAL BEARING FOUNDATIONS FOR SIGNS NOT ADVERSELY AFFECTED A 1/2" MOTION AT THE GROUND SURFACE DUE TO SHORT TERM LATERAL LOADS SHALL BE PERMITTED TO BE DESIGNED USING TWO TIMES THE TABULATED CODE VALUES.
- ALL FOOTINGS SHALL BEAR ON FIRM UNDISTURBED RESIDUAL SOIL AND/OR ENGINEERED EARTH.
- FILL COMPACTED TO 98% OF ITS MAXIMUM DRY DENSITY AS PER ASTM D 698-70 (STANDARD PROCTOR) UNLESS NOTED OTHERWISE. THE SOIL BEARING CAPACITY IS TO BE VERIFIED BY A GEOTECHNICAL ENGINEER PRIOR TO CONSTRUCTION. IF ALLOWABLE BEARING AND/OR LATERAL PRESSURE IS LESS THAN THE ABOVE ASSUMED AND/OR CALCULATED PRESSURES, THE ENGINEER SHOULD BE CONTACTED FOR RE-EVALUATION.
- EXCAVATION SHALL BE FREE OF LOOSE SOIL BEFORE POURING CONCRETE.
- WELDERS SHALL BE CERTIFIED FOR THE TYPE OF WELDING.
- ADEQUATELY BRACE POLES) UNTIL CONCRETE HAS SET UP FOR 14 DAYS.
- GROUT UNDER BASE PLATES WITH NON-SHRINK GROUT.
- THIS ENGINEER DOES NOT WARRANT THE ACCURACY OF DIMENSIONS FURNISHED BY OTHERS.
- ALL EXPOSED STEEL SHALL BE PAINTED WITH AN ENAMEL PAINT TO INHIBIT CORROSION.
- THIS DESIGN IS FOR THE INDICATED ADDRESS ONLY, AND SHOULD NOT BE USED AT OTHER LOCATIONS WITHOUT WRITTEN PERMISSION OF THE ENGINEER.
- DESIGN OF DETAILS AND STRUCTURAL MEMBERS NOT SHOWN, BY OTHERS.



FRONT ELEVATION W/ CAISSON FOUNDATION

SCALE: N.T.S.

1

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- * 120 MPH WIND SPEED, EXP. C
- * (1) POLE, (1) FOOTING

WIND DATA

Building Code	2020 Florida Buildi	Importance Factor, I	1.0	Damping Ratio, B	0.005
Wind Load Criteria	ASCE 7-16	Directionality Factor, K _d ⁽¹⁾	0.85	Natural Frequency, n ₁	12.87 Hz
Wind Speed, V	120 mph	Topography Factor, K _z	1.0	Gust Effect Factor, G	0.85
Exposure Category	C	Base Pressure, V ₁ /K _z	18.8 psf	ASD Wind Load Factor, Y ⁽²⁾	0.6
Wind Pressure Override per Jurisdiction Requirement	0 psf				

DEFLECTION ANALYSIS

Deflection Limit	H/60
Deflection at 0.7" W	0.04 in
Deflection Ratio	H/873

GEOMETRY INPUT⁽¹⁾

No. of Poles		Monument:		No	
Section	Location	Type	Height	Width	Offset
1	Base	Single Pole (Not Round)	1.00	0.17	
2	Single Pole w/ Cabinet		2.00	2.21	
Overall Height:			3.00 ft		

Actual base reactions based upon overages above:

0.1	0.2	0.1	0.2
-----	-----	-----	-----

SUPPORT POLE DESIGN SUMMARY

Base Elev		Section		Axis		Required Strength Values (ASD)		Allowable Strength Values (ASD)		Unity Ratios		Interaction Ratios		Status
f		HSS2X2X1/8		V _r		M _r		V _r		M _r		P _r		
0.00				Strong		0.1		0.2		0.0		0.1		

FOUNDATION DESIGN SUMMARY

Type	Diameter	Width	Thickness	Length	Depth	Volume	Reinforcing	Status	Allowable Soil Pressure
✓ Caisson	1.00	--	--	--	2.25	0.07		OK	300 psf/ft
Vertical Slab									
Spread									

PROJECT: 345 West Duval Street, Lake City, Florida, 32055

DRAWN BY: DEW

CHECKED BY: TSM

COMM. NO. 220149.164

DATE: 09/27/22

DRAWING NO. DWG.

MBI

MBI COMPANIES INC.
299 N. WEISGARBER RD.
KNOXVILLE, TN 37919
PHONE 865.584.0999
SIGN-ENGINEER.COM

TAKE 5

CORP. LLC. # F020000028650
BUS. LLC. # AA26000828
ENG. C.O.A. # 29794

REV # DATE DRAWN BY

3

DARREN S. ANTLE
P.E. LIC # 76913
11/8/23

FRONT ELEVATION

045 - TAKE 5

CAR WASH

345 W Duval St

Loke City, FL 32055



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UL File #E225670

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INITIAL LAYOUT

April 15, 2022

REVISIONS:

I
II
III
IV
V

Sq. Ft. Signage:

58.47

Signage Allowance:

Zoned CG

1.5 Sq. Ft. Per 1 Ft. Linear Lot

Frontage Aggregate

Maximum Sq. Ft.: 525 Sq. Ft. Aggregate

(350 Ft. Lot Frontage)


Minimum Clearance: 9 Ft. from Grade

PAINTING
BY CLIENT/GC PRIOR TO INSTALLATION


Color Key:

- PMS 2191 C
- PMS 7691 C
- PMS 107 C
- PMS 7625 C
- Black
- White

DETAIL

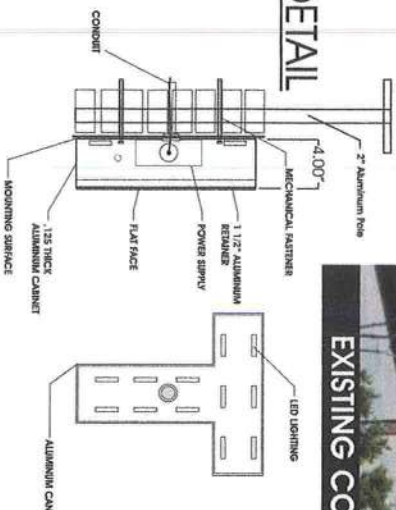

EXISTING CONDITIONS

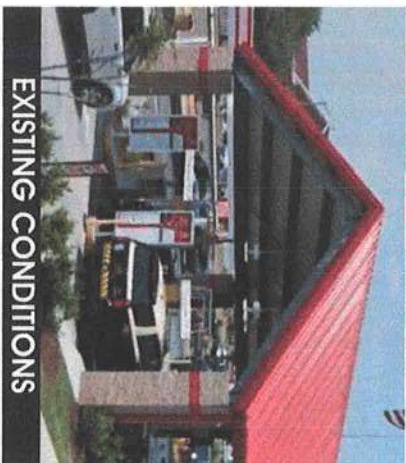

NOTES:

- IF ELECTRICAL LINE/BOX IS WITHIN 6' OF ELECTRICAL, CONNECTION TO BE HANDLED BY INSTALLER.
- IF NOT ELECTRICAL HANDLED BY OWNER/GC
- IF ROOF PENETRATIONS ARE NECESSARY, THEY ARE TO BE SEALED BY A ROOFER. THIS IS HANDLED BY THE GC/OWNER
- REMOVAL AND DISPOSAL OF EXISTING WALL SIGNS HANDLED BY GC/OWNER

IMPOSED IMAGERY



200.00" ESTIMATED RACEWAY LENGTH
310.00" ESTIMATED RACEWAY LENGTH

PROOF



SPECIFICATIONS

ILLUMINATED CHANNEL
LETTERS ON RACEWAYS

Quantity:

See above

Size:

As in drawing

Trim:

1"

Trim Color:

Black

Return Color:

Black

Face Color:

White

Face:

1/8" Acrylic

Letter Interior:

Gloss White

Illumination:

LED

Raceway Size:

4" x 7" 0.125 Extruded Aluminum

Raceway Color:

To Match Facade

Mounting:


Hanging Bars Flush to Facade

SIGNS: UNLIMITED

communicate your identity

Owner/Landlord Approval

6801 Mount Hermon Church Rd, Ste C, Durham, NC 27705 • (P) 919-552-8689 • (F) 919-557-1322

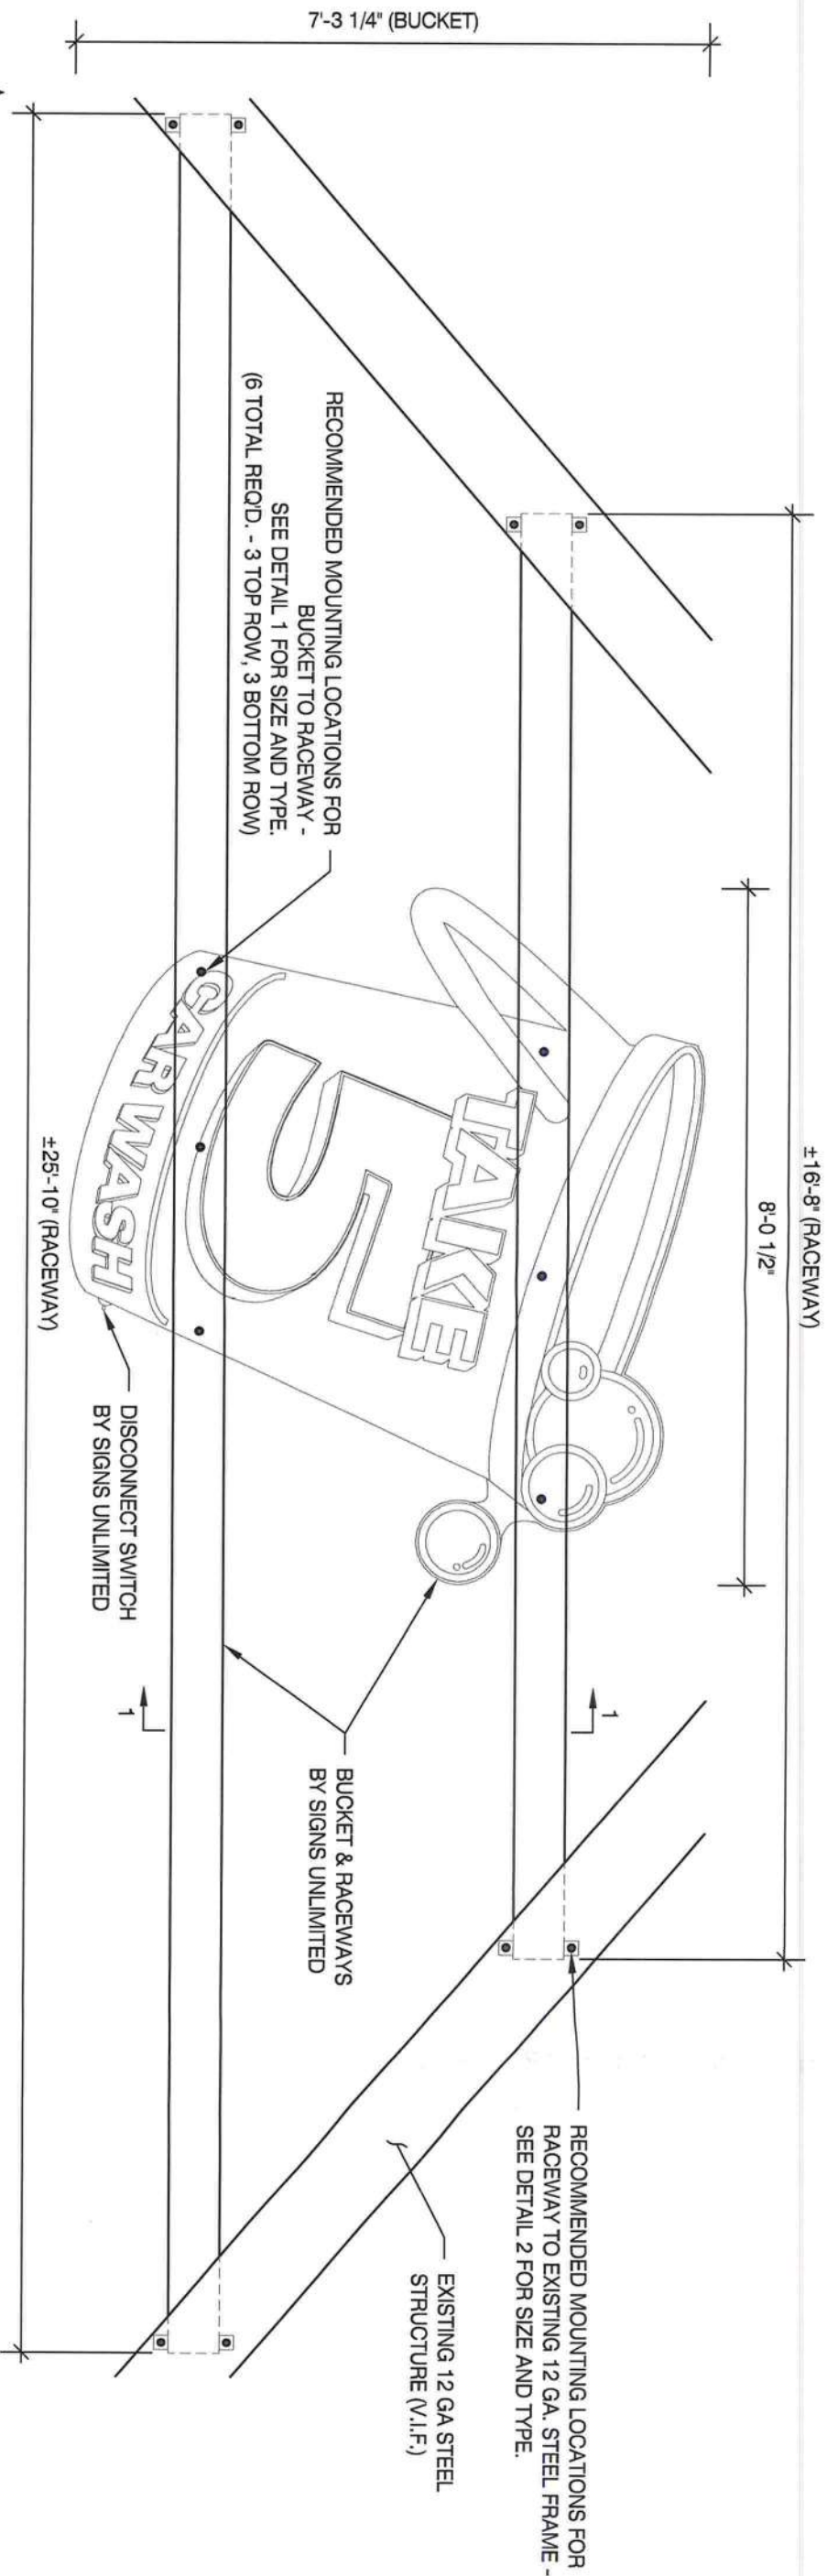

THE SCOPE OF THIS ENGINEERING IS LIMITED TO THE ATTACHMENT OF THE SIGN TO RACEWAY AND RACEWAY TO THE EXISTING STRUCTURE. ALL OTHER ASPECTS ARE EXCLUDED FROM THE SCOPE OF THIS ENGINEERING. BUILDING ENGINEER TO VERIFY ADEQUACY OF THE EXISTING STRUCTURE TO RESIST ADDITIONAL LOADS SHOWN. THIS ENGINEER NOT RESPONSIBLE FOR EXISTING STRUCTURE.

87 1/4" CUSTOM LOGO W/ RACEWAYS - FRONT ELEVATION

SCALE: N.T.S.

A

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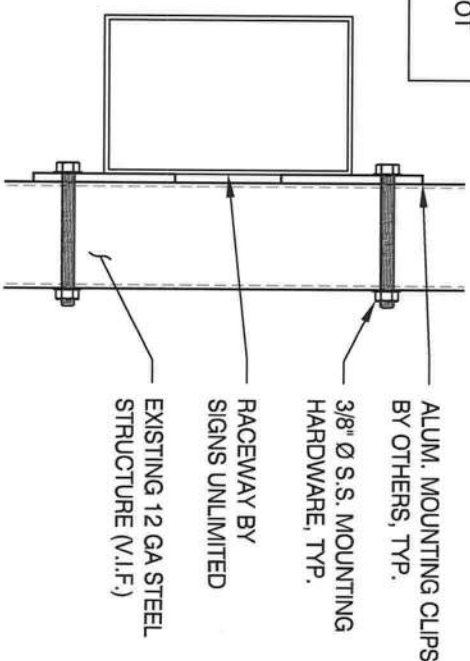
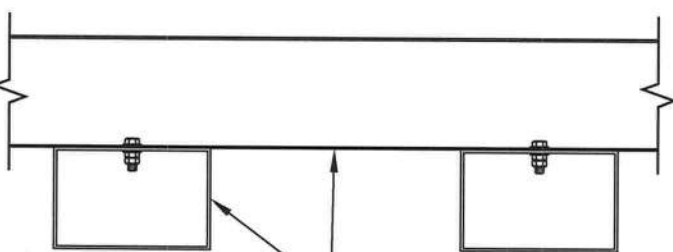
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NOTES

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- * RISK CATEGORY II
- * 120 MPH WIND SPEED, EXP. C

CHANNEL LETTERS & RACEWAY BY SIGNS UNLIMITED



3/8" Ø S.S. BOLT W/ WASHER & NUT (6 REQD.)

SCALE: N.T.S.

1

3/8" Ø S.S. THRU-BOLT W/ WASHER & NUT (4 REQD.)

SCALE: N.T.S.

2

MBI COMPANIES, INC.

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REV # DATE DRAWN BY

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DWG.

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DARREN S. AVTLE
P.E. LIC # 76813

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INITIAL LAYOUT:

April 15, 2022

REVISIONS:

I
II
III
IV
V

Sq. Ft. Signage:

58.47

Signage Allowance:

Zoned CG

1.5 Sq. Ft. Per 1 Ft. Linear Lot

Frontage Aggregate

Maximum Sq. Ft.: 525 Sq. Ft. Aggregate

(350 Ft. Lot Frontage)

Minimum Clearance: 9 Ft. from Grade

PAINTING
BY CLIENT/GC PRIOR TO INSTALLATION

Color Key:

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PMS 7691 C


PMS 107 C

PMS 7625 C

Black

White

DETAIL

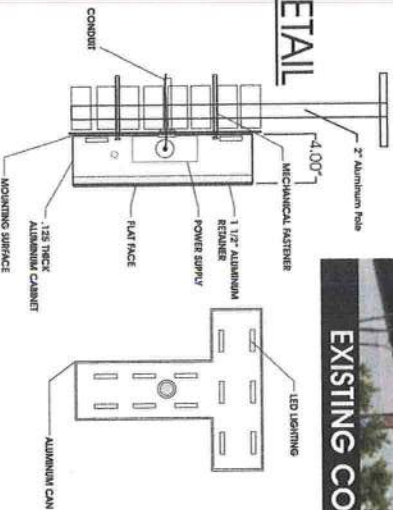

EXISTING CONDITIONS



210.00" Clearance



336.00" EST

420.00" EST

NOTES:

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- REMOVAL AND DISPOSAL OF EXISTING WALL SIGNS HANDLED BY GC/OWNER

Raceway Size:
4" x 7" 0.125 Extruded Aluminum

Raceway Color:

To Match Facade

Mounting:

Hanging Bars Flush to Facade

IMPOSED IMAGERY

SPECIFICATIONS

ILLUMINATED CHANNEL
LETTERS ON RACEWAYS

Quantity:

See above

Size:

As in drawing

Trim:

1"

Trim Color:

Black

Return Color:

Black

Face Color:

White

Face:


1/8" Acrylic

Letter Interior:

Gloss White

Illumination:

LED

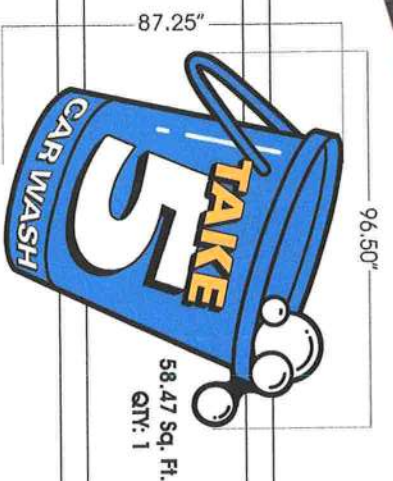

PROOF

72.00"


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SIGNS UNLIMITED

communicate your identity



THE SCOPE OF THIS ENGINEERING IS LIMITED TO THE ATTACHMENT OF THE SIGN TO RACEWAY AND RACEWAY TO THE EXISTING STRUCTURE. ALL OTHER ASPECTS ARE EXCLUDED FROM THE SCOPE OF THIS ENGINEERING. BUILDING ENGINEER TO VERIFY ADEQUACY OF THE EXISTING STRUCTURE TO RESIST ADDITIONAL LOADS SHOWN. THIS ENGINEER NOT RESPONSIBLE FOR EXISTING STRUCTURE.


87 1/4" CUSTOM LOGO W/ RACEWAYS - FRONT ELEVATION
SCALE: N.T.S. (A)

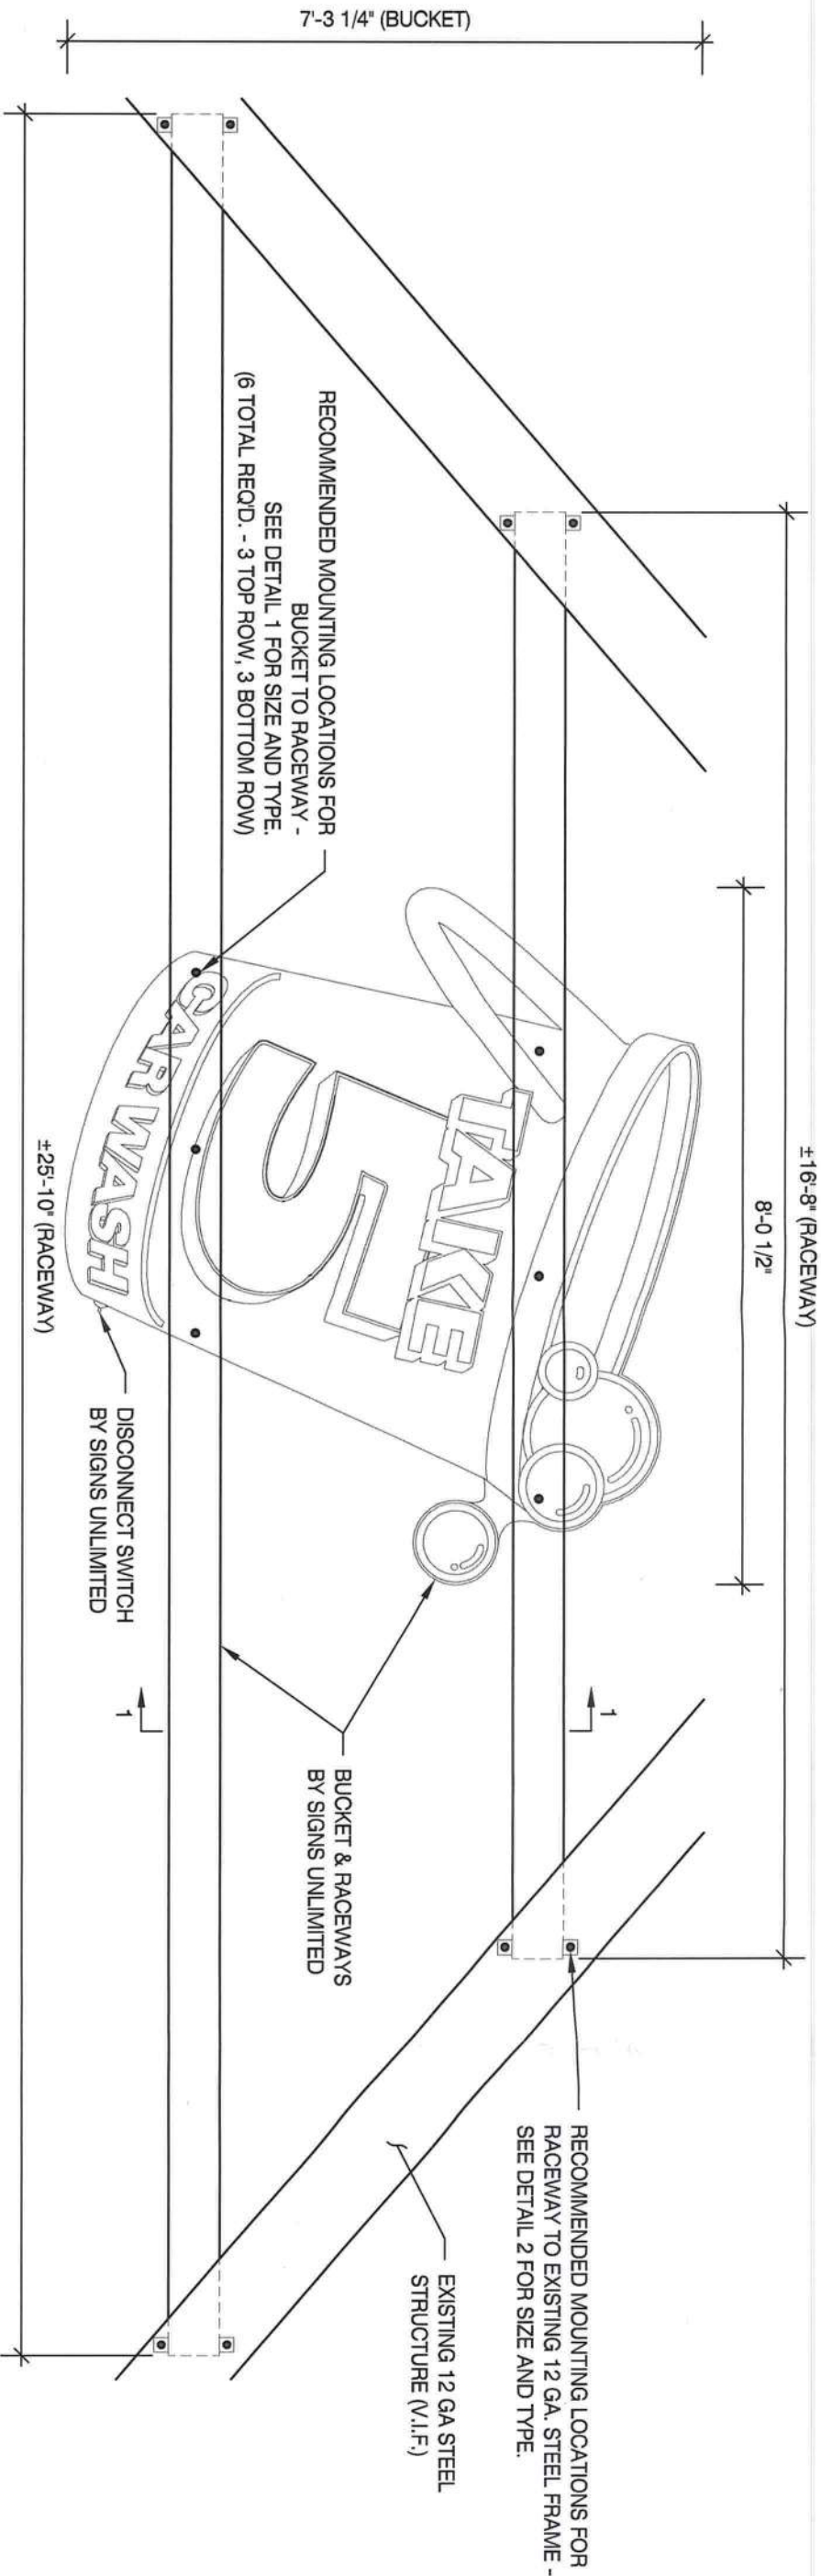CALCULATIONS INCLUDE THE FOLLOWING CONSIDERATIONS AS OUTLINED IN THE 2020 FLORIDA BUILDING CODE (7th ED) :
CHAPTER 16-LOADS AND FORCES
CHAPTER 17-SPECIAL INSPECTIONS
CHAPTER 18-SOILS AND FOUNDATIONS
CHAPTER 19-CONCRETE
CHAPTER 20-ALUMINUM
CHAPTER 21-MASONRY
CHAPTER 22-STEEL
CHAPTER 23-WOOD
ALL SIGNS SHALL BE COMPLIANT WITH CURRENT NEC CODES


NOTES
1.) SEE MANUFACTURERS DRAWINGS FOR ADDITIONAL DETAILS AND DIMENSIONS.

- * CLIENT - SIGNS UNLIMITED
- * 2020 FLORIDA BUILDING CODE 7TH ED.
- * RISK CATEGORY II
- * 120 MPH WIND SPEED, EXP. C

3/8" Ø S.S. BOLT W/ WASHER & NUT (6 REQD.)
SCALE: N.T.S. (DUAL RACEWAY) 1

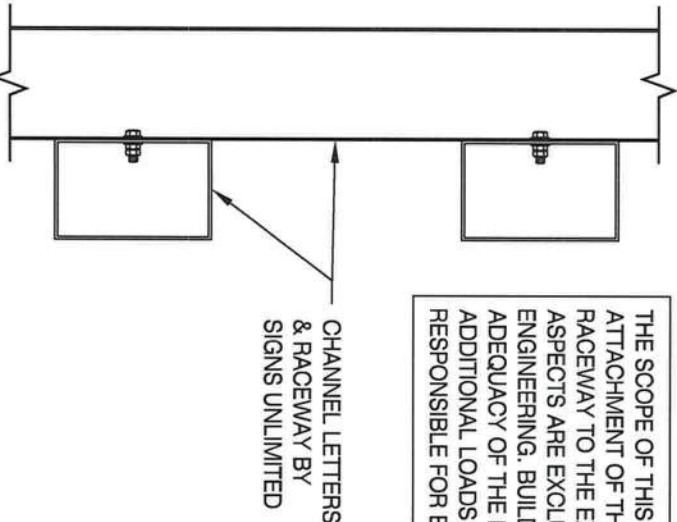

3/8" Ø S.S. THRU-BOLT W/ WASHER & NUT (4 REQD.)
SCALE: N.T.S. 2

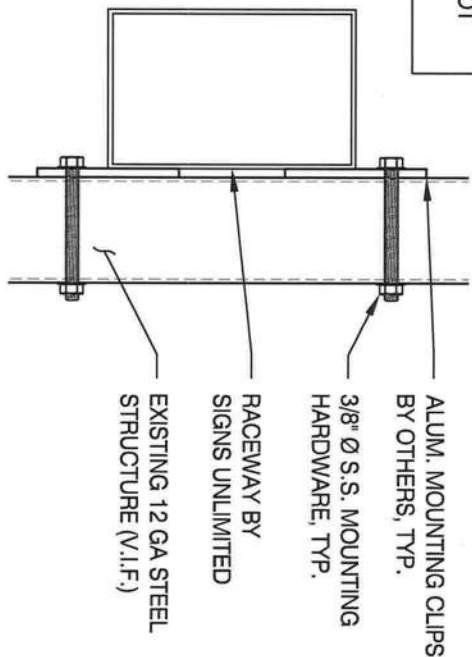

MBI

MBI COMPANIES, INC.
299 N. WEISGARBER RD.
KNOXVILLE, TN 37919
PHONE 865.584.0999
SIGN-ENGINEER.COM

PROJECT:
345 West Duval Street, Lake City, Florida, 32055
DRAWING TITLE:

TAKE 5

DRAWN BY: DEW
CHECKED BY: TSM
COMM. NO. 220149.164

CORP. LLC. # F02000002650
BUS. LLC. # AA26000828
ENG. C.O.A. # 29794

DATE: 09/27/22

REV # DATE DRAWN BY

DRAWING NO. DWG. 1

STATE OF FLORIDA
No. 76813
DARREN S. ANTLE
P.E. LIC # 76813
09/27/22