
# **COLUMBIA** COUNTY

# LAKE JEFFERY ROAD FIRE STATION **EXPANSION** COLUMBIA COUNTY, FLORIDA

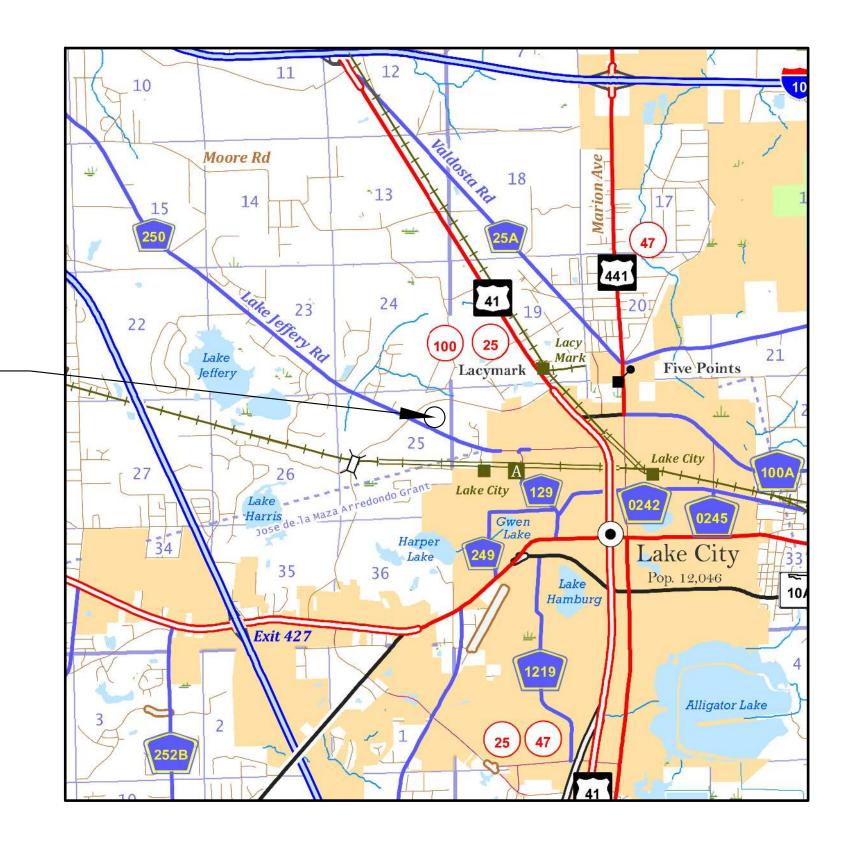

# SHEET INDEX

COVER SHEET	C-1
SIGNATURE SHEET	<b>C-2</b>
GENERAL NOTES	<b>C-3</b>
SITE PLAN	<b>C-4</b>
GRADING PLAN	<b>C-5</b>
SWMF	<b>C-6</b>
SWMF DETAILS	<b>C-7</b>
UTILITIES PLAN	<b>C-8</b>
<b>EROSION CONTROL PLAN</b>	<b>C-9</b>
<b>EROSION CONTROL NOTES &amp; DETAILS</b>	C-10
UTILITIES DETAILS	C-11
MISC DETAILS	C-12 - C-13
SUMMARY OF QUANTITIES	C-14

# **ATTACHMENTS**

NOTE: FOR INFORMATION PURPOSES ONLY

**FLOOR PLAN A-1** 

#### **GOVERNING CRITERIA:**

Florida Department of Transportation; Manual of Uniform Minimum Standards for Design, Construction and Maintenance for Streets and Highways (2018 Edition)

#### **GOVERNING STANDARD PLANS:**

Florida Department of Transportation, FY 2024-25 Standard Plans for Road and Bridge Construction and applicable Interim Revisions (Irs).

Standard Plans for Road Construction and associated Irs are available at the following website:

http://www.fdot.gov/design/Standardplans.shtm

APPLICABLE IRs:

Standard Plans for Bridge Construction are included in the Structures Plans Component.

#### **GOVERNING STANDARD SPECIFICATIONS:**

Florida Department of Transportation, July, 2020 Standard Specifications for Road and Bridge Construction are available at the following website:

http://www.fdot.gov/programmanagement/Implemented/SpecBooks

## PLANS PREPARED FOR:

COLUMBIA COUNTY BOCC 135 NE HERNANDO AVENUE, SUITE 203 LAKE CITY, FL 32055 386-758-1005

REVISIONS
DESCRIPTION



PROJECT LOCATION

P.O. BOX 3823 LAKE CITY, FL 32056 PH. 386-752-4675 **LIC NO. LB8356** 

NORTH FLORIDA PROFESSIONAL SERVICES, INC. 2551 BLAIRSTONE PINES DR. TALLAHASSEE, FL 32301 WWW.NFPS.NET CA# 29011

**JOB NUMBER:** L150209CCB EOR: RYAN D. ASMUS P.E. NO.: 66626

# **COVER SHEET**


SHEET

C-1

Keegan Renick

10/14/2024 4:33:02 PM

X:\2015\L150209CCB\H.CADD(FS51)\Roadway\KEYSRD\_FS51\_01.dwg

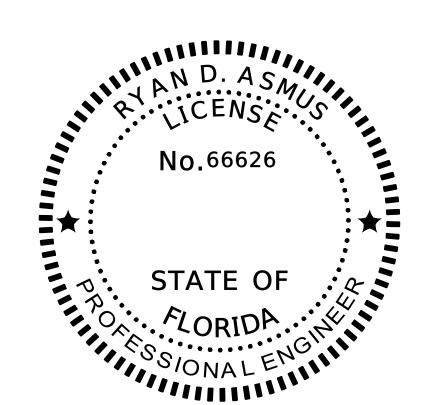

# Ryan D Asmus O=NORTH FLORIDA PROFESSIONAL SERVICES INC., C=US Date: 2025.01.15 11:48:24-05'00'

THIS ITEM HAS BEEN DIGITALLY SIGNED AND SEALED BY RYAN D. ASMUS ON THE DATE ADJACENT TO THE SEAL.

PRINTED COPIES OF THIS DOCUMENT ARE NOT CONSIDERED SIGNED AND SEALED AND THE SIGNATURE MUST BE VERIFIED ON ANY ELECTRONIC COPIES.

NORTH FLORIDA PROFESSIONAL SERVICES INC. P.O. BOX 3823 LAKE CITY, FL 32056 CERTIFICATE OF AUTHORIZATION: 29011

RYAN D. ASMUS, P.E. NO. 66626

THE ABOVE NAMED PROFESSIONAL ENGINEER SHALL BE RESPONSIBLE FOR THE FOLLOWING SHEETS IN ACCORDANCE WITH RULE 61G15-23.004, F.A.C.

# SHEET INDEX

COVER SHEET	C-1
SIGNATURE SHEET	<b>C-2</b>
GENERAL NOTES	<b>C-3</b>
SITE PLAN	<b>C-4</b>
GRADING PLAN	C-5
SWMF	C-6
SWMF DETAILS	<b>C-7</b>
UTILITIES PLAN	<b>C-8</b>
<b>EROSION CONTROL PLAN</b>	<b>C-9</b>
<b>EROSION CONTROL NOTES &amp; DETAILS</b>	C-10
UTILITIES DETAILS	C-11
MISC DETAILS	C-12 - C-13
SUMMARY OF QUANTITIES	C-14

	REVISIONS	
DATE	DESCRIPTION	]
		,



NORTH FLORIDA PROFESSIONAL SERVICES, INC.

P.O. BOX 3823

2551 BLAIRSTONE BINES DR

P.O. BOX 3823 LAKE CITY, FL 32056 PH. 386-752-4675 LIC NO. LB8356 2551 BLAIRSTONE PINES DR.
TALLAHASSEE, FL 32301
WWW.NFPS.NET
CA# 29011

JOB NUMBER: L150209CCB EOR: RYAN D. ASMUS P.E. NO.:

# SIGNATURE SHEET

LAKE JEFFERY ROAD FIRE STATION EXPANSION COLUMBIA COUNTY, FLORIDA

NO. C-2

SHEET

#### GENERAL NOTES

- 1. THE CONTRACTOR SHALL VERIFY ALL EXISTING CONDITIONS AND DIMENSIONS AT THE JOB SITE TO ENSURE THAT ALL NEW WORK WILL FIT IN THE MANNER INTENDED ON THE PLANS. SHOULD ANY CONDITIONS EXIST THAT ARE CONTRARY TO THOSE SHOWN ON THE PLANS, THE CONTRACTOR SHALL NOTIFY THE ENGINEER AND THE COLUMBIA COUNTY, FLORIDA (BUILDING DEPARTMENT) OF SUCH DIFFERENCES IMMEDIATELY AND PRIOR TO PROCEEDING WITH THE WORK.
- 2. THE CONTRACTOR SHALL COMPLY WITH ALL CONDITIONS AS SET FORTH BY THE ISSUED FLORIDA DEPARTMENT OF ENVIRONMENTAL PROTECTION 10/2 SELF-CERTIFICATION.
- 3. THE CONTRACTOR SHALL MAINTAIN THE CONSTRUCTION SITE IN A SECURE MANNER. ALL OPEN TRENCHES AND EXCAVATED AREAS SHALL BE PROTECTED FROM ACCESS BY THE GENERAL PUBLIC.
- 4. ANY PUBLIC LAND CORNER WITHIN THE LIMITS OF CONSTRUCTION SHALL BE PROTECTED. IF A CORNER MONUMENT IS IN DANGER OF BEING DESTROYED AND HAS NOT BEEN PROPERLY REFERENCED, THE CONTRACTOR SHOULD NOTIFY THE ENGINEER.
- 5. THE SITE IS LOCATED IN SECTION 25, TOWNSHIP 3 SOUTH, RANGE 16 EAST, COLUMBIA COUNTY, FLORIDA.
- 6. THE CONTRACTOR SHALL IMPLEMENT ALL COMPONENTS OF THE EROSION AND SEDIMENTATION CONTROL PLAN PRIOR TO ANY EARTH DISTURBING ACTIVITIES. ALL COMPONENTS SHALL BE MAINTAINED BY THE CONTRACTOR UNTIL ALL VEGETATION IS ESTABLISHED, THE ENTIRE PROJECT AREA IS STABILIZED AND THE OWNER HAS ACCEPTED OPERATION AND MAINTENANCE.
- 7. ALL SLOPES OF THE STORMWATER BASIN SHALL BE GRASSED. ALL SLOPES STEEPER THAN 3:1 SHALL BE STAPLED SOD.
- 8. ALL DISTURBED AREAS NOT SODDED SHALL BE SEEDED WITH A MIXTURE OF LONG-TERM VEGETATION AND QUICK GROWING SHORT-TERM VEGETATION FOR THE FOLLOWING CONDITIONS. FOR THE MONTHS FROM SEPTEMBER THROUGH MARCH, THE MIX SHALL CONSIST OF 70 POUNDS PER ACRE OF LONG-TERM SEED AND 20 POUNDS PER ACRE OF WINTER RYE. FOR THE MONTHS OF APRIL THROUGH AUGUST, THE MIX SHALL CONSIST OF 70 PER ACRE OF LONG-TERM SEED AND 20 POUNDS PER ACRE OF MILLET.
- 9. THE LOCATION OF THE UTILITIES SHOWN IN THE PLANS ARE APPROXIMATE ONLY. THE EXACT LOCATION SHALL BE DETERMINED BY THE CONTRACTOR DURING CONSTRUCTION. CONTRACTOR SHALL PROTECT ALL UTILITIES WITHIN THE PROJECT AREAS.
- 10. ALL SITE CONSTRUCTION SHALL BE IN ACCORDANCE WITH THE COLUMBIA COUNTY LAND DEVELOPMENT REGULATIONS.
- 11. CONTRACTOR SHALL COORDINATE ALL WORK WITH OTHER CONTRACTORS WITHIN PROJECT AREA.
- 12. IF UNSUITABLE MATERIAL IS ENCOUNTERED DURING GRADING, CONTRACTOR SHALL REMOVE UNSUITABLE MATERIAL TO A DEPTH OF 24" BELOW FINISHED GRADE WITHIN THE CONSTRUCTION LIMITS.
- 13. THE CONTRACTOR SHALL NOTIFY THE COUNTY AT LEAST 48 HOURS PRIOR TO BEGINNING OF CONSTRUCTION.
- 14. THE CONTRACTOR SHALL NOTIFY THE COUNTY AT LEAST 48 HOURS IN ADVANCE OF THE PRESSURE AND LEAKAGE TESTS.
- 15. NO FINAL TESTING OR PRESSURE TESTING WILL BE ACCEPTED UNLESS WITNESSED BY THE COUNTIES REPRESENTATIVE.
- 16. NO WORK SHALL BE PERFORMED ON SATURDAY OR SUNDAY WITHOUT WRITTEN NOTIFICATION TO THE COUNTY AND COUNTY ENGINEER.
- 17. CONTRACTOR SHALL PROVIDE AN AS-BUILT SURVEY MEETING THE REQUIREMENTS OF CHAPTER 61G17 F.A.C. FOR THE STORMWATER MANAGEMENT SYSTEMS. INCLUDE HORIZONTAL AND VERTICAL DIMENSIONAL DATA SO THAT IMPROVEMENTS ARE LOCATED AND DELINEATED RELATIVE TO THE BOUNDARY. THIS AS-BUILT SURVEY SHOULD INCLUDE ALL OUTFALL STRUCTURES. PROVIDE SUFFICIENT DETAILED DATA TO DETERMINE WHETHER THE IMPROVEMENTS WERE CONSTRUCTED IN ACCORDANCE WITH THE PLANS. A COPY OF THE AS-BUILT SURVEY (IN PAPER AND DIGITAL AUTOCAD

FORMAT) MUST BE SUBMITTED TO THE COLUMBIA COUNTY, FLORIDA (BUILDING DEPARTMENT) AND THE ENGINEER.

- 18. THE CONTRACTOR SHALL SUBMIT A NATIONAL POLLUTANT DISCHARGE ELIMINATION SYSTEM NOTICE OF INTENT ALONG WITH SUPPORTING DOCUMENTATION TO THE FLORIDA DEPARTMENT OF ENVIRONMENTAL PROTECTION AT LEAST 48 HOURS PRIOR TO BEGINNING OF CONSTRUCTION. THE CONTRACTOR SHALL BE RESPONSIBLE FOR ALL PERMIT FEES.
- 19. IF DURING CONSTRUCTION OR OPERATION OF THE STORM WATER MANAGEMENT SYSTEM, A STRUCTURAL FAILURE IS OBSERVED THAT HAS THE POTENTIAL TO CAUSE THE DIRECT DISCHARGE OF SURFACE WATER INTO THE FLORIDAN AQUIFER SYSTEM, CORRECTIVE ACTIONS DESIGNED OR APPROVED BY A REGISTERED PROFESSIONAL SHALL BE TAKEN AS SOON AS PRACTICAL TO CORRECT THE FAILURE. SEE KARST REPAIR DETAIL #E23. IN ADDITION, A REPORT PREPARED BY A REGISTERED PROFESSIONAL MUST BE PROVIDED AS SOON AS PRACTICAL TO THE DEPARTMENT FOR REVIEW AND APPROVAL THAT PROVIDES REASONABLE ASSURANCE THAT THE BREACH WILL BE PERMANENTLY CORRECTED.
- 20. ALL CONCRETE SLABS ABUTTING EXTERIOR WALLS SHALL BE SOIL TREATED FOR TERMITES.
- 21. ALL UTILITY AND/OR DRAINAGE STRUCTURES SHALL BE PRECAST UNLESS APPROVED BY THE ENGINEER. CONTRACTOR SHALL SUBMIT SHOP DRAWINGS FOR APPROVAL PRIOR TO PROCUREMENT.

C-3

THIS ITEM HAS BEEN DIGITALLY SIGNI
PRINTED COPIES OF THIS DOCUMENT

	REVISIONS	, принининини.	NORTH ELORIDA DI	DOFFCCIONAL CEDVICES INC
DATE	DESCRIPTION	June 1 HFL ON THE	NORTH FLURIDA PI	ROFESSIONAL SERVICES, INC.
			P.O. BOX 3823	2551 BLAIRSTONE PINES DR.
		NFPS I	LAKE CITY, FL 32056	TALLAHASSEE, FL 32301
			PH. 386-752-4675	WWW.NFPS.NET
		III JOONAL SER WILLIAM TO THE WAY TO TO THE WA		
		The state of the s	LIC NO. LB8356	CA# 29011

JOB NUMBER: L150209CCB EOR: RYAN D. ASMUS P.E. NO.:


66626


GENERAL NOTES


LAKE JEFFERY ROAD FIRE STATION EXPANSION

COLUMBIA COUNTY, FLORIDA


NSION C-3

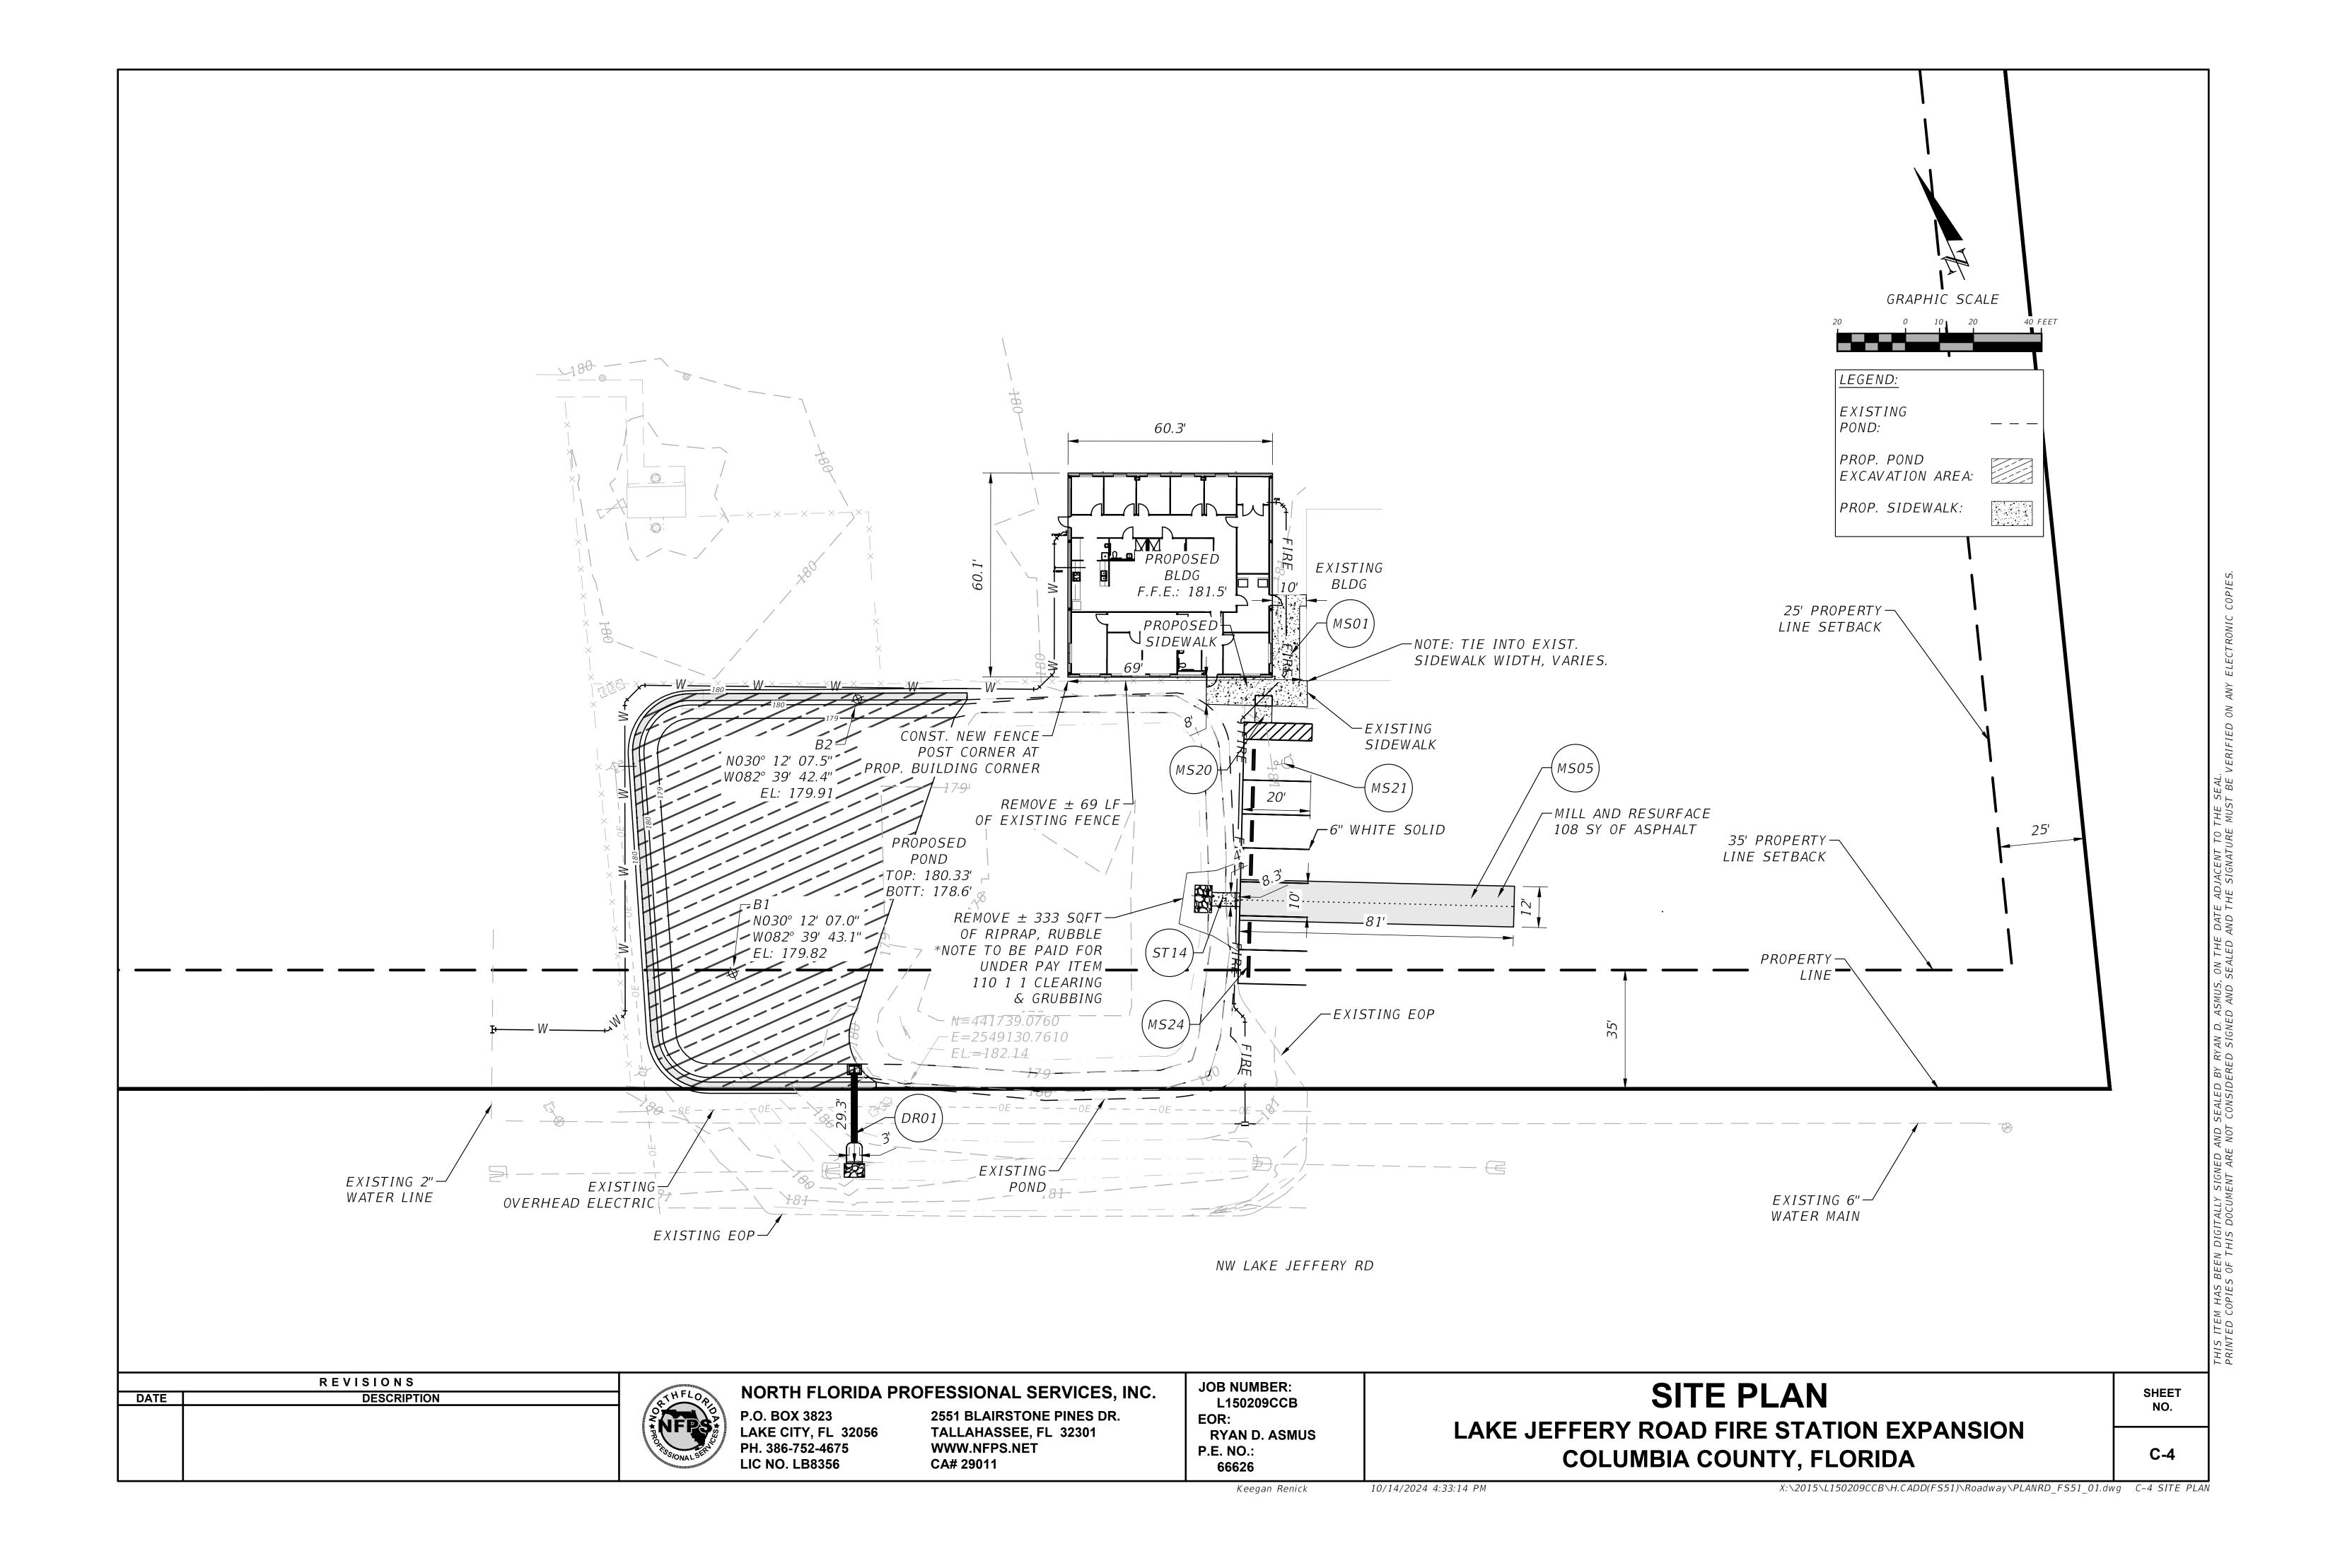

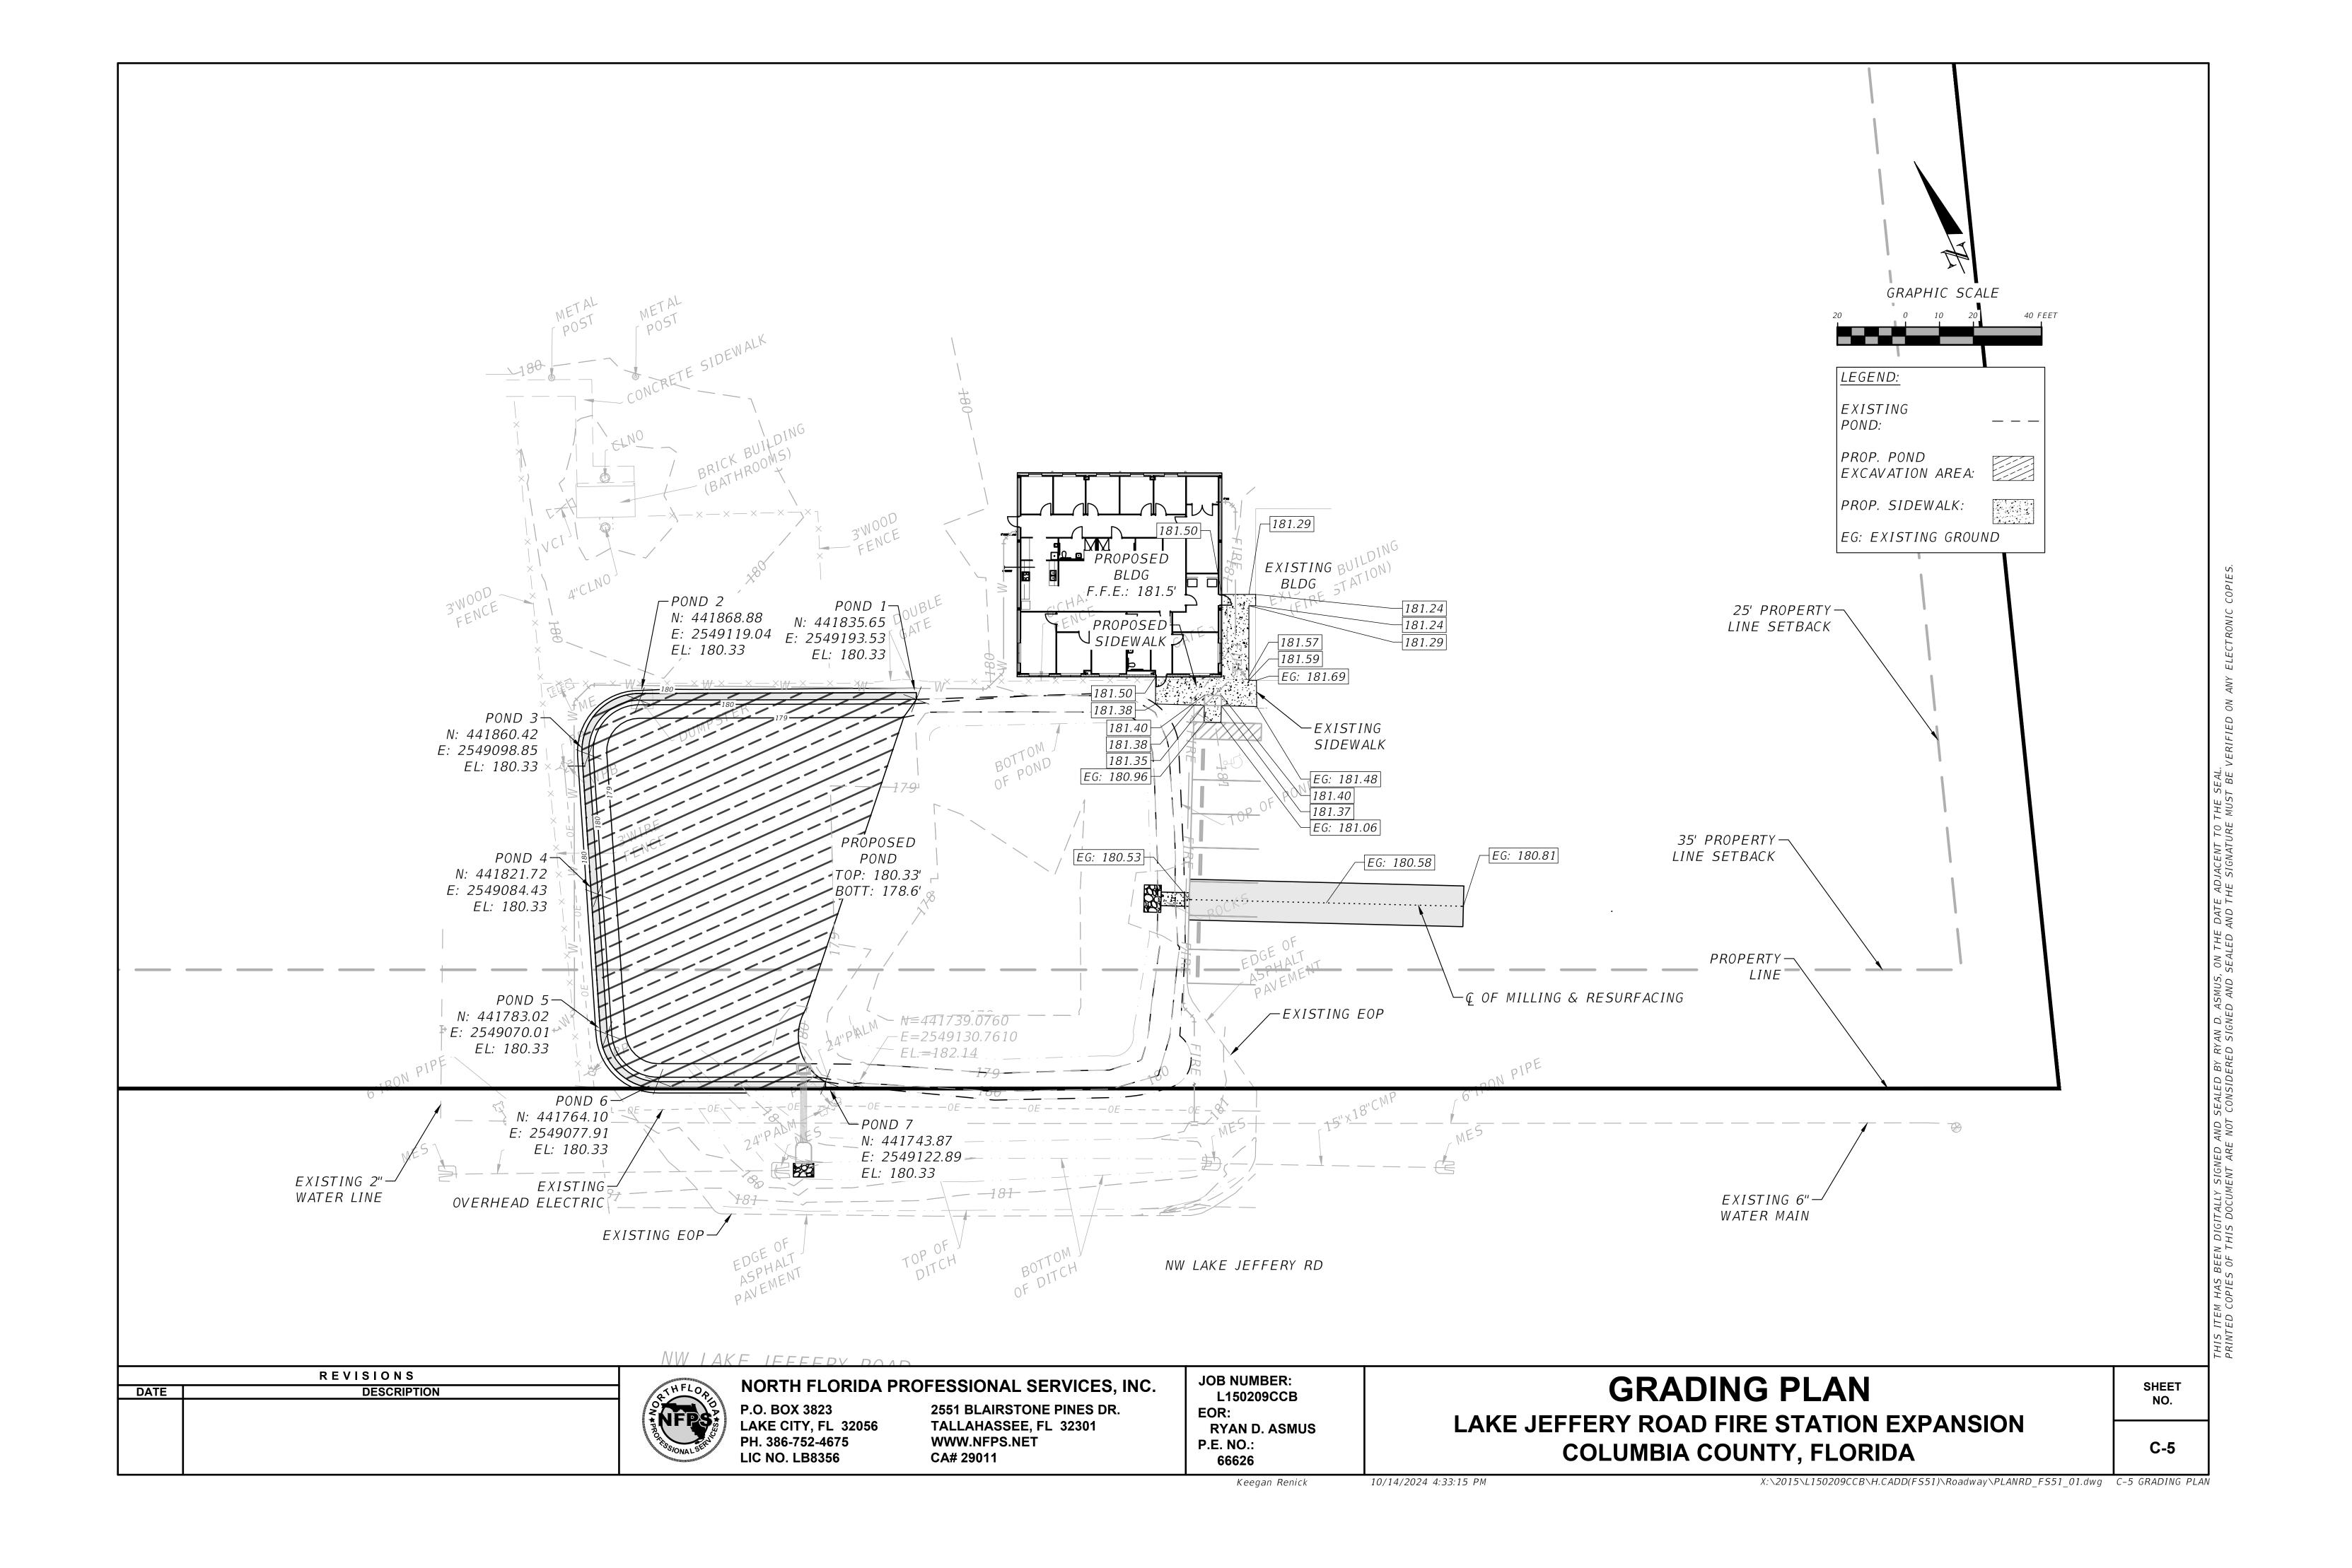

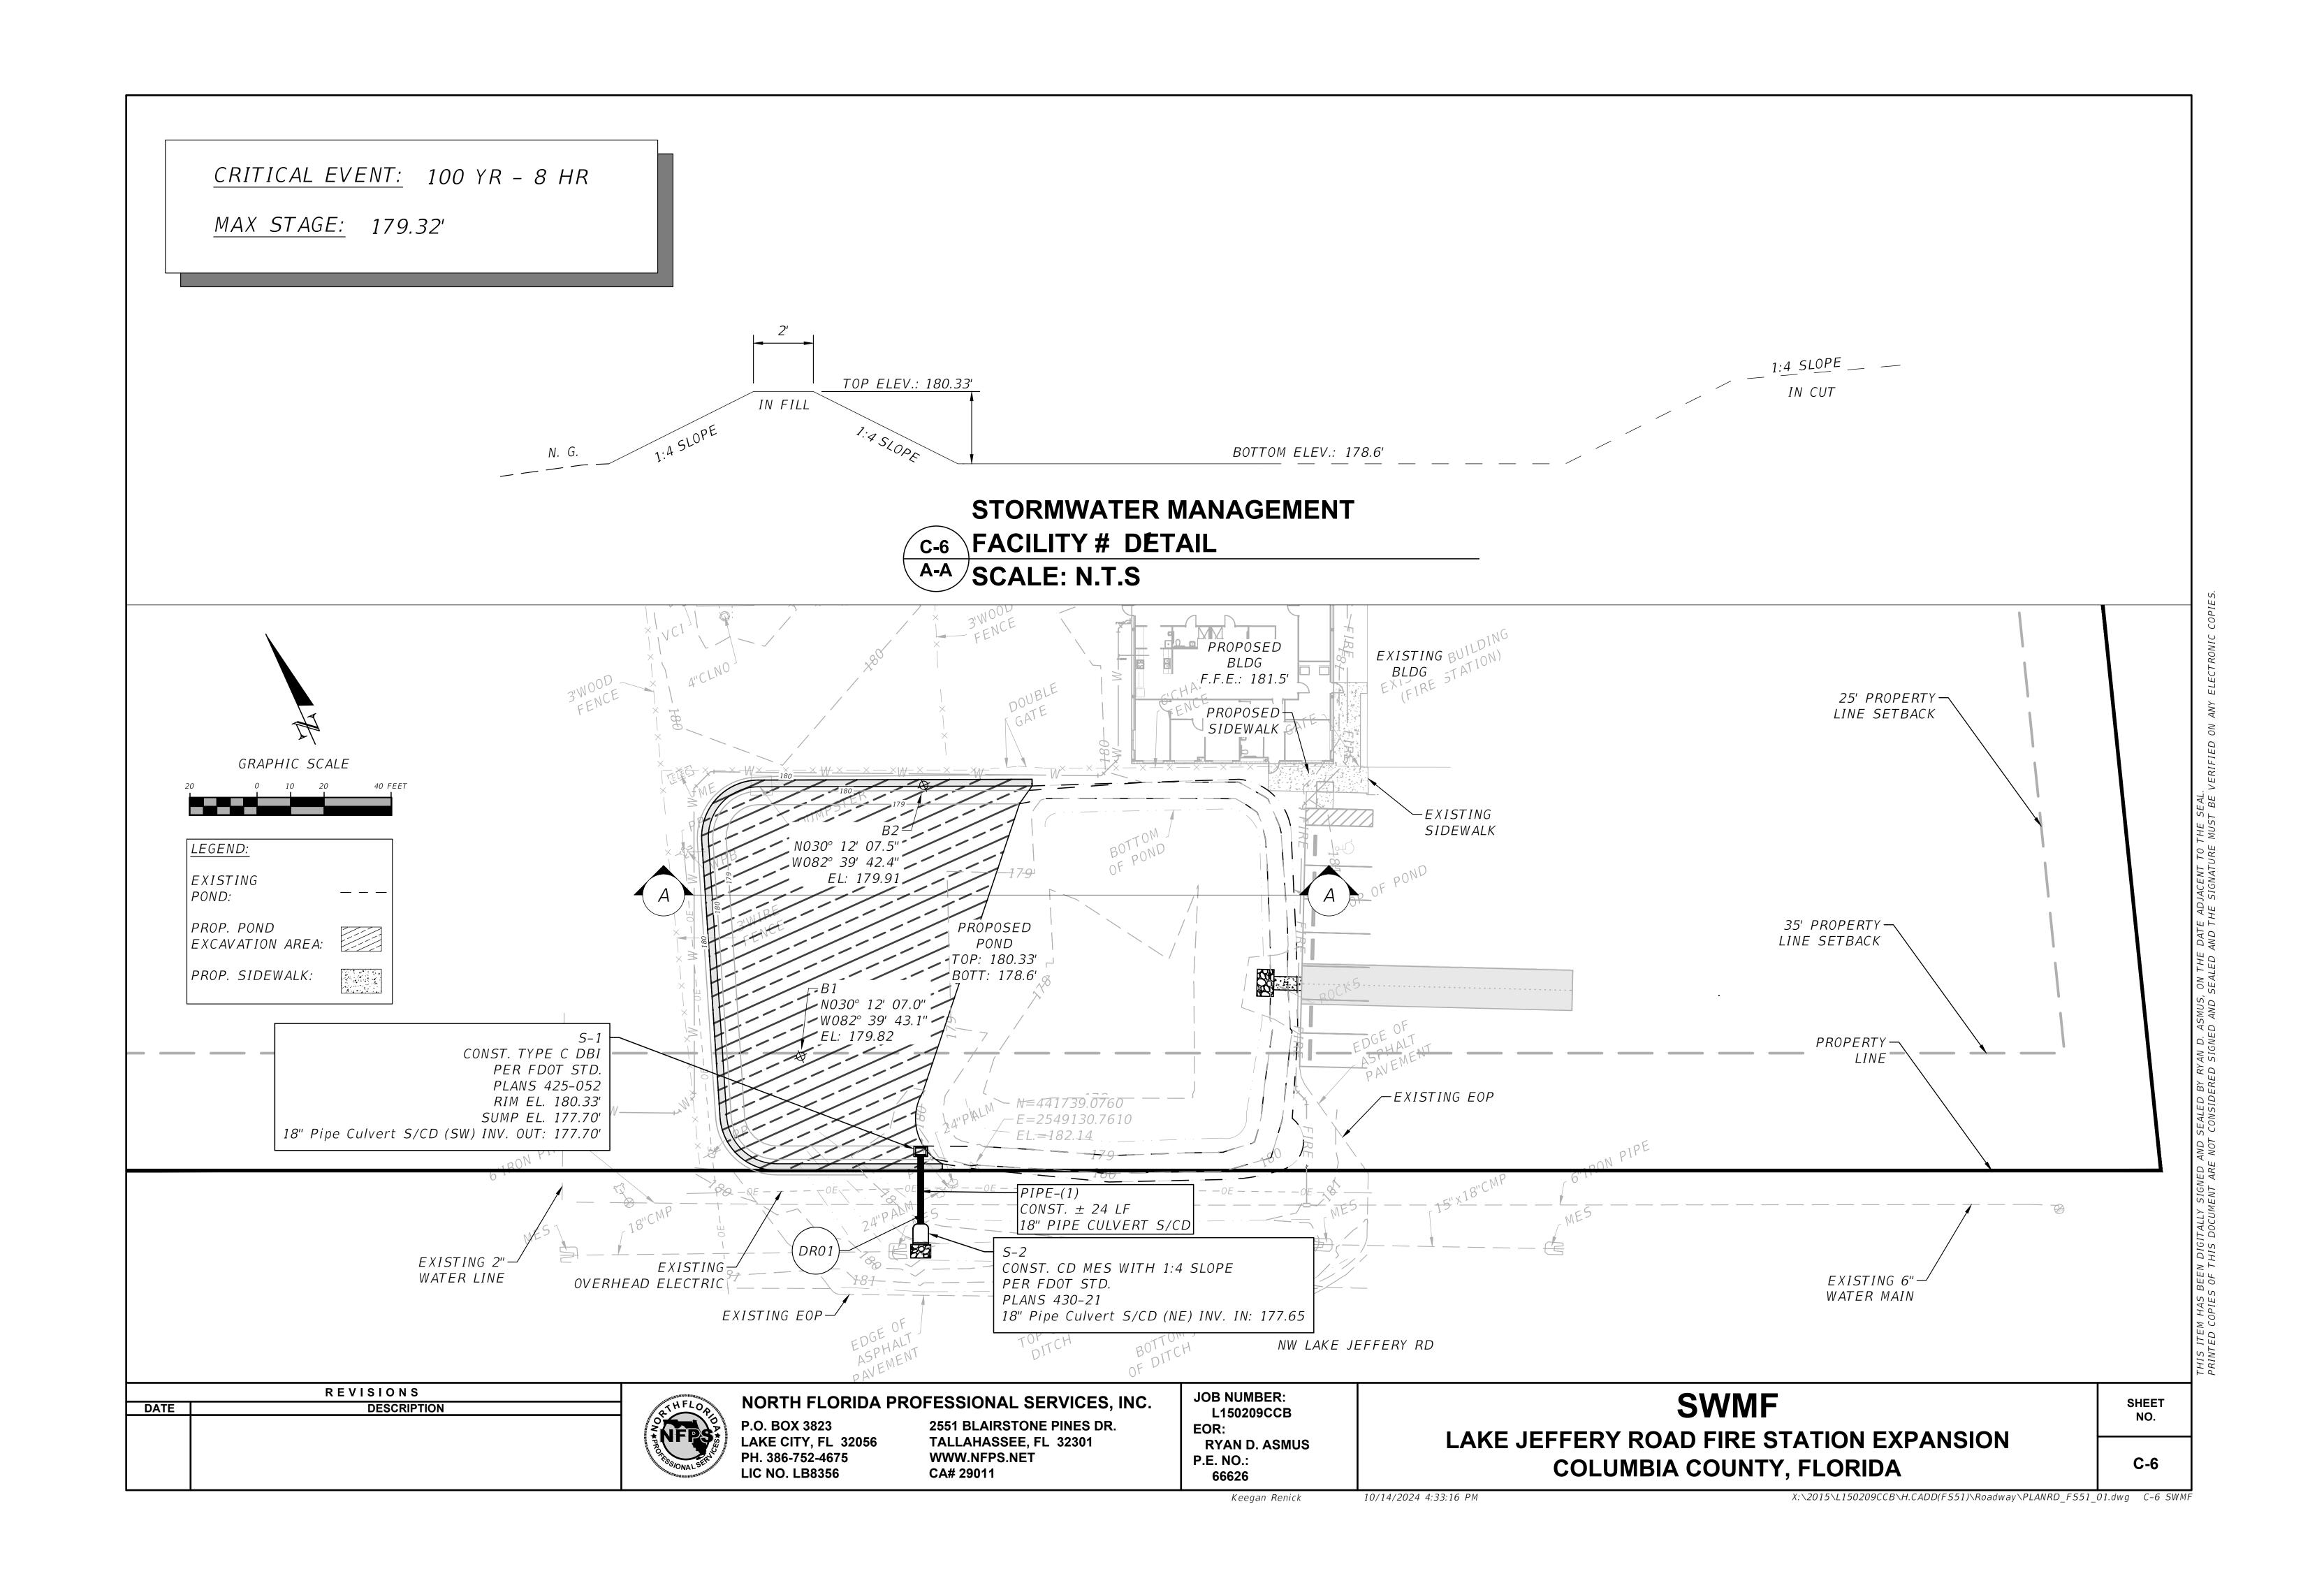

## TYPE C DBI

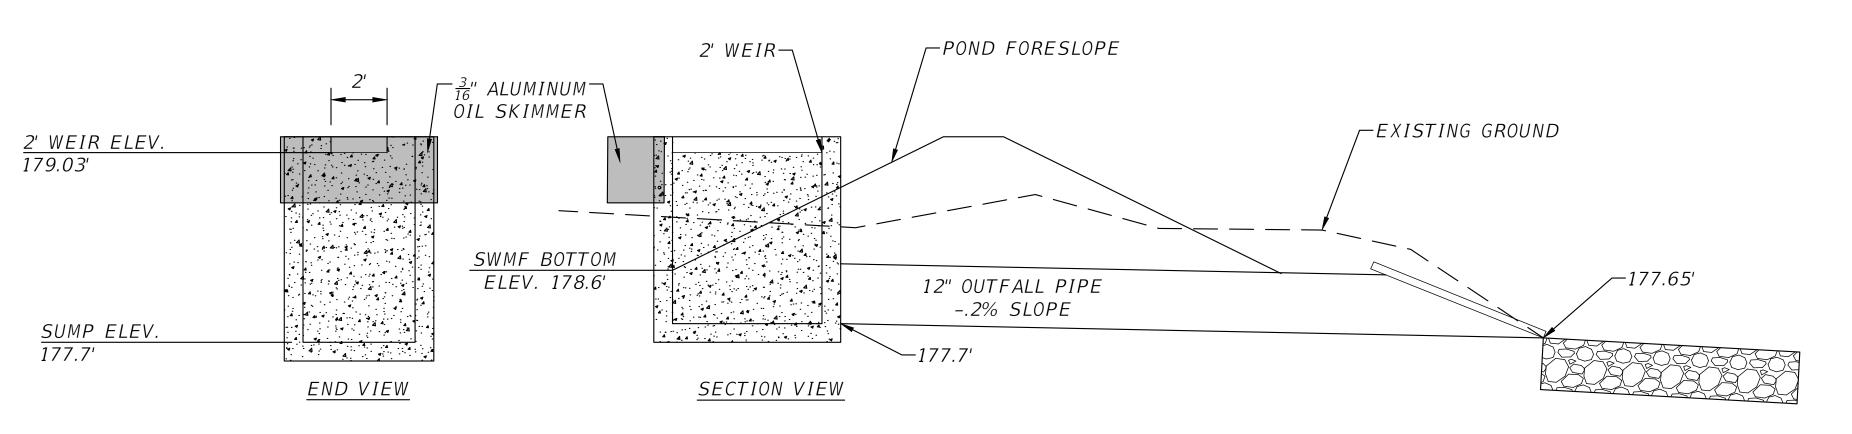

SWMF #1 CONTROL STRUCTURE DETAIL SCALE: N.T.S.

REVISIONS DESCRIPTION DATE



P.O. BOX 3823

NORTH FLORIDA PROFESSIONAL SERVICES, INC. 2551 BLAIRSTONE PINES DR. LAKE CITY, FL 32056 PH. 386-752-4675 LIC NO. LB8356 TALLAHASSEE, FL 32301 WWW.NFPS.NET CA# 29011


JOB NUMBER: L150209CCB EOR: RYAN D. ASMUS P.E. NO.:


Keegan Renick

**SWMF DETAILS** LAKE JEFFERY ROAD FIRE STATION EXPANSION COLUMBIA COUNTY, FLORIDA

SHEET NO. C-7


10/14/2024 4:33:16 PM

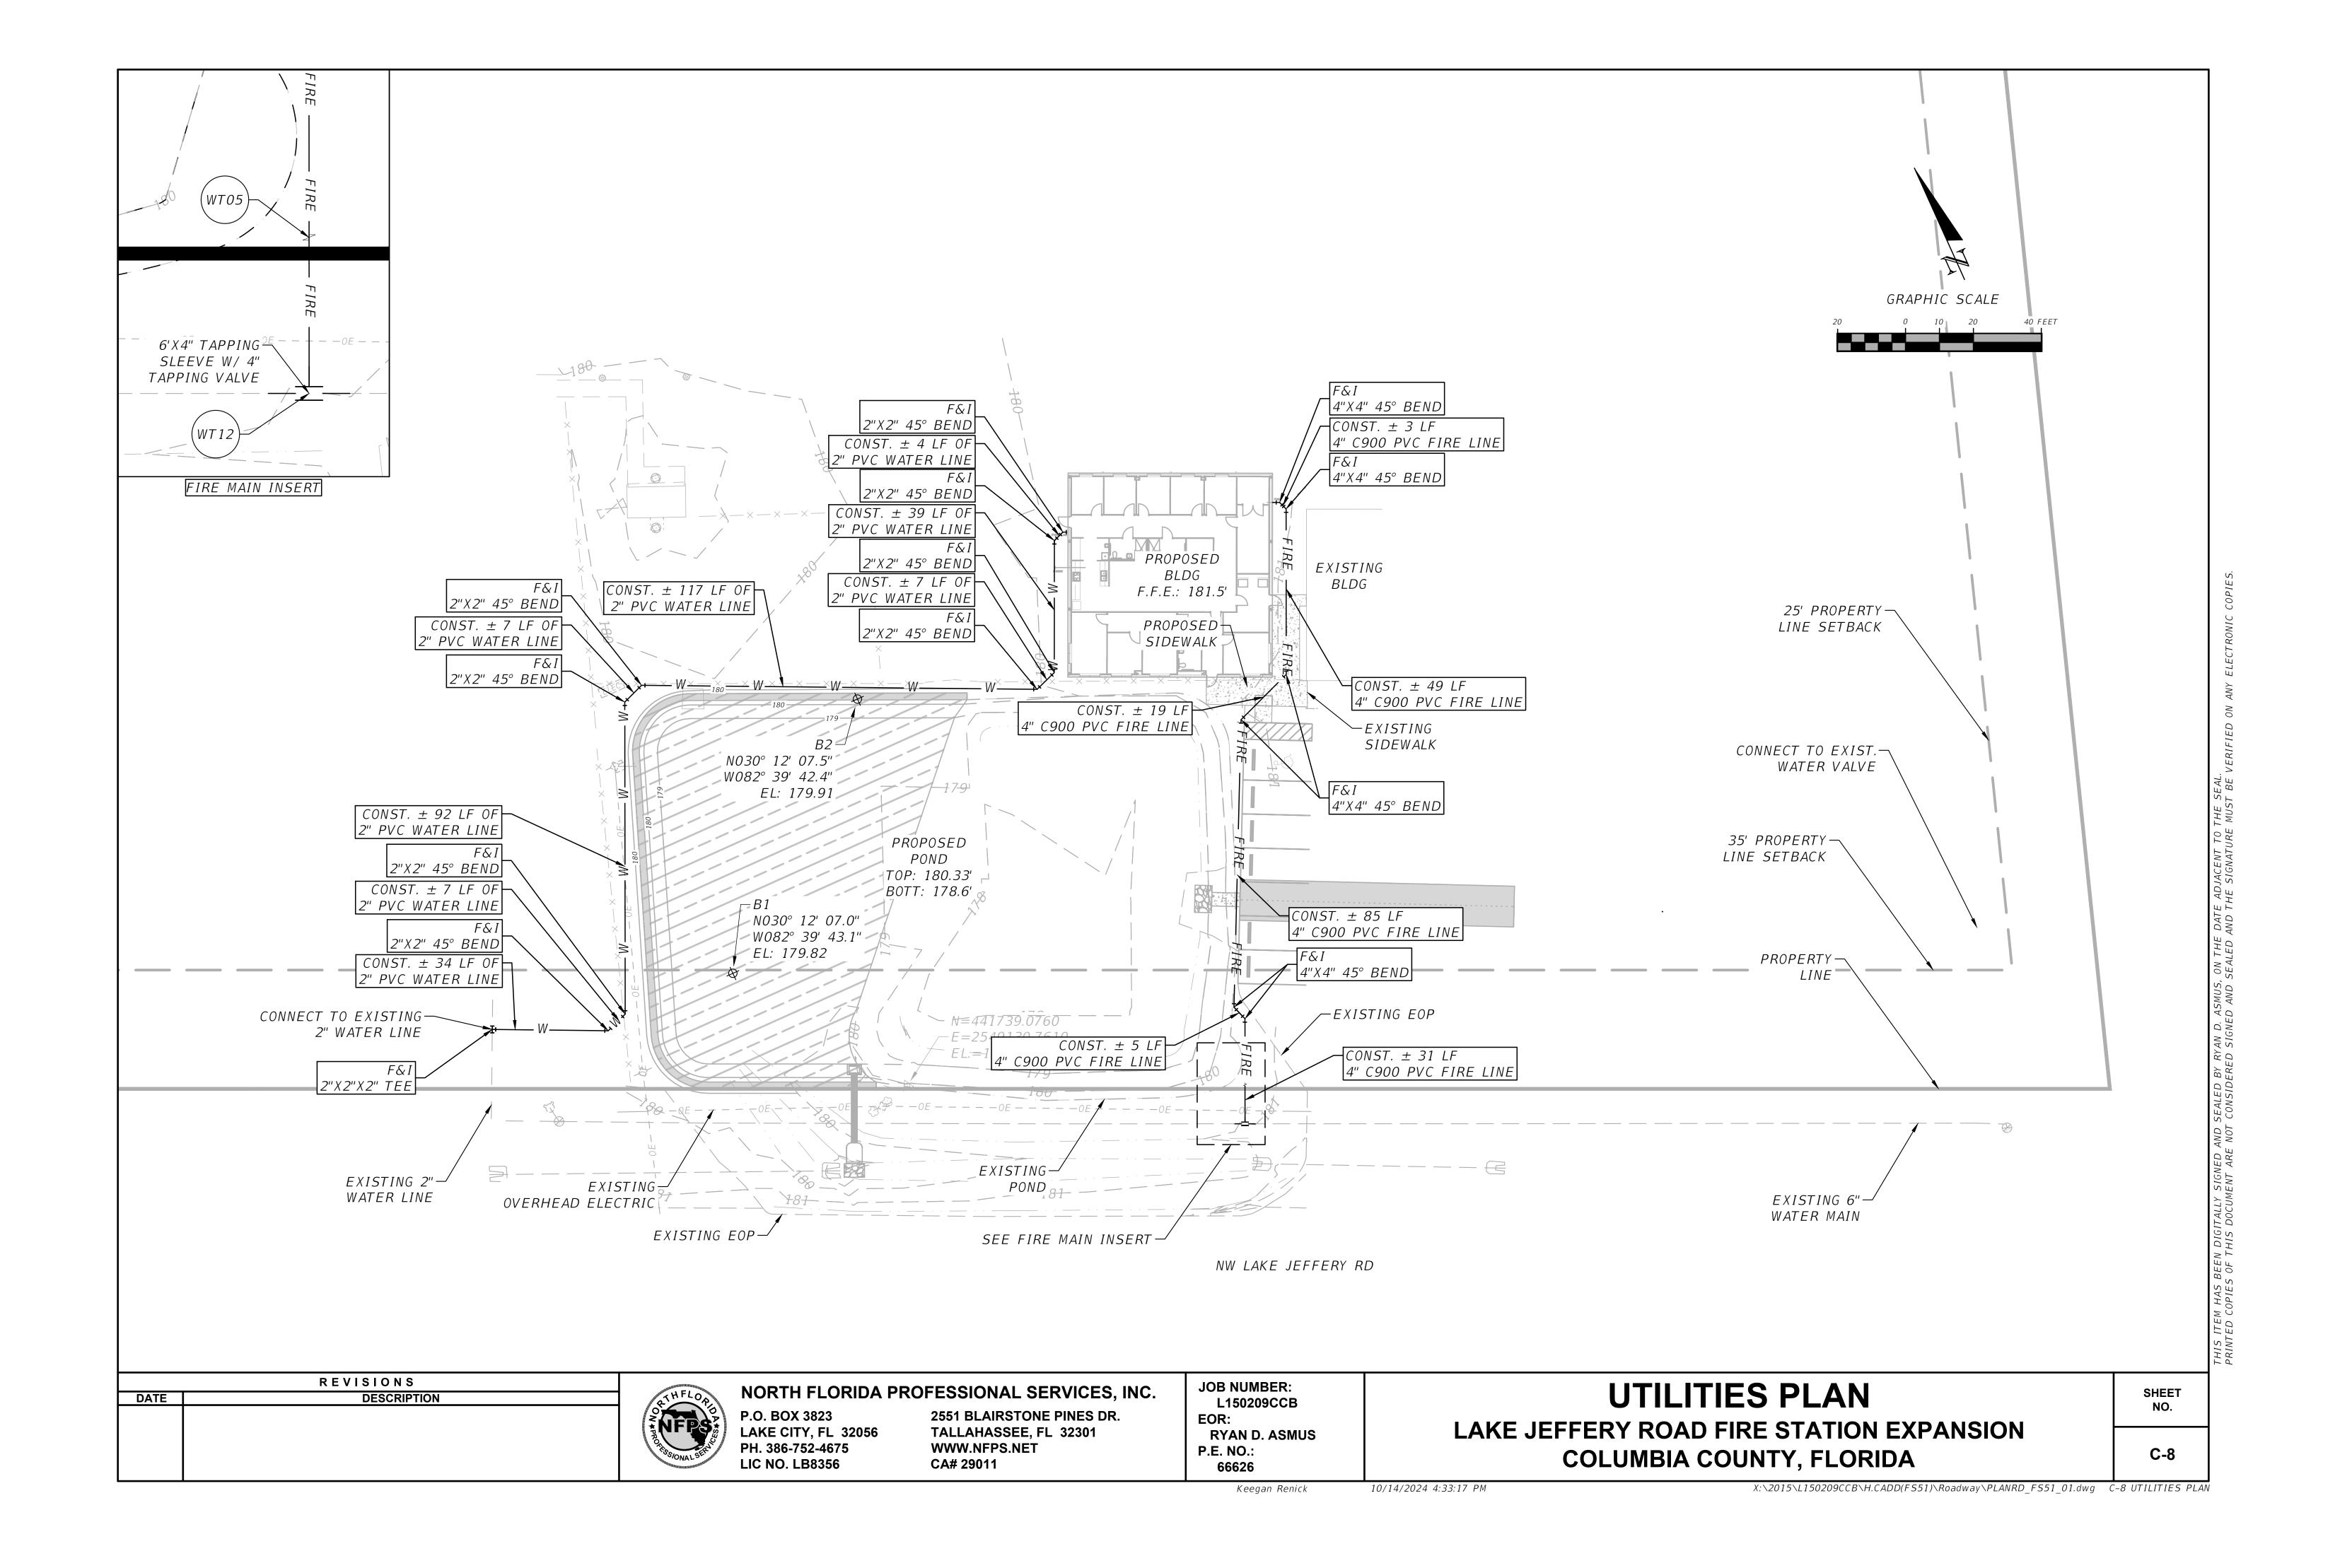


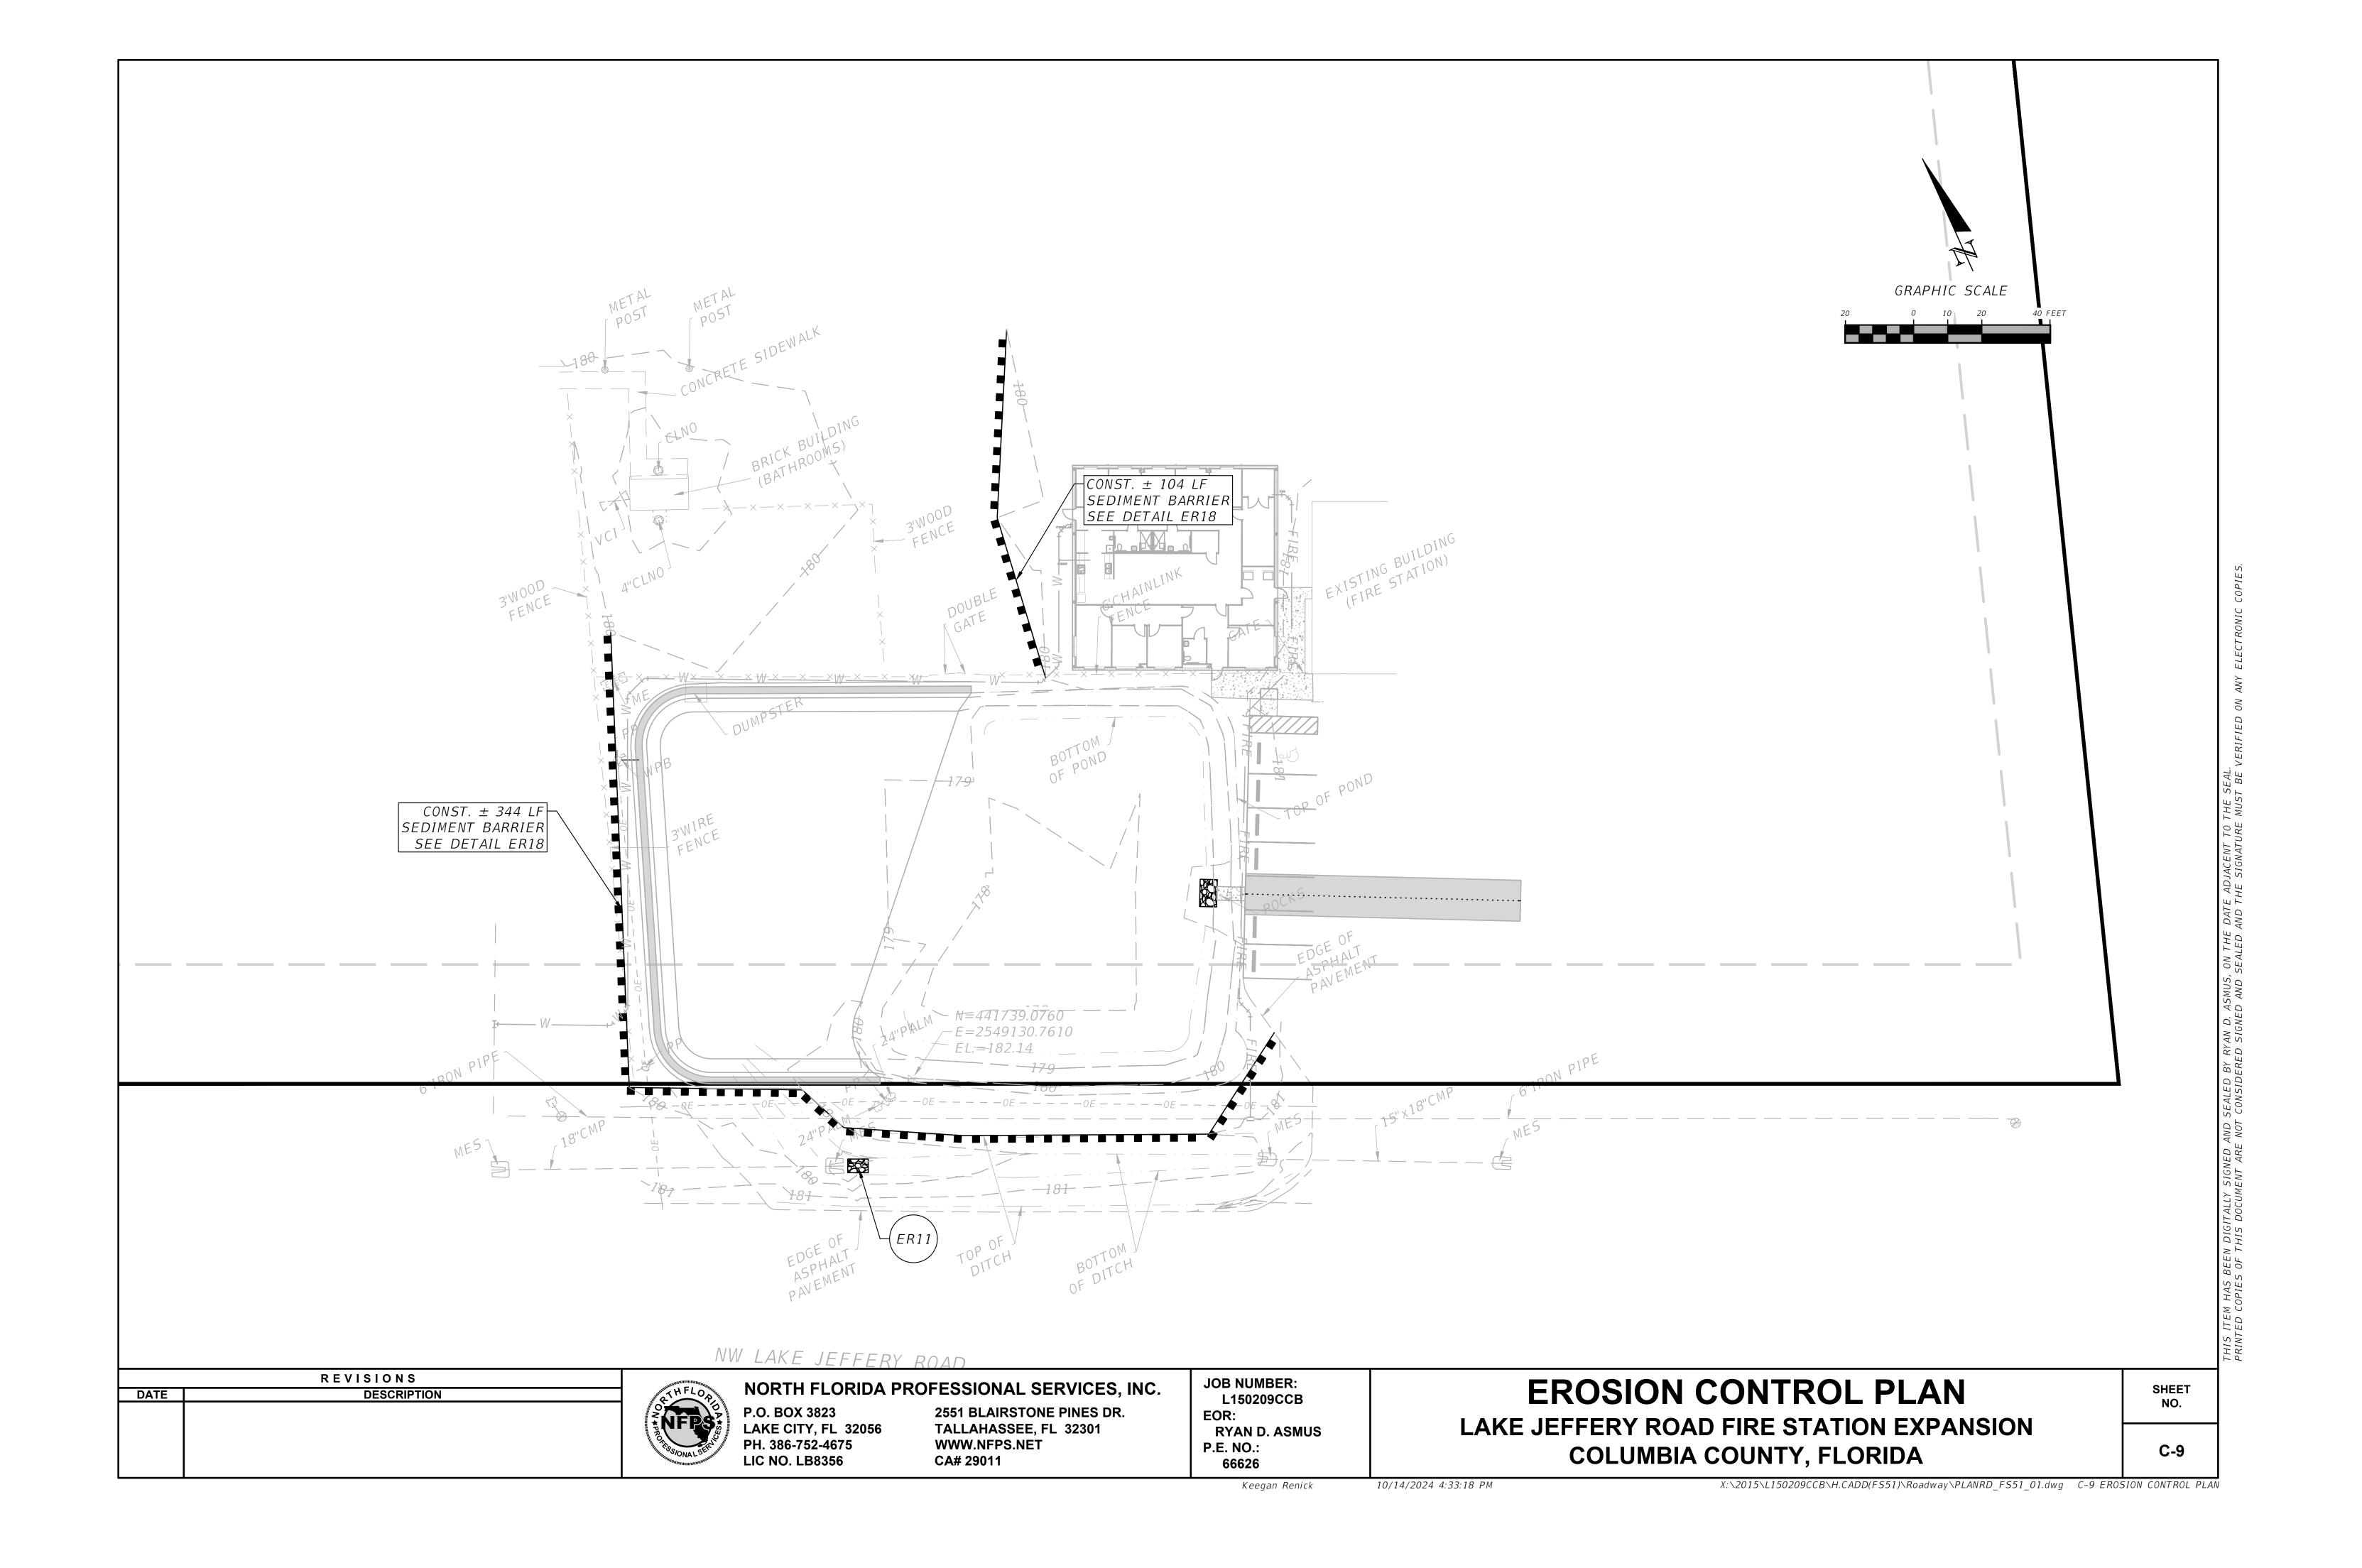

#### EROSION CONTROL NOTES

- 1. THIS EROSION AND SEDIMENTATION CONTROL PLAN COMPLIES WITH THE REQUIREMENTS OF THE "FLORIDA DEVELOPMENT MANUAL" AND THE "FLORIDA EROSION AND SEDIMENT CONTROL INSPECTOR'S MANUAL".
- 2. THE CONTRACTOR SHALL ADHERE TO COLUMBIA COUNTY, SRWMD, AND OTHER GOVERNING AUTHORITIES FOR EROSION AND SEDIMENT CONTROL REGULATIONS. IF THE CONTRACTOR NEEDS TO CHANGE THIS PLAN TO MORE EFFECTIVELY CONTROL EROSION AND SEDIMENTATION, THE CONTRACTOR SHALL USE BMP'S FROM THE "FLORIDA EROSION AND SEDIMENT CONTROL INSPECTOR'S MANUAL".
- 3. THE CONTRACTOR SHALL ADJUST AND REVISE THIS PLAN TO MEET ACTUAL FIELD CONDITIONS. ANY REVISIONS SHALL BE APPROVED BY THE REVIEWING AGENCIES.
- 4. SEDIMENT AND EROSION CONTROL FACILITIES, STORM DRAINAGE FACILITIES AND DETENTION BASINS SHALL BE INSTALLED PRIOR TO ANY OTHER CONSTRUCTION.
- 5. EROSION CONTROL MEASURES SHALL BE INSPECTED WEEKLY AND AFTER EACH RAINFALL OF 0.5 INCHES OR GREATER, AND REPAIRED OR REPLACED AS NECESSARY.
- 6. SEDIMENT AND EROSION CONTROL MEASURES SHALL NOT BE REMOVED UNTIL ALL CONSTRUCTION IS COMPLETE AND UNTIL A PERMANENT GROUND COVER HAS BEEN ESTABLISHED.
- 7. ALL OPEN DRAINAGE SWALES SHALL BE GRASSED AND RIPRAP SHALL BE PLACED AS REQUIRED TO CONTROL EROSION.
- 8. SILT FENCES SHALL BE LOCATED ON SITE TO PREVENT SEDIMENT AND EROSION FROM LEAVING PROJECT LIMITS.
- 9. CONTRACTOR SHALL PLACE A DOUBLE ROW OF SILT FENCE IN AREAS WHERE RUNOFF FROM DISTURBED AREAS MAY ENTER WETLANDS.
- 10. DURING CONSTRUCTION AND AFTER CONSTRUCTION IS COMPLETE, ALL STRUCTURES SHALL BE CLEANED OF ALL DEBRIS AND EXCESS SEDIMENT.
- 11. ALL GRADED AREAS SHALL BE STABILIZED IMMEDIATELY WITH A TEMPORARY FAST-GROWING COVER AND/OR MULCH.
- 12. A PAD OF RUBBLE RIP RAP SHALL BE PLACED AT THE BOTTOM OF ALL COLLECTION FLUMES AND COLLECTION PIPE OUTLETS. GRANITE OR LIMESTONE RIPRAP IS REQUIRED, NO BROKEN CONCRETE WILL BE ACCEPTED.
- 13. ALL SIDE SLOPES STEEPER THAN 3:1 SHALL BE ADEQUATELY PROTECTED FROM EROSION THROUGH THE USE OF SYNTHETIC BALES OR SODDING.
- 14. ALL STABILIZATION PRACTICES SHALL BE INITIATED AS SOON AS PRACTICABLE IN AREAS OF THE JOB WHERE CONSTRUCTION ACTIVITIES HAVE TEMPORARILY OR PERMANENTLY STOPPED, BUT IN NO CASE SHALL THE DISTURBED AREA BE LEFT UNPROTECTED FOR MORE THAN SEVEN DAYS.
- 15. ALL WASTE GENERATED ON THE PROJECT SHALL BE DISPOSED OF BY THE CONTRACTOR IN AREAS PROVIDED BY CONTRACTOR.
- 16. LOADED HAUL TRUCKS SHALL BE COVERED WITH TARPS.
- 17. EXCESS DIRT SHALL BE REMOVED DAILY.
- 18. THIS PROJECT SHALL COMPLY WITH ALL WATER QUALITY STANDARDS. PERMIT REQUIRED FROM SRWMD HAS BEEN OBTAINED.
- 19. QUALIFIED PERSONNEL SHALL INSPECT THE AREA USED FOR STORAGE OF STOCKPILES, THE SILT FENCE AND STRAW BALES, THE LOCATION WHERE VEHICLES ENTER OR EXIT THE SITE, AND THE DISTURBED AREAS THAT HAVE NOT BEEN FINALLY STABILIZED, AT LEAST ONCE EVERY SEVEN CALENDAR DAYS AND WITHIN 24 HOURS OF THE END OF A STORM OF 0.5 INCHES OR GREATER.
- 20. SITES THAT HAVE BEEN FINALLY STABILIZED WITH SOD OR GRASSING SHALL BE INSPECTED AT LEAST ONCE EVERY WEEK.

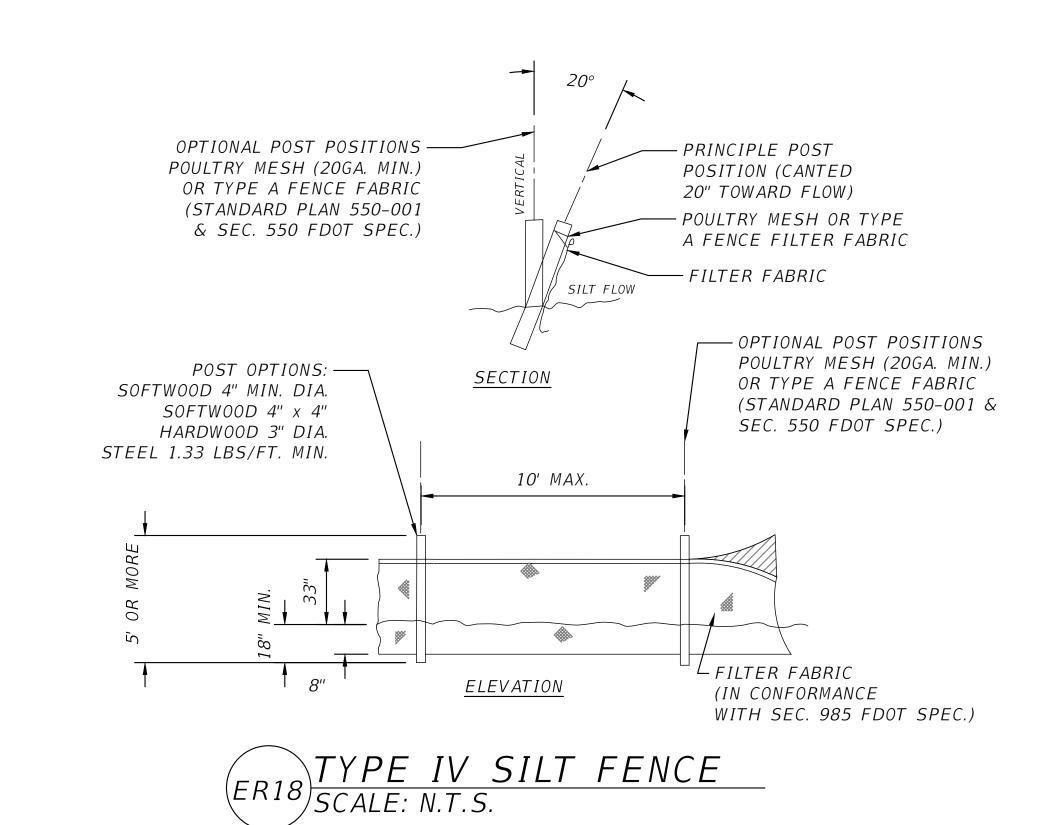

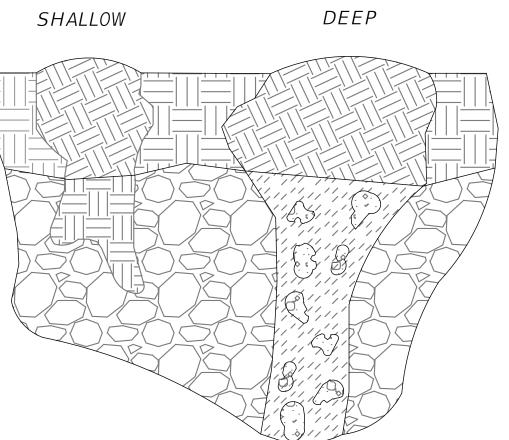

NOTES: THE FOLLOWING SHALL BE PERFORMED IN THE EVENT ANY KARST FEATURES FORM DURING CONSTRUCTION - E.G. SOLUTION CAVITIES, CHIMNEYS, SINKHOLES.

- 1. NOTIFY THE WATER MANAGEMENT DISTRICT AND THE APPLICABLE MUNICIPAL OR COUNTY PUBLIC WORKS IMMEDIATELY WHEN THE FEATURES ARE ENCOUNTERED. THE METHOD OF REPAIR SHALL BE SUBMITTED FOR REVIEW, COMMENT, AND APPROVAL PRIOR TO ATTEMPTING ANY REPAIR.
- 2. SHALLOW KARST FEATURES ARE TYPICALLY LESS THAN 5' DEEP AND ONLY HAVE SMALL VOIDS IN THE LIMESTONE. THE FEATURE CAN BE REPAIRED BY BACKFILLING WITH A LOWER PERMEABILITY MATERIAL SUCH AS CLAYEY-SAND OR CLAY. COMPACT THE BACKFILL AND CREATE A SMALL MOUND SLIGHTLY ABOVE GRADE TO ACCOUNT FOR SETTLING.
- 3. DEEP KARST FEATURES SHALL BE REPAIRED MORE PERMANENTLY.
  EXCAVATE THE FEATURE TO THE LIMESTONE BEDROCK. PLUG VOIDS IN
  THE BEDROCK WITH CLEAN GROUT. BACKFILL OVER THE PLUG WITH A
  LOWER-PERMEABILITY MATERIAL SUCH AS CLAYEY-SAND OR CLAY.
  COMPACT THE BACKFILL TO GRADE.

ER23 KARST FEATURE REPAIR DETAIL
SCALE: N.T.S.

DATE DESCRIPTION



NORTH FLORIDA PROFESSIONAL SERVICES, INC.

P.O. BOX 3823 LAKE CITY, FL 32056 PH. 386-752-4675 LIC NO. LB8356 2551 BLAIRSTONE PINES DR. TALLAHASSEE, FL 32301 WWW.NFPS.NET CA# 29011 JOB NUMBER: L150209CCB EOR: RYAN D. ASMUS P.E. NO.: 66626

**EROSION CONTROL NOTES & DETAILS** 


LAKE JEFFERY ROAD FIRE STATION EXPANSION COLUMBIA COUNTY, FLORIDA

SHEET NO.

C-10

- 1. PIPE BEDDING: SELECT COMMON FILL COMPACTED TO 95% OF THE MAXIMUM DENSITY AS PER AASHTO T-180.
- 2. TRENCH BACKFILL: COMMON FILL COMPACTED TO 95% OF THE MAXIMUM DENSITY AS PER AASHTO T-180.
- 3. PIPE BEDDING UTILIZING SELECT COMMON FILL OR BEDDING ROCK WILL BE REQUIRED IFOVER-EXCAVATION OCCURS.
- 4. (\*): 15" MAX. FOR PIPE DIAMETER LESS THAN 24", AND 24" MAX. FOR PIPE
- DIAMETER 24" AND LARGER. 5. WATER SHALL NOT BE PERMITTED IN THE TRENCH DURING CONSTRUCTION.
- 6. ALL PIPE TO BE INSTALLED WITH BELL FACING UPSTREAM TO THE DIRECTION OF THE FLOW.
- 7. PROVIDE TRENCH SLOPING AND BRACING AS REQUIRED FOR SAFETY.
- 8. FINAL RESTORATION IN IMPROVED AREAS SHALL BE IN COMPLIANCE WITH ALL APPLICABLE REGULATIONS OF GOVERNING AGENCIES. SURFACE RESTORATION WITHIN PAVED AREAS SHALL COMPLY WITH THE REQUUIREMENTS OF THE ROAD CONSTRUCTION SPECIFICATIONS.



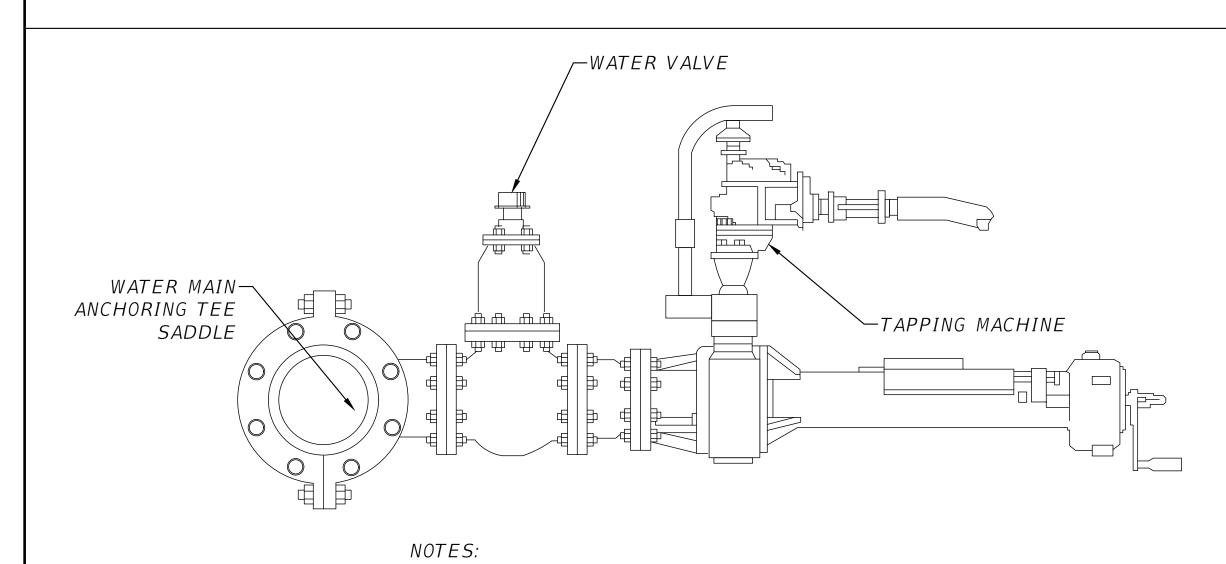

1. CONTACT BRIAN SCOTT AT THE CITY OF LAKE CITY FOR WET TAP REQUIREMENTS.

WET TAP AND SADDLE ASSEMBLY SCALE: N.T.S

REVISIONS DESCRIPTION DATE



NORTH FLORIDA PROFESSIONAL SERVICES, INC.

P.O. BOX 3823 LAKE CITY, FL 32056 PH. 386-752-4675 **LIC NO. LB8356** 

**2551 BLAIRSTONE PINES DR.** TALLAHASSEE, FL 32301 WWW.NFPS.NET CA# 29011

**JOB NUMBER:** L150209CCB EOR: P.E. NO.:

66626

RYAN D. ASMUS

# **UTILITIES DETAILS**

LAKE JEFFERY ROAD FIRE STATION EXPANSION COLUMBIA COUNTY, FLORIDA

C-11

SHEET

90° ELBOW--90° ELBOW FINISHED-GRADE └PIPE SIZE + 12" DIAMETER OR (PIPE SIZE + 12") X (PIPE SIZE + 12) X 6" CONCRETE COLLAR WITH #4 BAR ALL AROUND (2 REQ'D) SERVICE MAIN−90° ELBOW 90° ELBOW-

		MATERIALS
ITE	M	DECRIPTION
1		BACKFLOW PREVENTER
2		GATE VALVE
3		UNION
4		TEST COCKS
5	·	THREADED NIPPLE

NOTES:

- 1. UNDER NO CONDITION WILL ANY CONNECTION BE ALLOWED BETWEEN THE SERVICE METER AND A BACKFLOW PREVENTER USED FOR SYSTEM CONTAINMENT. BACKFLOW PREVENTER SHALL ALWAYS BE INSTALLED DOWNSTREAM OF METER.
- 2. IF A PRESSURE MONITOR IS TO BE INSTALLED, ADD A TEE, VALVE FITTINGS, AND MOUNT ON SUPPLY SIDE PRIOR TO BACKFLOW PREVENTION DEVICE: UNDER NO CIRCUMSTANCE, SHALL TEST PORTS BE MODIFIED OR UTILIZED FOR THIS OR OTHER APPLICATION OTHER THAN BACKFLOW DEVICE TESTING.
- 3. A CONBRACO SERIES 40-000 FREEZE PROTECTION VALVE SHALL BE INCLUDED. 4. PROVIDE AND INSTALL COVER OVER BACKFLOW PREVENTER AS REQ'D BY LOCAL AUTHORITIES.

SCALE: N.T.S


REDUCED PRESSURE BACKFLOW PREVENTER


Keegan Renick

**WT05** 

10/14/2024 4:33:20 PM


X:\2015\L150209CCB\H.CADD(FS51)\Roadway\KEYSRD\_FS51\_01.dwg

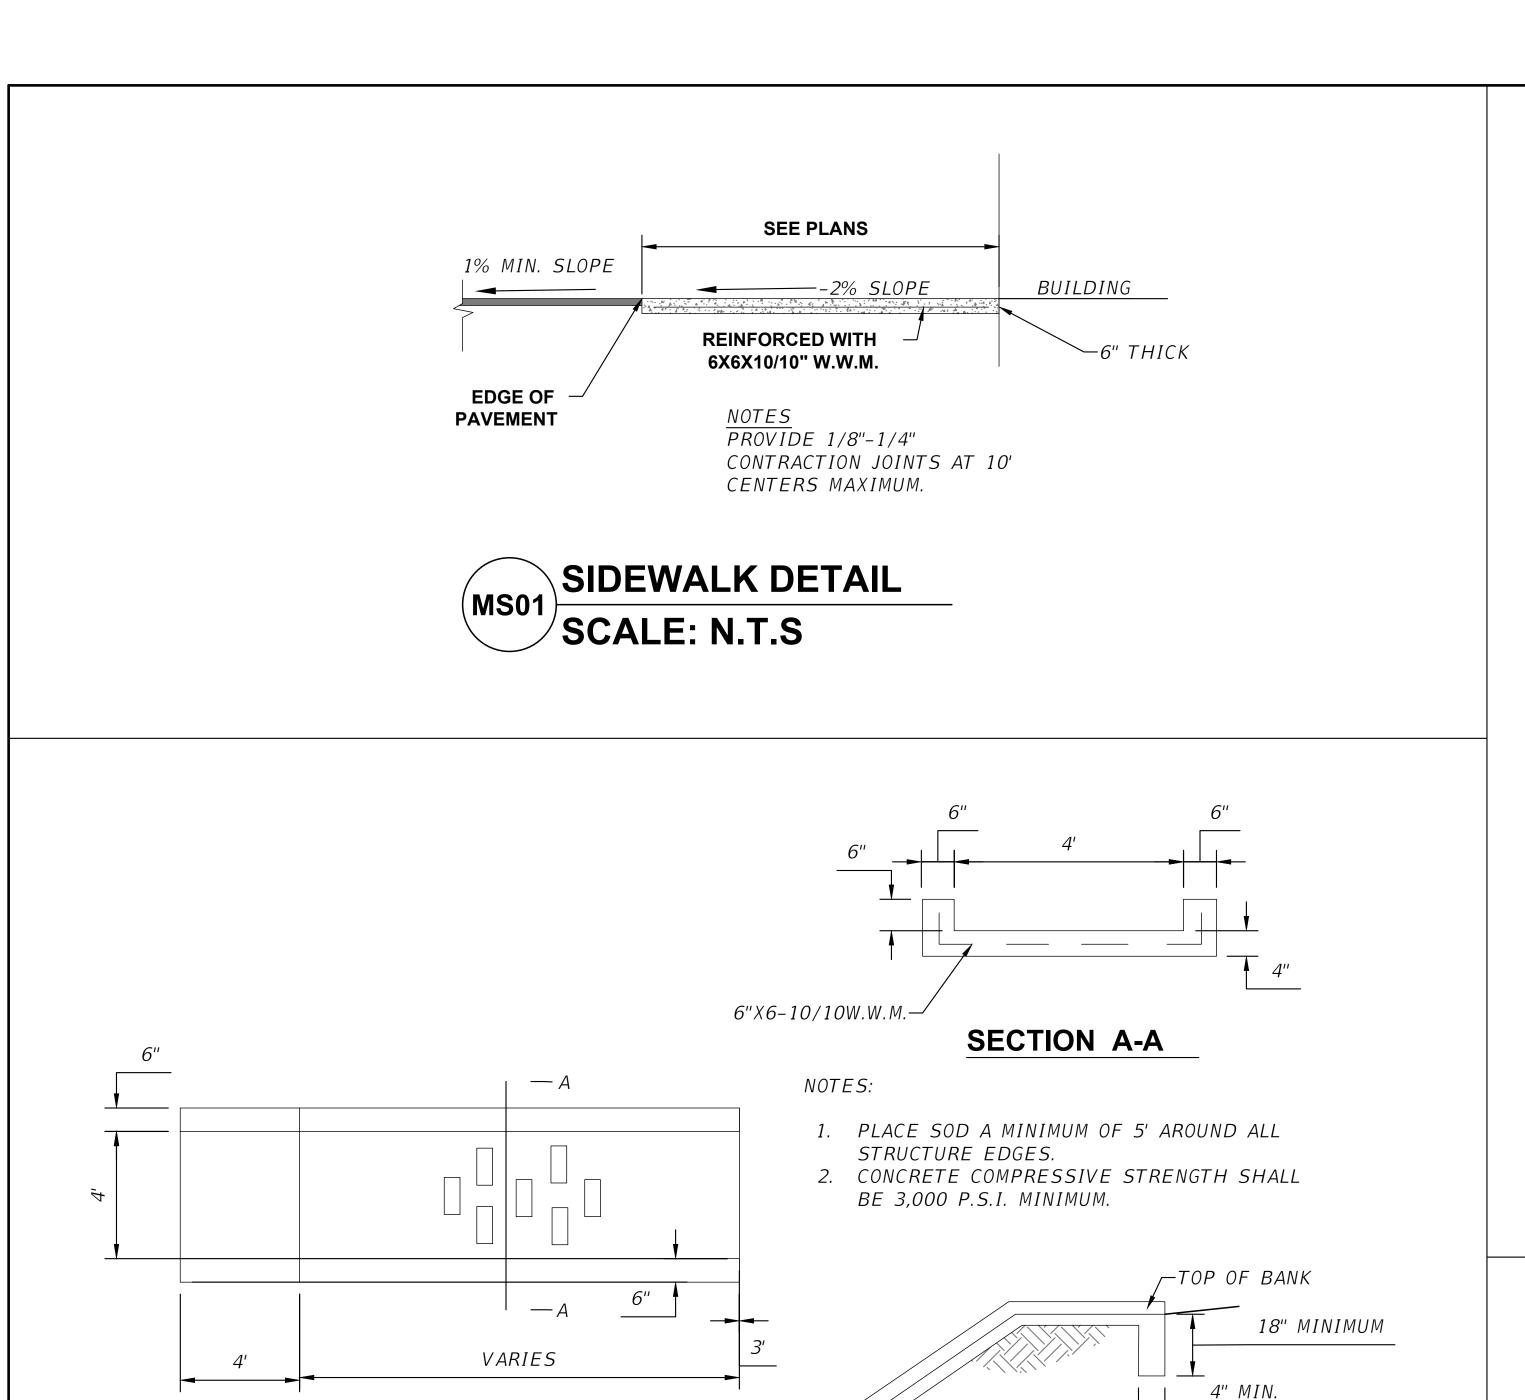

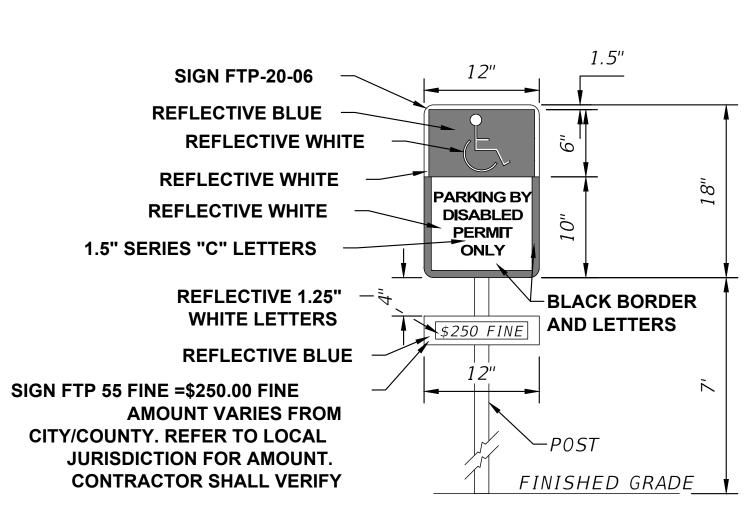

SIGN NOTES:

1. SIGN CONSTRUCTION, DESIGN AND PLACEMENT SHALL COMPLY WITH STATE AND LOCAL STATUES.

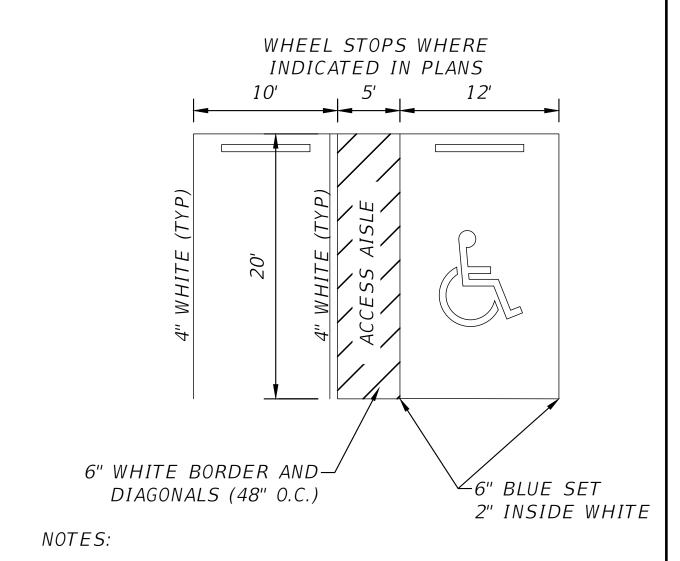


1. SIGN SHALL BE PLACED IN FRONT OF ALL DESIGNATED HANDICAPPED SPACES. SIGN HEIGHT SHALL BE 7' FROM PAVEMENT TO BOTTOM OF SIGN

2. 5' HANDICAPPED AISLE MAY BE PLACED ON THE RIGHT OR LEFT SIDE OF PARKING STALL.

3. HANDICAPPED PARKING SYMBOL SHALL BE 3 OR 5 FT. HIGH.

4. BLUE PAVEMENT MARKINGS SHALL BE TINTED TO MATCH SHADE 15180 OF FEDERAL STANDARDS 595A.



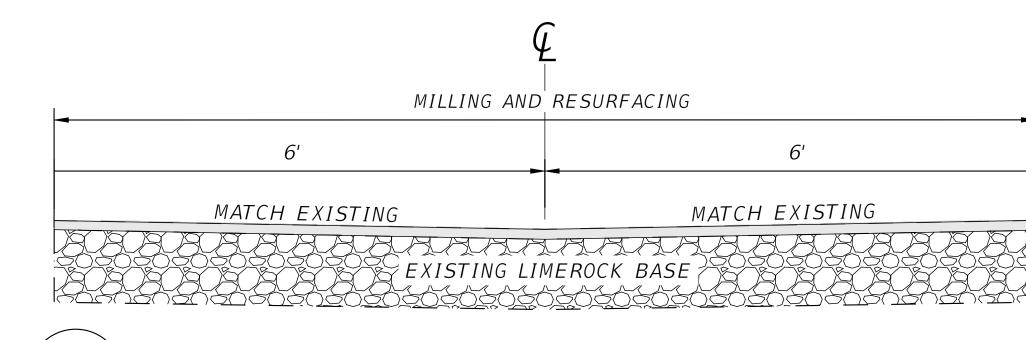

MS05 ASPHALT REPAIR DET AIL SCALE: N.T.S

> MILL: 2" DEPTH AT EXISTING CROSS SLOPE RESURFACE: 2" DEPTH TYPE SP 12.5 STRUCTURAL COURSE

REVISIONS DESCRIPTION DATE

SCALE: N.T.S

BOTTOM OF BANK-



PH. 386-752-4675

**LIC NO. LB8356** 

└CONSTRUCT RIP RAP ENERGY DISSIPATOR

CONCRETE SPILLWAY DETAIL

NORTH FLORIDA PROFESSIONAL SERVICES, INC. P.O. BOX 3823 2551 BLAIRSTONE PINES DR. LAKE CITY, FL 32056

TALLAHASSEE, FL 32301 WWW.NFPS.NET CA# 29011


**JOB NUMBER:** L150209CCB EOR: RYAN D. ASMUS P.E. NO.:


66626

MISC DETAILS LAKE JEFFERY ROAD FIRE STATION EXPANSION COLUMBIA COUNTY, FLORIDA

C-12

SHEET

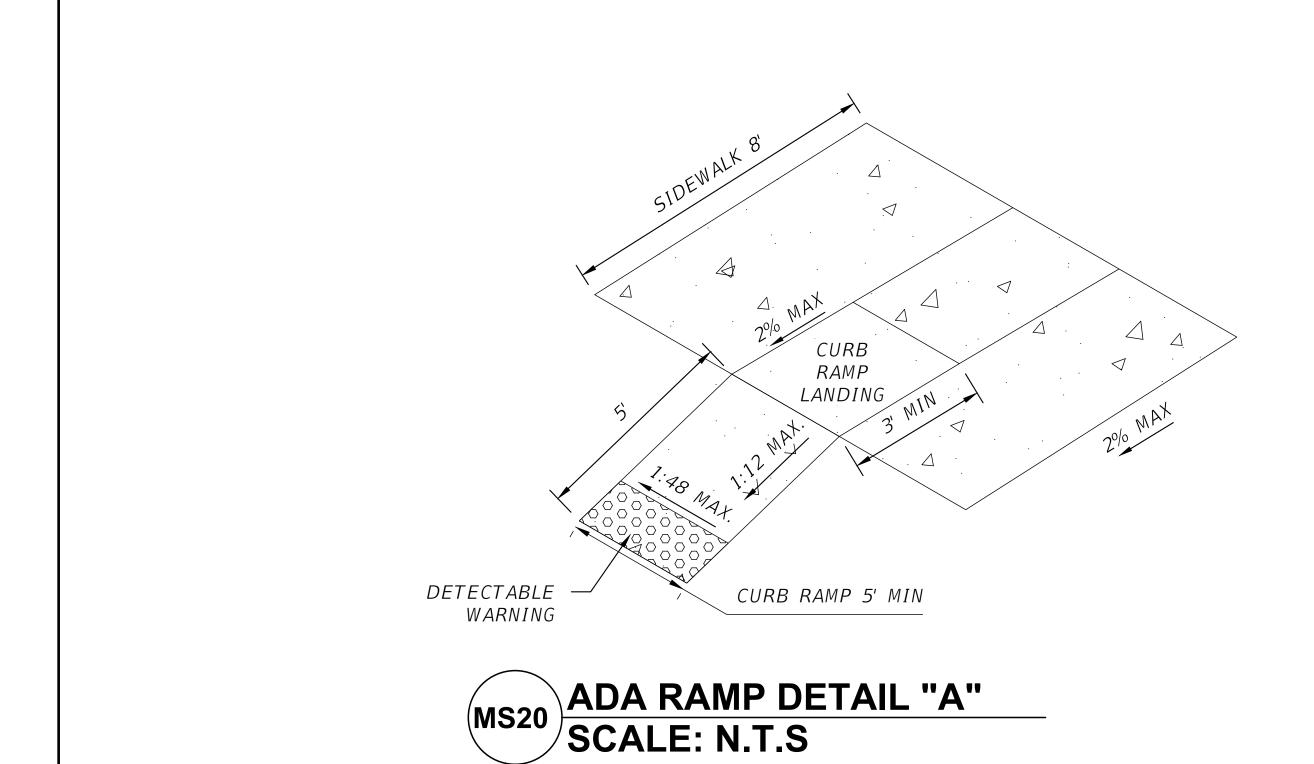

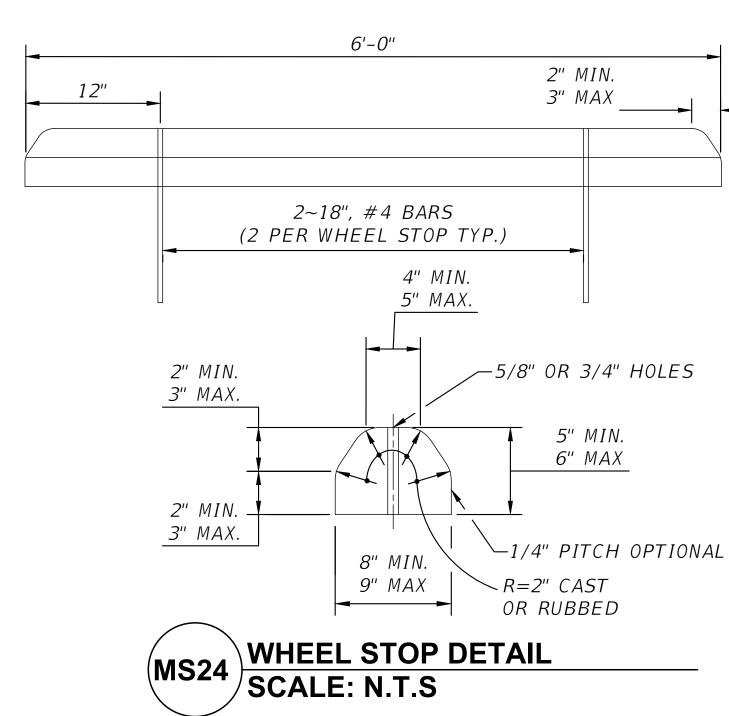

*1/4" PITCH OPTIONAL* 

	REVISIONS
DATE	DESCRIPTION



NORTH FLORIDA PROFESSIONAL SERVICES, INC. P.O. BOX 3823 LAKE CITY, FL 32056 PH. 386-752-4675 LIC NO. LB8356

2551 BLAIRSTONE PINES DR. TALLAHASSEE, FL 32301 WWW.NFPS.NET CA# 29011

JOB NUMBER: L150209CCB EOR: **RYAN D. ASMUS** P.E. NO.:

66626

**MISC DETAILS** LAKE JEFFERY ROAD FIRE STATION EXPANSION COLUMBIA COUNTY, FLORIDA

SHEET NO. C-13

Keegan Renick

10/14/2024 4:33:21 PM

		Summary of Lu	ımp Sum Iten	ns							Sumi	mary of Gen				Total				
Pay Item Number	Pay Item Description		Unit of Measure	Quantity	· I	Total antity	Desi	ign Notes	Construction Remarks	Pay Item Number	Pay Item Description		Unit of leasure	Quant y	it i	Quantit y	Desi	ign Notes		
0101 1	MODILIZATION		1.6	P F	F P	F								Р		P F				
0101 1	MOBILIZATION	Summary of Clea	LS ring & Grubb	oing						0542 70	BUMPER GUARDS, CONCRETE	V 05 D5D54	EA	6		6				
					Tata	ol Occantitus					SUMMARY OF PERFORMANCE TURF									
Pay Item Number	Pay Item Description	Unit of Measure	Qua	F	F F	Quantity F		Design Notes Construction Remarks		Pay Item Number	Pay Item Description	Unit of Measur				Total Qua	ıntity	Design N		
110 1 1	CLEARING & GRUBBING	AC	0.22	2	0.2	22							Р	F	:	Р	F			
		Summary o	of Earthwork				<b>I</b>			0570 1 2	PERFORMANCE TURF, SOD	SY	1031.			1031.1				
Pay Item		Unit of	Qı	uanity		Total Qua	ıntity	Design	Construction		Summary of Si	gning and P	avement Ma	rking 						
Number	Pay Item Description								n Notes											
0120 1	DECILIAD EVENVATION	CY	77			•	<del>-</del>			Number		Wieasure	Р	F	Р	F				
0120 1	REGULAR EXCAVATION		of Pavement							0710 11 101	PAINT, STANDARD, WHITE, SOLID, 6" FOR PARKING SPACES	LF	120		120	)				
Pay Item	Day Itam Dagarintian		Unit of	Quantit	ty	Total Quantity	,	Danisus Notas	Construction	0710 11 160	PAINT, STANDARD, WHITE, MESSAGE OR SYMBOL (HANDICAP SYMBOL)	EA	1		1					
Number	Pav ilem Describtion		0710 11 142	PAINT, STANDARD, BLUE, SOLID, 6"	LF	110		110	)											
0327 70 5	MILLING EXIST ASPH PAVT, 2" DEPTH		SY	107.7		107.7					Sum	mary of Util	lity Items							
0334 1 12	SUPERPAVE ASPHALTIC CONC, TRAFFIC	C B TN		12		12				Pay Item	Pay Item Description	Unit of		Quanity		otal antity	Desig	n Notes		
	Summa	ry of Sidewalk and	Followalk and Detectable Warnings  Measure  P F P F			200.g.: 110.00														
Pay Item	Pay Item Description		Unit of	Quantity		Total Quantity		III 2 NT ITV		Design Notes	Construction	1050 31202	050 31202 UTILITY PIPE- POLY VINYL CHLORIDE, FURNISH & INSTALL, WATER/SEWER, 2"				303 303			
Number	. a,		Measure	Р	F	Р	F		Remarks	1050 31204	UTILITY PIPE- POLY VINYL CHLORIDE, FURNISH & INSTALL, WATER/SEWER, 4"	LF	193		193	3				
522 2	Concrete Sidewalk and Driveways, 6" T	hick	SY	51.52		51.52				1080 23104	UTILITY FIXTURE- TAPPING SADDLE/SLEEVE, FURNISH & INSTALL, 4"	EA	1		1					
527 2	Detectable Warning Surface		SF	10		10														
	1	Summary	of Drainage			I														
Pay Item Number	Pay Item Description		Unit of Measure	Quar		Total Quantity	/ D	Design Notes	Construction Remarks											
425 1521	INLETS, DT BOT, TYPE C, <10'		EA	1 P	F	<b>P</b> 1	F													
430175112	PIPE CULVERT, OPTIONAL MATERIAL, I	ROUND, 12"		24		24														
430982121	S/CD  MITERED END SECTION, OPTIONAL RO	UND, 12" CD	EA	1		1														
524 1 49	CONCRETE DITCH PAVEMENT, 6", REIN	NFORCED	SY	3.7		3.7														
	SUMMARY OF	EROSION AND SE	DIMENT CO	NTROL DE	VICES	<u> </u>														
Pay Item	D. 10. D. 10.	Unit of	Quantity	Tota	al Quan	tity	<u> </u>	n Na f	Construction											
Number	Pay Item Description	Measure					Desigi	n Notes	Remarks											

	REVISIONS
DATE	DESCRIPTION

SEDIMENT BARRIER

LINING

RIPRAP, RUBBLE, F&I, DITCH

0104 10 3

0530 3 4



448

5.12

448

3.2

1.92

NORTH FLORIDA PROFESSIONAL SERVICES, INC. P.O. BOX 3823 LAKE CITY, FL 32056 PH. 386-752-4675 LIC NO. LB8356

2551 BLAIRSTONE PINES DR. TALLAHASSEE, FL 32301 WWW.NFPS.NET CA# 29011

JOB NUMBER: L150209CCB EOR: **RYAN D. ASMUS** P.E. NO.:

# **SUMMARY OF QUANTITIES** LAKE JEFFERY ROAD FIRE STATION EXPANSION COLUMBIA COUNTY, FLORIDA

SHEET NO. C-14

Construction

Remarks

Construction

Remarks

Construction

Remarks

Construction


Remarks

Design Notes

DATE 4/1/2024

2338

A - 1

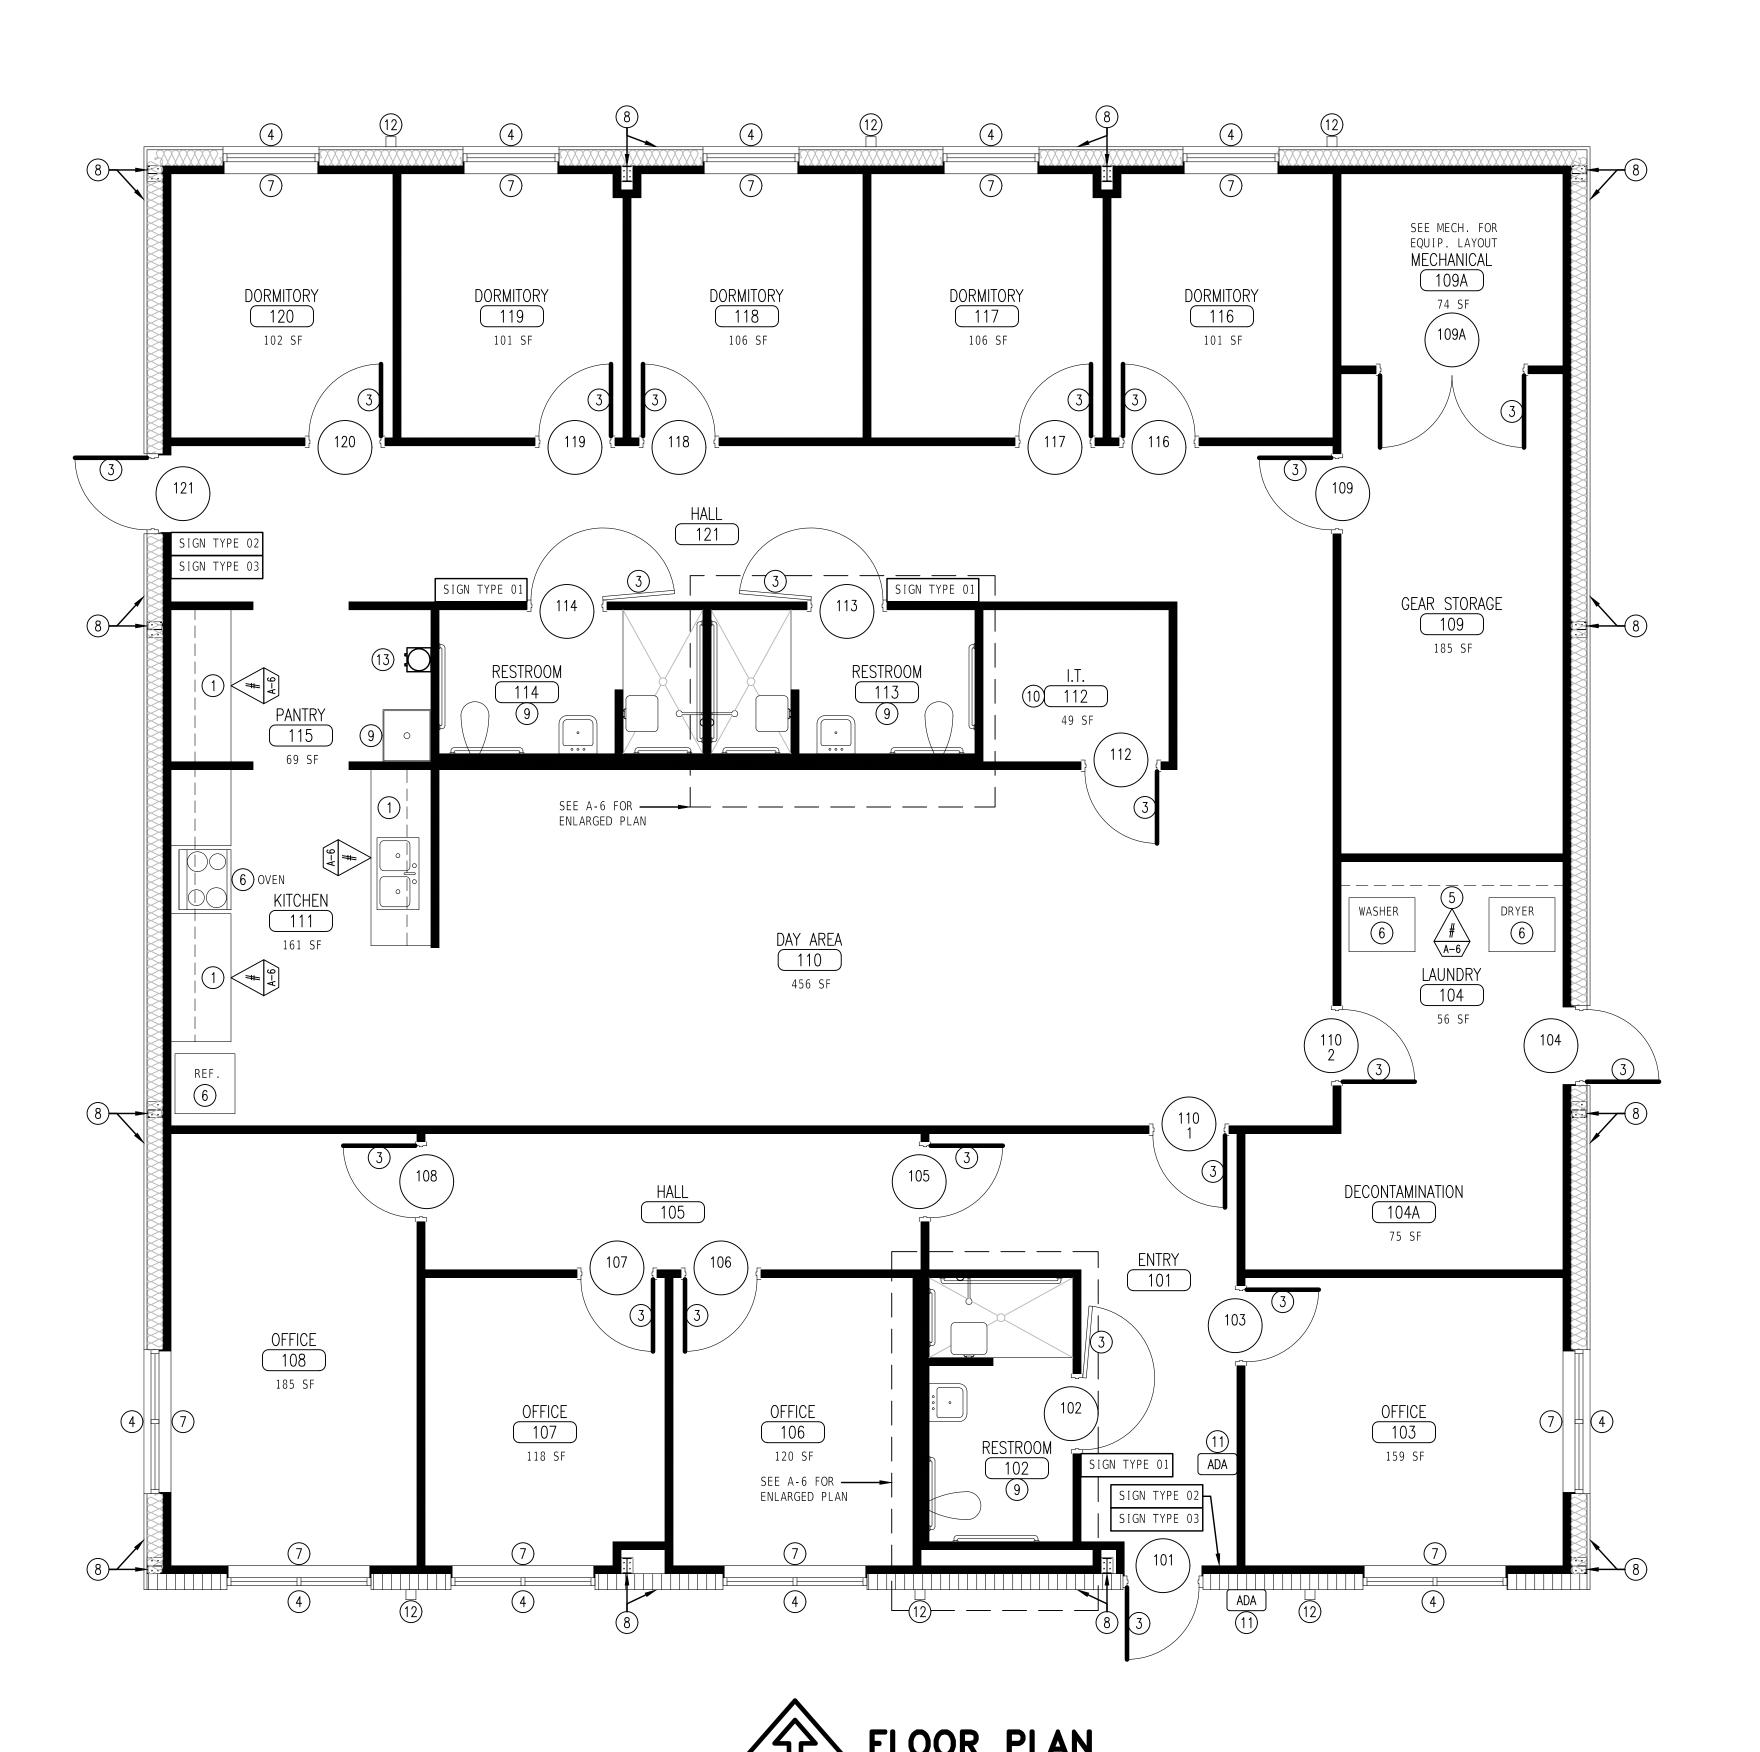

# WALL LEGEND

EXTERIOR SPLIT-FACE 8" CMU WALL W/ FOAM INSUL. IN ALL CELLS NOT FILLED W/ CONC. - SEE STRUCT. FOR CMU REINF - SEE EXT ELEV'S

EXTERIOR PRE-ENGINEERED MT'L. BLD'G. FRAM'G. PURLINS, INSUL. AND EXT. PANEL'G. - SEE EXT. ELEV'S.

INTERIOR 3-5/8" 20 GA. MT'L. STUD. FRAM'G. AT 16" O.C. AND ONE LAYER OF 5/8" TYPE X GYP. BD. ON INT. SIDE - EXTEND FULL PEMB WALL HT. - APPROX. 12'-0"

INTERIOR 3-5/8"" (OR 6" WHERE INDICATED) 20 GA. MT'L. STUD FRAM'G. AT 16" O.C. W/ ONE LAYER OF 5/8" TYPE X GYP. BD. ON EA. (5/8" MOISTURE RESISTANT TILE BACKER BD. ON RESTROOM AND CUSTODIAL ROOM SIDES) - EXTEND WALLS TO 12'-0"

#### SIGNAGE LEGEND

SIGN TYPE 01

ROOM NAME AND GENDER AND ACCESSIBILITY GRAPHICS SIGN - REFER TO PROJECT MANUAL SECTION 10 1400

SIGN TYPE 02

EXIT SIGN - REFER TO PROJECT MANUAL SECTION 10 1400 SIGNAGE

SIGN TYPE 03

EMERGENCY EVACUATION SIGN - REFER TO PROJECT MANUAL SECTION 10 1400

## **FLOOR PLAN NOTES**

- 1) ARCHITECTURAL CASEWORK W/ SINKS WHERE INDICATED -COORD. W/ MEP
- 2) SHT. MT'L. DOWNSPOUT COORD. W/ ROOF PLAN, EXTERIOR ELEVATIONS AND CIVIL DOCUMENTS
- 3 DOOR, FRAME AND DOOR HARDWARE AS SCHED.
- EXTERIOR ALUM.-FRAMED STOREFRONT FRAM'G. AND GLAZ'G. SYS.
- 5 ADJUSTABLE MT'L. SHELV'G.
- 6 OWNER FURNISHED AND INSTALLED EQUIP. COORD. W/MEP FOR ROUGH-IN REQUIREMENTS
- 7) MANUAL ROLLER SHADES
- 8 PRE-ENGINEERED MT'L. BLD'G. STRUCT. AND ASSOCIATED EXT. WALLS
- 9 PLUMB'G. FIXTURES AND ACCESSORIES COORD. W/
- 10 PLYWOOD AROUND ROOM INTERIOR PAINT W/ GRAY FIRE RETARDANT PAINT - INSTALL AT 6" A.F.F.
- 11) ADA PUSH BUTTON DOOR OPERATOR
- DOWNSPOUT COORD. W/ CIVIL FOR UNDERGROUND TIE-IN
- WATER COOLER BY OWNER
- REFER TO SECTION 09 1000 OF PROJECT MANUAL FOR FINISH SCHEDULE - TYP. NOTE THROUGHOUT
- COORD. W/ CIVIL, STRUCTURAL AND MEP DOCUMENTS FOR ADDITIONAL SCOPE OF WORK <u>TYP. NOTE THROUGHOUT</u>