


REVISIONS

SOFTPIAN ARCHITECTURE DESIGN SOFTMARE

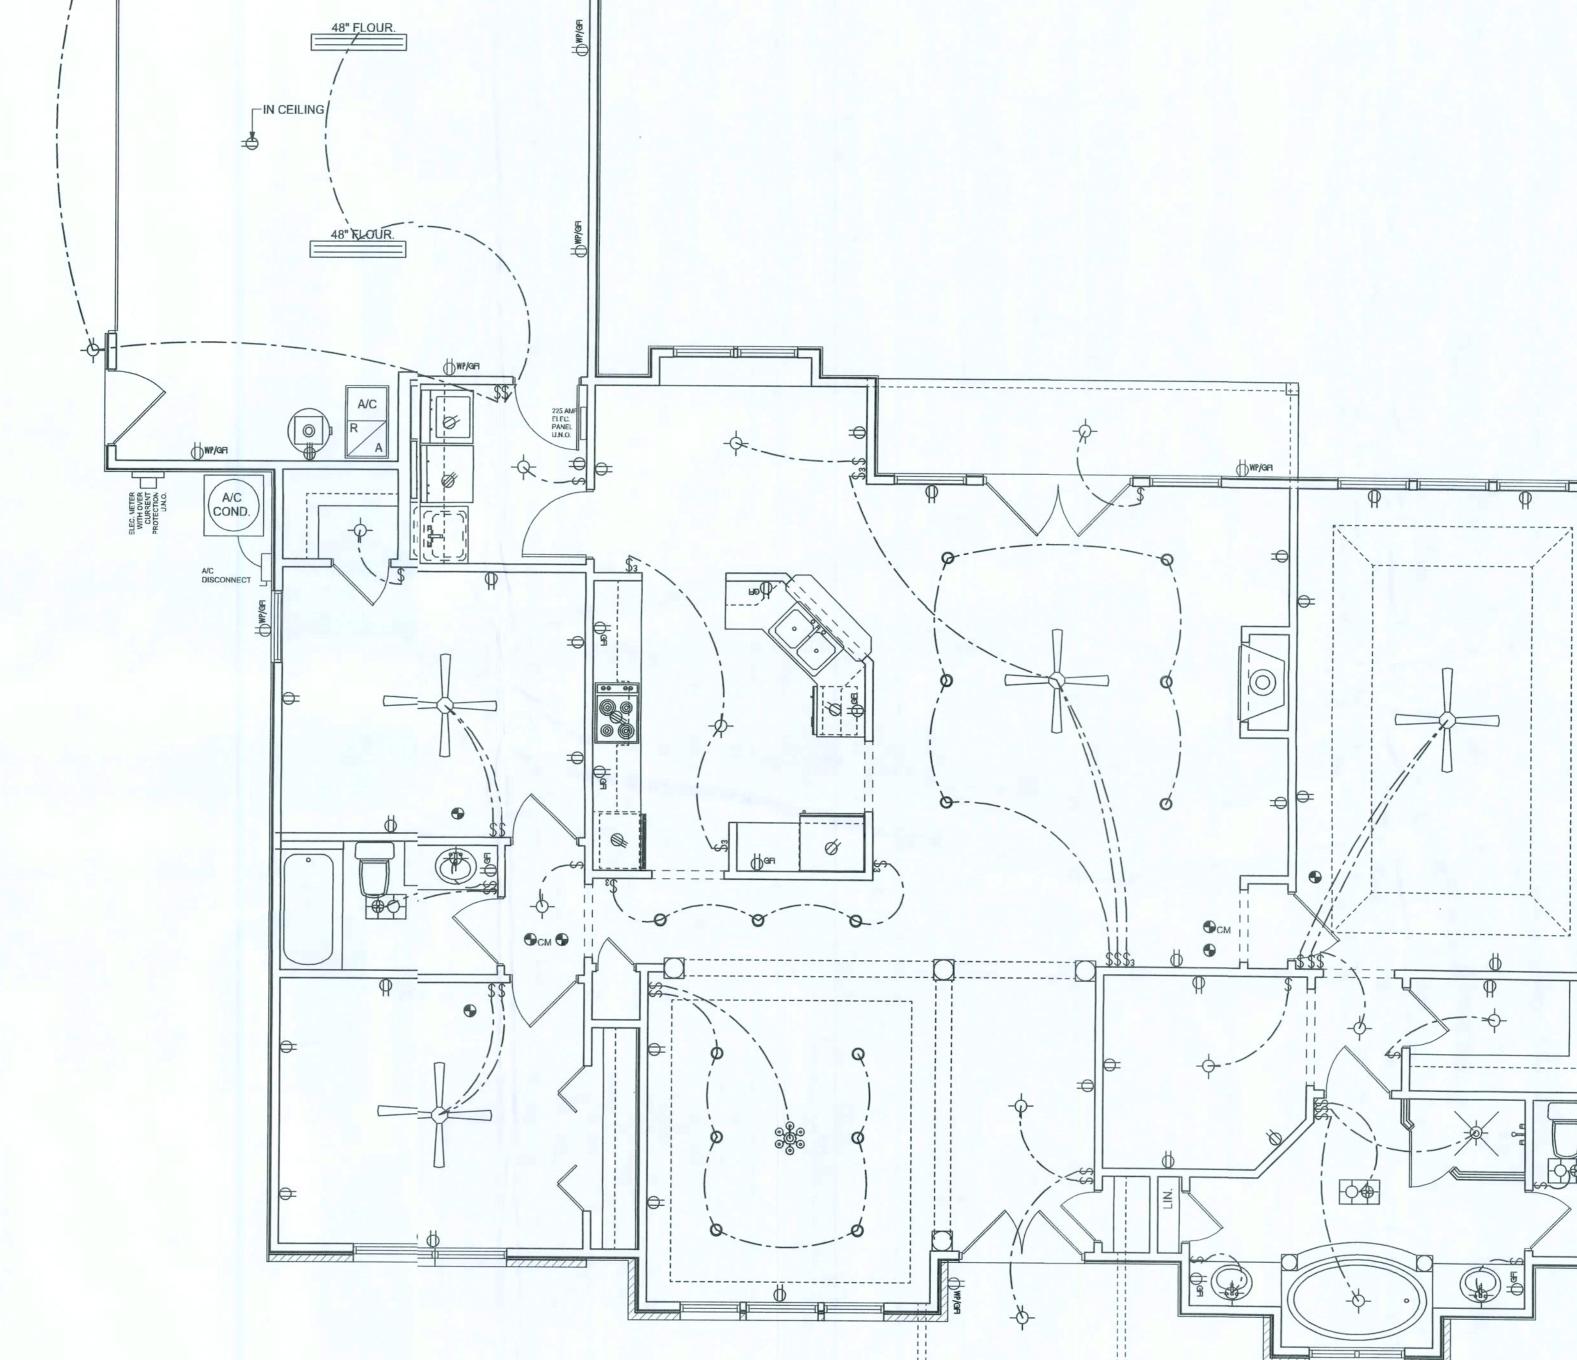

ELECTRICAL PLAN NOTES

E -1 WIRE ALL APPLIANCES, HVAC UNITS AND OTHER EQUIPENT PER MANUF. SPECIFICATIONS.

E -2 CONSULT THE OWNER FOR THE NUMBER OF SEPERATI TELEPHONE LINES TO BE INSTALLED.

E -3 ALL INSTALLATIONS SHALL BE PER NAT'L. ELECTRIC CCE.

ALL SMOKE DETECTORS SHALL BE 120V W/ BATTERY E -4 BACKUP OF THE PHOTOELECTRIC TYPE, AND SHALL BE INTERLOCKED TOGETHER. INSTALL INSIDE AND NEAR ALL BEDROOMS.

TELEPHONE, TELEVISION AND OTHER LOW VOLTAGE DEVICES OR OUTLETS SHALL BE AS PER THE OWNER'S E -5 DIRECTIONS, & IN ACCORDANCE W/ APPLICABLE SECTIONS OF NEC-LATEST EDITION.

E -6 ELECTRICAL CONT'R SHALL BE RESPONSIBLE FOR THE DESIGN & SIZING OF ELECTRICAL SERVICE AND CIRCUIT.

E -7 ENTRY OF SERVICE (UNDERGROUND OR OVERHEAD) TO BE DETERMINED BY POWER COMPANY.


E -8 ALL BEDROOM RECEPTACLES SHALL BE AFCI (ARC FAULT CIRCUIT INTERRUPT)

E -9 ALL OUTLETS TO BE LOCATED ABOVE BASE FLOOD ELEVATION

APPROVAL OF THE BUILDING OFFICIAL

A SERVICE DISCONNECT WITH OVER CURRENT PROTEGON SHALL BE INSTALLED OUTSIDE OF THE BUILDING, ON TH LOAD SIDE OF THE METER, AT THE PLACE ELECTRIC E -10 CONDUCTORS ENTER THE BUILDING. SERVICE ENTRANCE CONDUCTORS MAY NOT BE LOCATO INSIDE OF THE OF THE BUILDING WITHOUT SPECIAL

CARBON MONOXIDE ALARMS SHALL BE REQUIRED WITH 10' E -11 OF ALL ROOMS FOR SLEEPING PURPOSES IN BUILDINGSAVING A FOSSIL-FUEL-BURNING HEATER OR APPLIANCE, A FIRPLACE, OR ATTACHED GARAGE.

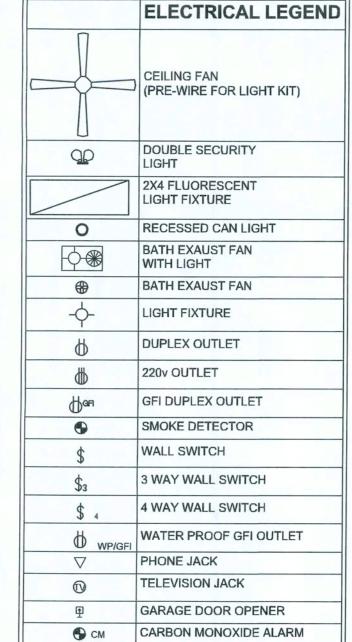

SCALE: 1/4" = 1'-0"

WINDLOAD ENGINEIR: Mark Disosway, PE No.53915, POB 86, Lake City, FL

Stated dimensions suprcede scaled dimensions. Refer all uestions to Mark Disosway, P.E. or resolution. Do not proceed without clarification.

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CERTIFICATION: I heeby certify that I have examined this plan, and that the applicable portions of the plan, reating to wind engineering comply with section R:01.2.1, florida building code residential 2004, o the best of my

LIMITATION: This desgn is valid for one building, at specified loation.

MARK DSOSWAY

P.E.53915

32056, 386-754-5419

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Adam Papka

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> PRINTID DATE: July 24, :008


DRAWN BY: STRUCTURAL BY: Evan Beamsley David Disosway


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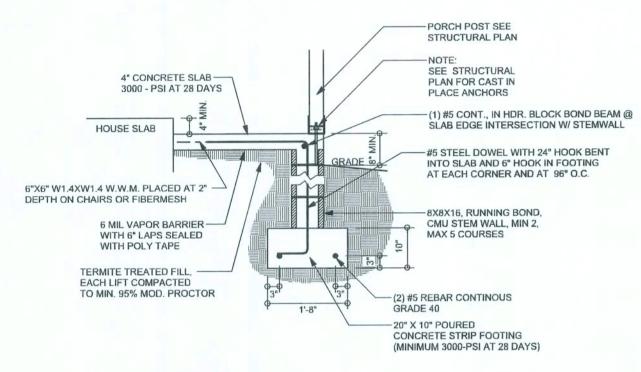
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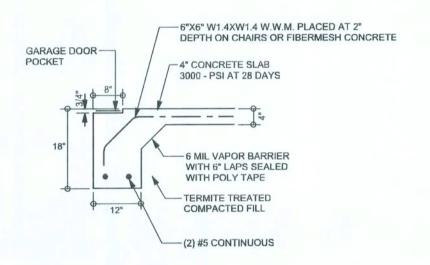





F9 STEM WALL FOOTING S-2 SCALE: 1/2" = 1'-0"

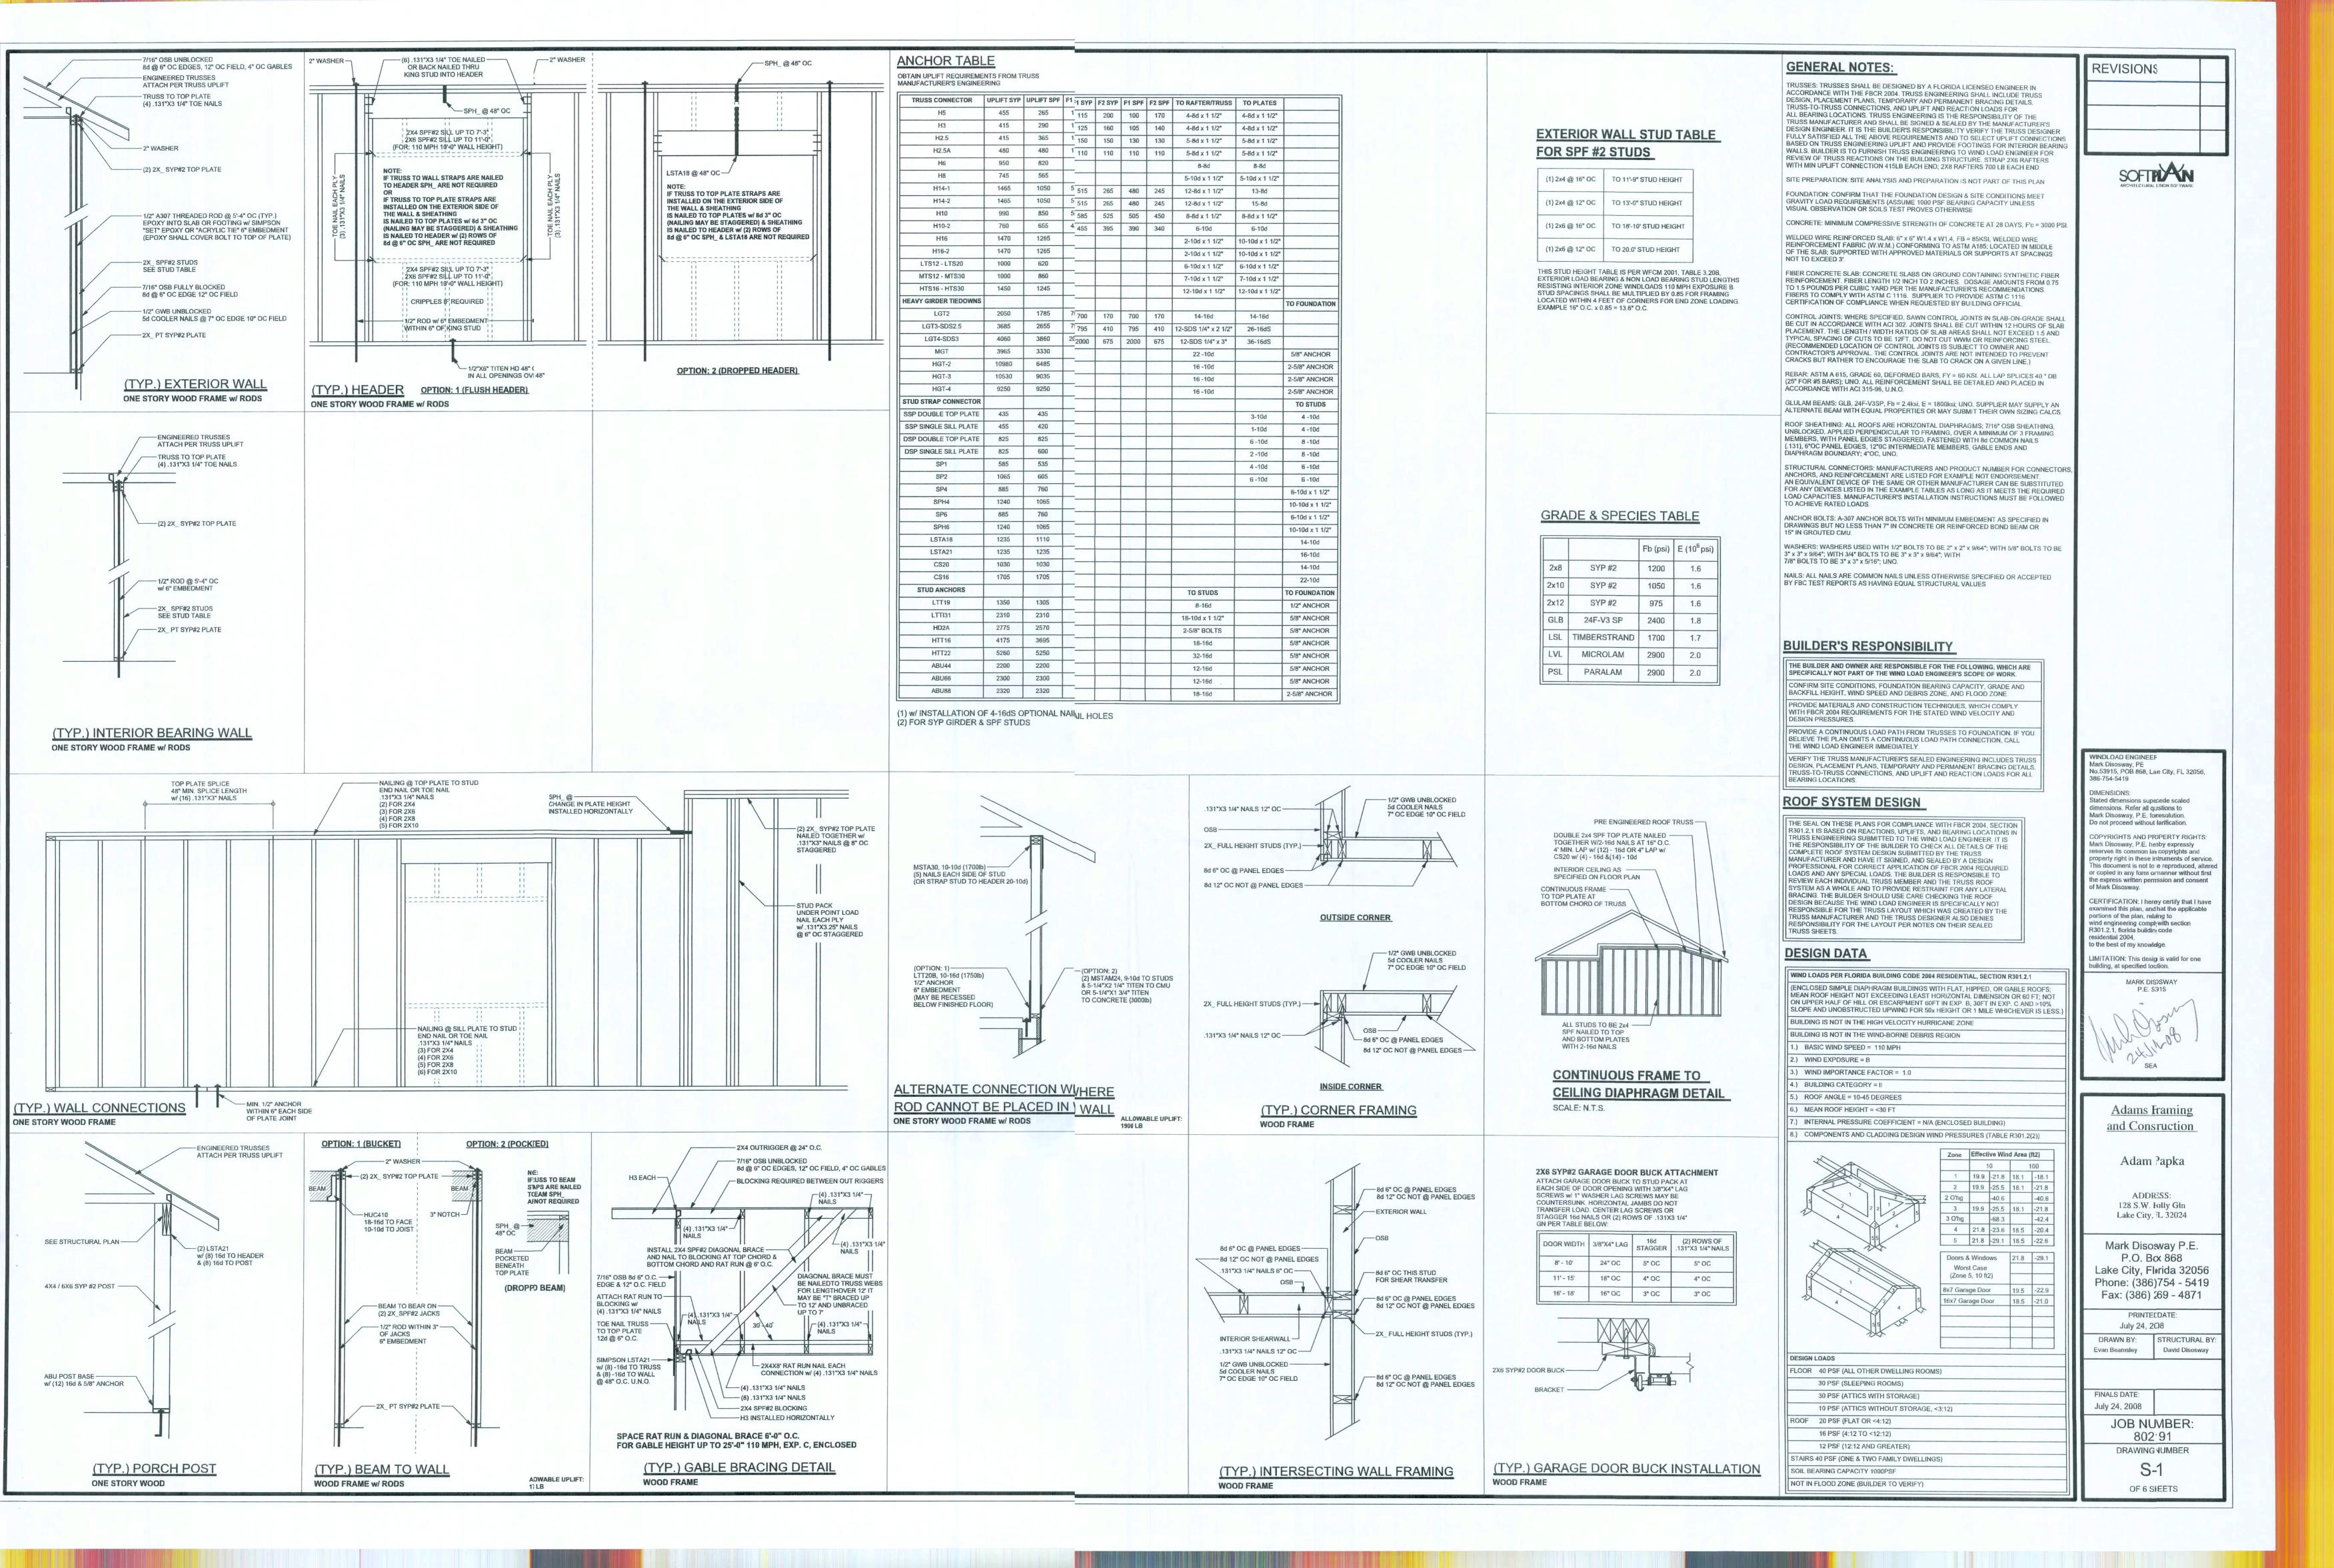


F12 ALT. STEM WALL PORCH FOOTING S-2 SCALE: 1/2" = 1'-0"

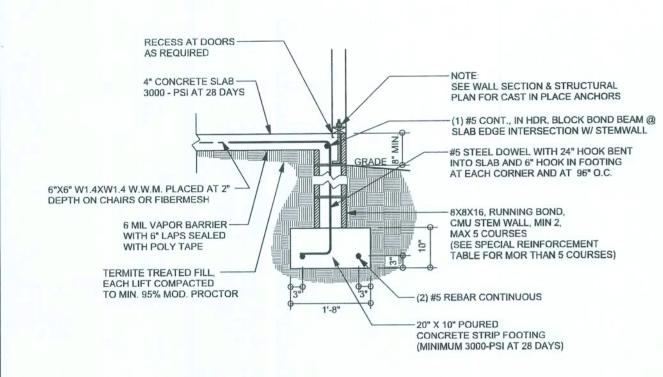

F4 GARAGE DOOR FOOTING S-2 SCALE: 1/2" = 1'-0"

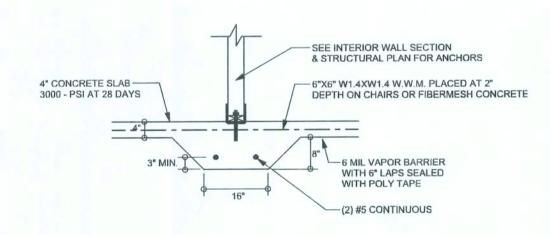

F2 INTERIOR BEARING FOOTING S-2 SCALE: 1/2" = 1'-0"

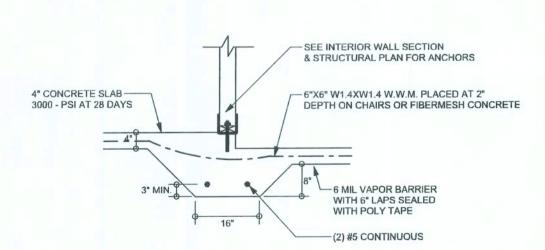



F3 INTERIOR BEARING STEP FOOTING
S-2 SCALE: 1/2" = 1'-0"

TALL STM WALL TABLE

The table assume 0 ksi reinforcing bars with 6" hook in the footing and bent 24" into the reinforced slab at: top. The vertical steel is to be placed toward the tension side of the CMU wall (away in the soil pressure, within 2" of the exterior side of the wall). If the wall is over 8' high, addurowall ladder reinforcement at 16"OC vertically or a horizontal bond beam with 1#5 conuous at mid height. For higher parts of the wall 12" CMU may be used with reinforcemens shown in the table below.

| STEMWALL HEIGHT (FEET) | UNLANCED EKFILL :IGHT | VERTICAL REINFORCEMENT FOR 8" CMU STEMWALL (INCHES O.C.) | | | VERTICAL REINFORCEMENT FOR 12" CMU STEMWALL (INCHES O.C.) | | |
|------------------------------|-----------------------------|--|----|----|---|----|----|
| | | #5 | #7 | #8 | #5 | #7 | #8 |
| 3.3 | 3.0 | 96 | 96 | 96 | 96 | 96 | 96 |
| 4.0 | 3.7 | 96 | 96 | 96 | 96 | 96 | 96 |
| 4.7 | 4.3 | 88 | 96 | 96 | 96 | 96 | 96 |
| 5.3 | 5.0 | 56 | 96 | 96 | 96 | 96 | 96 |
| 6.0 | 5.7 | 40 | 80 | 96 | 80 | 96 | 96 |
| 6.7 | 6.3 | 32 | 56 | 80 | 56 | 96 | 96 |
| 7.3 | 7.0 | 24 | 40 | 56 | 40 | 80 | 96 |
| 8.0 | 7.7 | 16 | 32 | 48 | 32 | 64 | 80 |
| 8.7 | 8.3 | 8 | 24 | 32 | 24 | 48 | 64 |
| 9.3 | 9.0 | 8 | 16 | 24 | 16 | 40 | 48 |

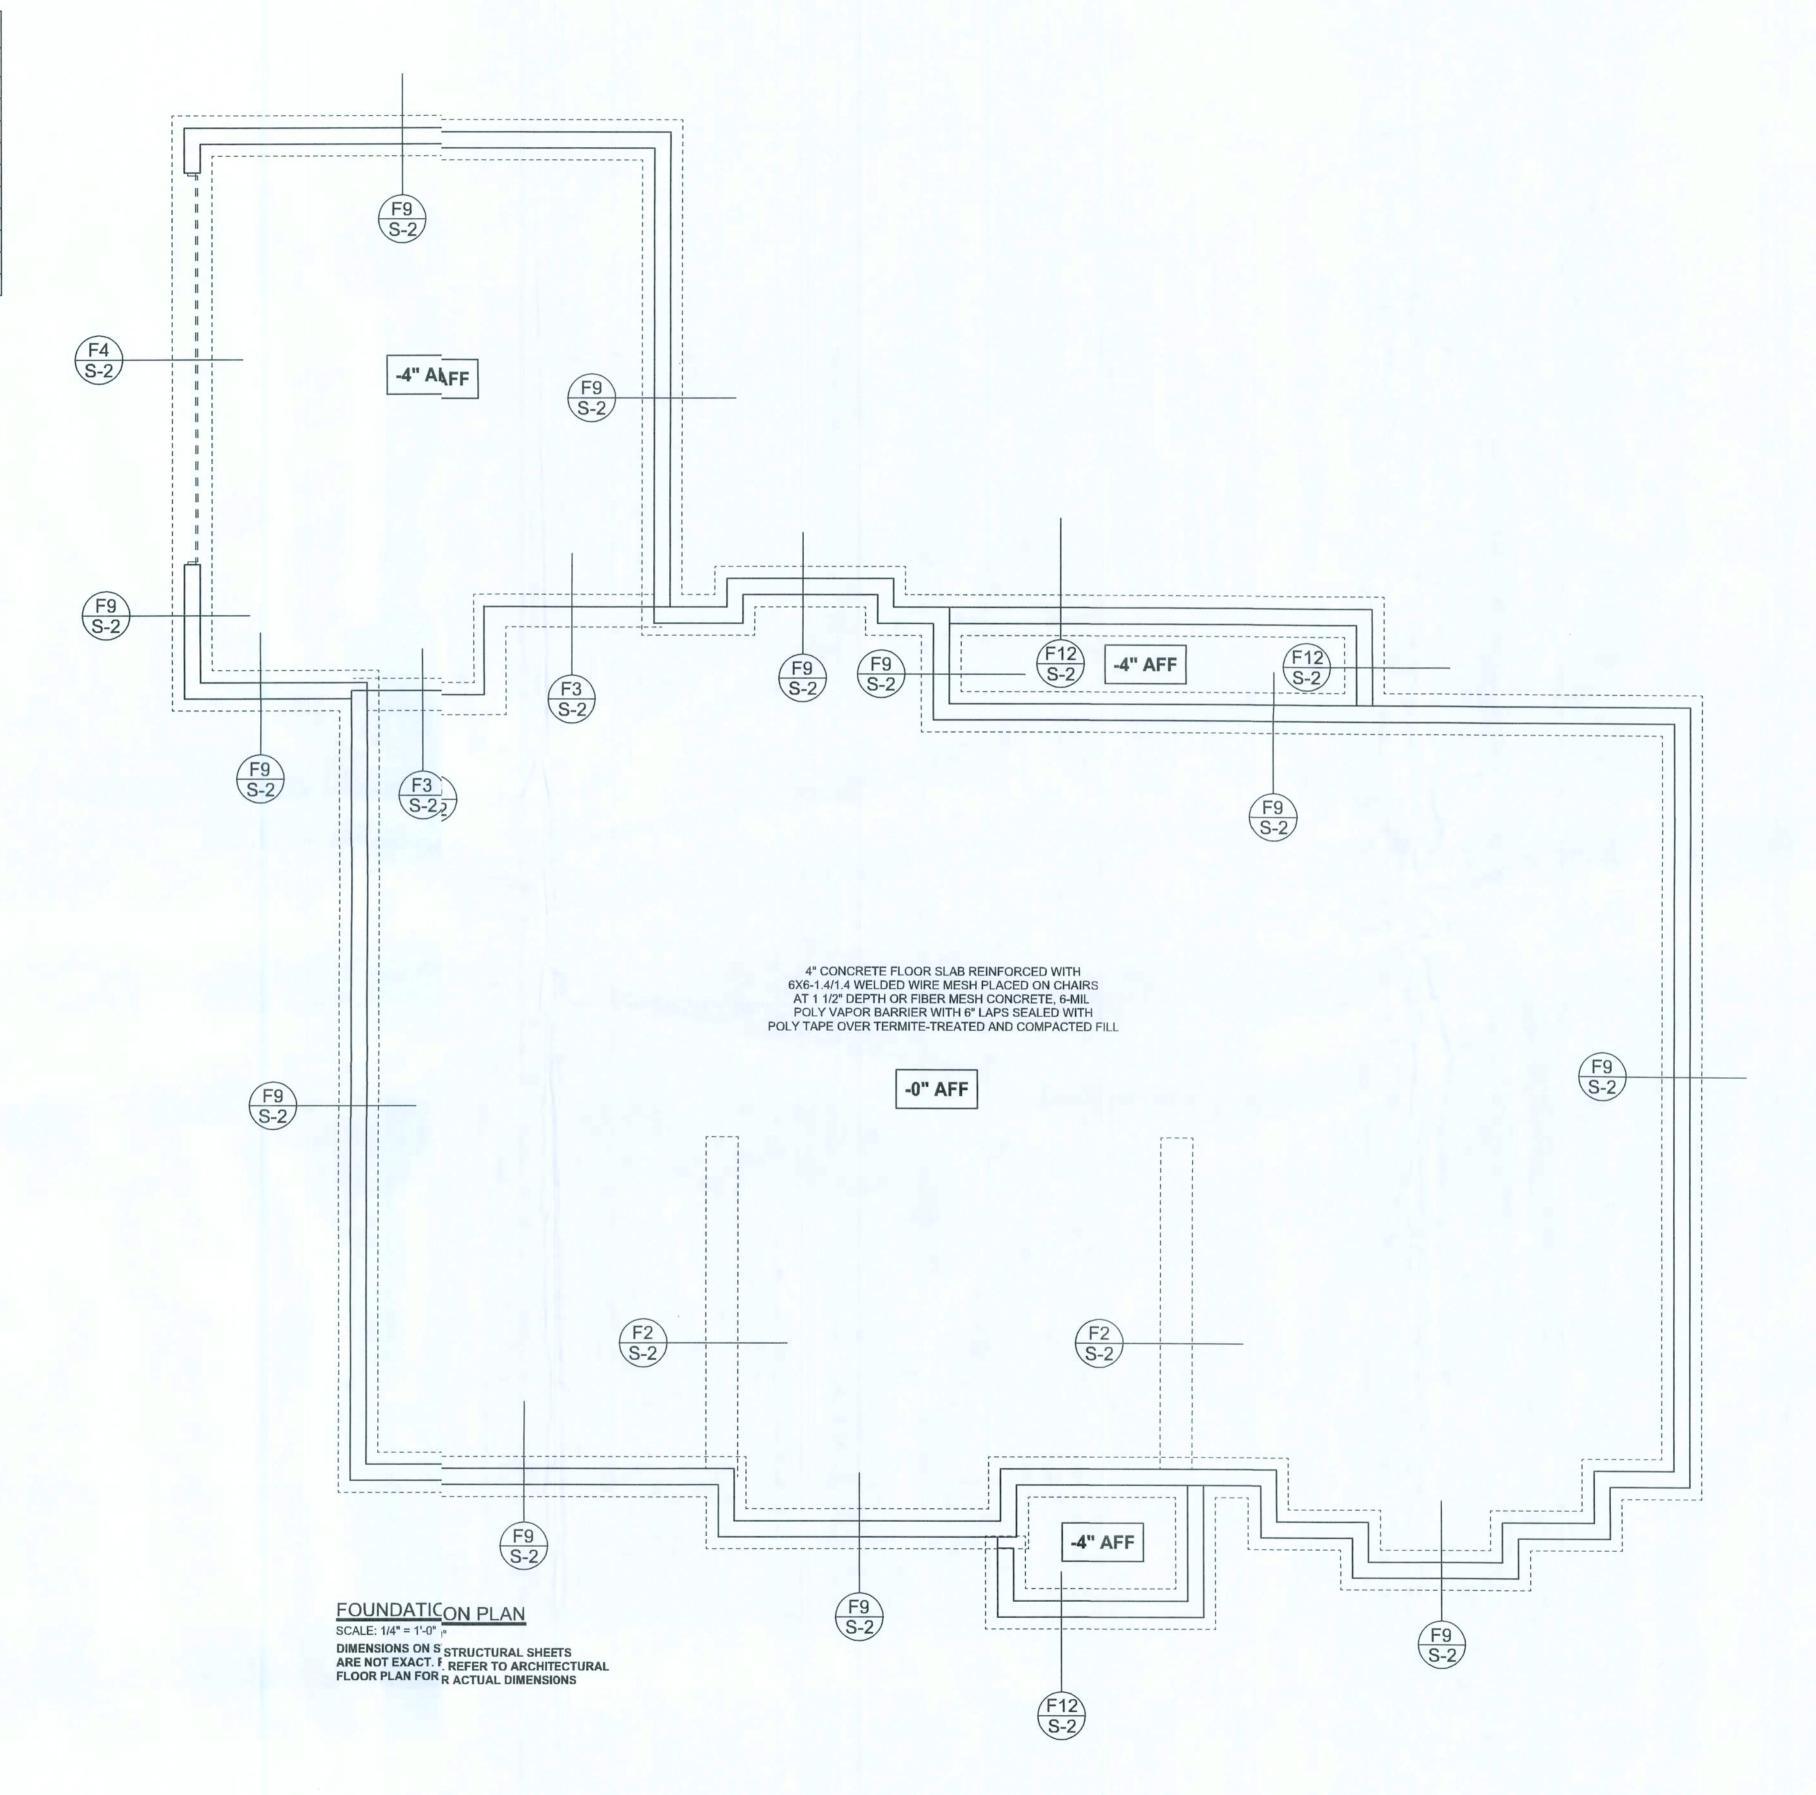

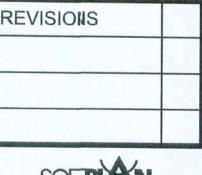

SOF PLAN ARCHITECTUAL DESIGN SOFTWARE

WINDLOAD ENGINER:
Mark Disosway, PE
No.53915, POB 868 Lake City, FL 32056,
386-754-5419

DIMENSIONS:
Stated dimensions spercede scaled dimensions. Refer a questions to Mark Disosway, P.E for resolution.
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CERTIFICATION: I lereby certify that I have examined this plan, not that the applicable portions of the plan, elating to wind engineering conply with section R301.2.1, florida builing code residential 2004, to the best of my knawledge.

LIMITATION: This disign is valid for one building, at specifiedocation.

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Adan Papka

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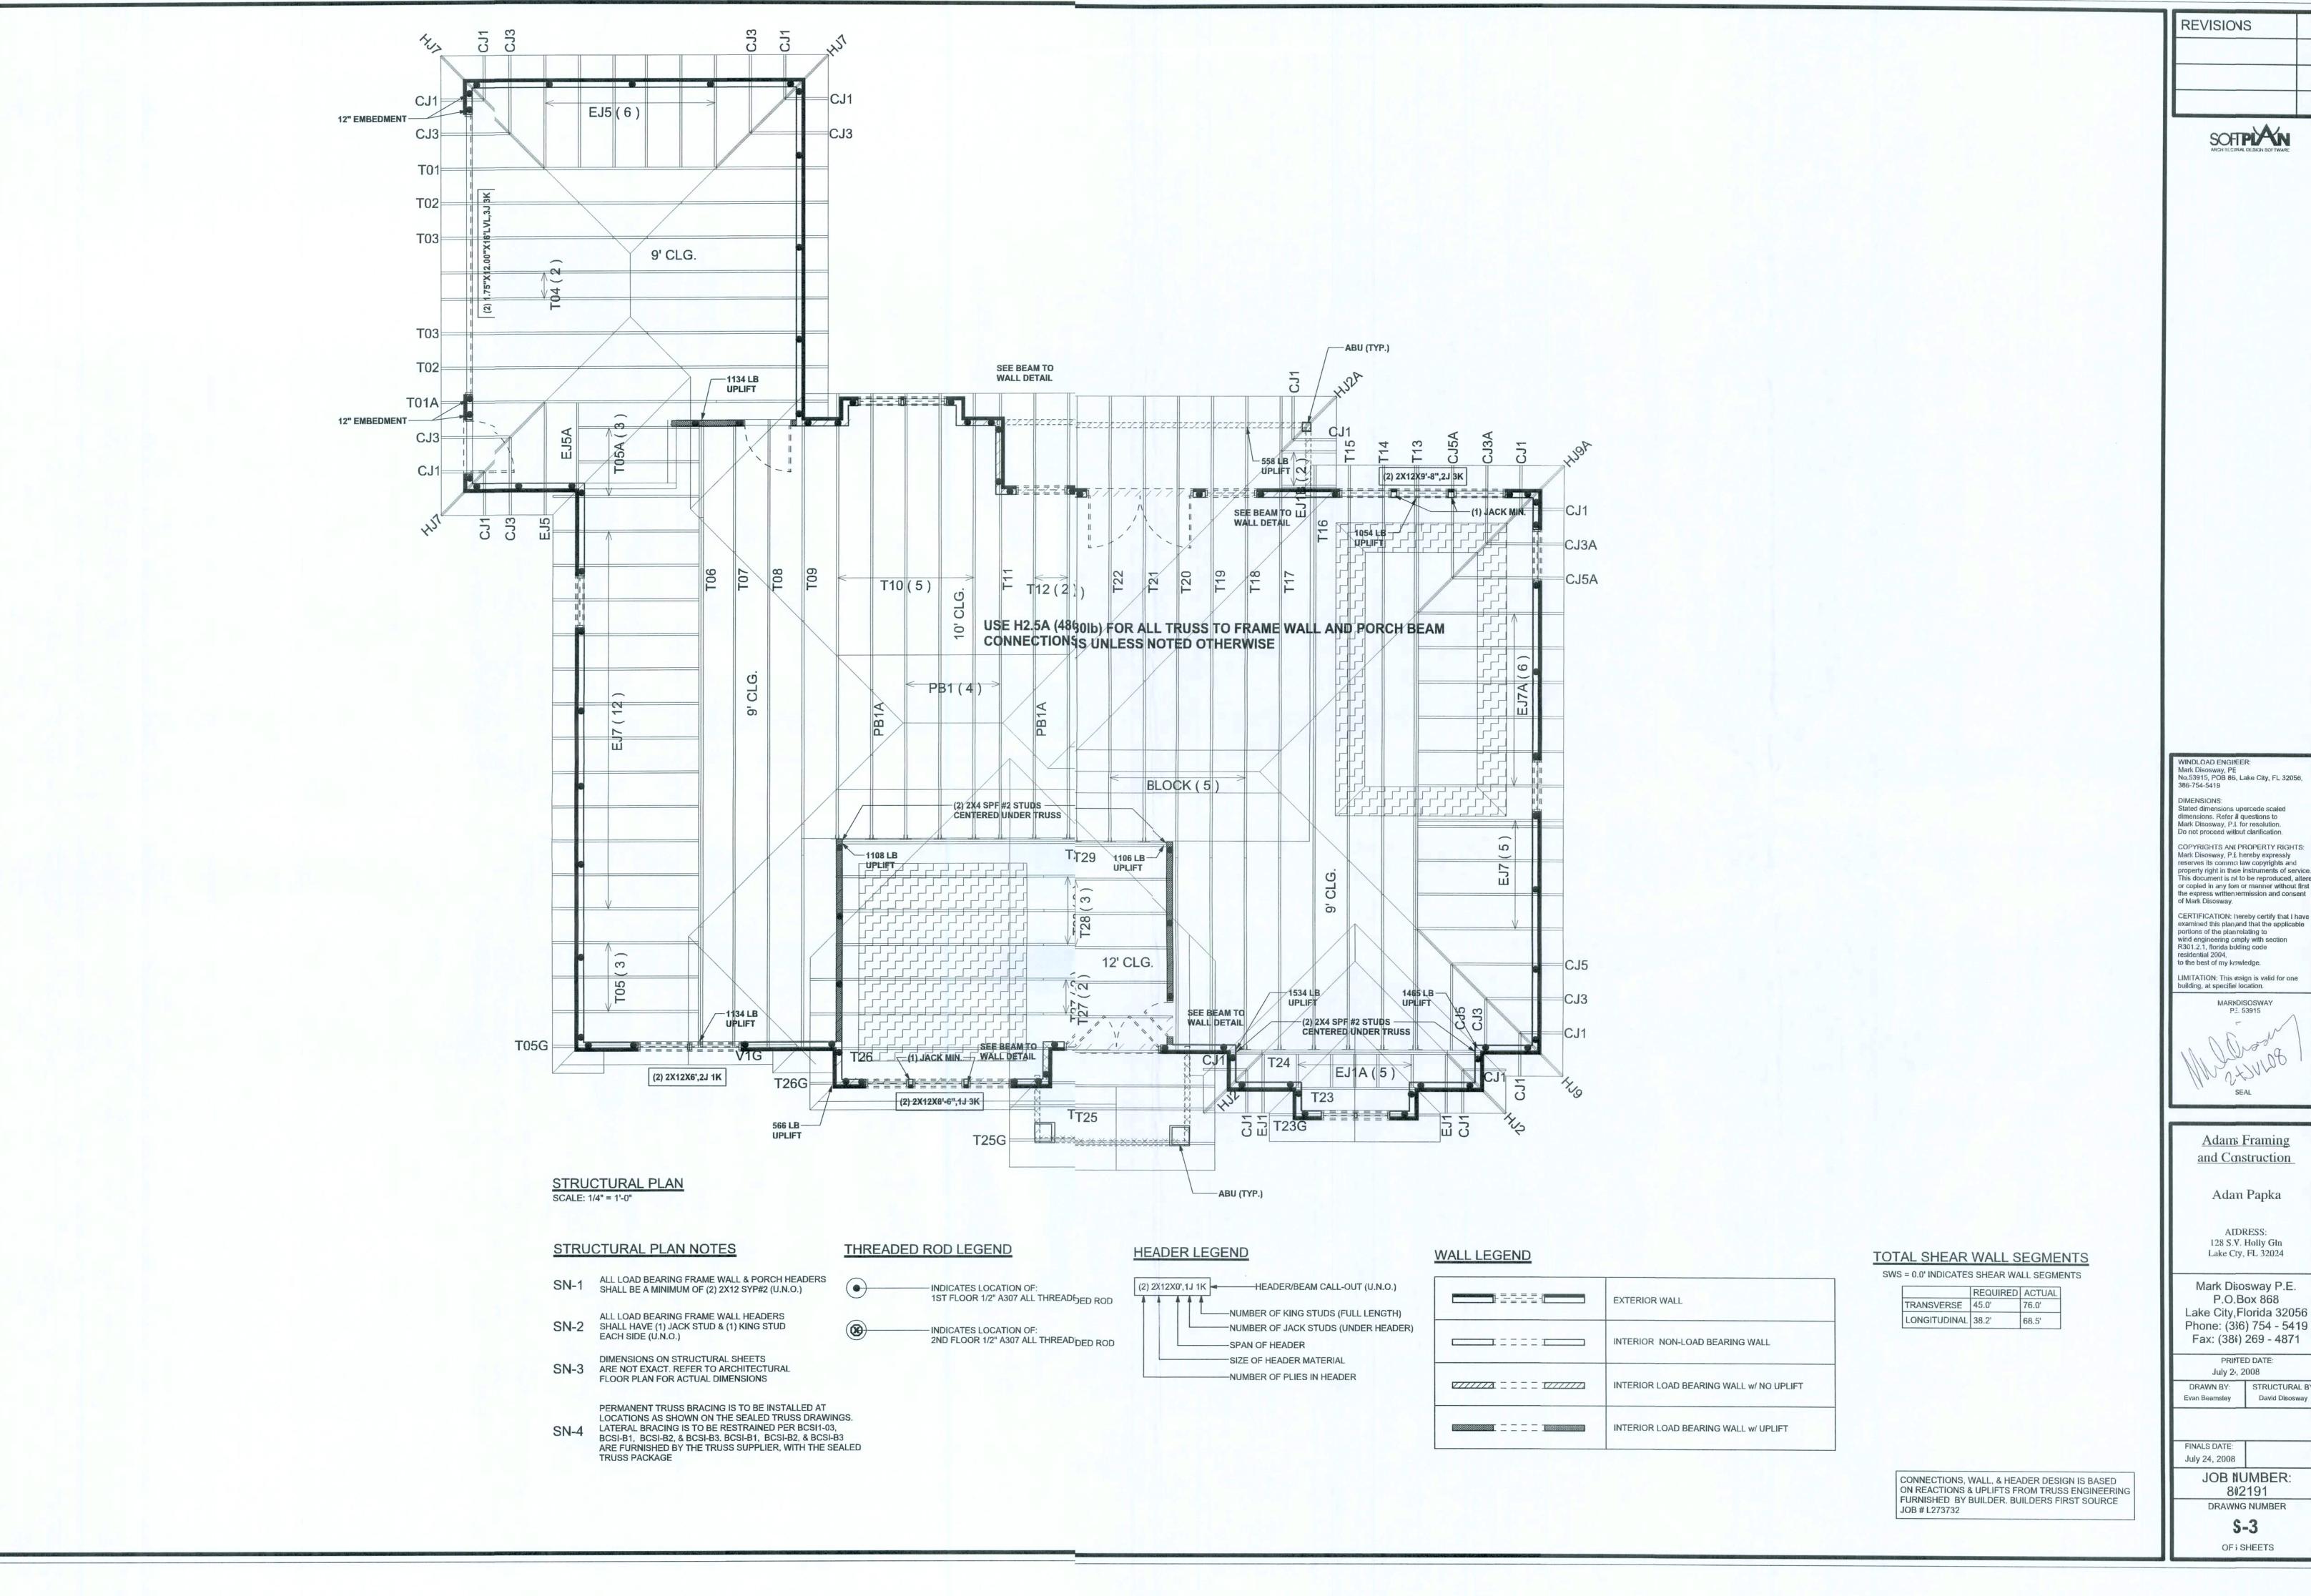
PRINTED DATE:
July 24 2008

DRAWN BY: STRUCTURAL BY:
Evan Beamsley David Disosway

FINALS DATE: July 24, 2008

JOB NUMBER: 8(2191 DRAWIIG NUMBER

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portions of the plan relating to wind engineering cmply with section R301.2.1, florida bulding code to the best of my knwledge.

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PRINTED DATE: July 24, 2008 DRAWN BY: STRUCTURAL BY: Evan Beamsley David Disosway

July 24, 2008

JOB NUMBER: 802191

> **S-3** OF; SHEETS