# **Columbia County New Building Permit Application**

For Office Use Only Application # 44429 Date Received 128 By Permit #39241
Zoning Official / W Date 1-39-30 Flood Zone X Land Use Aq Zoning A-3
FEMA Map # Elevation MFE River Plans Examiner_ 7.C Date 2-4.20
comments non habitable structure
NOC ( FH Deed or PA ( Site Plan   State Road Info   Well-letter   911 Sheet   Parent Parcel #
Dev Permit # In Floodway Letter of Auth. from Contractor F W Comp. letter
wner Builder Disclosure Statement   Land Owner Affidavit   Ellisville Water App Fee Paid   Sub VF Form
Septic Permit No. 20.0072 OR City Water Fax
Applicant (Who will sign/pickup the permit) BOBSY + TON! MASON Phone 352. 339. 0924
Address 675 SKI MORNING STAP GIN. 77 White, 41 32038
Owners Name Same As Abov & Phone 352 339, 0924
911 Address 675 SW Morging Stan GIN. FL Whili 91 32038
Contractors Name Bobby & Jon; MASOn Phone 352. 339. 0924
Address 675 SW Morning Stan GIN A. White, JL 32038
Contractor Email Boop ythor. eom. ***Include to get updates on this job.
Fee Simple Owner Name & Address
Bonding Co. Name & Address
Architect/Engineer Name & Address WAYNE S. MOURE PE-
Mortgage Lenders Name & Address 631 SE Indistrial Ca LAKE CRG \$13201
Circle the correct power company FL Power & Light Clay Elec. Suwannee Valley Elec. Duke Energy
Property ID Number 34. 58-16. 03757- 109 Estimated Construction Cost 341066
Subdivision Name SHANNA LIGADOUS Lot 9 Block Unit Phase
Driving Directions from a Major Road
675 SIN MORNING SAN GIN
Construction of METAL Storage Blui 1819 Commercial OR V Residential
Proposed Use/Occupancy Stora & Grange Number of Existing Dwellings on Property
Is the Building Fire Sprinkled? If Yes, blueprints included Or Explain
Circle Proposed Culvert Permit or Culvert Waiver or D.O.T. Permit or Have an Existing Drive
Actual Distance of Structure from Property Lines - Front Side
Number of Stories Heated Floor Area Total Floor Area 1500 Acreage 5.00
Zoning Applications applied for (Site & Development Plan, Special Exception, etc.)  \$292.81

#### **Columbia County Building Permit Application**

## CODE: Florida Building Code 2017 and the 2014 National Electrical Code.

Application is hereby made to obtain a permit to do work and installations as indicated. I certify that no work or installation has commenced prior to the issuance of a permit and that all work be performed to meet the standards of all laws regulating construction in this jurisdiction.

<u>TIME LIMITATIONS OF APPLICATION</u>: An application for a permit for any proposed work shall be deemed to have been abandoned 180 days after the date of filing, unless pursued in good faith or a permit has been issued.

<u>TIME LIMITATIONS OF PERMITS:</u> Every permit issued shall become invalid unless the work authorized by such permit is commenced within 180 days after its issuance, or if the work authorized by such permit is suspended or abandoned for a period of 180 days after the time work is commenced. A valid permit receives an approved inspection every 180 days. Work shall be considered not suspended, abandoned or invalid when the permit has received an approved inspection within 180 days of the previous approved inspection.

FLORIDA'S CONSTRUCTION LIEN LAW: Protect Yourself and Your Investment: According to Florida Law, those who work on your property or provide materials, and are not paid-in-full, have a right to enforce their claim for payment against your property. This claim is known as a construction lien. If your contractor fails to pay subcontractors or material suppliers or neglects to make other legally required payments, the people who are owed money may look to your property for payment, even if you have paid your contractor in full. This means if a lien is filed against your property, it could be sold against your will to pay for labor, materials or other services which your contractor may have failed to pay.

**NOTICE OF RESPONSIBILITY TO CONTRACTOR AND AGENT:**YOU ARE HEREBY NOTIFIED as the recipient of a building permit from Columbia County, Florida, you will be held responsible to the County for any damage to sidewalks and/or road curbs and gutters, concrete features and structures, together with damage to drainage facilities, removal of sod, major changes to lot grades that result in ponding of water, or other damage to roadway and other public infrastructure facilities caused by you or your contractor, subcontractors, agents or representatives in the construction and/or improvement of the building and lot for which this permit is issued. No certificate of occupancy will be issued until all corrective work to these public infrastructures and facilities has been corrected.

WARNING TO OWNER: YOUR FAILURE TO RECORD A NOTICE OF COMMENCEMENT MAY RESULT IN YOU PAYING TWICE FOR IMPROVEMENTS TO YOUR PROPERTY. A NOTICE OF COMMENCEMENT MUST BE RECORDED AND POSTED ON THE JOB SITE BEFORE THE FIRST INSPECTION. IF YOU INTEND TO OBTAIN FINANCING, CONSULT WITH YOUR LENDER OR ATTORNEY BEFORE RECORDING YOUR NOTICE OF COMMENCEMENT.

OWNERS CERTIFICATION: I CERTIFY THAT ALL THE FOREGOING INFORMATION IS ACCURATE AND THAT ALL WORK WILL BE DONE IN COMPLIANCE WITH ALL APPLICABLE LAWS REGULATING CONSTRUCTION AND ZONING.

NOTICE TO OWNER: There are some properties that may have deed restrictions recorded upon them. These restrictions may limit or prohibit the work applied for in your building permit. You must verify if your property is encumbered by any restrictions or face possible litigation and or fines.

De Cont and Added	race possible illigation and or lines.	
BOBBA M. MAZON	But When	**Property owners must sign here
TONI M. MASON	Doni m mason	<u>before</u> any permit will be issued
Print Owners Name	Owners Signature	any permit will be located

<u>CONTRACTORS AFFIDAVIT</u>: By my signature I understand and agree that I have informed and provided this written statement to the owner of all the above written responsibilities in Columbia County for obtaining this Building Permit including all application and permit time limitations.

Contractor's Signature	Contractor's License Number  Columbia County  Competency Card Number
Affirmed under penalty of perjury to by the Contractor an	
Personally known or Produced Identification	SEAL:
State of Florida Notary Signature (For the Contractor)	

<sup>\*\*</sup>If this is an Owner Builder Permit Application then, ONLY the owner can sign the building permit when it is issued.

Aerial Viewer

**Pictometery** 

# **Columbia County Property Appraiser**

Jeff Hampton
Parcel: << 34-5\$-16-03752-109 >>>

2020 Working Values updated: 1/6/2020

Owner & Property Info Result: 1 of 15 MASON BOBBY W & TONI M Owner 675 SW MORINING STAR GLN FT WHITE, FL 32038 Site 675 MORNING STAR GLN, FORT WHITE LOT 9 SHANNA MEADOWS S/D. WD 1038-1855, WD 1038-1856, WD 1045-2209, QC 1048-858, WD 1214-941, Description\* 34-5S-16E Area Use Code\*\* SINGLE FAM (000100) Tax District 3

\*The <u>Description</u> above is not to be used as the Legal Description for this parcel in any legal transaction.

transaction.

"The <u>Use Code</u> is a FL Dept. of Revenue (DOR) code and is not maintained by the Property Appraiser's office. Please contact your city or county Planning & Zoning office for specific zoning information.

• 2019 © 2016 🔾 2013 🔾 2010	2007 2005 Sales
+	
-	
	A 20
	A TOO NING ST
700	SW MORNING ST
2017-08-45 \$330,000 WD1-0-01	

Google Maps

Property &	Assessment Values		
2019	Certified Values	2020	Working Values
Mkt Land (1)	\$27,000	Mkt Land (1)	\$27,000
Ag Land (0)	\$0	Ag Land (0)	\$0
Building (1)	\$200,763	Building (1)	\$205,210
XFOB (5)	\$23,496	XFOB (5)	\$22,812
Just	\$251,259	Just	\$255,022
Class	\$0	Class	\$0
Appraised	\$251,259	Appraised	\$255,022
SOH Cap [?]	\$16,075	SOH Cap [?]	\$12,782
Assessed	\$235,184	Assessed	\$242,240
Exempt	HX H3 OTHER \$235,184	Exempt	HX H3 OTHER \$242,240
Total Taxable	county:\$0 city:\$0 other:\$0 school:\$0		county:\$0 city:\$0 other:\$0 school:\$0

Sales History							
Sale Date	Sale Price	Book/Page	Deed	V/I	Quality (Codes)	RCode	
5/2/2011	\$254,000	1214/0941	WD	I	Q	01	
6/1/2005	\$100	1048/0858	QC	V	Ü	01	
4/1/2005	\$100	1045/2209	QC	V	U	01	
2/17/2005	\$33,500	1038/1856	WD	V	Q		
2/14/2005	\$28,000	1038/1855	WD	V	U	04	

# Building Characteristics Bldg Sketch Bldg Item Bldg Desc\* Year Blt Base SF Actual SF Bldg Value Sketch 1 SINGLE FAM (000100) 2006 2293 3718 \$205,210

\*Bldg Desc determinations are used by the Property Appraisers office solely for the purpose of determining a promerty's Just Value for ad valorem tax our used for any other purpose.

Extra F	eatures & Out Buildin	gs (Codes)				
Code	Desc	Year Bit	Value	Units	Dims	Condition (% Good
0166	CONC,PAVMT	2006	\$2,032.00	1016.000	0 x 0 x 0	(000.00)
0282	POOL ENCL	2006	\$7,020.00	1560.000	26 x 60 x 0	(000 00)
0280	POOL R/CON	2006	\$10,260.00	450.000	15 x 30 x 0	(000.00)
0031	BARN,MT AE	2014	\$3,200.00	1.000	0 x 0 x 0	(000.00)
0294	SHED WOOD/	2014	\$300.00	1.000	0 x 0 x 0	(00,000)

▼ Land Breakdown							
Land Code	Desc	Units	Adjustments	Eff Rate	Land Value		
000100	SFR (MKT)	1.000 LT - (5.000 AC)	1.00/1.00 1.00/1.00	\$27,000	\$27,000		

Search Result: 1 of 15

Columbia County Property Appraiser | Jeff Hampton | Lake City, Florida | 386-758-1083

hv



#### **COLUMBIA COUNTY BUILDING DEPARTMENT**

135 NE Hernando Ave., Suite B-21 Lake City, FL 32055

Office: 386-758-1008 Fax: 386-758-2160

#### **OWNER BUILDER DISCLOSURE STATEMENT**

#### Florida Statutes Chapter 489.103:

- 1. I understand that state law requires construction to be done by a licensed contractor and have applied for an owner-builder permit under an exemption from the law. The exemption specifies that I, as the owner of the property listed, may act as my own contractor with certain restrictions even though I do not have a license.
- 2. I understand that building permits are not required to be signed by a property owner unless he or she is responsible for the construction and is not hiring a licensed contractor to assume responsibility.
- 3. I understand that, as an owner-builder, I am the responsible party of record on a permit. I understand that I may protect myself from potential financial risk by hiring a licensed contractor and having the permit filed in his or her name instead of my own name. I also understand that a contractor is required by law to be licensed in Florida and to list his or her license numbers on permits and contracts.
- 4. I understand that I may build or improve a one-family or two-family residence or a farm outbuilding. I may also build or improve a commercial building if the costs do not exceed \$75,000. The building or residence must be for my own use or occupancy. It may not be built or substantially improved for sale or lease, unless I am completing the requirements of a building permit where the contractor listed on the permit substantially completed the project. If a building or residence that I have built or substantially improved myself is sold or leased within 1 year after the construction is complete, the law will presume that I built or substantially improved it for sale or lease, which violates the exemption.
- 5. I understand that, as the owner-builder, I must provide direct, onsite supervision of the construction.
- 6. I understand that I may not hire an unlicensed person to act as my contractor or to supervise persons working on my building or residence. It is my responsibility to ensure that the persons whom I employ have the licenses required by law and by county or municipal ordinance.

Revision Date: 8/15/2019

- 7. I understand that it is a frequent practice of unlicensed persons to have the property owner obtain an owner-builder permit that erroneously implies that the property owner is providing his or her own labor and materials. I, as an owner-builder, may be held liable and subjected to serious financial risk for any injuries sustained by an unlicensed person or his or her employees while working on my property. My homeowner's insurance may not provide coverage for those injuries. I am willfully acting as an owner-builder and am aware of the limits of my insurance coverage for injuries to workers on my property.
- 8. I understand that I may not delegate the responsibility for supervising work to a licensed contractor who is not licensed to perform the work being done. Any person working on my building who is not licensed must work under my direct supervision and must be employed by me, which means that I must comply with laws requiring the withholding of federal income tax and social security contributions under the Federal Insurance Contributions Act (FICA) and must provide workers' compensation for the employee. I understand that my failure to follow these laws may subject me to serious financial risk.
- 9. I agree that, as the party legally and financially responsible for this proposed construction activity, I will abide by all applicable laws and requirements that govern owner-builders as well as employers. I also understand that the construction must comply with all applicable laws, ordinances, building codes, and zoning regulations.
- 10. I understand that I may obtain more information regarding my obligations as an employer from the Internal Revenue Service, the United States Small Business Administration, the Florida Department of Financial Services, and the Florida Department of Revenue. I also understand that I may contact the Florida Construction Industry Licensing Board at 850-487-1395 or <a href="http://www.myfloridalicense.com/">http://www.myfloridalicense.com/</a> for more information about licensed contractors.
- 11. I am aware of, and consent to, an owner-builder building permit applied for in my name and understand that I am the party legally and financially responsible for the proposed construction activity at the following address:

(Write in the address of jobsite property)

Revision Date: 8/15/2019

12. I agree to notify Columbia County Building Department immediately of any additions, deletions, or changes to any of the information that I have provided on this disclosure. Licensed contractors are regulated by laws designed to protect the public. If you contract with a person who does not have a license, the Construction Industry Licensing Board and Department of Business and Professional Regulation may be unable to assist you with any financial loss that you sustain as a result of a complaint. Your only remedy against an unlicensed contractor may be in civil court. It is also important for you to understand that, if an unlicensed contractor or employee of an individual or firm is injured while working on your property, you may be held liable for damages. If you obtain an owner-builder permit and wish to hire a licensed contractor, you will be responsible for verifying whether the contractor is properly licensed and the status of the contractor's workers' compensation coverage.

#### Florida Statutes Chapter 489.503:

State law requires electrical contracting to be done by licensed electrical contractors. You have applied for a permit under an exemption to that law. The exemption allows you, as the owner of your property, to act as your own electrical contractor even though you do not have a license. You may install electrical wiring for a farm outbuilding or a single-family or duplex residence. You may install electrical wiring in a commercial building the aggregate construction costs of which are under \$75,000. The home or building must be for your own use and occupancy. It may not be built for sale or lease, unless you are completing the requirements of a building permit where the contractor listed on the permit substantially completed the project. If you sell or lease more than one building you have wired yourself within 1 year after the construction is complete, the law will presume that you built it for sale or lease, which is a violation of this exemption. You may not hire an unlicensed person as your electrical contractor. Your construction shall be done according to building codes and zoning regulations. It is your responsibility to make sure that people employed by you have licenses required by state law and by county or municipal licensing ordinances.

An owner of property completing the requirements of a building permit, where the contractor listed on the permit substantially completed the project as determined by the local permitting agency, for a one-family or two family residence, townhome, accessory structure of a one-family or two-family residence or townhome or individual residential condominium unit or cooperative unit. Prior to the owner qualifying for the exemption, the owner must receive approval from the local permitting agency, and the local permitting agency must determine that the contractor substantially completed the project. An owner who qualifies for the exemption under this paragraph is not required to occupy the dwelling or unit for at least 1 year after the completion of the project.


Revision Date: 8/15/2019

Before a building permit shall be issued, this notarized disclosure statement must be completed and signed by the property owner and returned to the local permitting agency responsible for issuing the permit.

TYPE OF CONSTRUCTION () Single Family Dwelling () Two-Family Residence () Farm Outbuilding
() Addition, Alteration, Modification or other Improvement () Electrical  (VOther_Storngr Building
( ) Contractor substantially completed project, of a
( ) Commercial, Cost of Construction for construction of
BOBBY W. & TONI M. MASON  (Print Property Owners Name)  statement for exemption from contractor licensing as an owner/builder. I agree to comply with all requirements provided for in Florida Statutes allowing this exception for the construction permitted by Columbia County Building Permit.  Signature: Done Mason  (Signature of property owner)
NOTARY OF OWNER BUILDER SIGNATURE  The above signer is personally known to me or produced identification  Notary Signature About Date 17, 20  LAURIE HODSON MY COMMISSION # FF 978102 EXPIRES: July 14, 2020 Bonded Thru Notary Public Underwriters

# STATE OF FLORIDA DEPARTMENT OF HEALTH **APPLICATION FOR CONSTRUCTION PERMIT**

Permit Application Number 20-0874

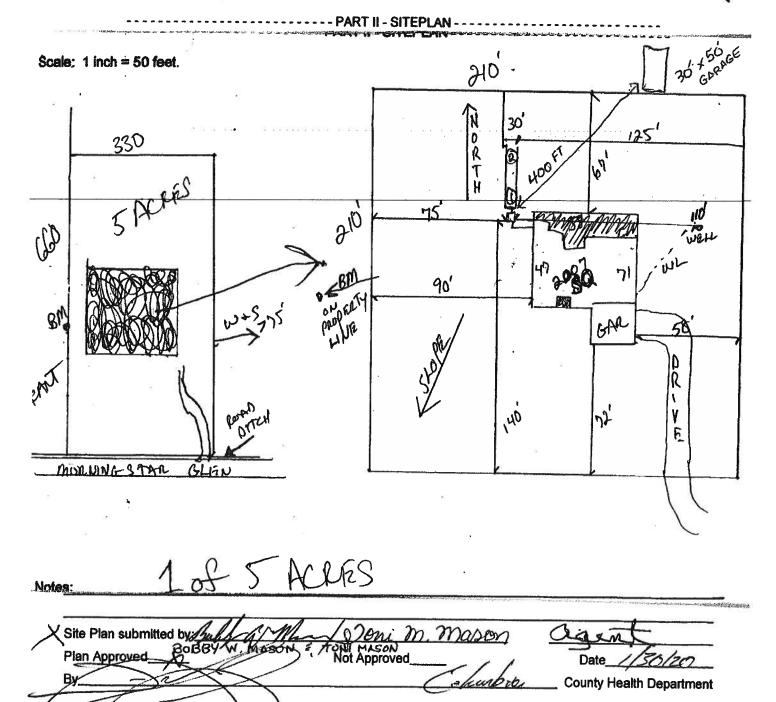

ALL CHANGES MUST BE APPROVED BY THE COUNTY HEALTH DEPARTMENT

DH 4015, 08/09 (Obsoletes previous editions which may not be used) Incorporated: 64E-6.001, FAC (Stock Number: 5744-002-4015-8)

Page 2 of 4

STATE OF FLORIDA

DEPARTMENT OF HEALTH ONSITE SEWAGE TREATMENT AND DISPOSAL SYSTEM APPLICATION FOR CONSTRUCTION PERMIT

PERMIT NO . DATE PAID :	20-2072
FEE PAID: RECEIPT #:	144

APPLICATION FOR:  [ ] New System [ X ] E [ ] Repair [ ] A	xisting System bandonment	m [	] Holding 1	ank [	] Innovative
APPLICANT: BOBBY W. MASC					
AGENT:	N/A			TELEPH	one:(352)339-092
MAILING ADDRESS: <u>675 SW</u> FORT W	MORNING HITE, FL.	STAR	GLEN		
TO BE COMPLETED BY APPLICANT BY A PERSON LICENSED PURSUAN APPLICANT'S RESPONSIBILITY TO PLATTED (MM/DD/YY) IF REQUES	T TO 489.105 (: O PROVIDE DOCE	3) (m) OR 4 UMENTATION	89.552, FLOR	THE LO	TUTES. IT IS THE
PROPERTY INFORMATION					
LOT: 9 BLOCK: N/A	SUBDIVISION:	SHANN	A MEADOW	5 '5/0	PLATTED:
PROPERTY ID #: 34-58-16	- 03752-109	2 ZONING	: <u>AG</u> 1	/M OR EQ	UIVALENT: [ X /N
property size: 5 acres	WATER SUPPLY	: [X] PRI	VATE PUBLIC	: [ ]<=:	2000GPD [ ]>2000GPD
IS SEWER AVAILABLE AS PER 38				ISTANCE	TO SEWER:FT
PROPERTY ADDRESS: 675 SW FORT V	MORNIN	IG STA	IR GLEN		
DIRECTIONS TO PROPERTY:	VHITE, FI	L. 320	38		
BUILDING INFORMATION	[X] RESIDE	NTIAL	[ ] COM	ŒRCIAL	1
Unit Type of No Establishment		Building Area Sqft	Commercial/I	Institut: opter 641	ional System Design E-6, FAC
1 GARAGE	-	500 Sqft	•		
2					
3	<del></del>		- With the British		
4	-	<del></del>			
[ ] Floor/Equipment Drains	[ ] Other	c (Specify	)		
SIGNATURE: Maly a Ma	Doni	mase	m	DAT	E: 01/28/20
BOBBY W. MASON / DH 4015, 08/09 (Obsoletes pr Incorporated 64E-6.001, FAC	TON M. evious edition	MASON ns which n	ay not be u	sed)	Page 1 of 4





# STRUCTURAL DESIGN

# ENCLOSED BUILDING EXPOSURE B

# MAXIMUM 30'-0" WIDE X 20'-0" EAVE HEIGHT- BOX EAVE FRAME AND BOW FRAME

18 December 2017 Revision 4 M&A Project No. 16022S/17300S

Prepared for:

Tubular Building Systems, LLC 631 SE Industrial Circle Lake City, Florida 32025

Prepared by:

Moore and Associates Engineering and Consulting, Inc. 1009 East Avenue North Augusta, SC 29841

> 401 S. Main Street, Suite 200 Mount Airy, NC 27030





				LULINE S. MOOR
				No 57170 OCT 1 6 2019 STATE OF
MOORE AND ENGINEERING AND	ASSOCIATES CONSULTING, INC.	DRAWN BY: LT	30'-0"x20'-	ULAR BUILDING SYSTEMS -0" ENCLOSED BUILDING EXP. B PE SEAL COVER SHEET
THIS DOCUMENT IS THE PROPERTY OF MOOR CONSULTING. THE UNAUTHORIZED REPRODUCT THIS DOCUMENT IS STRICTLY PROHIBITED AS SUBJECT TO LEGAL ACTION.	E AND ASSOCIATES ENGINEERING AND ION, COPYING, OR OTHERVISE USE OF ND ANY INFRINGEMENT THEREUPON MAY	PROJECT HGR: VSH CLIENT: TBS	DATE: 12-18-17 SHT. 1	JOB NO: SCALE: NTS 160225/173005 DVG. NO: SK-3 REV.: 4

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SHEET 2	DRAWING INDEX
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SHEET 4	TYPICAL SIDE AND END ELEVATIONS
SHEET 5	TYPICAL RAFTER COLUMN END AND SIDE FRAMING SECTIONS (BOX EAVE RAFTER)
SHEET 6A	TYPICAL RAFTER COLUMN CONNECTION DETAILS (LACED COLUMN)
SHEET 6B	TYPICAL RAFTER COLUMN CONNECTION DETAILS (DOUBLE COLUMN)
SHEET 6C	TYPICAL RAFTER COLUMN CONNECTION DETAILS (SINGLE COLUMN)
SHEET 7	TYPICAL RAFTER COLUMN END AND SIDE FRAMING SECTIONS (BOW RAFTER)
SHEET 8A	TYPICAL RAFTER COLUMN CONNECTION DETAILS (DOUBLE COLUMN)
SHEET 8B	TYPICAL RAFTER COLUMN CONNECTION DETAILS (SINGLE COLUMN)
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SHEET 10	TYPICAL END WALL AND SIDE WALL OPENING FRAMING SECTIONS (BOX EAVE RAFTER)
SHEET 11	TYPICAL END WALL AND SIDE WALL OPENING FRAMING SECTIONS (BOW RAFTER)
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SHEET 13	LEAN-TO OPTIONS (BOX EAVE RAFTER)
SHEET 14	LEAN-TO OPTIONS (BOW RAFTER)
SHEET 15	VERTICAL ROOF/SIDING OPTION END AND SIDE ELEVATION AND SECTION
SHEET 16	OPTIONAL DOOR HEADER



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#### INSTALLATION NOTES AND SPECIFICATIONS

- 1. DESIGN IS FOR A MAXIMUM 30'-0' WIDE x 20'-0' EAVE HEIGHT ENCLOSED STRUCTURES.
- 2. DESIGN WAS DONE IN ACCORDANCE WITH THE 2017 FLORIDA BUILDING CODE (FBC) 6TH EDITION, 2012 INTERNATIONAL BUILDING CODE (IBC), AND 2015 IBC
- 3: DESIGN LOADS ARE AS FOLLOWS: A) DEAD LOAD = 1.5 PSF
  - = 12 PSF B) LIVE LOAD C) GROUND SNOW LOAD = 10 PSF
- 4. LOW ULTIMATE WIND SPEED 105 TO 140 MPH (NOMINAL WIND SPEED 81 TO 108 MPH): MAXIMUM RAFTER/POST AND END POST SPACING = 5.0 FEET.
- 5. HIGH ULTIMATE WIND SPEED 141 TO 170 MPH (NOMINAL WIND SPEED 109 TO 132 MPH): MAXIMUM RAFTER/POST AND END POST SPACING = 4.0 FEET.
- 6. LOW HAZARD RISK CATEGORY I (WIND).
- 7. WIND EXPOSURE CATEGORY B.
- 8 SPECIFICATIONS APPLICABLE TO 29 GAUGE METAL PANELS FASTENED DIRECTLY TO 2 1/2' x 2 1/2' 14 GAUGE TUBE STEEL (TS) FRAMING MEMBERS. FOR VERTICAL PANELS, 29 GAUGE METAL PANELS SHALL BE FASTENED TO 18 GAUGE HAT CHANNELS (UNLESS OTHERWISE NOTED).
- 9. AVERAGE FASTENER SPACING ON-CENTERS ALONG RAFTERS OR PURLINS, AND POSTS, INTERIOR = 9° OR END = 6°, (MAX.)
- 10. FASTENERS CONSIST OF #12-14x3/4" SELF-DRILLING FASTENER (SDF), USE CONTROL SEAL WASHER WITH EXTERIOR FASTENERS. SPECIFICATIONS APPLICABLE ONLY FOR MEAN ROOF HEIGHT OF 20 FEET OR LESS, AND ROOF SLOPES OF 14" (3:12 PITCH) OR LESS SPACING REQUIREMENTS FOR OTHER ROOF HEIGHTS AND/OR SLOPES MAY VARY.
- 11 GROUND ANCHORS SHALL BE INSTALLED THROUGH BASE RAIL WITHIN 6' OF EACH RAFTER COLUMN ALONG SIDES.
- 12 GROUND ANCHORS (SDIL NAILS) CONSIST OF #4 REBAR W/WELDED NUT x 30' LONG IN SUITABLE SDIL CONDITIONS MAY BE USED FOR LOW ( ≤ 108 MPH NDMINAL) WIND SPEEDS ONLY. OPTIONAL ANCHORAGE MAY BE USED IN SUITABLE SDILS AND MUST BE USE IN UNSUITABLE SDILS AS NOTED
- 13 OPTIONAL BASE RAIL ANCHORAGE MAY BE USED FOR LOW AND MUST BE USED FOR HIGH WIND SPEEDS
- 14. WIND FORCES GOVERN OVER SEISMIC FORCES SEISMIC PARAMETERS ANALYZED ARE

SDIL SITE CLASS = D RISK CATEGORY I/II/III

R= 3.25


I<sub>E</sub>= 10 S<sub>DS</sub>= 1.522 V= C<sub>s</sub>W

Sp!= 0.839




MOORE AND ASSOCIATES ENGINEERING AND CONSULTING, INC.	DRAWN BY: LT	TUBULAR BUILDING SYSTEMS 30'-0"x20'-0" ENCLOSED BUILDING EXP. B			
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THIS DOCUMENT IS STRICTLY PROHIBITED AND ANY INFRINGEMENT THEREUPON MAY BE SUBJECT TO LEGAL ACTION.	CLIENT: TBS	SHT. 3	DWG. NO: SK-3	REV= 4	

# BOX EAVE FRAME RAFTER ENCLOSED BUILDING

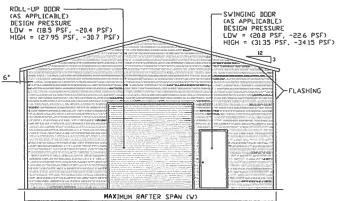


## TYPICAL END ELEVATION-HORIZONTAL ROOF


# BOW FRAME RAFTER ENCLOSED BUILDING

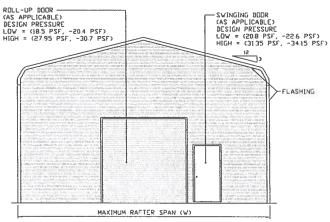

# TYPICAL END ELEVATION

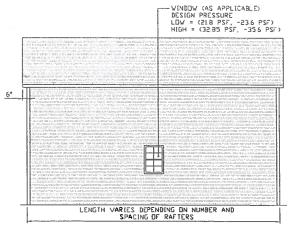

TYPICAL SIDE ELEVATION

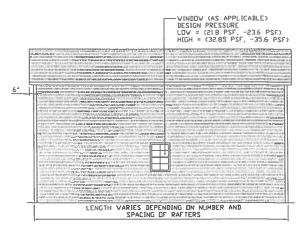


# TYPICAL SIDE ELEVATION-HORIZONTAL ROOF

6 2019

MOORE AND ASSOCIATES
ENGINEERING AND CONSULTING, INC.


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┛	PROJECT MGR: VSM	DATE: 12-18-17	SCALE: NTS		NO: 225/17300S				
	CLIENT: TBS	SHT. 4	DVG. NO: SK-3		REV.: 4				

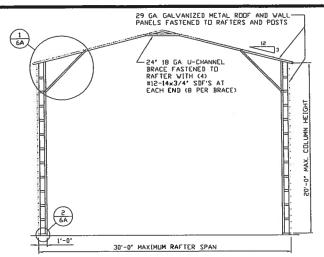


### TYPICAL RAFTER/COLUMN END FRAME SECTION

SCALE: NTS

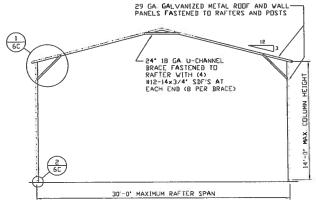


## TYPICAL RAFTER/COLUMN END FRAME SECTION

SCALE: NTS

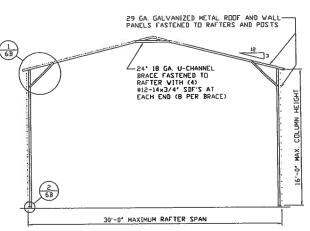

#### TYPICAL RAFTER/COLUMN END FRAME SECTION

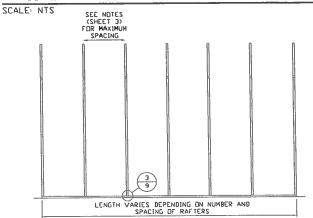



TYPICAL RAFTER/COLUMN SIDE FRAMING SECTION

SCALE: NTS



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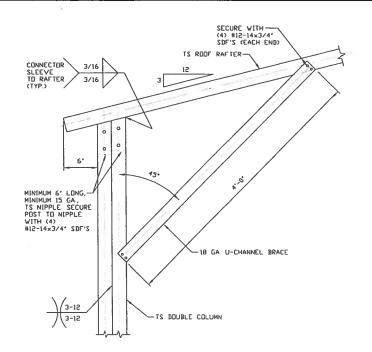


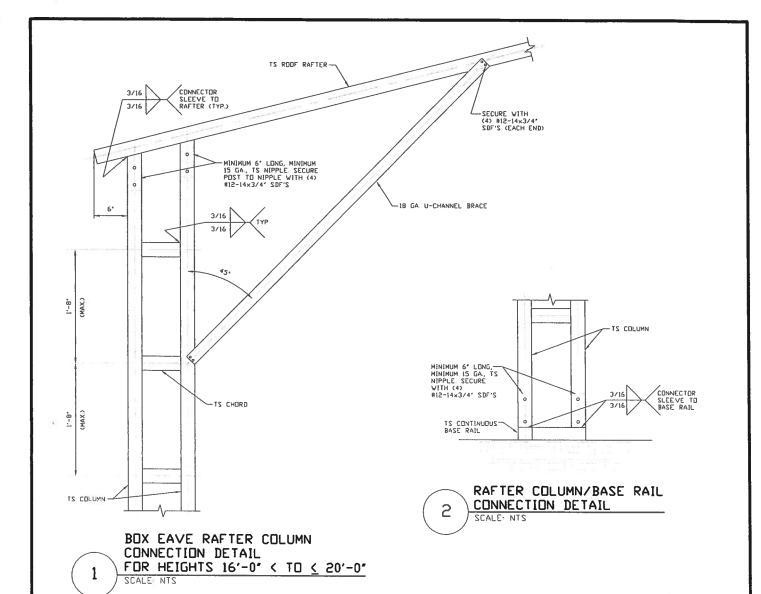

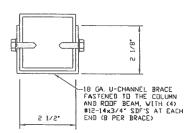
BRACE SECTION




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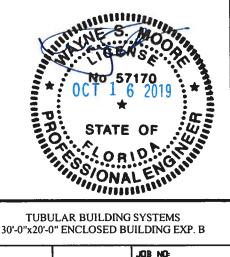
BOX EAVE RAFTER COLUMN CONNECTION DETAIL FOR HEIGHTS 14'-0" < TO ≤ 16'-0" 1 SCALE: NTS




RAFTER COLUMN/BASE RAIL CONNECTION DETAIL 2 SCALE: NTS

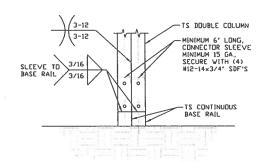


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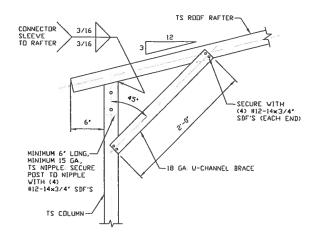
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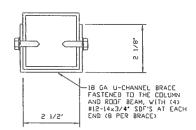
BOX EAVE RAFTER COLUMN CONNECTION DETAIL FOR HEIGHTS 10'-0' < TO < 14'-0'

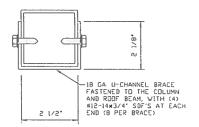

RAFTER COLUMN/BASE RAIL CONNECTION DETAIL
SCALE: NTS

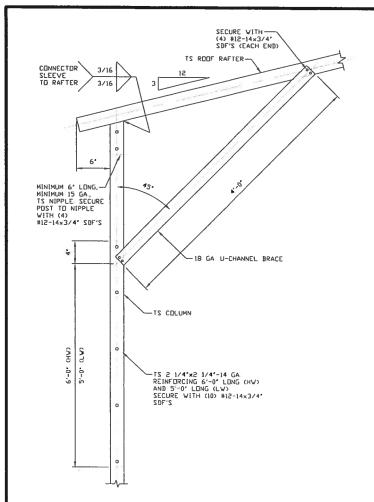


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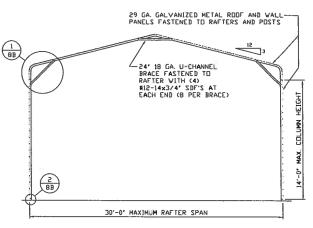


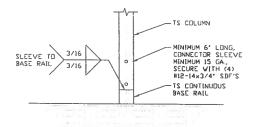BRACE SECTION



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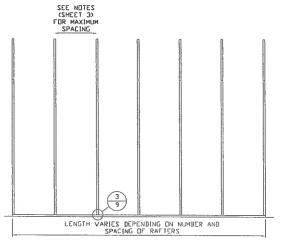


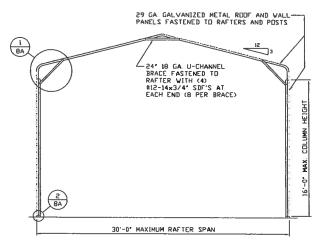

TYPICAL RAFTER/COLUMN END FRAME SECTION

SCALE: NTS


TYPICAL RAFTER/COLUMN END FRAME SECTION
SCALE: NTS




TYPICAL RAFTER/COLUMN SIDE FRAMING SECTION
SCALE NTS




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BOX EAVE RAFTER COLUMN CONNECTION DETAIL FOR HEIGHTS 14'-0' < TO < 16'-0' SCALE NTS

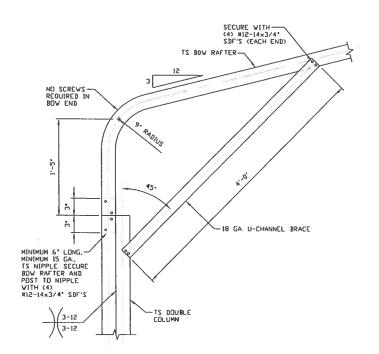


BRACE SECTION

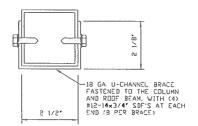


RAFTER COLUMN/BASE RAIL
CONNECTION DETAIL
SCALE: NTS

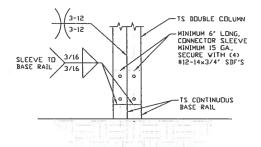


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BOX EAVE RAFTER COLUMN
CONNECTION DETAIL
FOR HEIGHTS 10'-0" < TO < 14'-0"

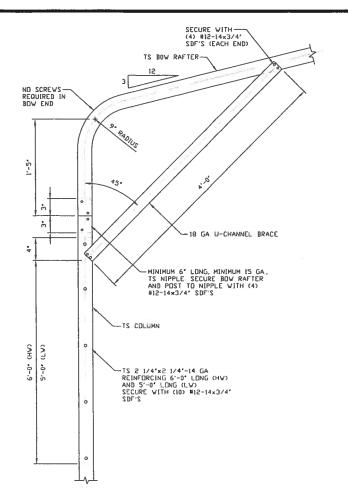


2 RAFTER COLUMN/BASE RAIL CONNECTION DETAIL
SCALE: NTS

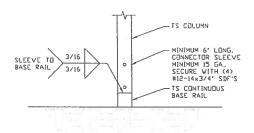

BOX EAVE RAFTER COLUMN CONNECTION DETAIL FOR HEIGHTS ≤ 10'-0"

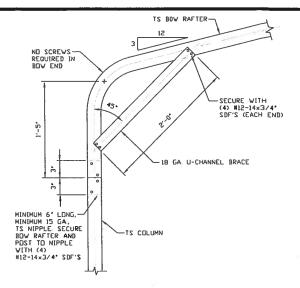
SCALE: NTS

1B

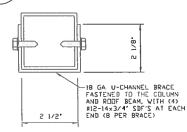

# BRACE SECTION

SCALE: NTS

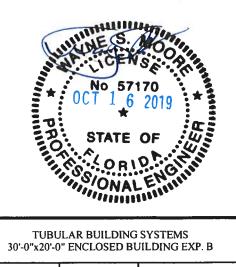



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	CLIENT: TBS	SHT. 8B	DWG. NO: SK-3		REV. 4

#### BASE RAIL ANCHORAGE OPTIONS FOR LOW AND HIGH WIND SPEED



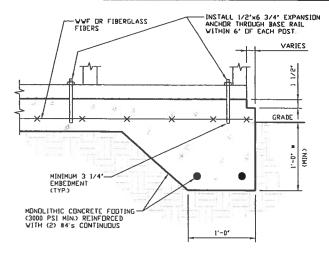

**3A** 
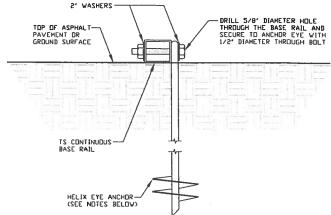
#### CONCRETE MONOLITHIC SLAB BASE RAIL ANCHORAGE

SCALE: NTS (MINIMUM ANCHOR EDGE DISTANCE IS 4')
\* COORDINATE WITH LOCAL CODES/ORD GROUND BASE HELIX ANCHORAGE SCALE: NTS (CAN BE USED FOR ASPHALT)

### **GENERAL NOTES**

#### CONCRETE:

CONCRETE SHALL HAVE A MINIMUM SPECIFIED COMPRESSIVE STRENGTH OF 3,000 PSI AT 28 DAYS.

## COVER OVER REINFORCING STEEL:

FOR FOUNDATIONS, MINIMUM CONCRETE COVER OVER REINFORCING BARS SHALL BE PER ACI-318 3 INCHES IN FOUNDATIONS WHERE THE CONCRETE IS CAST AGAINST AND PERMANENTLY IN CONTACT WITH THE EARTH OR EXPOSED TO THE EARTH OR WEATHER, AND 1 1/2 INCHES ELSEWHERE.

#### REINFORCING STEEL:

THE TURNDOWN REINFORCING STEEL SHALL BE ASTM A615 GRADE 60. THE SLAB REINFORCEMENT SHALL BE WELDED WIRE FABRIC MEETING ASTM A185 OR FIBERGLASS FIBER REINFORCEMENT.


#### REINFORCEMENT MAY BE BENT IN THE SHOP OR THE FIELD PROVIDED:

- 1 REINFORCEMENT IS BENT COLD
- 2. THE DIAMETER OF THE BEND, MEASURED ON THE INSIDE OF THE BAR, IS NOT LESS THAN SIX-BAR DIAMETERS

  3. REINFORCEMENT PARTIALLY EMBEDDED IN CONCRETE SHALL NOT
- BE FIELD BENT

#### HELIX ANCHOR NOTES:

- I FOR VERY DENSE AND/OR CEMENTED SANDS, COARSE GRAVEL AND COBBLES, CALICHE, PRELOADED SILTS AND CLAYS USE MINIMUM (2) 4' HELICES WITH MINIMUM 30 INCH EMBEDMENT.
- 2 FDR CORAL USE MINIMUM (2) 4' HELICES WITH MINIMUM 30 INCH
- 3 FOR MEDIUM DENSE COARSE SANDS, SANDY GRAVELS, VERY STIFF SILTS, AND CLAYS USE MINIMUM (2) 4' HELICES WITH MINIMUM 30 INCH EMBEDMENT.
- 4 FOR LODSE TO MEDIUM DENSE SANDS, FIRM TO STIFF CLAYS AND SILTS ALLUVIAL FILL USE MINIMUM (2) 6' HELICES WITH MINIMUM 50 INCH EMBEDMENT
- 5 FDR VERY LOSE TO MEDIUM DENSE SANDS, FIRM TO STIFFER CLAYS AND SILTS, ALLUVIAL FILL USE MINIMUM (2) B' HELICES WITH MINIMUM 60 INCH EMBEDMENT.

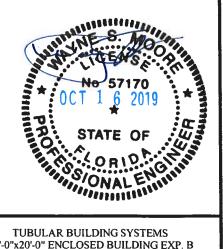


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	CLIENT: TBS	SHT. 9A	DVG. NO: SK-3		REV= 4

### OPTIONAL FOUNDATION ANCHORAGE FOR LOW & HIGH WIND SPEED



# 1A
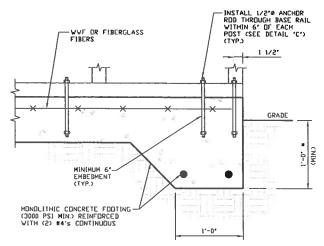
#### CONCRETE MONOLITHIC SLAB BASE RAIL ANCHORAGE

(MINIMUM ANCHOR EDGE DISTANCE IS 1 1/2') \* COORDINATE WITH LOCAL CODES/ORD

#### **GENERAL NOTES**

#### CONCRETE:

CONCRETE SHALL HAVE A MINIMUM SPECIFIED COMPRESSIVE STRENGTH OF 3,000 PSI AT 28 DAYS.

#### COVER OVER REINFORCING STEEL:

FOR FOUNDATIONS, MINIMUM CONCRETE COVER OVER REINFORCING BARS SHALL BE PER ACI-318:

3 INCHES IN FOUNDATIONS WHERE THE CONCRETE IS CAST AGAINST AND PERMANENTLY IN CONTACT WITH THE EARTH OR EXPOSED TO THE EARTH OR WEATHER, AND 1 1/2 INCHES ELSEWHERE

#### REINFORCING STEEL:


THE TURNDOWN REINFORCING STEEL SHALL BE ASTM A615 GRADE 60. THE SLAB REINFORCEMENT SHALL BE WELDED WIRE FABRIC MEETING ASTM A185 OR FIBERGLASS FIBER REINFORCEMENT.

#### REINFORCEMENT MAY BE BENT IN THE SHOP OR THE FIELD PROVIDED:

- I REINFORCEMENT IS BENT COLD

  THE DIAMETER OF THE BEND, MEASURED ON THE INSIDE OF THE BAR, IS NOT LESS THAN SIX-BAR DIAMETERS

  REINFORCEMENT PARTIALLY EMBEDDED IN CONCRETE SHALL NOT
- BE FIELD BENT

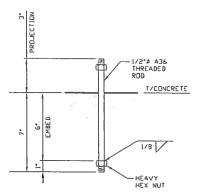



ANCHOR ROD THROUGH BASE RAIL DETAIL SCALE: NTS

INSTALL 1/2'\$ ANCHOR— ROD THROUGH BASE RAIL WITHIN 6' DF EACH POST (SEE DETAIL 'C') (TYP.) VVF DR FIBERGLASS FIBERS GRADE CMIMO 1,-0, MONOLITHIC CONCRETE FOOTING (3000 PSI MIN.) REINFORCED WITH (2) #4's CONTINUOUS 1'-0"

1B

SCALE: NTS

#### CONCRETE MONOLITHIC SLAB BASE RAIL ANCHORAGE

(MINIMUM ANCHOR EDGE DISTANCE IS 1 1/2')
\* COORDINATE WITH LOCAL CODES/ORD




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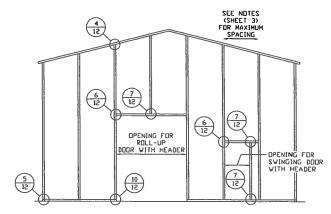
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PROJECT MGR: VSM	DATE: 12-18-17	SCALE: NTS	JOB NO: 160225/173005	
CLIENT: TBS	SHT. 9B	DWG. NO: SK-3	REV» 4	

# **BOX EAVE RAFTER END WALL AND SIDE WALL OPENINGS**




TYPICAL BOX EAVE RAFTER

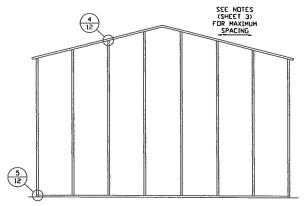END WALL FRAMING SECTION SCALE: NTS



TYPICAL BOX EAVE RAFTER END WALL OPENINGS FRAMING SECTION

SCALE: NTS

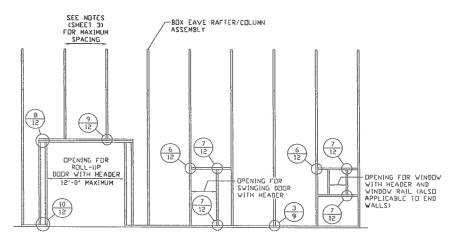

TYPICAL BOX EAVE RAFTER SIDE WALL OPENINGS FRAMING SECTION

SCALE NTS




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CLIENT: TBS	SHT. 10	DVG. NO: SK-3	REV. 4	

# **BOW RAFTER END WALL AND SIDE WALL OPENINGS**



TYPICAL BOX EAVE RAFTER END WALL FRAMING SECTION

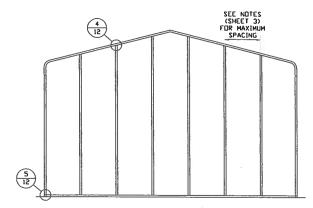SEE NOTES
(SHEET)
FOR MAXIMUM
SPACING

DPENING FOR
ROLL-UP
DOOR VITH HEADER


TO THE SVINGING DOOR
VITH HEADER

TO THE SVINGING DOOR
VITH HEADER

TO THE SVINGING DOOR
VITH HEADER

TYPICAL BOX EAVE RAFTER END WALL OPENINGS FRAMING SECTION

SCALE: NTS

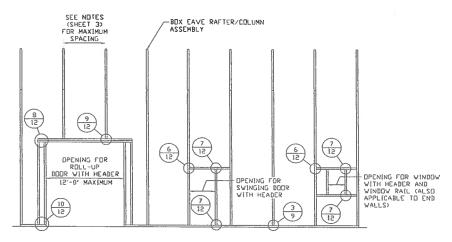

TYPICAL BOX EAVE RAFTER SIDE WALL OPENINGS FRAMING SECTION

SCALE NTS

SCALE: NTS




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CLIENT: TBS	SHT. 11	DWG. NO: SK-3	REV.: 4	

## BOW AND BOX EAVE RAFTER WALL OPENING DETAILS



TS COLUMN (CORNER) MINIMUM 6' LONG, MINIMUM 15 GA., TS NIPPLE SECURE WITH (4) #12-14x3/4' SDF'S 2'x2'x2' 16 GA. CLIP ANGLE SECURE TO RAFTER COLUMN AND BASE RAIL W/(4) #12-14x3/4' SDF'S NIPPLE TO 3/16 BASE RAIL 3/16 3/16 TS CONTINUOUS BASE RAIL

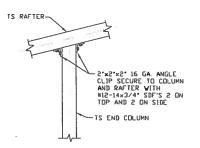TS COLUMN OR END COLUMN DR END COLUMN

2'x2'x2' 16 GA ANGLE
CLIP SCCURE TO COLUMN
AND EITHER TOP OF
HEADER, OR BOTTOM OF
WINDDW RAIL WITH
#12-14x3/4' SDF'S -TS HEADER OR WINDOW RAIL


END COLUMN/RAFTER CONNECTION DETAIL 4

END COLUMN/BASE RAIL CONNECTION DETAIL SCALE: NTS

HEADER OR WINDOW RAIL TO COLUMN CONNECTION DETAIL SCALE: NTS


6

SCALE: NTS

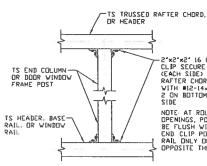

-2'x2'x2' 16 GA. ANGLE CLIP SECURE TO COLUMN (EACH SIBE) AND RAFTER CHORP/RAIL VITH #12-14x3/4' SDF'S 2 ON BOTTOM AND 2 DN SIDE

NOTE AT ROLL-UP BOOR
DPENINGS, POST SHOULD
BE FLUSH WITH RAIL
END CLIP POST TO
RAIL DNLY DN SIDE
DPPOSITE THE DPENING

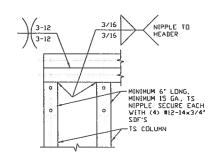

TS COLUMN NIPPLE TO HEADER 3/16 MINIMUM 6' LONG, MINIMUM 15 GA, TS NIPPLE, SECURE WITH (4) #12-14×3/4' SDF'S TS DOUBLE HEADER

COLUMN TO HEADER, BASE RAIL, OR WINDOW RAIL CONNECTION DETAIL

DOUBLE HEADER/COLUMN CONNECTION DETAIL 8

COLUMN/DOUBLE HEADER CONNECTION DETAIL 9 SCALE: NTS

SCALE: NTS

TS COLUMN -MINIMUM 6' LONG, MINIMUM 15 GA., TS NIPPLE SECURE EACH WITH (4) #12-14x3/4' SDF'S NIPPLE TO BASE RAIL 3/16 3/16 TS CONTINUOUS BASE RAIL


COLUMN/BASE RAIL CONNECTION DETAIL 10 SCALE: NTS



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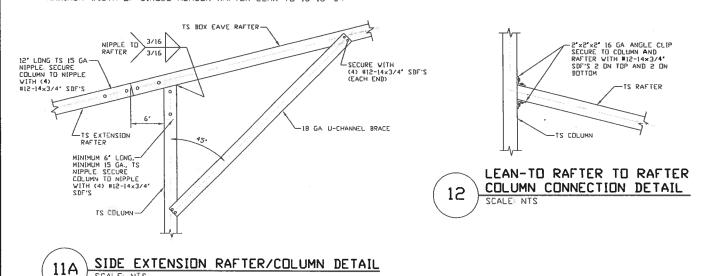
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CLIENT: TRS	SHT. 12	DWG. NO: SK-3	REV: 4	



TYPICAL BOX EAVE RAFTER LEAN-TO OPTIONS FRAMING SECTION (BOTH OPTIONS SHOWN)

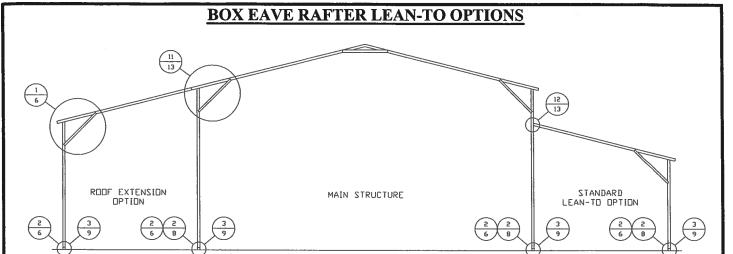
SCALE: NTS MAXIMUM WIDTH OF SINGLE MEMBER RAFTER LEAN-TO IS 16'-0'.






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# **BOW RAFTER LEAN-TO OPTIONS**

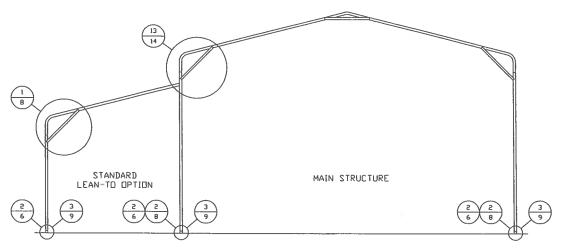

#### TYPICAL BOW RAFTER LEAN-TO OPTIONS FRAMING SECTION (BOTH OPTIONS SHOWN)

SCALE: NTS MAXIMUM WIDTH OF SINGLE MEMBER RAFTER LEAN-TO IS 16'-0'.

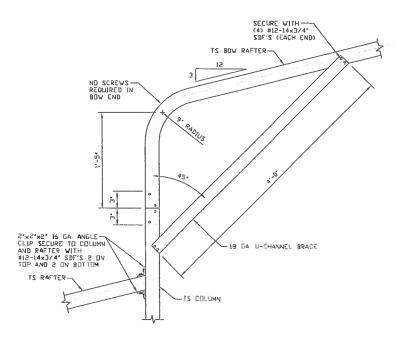


SIDE EXTENSION RAFTER/COLUMN DETAIL




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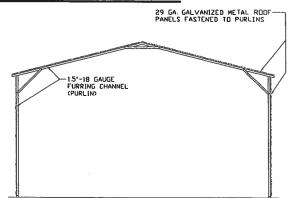
# **BOX EAVE RAFTER VERTICAL ROOF/SIDING OPTION**

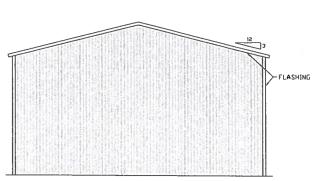

TYPICAL END ELEVATION VERTICAL ROOF/SIDING OPTION

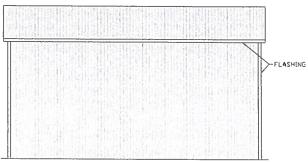

TYPICAL SIDE ELEVATION
VERTICAL ROOF/SIDING OPTION
SCALE: NTS




TYPICAL SECTION VERTICAL ROOF/SIDING OPTION

SCALE: NTS

SEE NOTES
(SHEET 3)
FOR MAXIMUM
SPACING

-15'-18 GAUGE FURRING CHANNEL SPACED
NDT MIDRE THAN 4'-0' IC. AND FASTENED
TO EACH RAFTER WITH (2) W12-14×3/4'
SDF'S

TYPICAL FRAMING SECTION
VERTICAL ROOF/SIDING OPTION

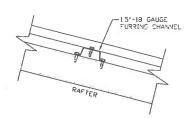


ROOF PANEL ATTACHMENT
(ALTERNATE FOR VERTICAL ROOF PANELS)
SCALE: NTS




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# **OPTIONAL DOOR HEADER**

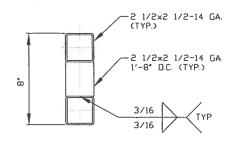

HEADER DETAIL FOR DOOR OPENINGS 12'-0' < LENGTH ≤ 15'-0'

SCALE: NTS

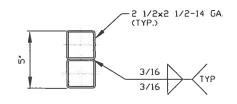


HEADER DETAIL FOR DOOR OPENINGS LENGTH < 12'-0'

SCALE: NTS



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Outside edge of foundation / footing See Corner Detail Sheet 3 **BUILDING SLAB** to outside of these Anii

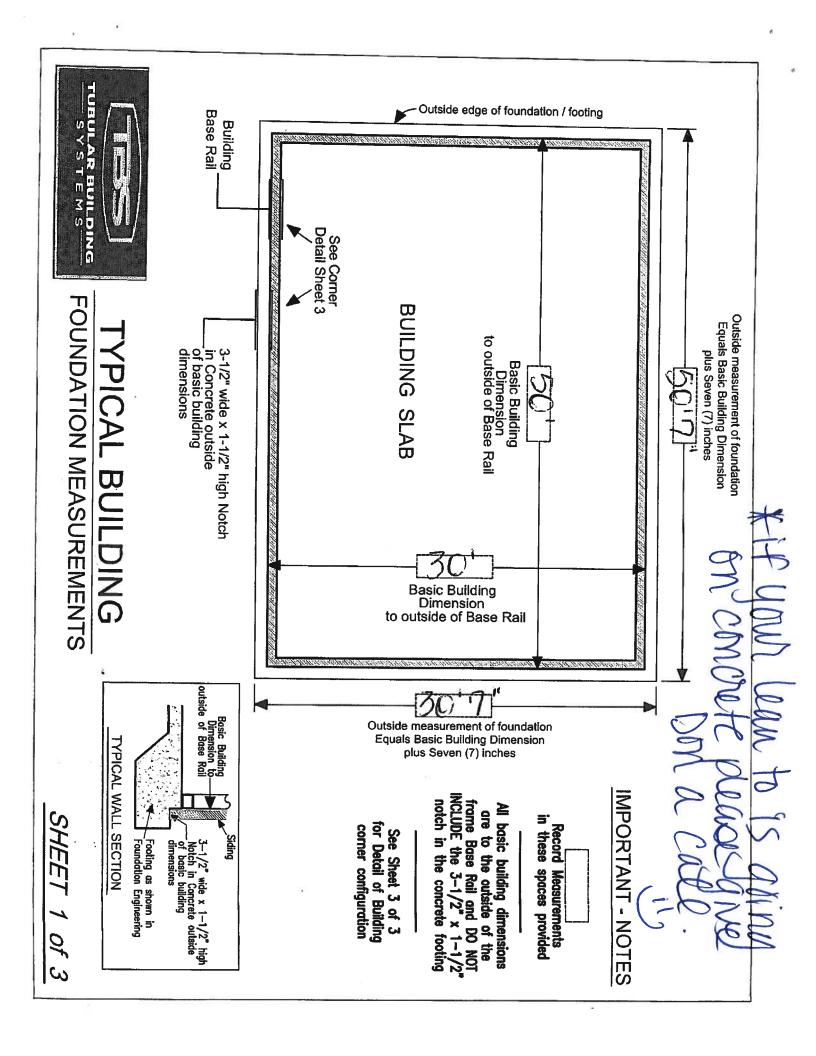TYPICAL BUILDING

FOUNDATION MEASUREMENTS
DIAGONALS

TUBULAR BUILDING

Building Base Rail

in Concrete outside of basic building dimensions


3-1/2" wide x 1-1/2" high Notch

IMPORTANT - NOTES


Record Measurements in these spaces provided

All basic building diagonal dimensions are to the outside corner of the frame Base Rail and DO NOT INCLUDE the 3-1/2" x 1-1/2" notch in the concrete footing

See Sheet 3 of 3 for Detail of Building corner configuration

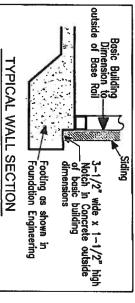

SHEET 2 of 3

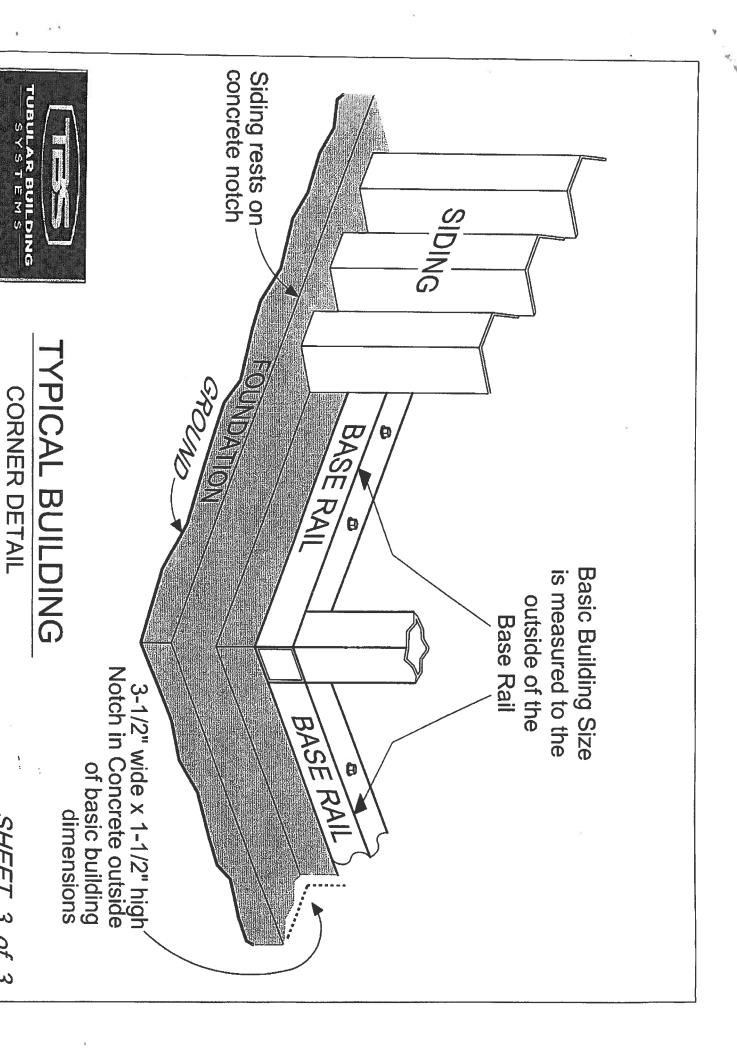

SHEET 3 of 3