


STEM WALL FOOTING S-2 SCALE: 1/2" = 1'-0"

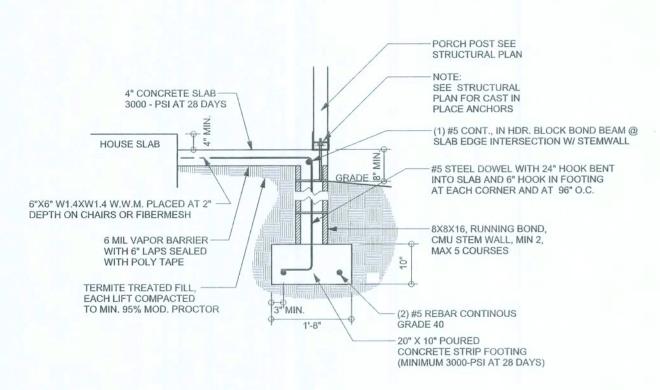


STEM WALL PORCH FOOTING S-2 SCALE: 1/2" = 1'-0"


TALL STEM WALL TABLE

The table assumes 60 ksi reinforcing bars with 6" hook in the footing and bent 24" into the reinforced slab at the top. The vertical steel is to be placed toward the tension side of the CMU wall (away from the soil pressure, within 2" of the exterior side of the wall). If the wall is over 8' high, add Durowall ladder reinforcement at 16"OC vertically or a horizontal bond beam with 1#5 continuous at mid height. For higher parts of the wall 12" CMU may be used with reinforcement as shown in the table below.


STEMWALL HEIGHT (FEET)	UNBALANCED BACKFILL HEIGHT	VERTICAL REINFORCEMENT FOR 8" CMU STEMWALL (INCHES O.C.)			VERTICAL REINFORCEMENT FOR 12" CMU STEMWALL (INCHES O.C.)		
		#5	#7	#8	#5	#7	#8
3.3	3.0	96	96	96	96	96	96
4.0	3.7	96	96	96	96	96	96
4.7	4.3	88	96	96	96	96	96
5.3	5.0	56	96	96	96	96	96
6.0	5.7	40	80	96	80	96	96
6.7	6.3	32	56	80	56	96	96
7.3	7.0	24	40	56	40	80	96
8.0	7.7	16	32	48	32	64	80
8.7	8.3	8	24	32	24	48	64
9.3	9.0	8	16	24	16	40	48

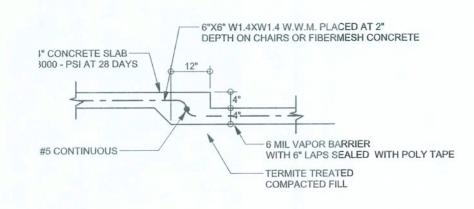


F) TYPICAL NON - BEARING STEP FOOTING SCALE: 1/2" = 1'-0"

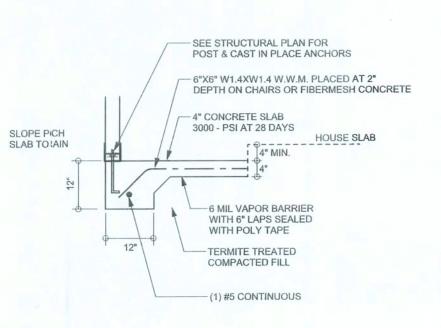


PORCH FOOTING S-2 SCALE: 1/2" = 1'-0"

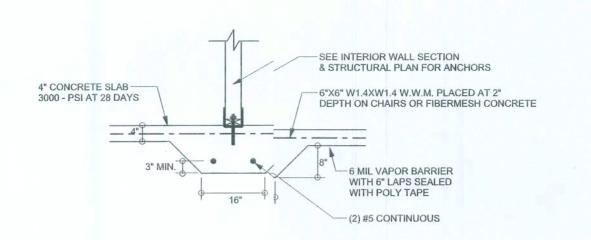


INTERIOR BEAARING FOOTING S-2 | SCALE: 1/2" = 1'-0"

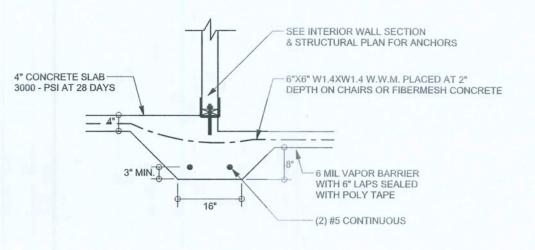


F3 INTERIOR BEARING STEP FOOTING SCALE: 1/2" = 1'-0"

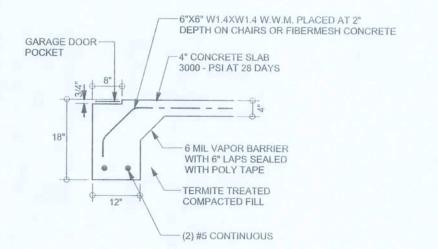

F4 GARAGE DOOR FOOTING S-2 SCALE: 1/2" = 1'-0"

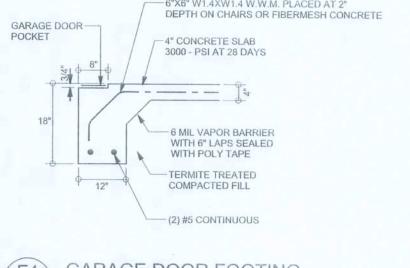



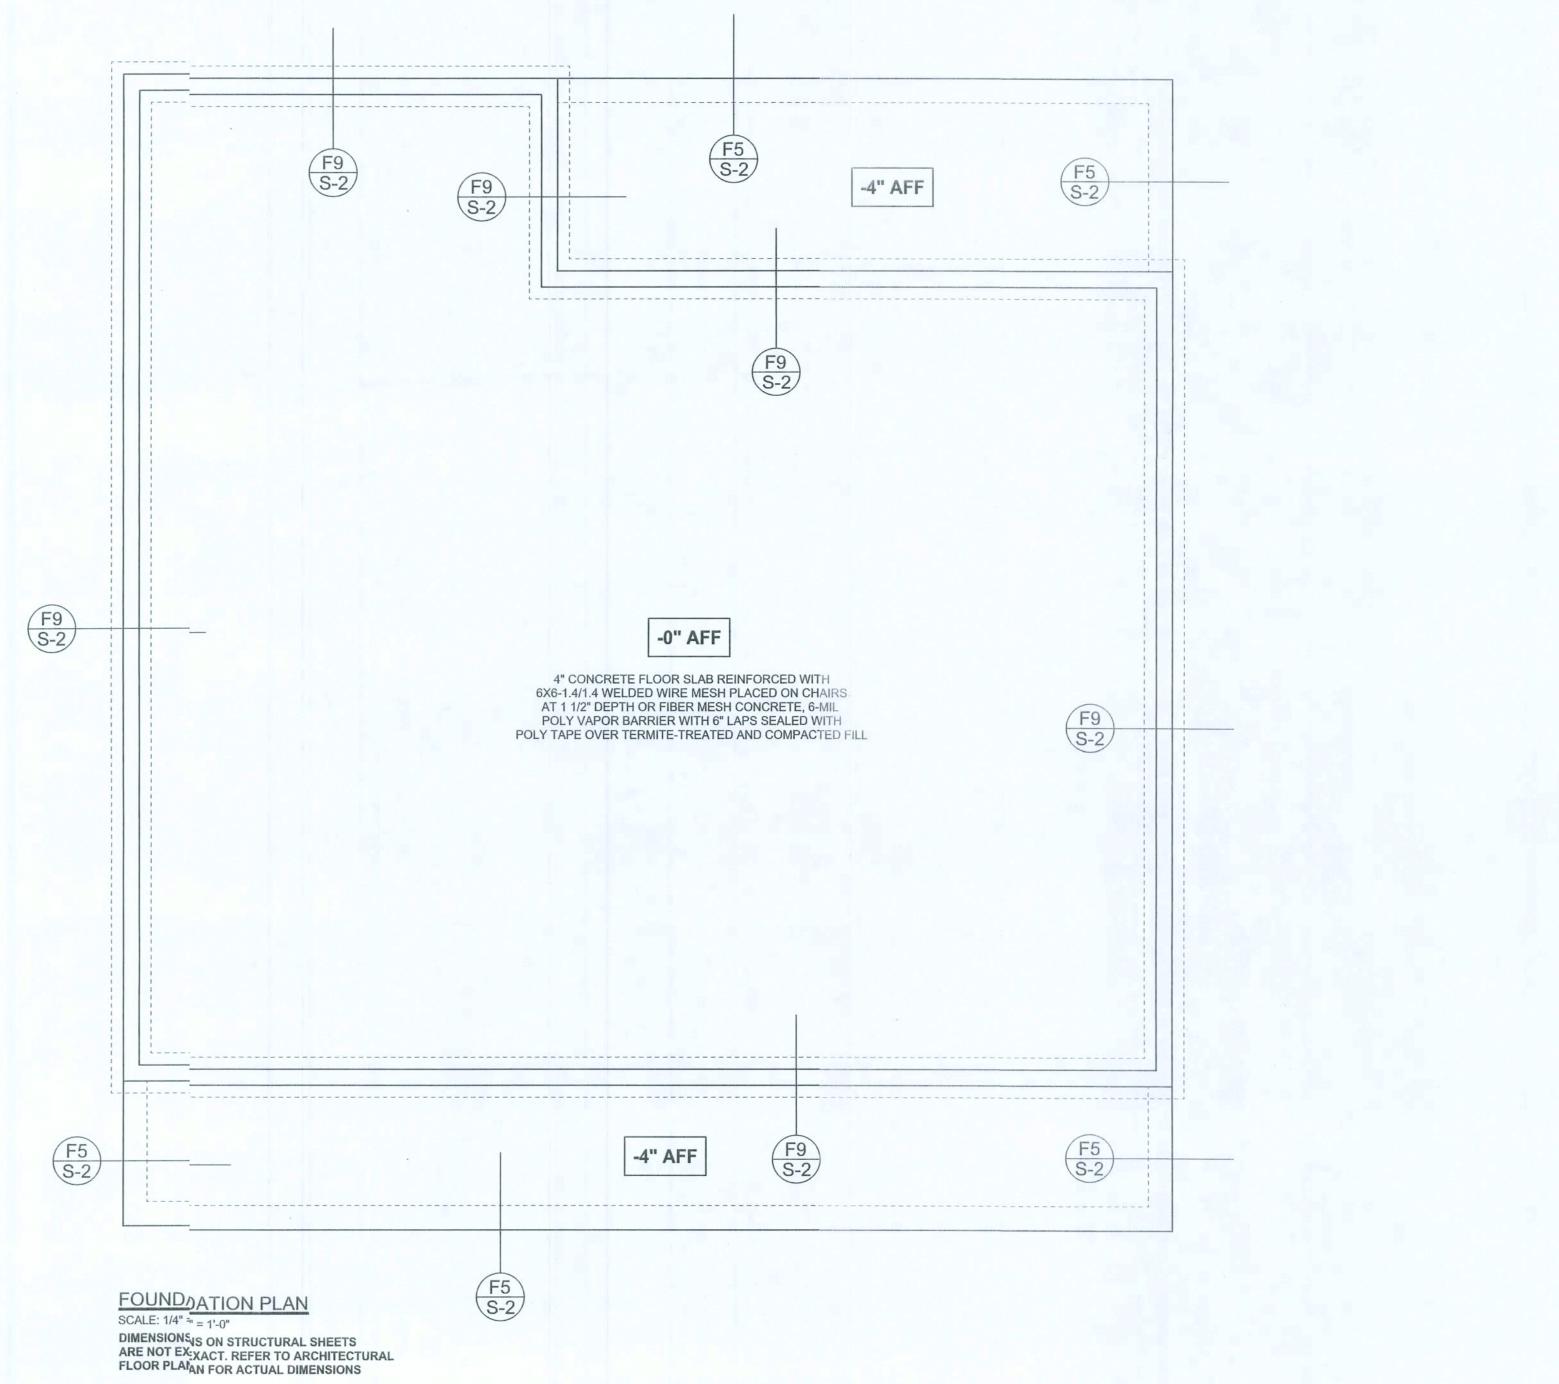

Mark Disosway, PE No.53915, POB 868, Lae City, FL 32056, 386-754-5419 DIMENSIONS: Stated dimensions supecede scale

REVISIONS

SOFTRAN

Mark Disosway, P.E. foresolution. Do not proceed without:larification. COPYRIGHTS AND PROPERTY RIGHTS: Mark Disosway, P.E. heeby expressly reserves its common lar copyrights and property right in these istruments of service. This document is not to e reproduced, altered or copied in any form ornanner without first the express written perrission and consent of Mark Disosway.

CERTIFICATION: I herey certify that I have examined this plan, andhat the applicable portions of the plan, relaing to wind engineering compl with section R301.2.1, florida buildin code residential 2007, to the best of my knowldge.

LIMITATION: This design is valid for one building, at specified loation.

MARK DISSWAY P.E. 5915

Jerry WoodResidence

ADDÆSS: Columbia County, Florida

Mark Diso:way P.E. P.O. Bex 868 Lake City, Fbrida 32056 Phone: (386 754 - 5419 Fax: (386) 169 - 4871

> PRINTEI DATE: October 1:, 2009 DRAWN BY: STRUCTURAL BY: David Disosway David Disosway

FINALS DATE:

12Oct09

JOB NUMBER: 909172 DRAWINGNUMBER

OF 3 SHEETS



SN-1 ALL LOAD BEARING FRAME WLL & PORCH HEADERS SHALL BE A MINIMUM OF (2) :12 SYP#2 (U.N.O.)

SN-2 ALL LOAD BEARING FRAME WLL HEADERS SHALL HAVE (1) JACK STUD (1) KING STUD EACH SIDE (U.N.O.)

SN-3 DIMENSIONS ON STRUCTUR/ SHEETS ARE NOT EXACT. REFER TO //CHITECTURAL FLOOR PLAN FOR ACTUAL DENSIONS

PERMANENT TRUSS BRACIN(S TO BE INSTALLED AT LOCATIONS AS SHOWN ON TE SEALED TRUSS DRAWINGS.

LATERAL BRACING IS TO BE ESTRAINED PER BCSI1-03, BCSI-B1, BCSI-B2, & BCSI-B3, CSI-B1, BCSI-B2, & BCSI-B3 ARE FURNISHED BY THE TRUS SUPPLIER, WITH THE SEALED TRUSS PACKAGE

THREADED ROD LEGEND

INDICATES LOCATION OF:
1ST FLOOR 1/2" A3(ALL THREADED ROD

INDICATES LOCATION OF:

2ND FLOOR 1/2" A3 ALL THREADED ROD

HEADER LEGEND

(2) 2X12X0',1J 1K HEADER/B\M CALL-OUT (U.N.O.)

NUMBER OF KINSTUDS (FULL LENGTH)


NUMBER OF JACSTUDS (UNDER HEADER)

SPAN OF HEADE

SIZE OF HEADERIATERIAL


NUMBER OF PLIE IN HEADER

WALL LEGEND

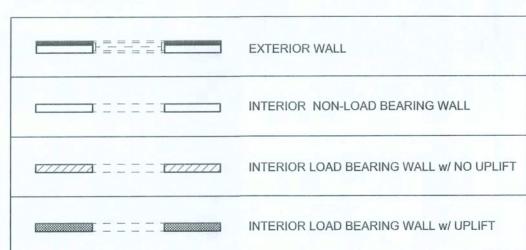

TOTAL SHEAR WALL SEGIENTS

REQUIRED ACTAL
TRANSVERSE 38.5' 70.2
LONGITUDINAL 34.0' 39.4

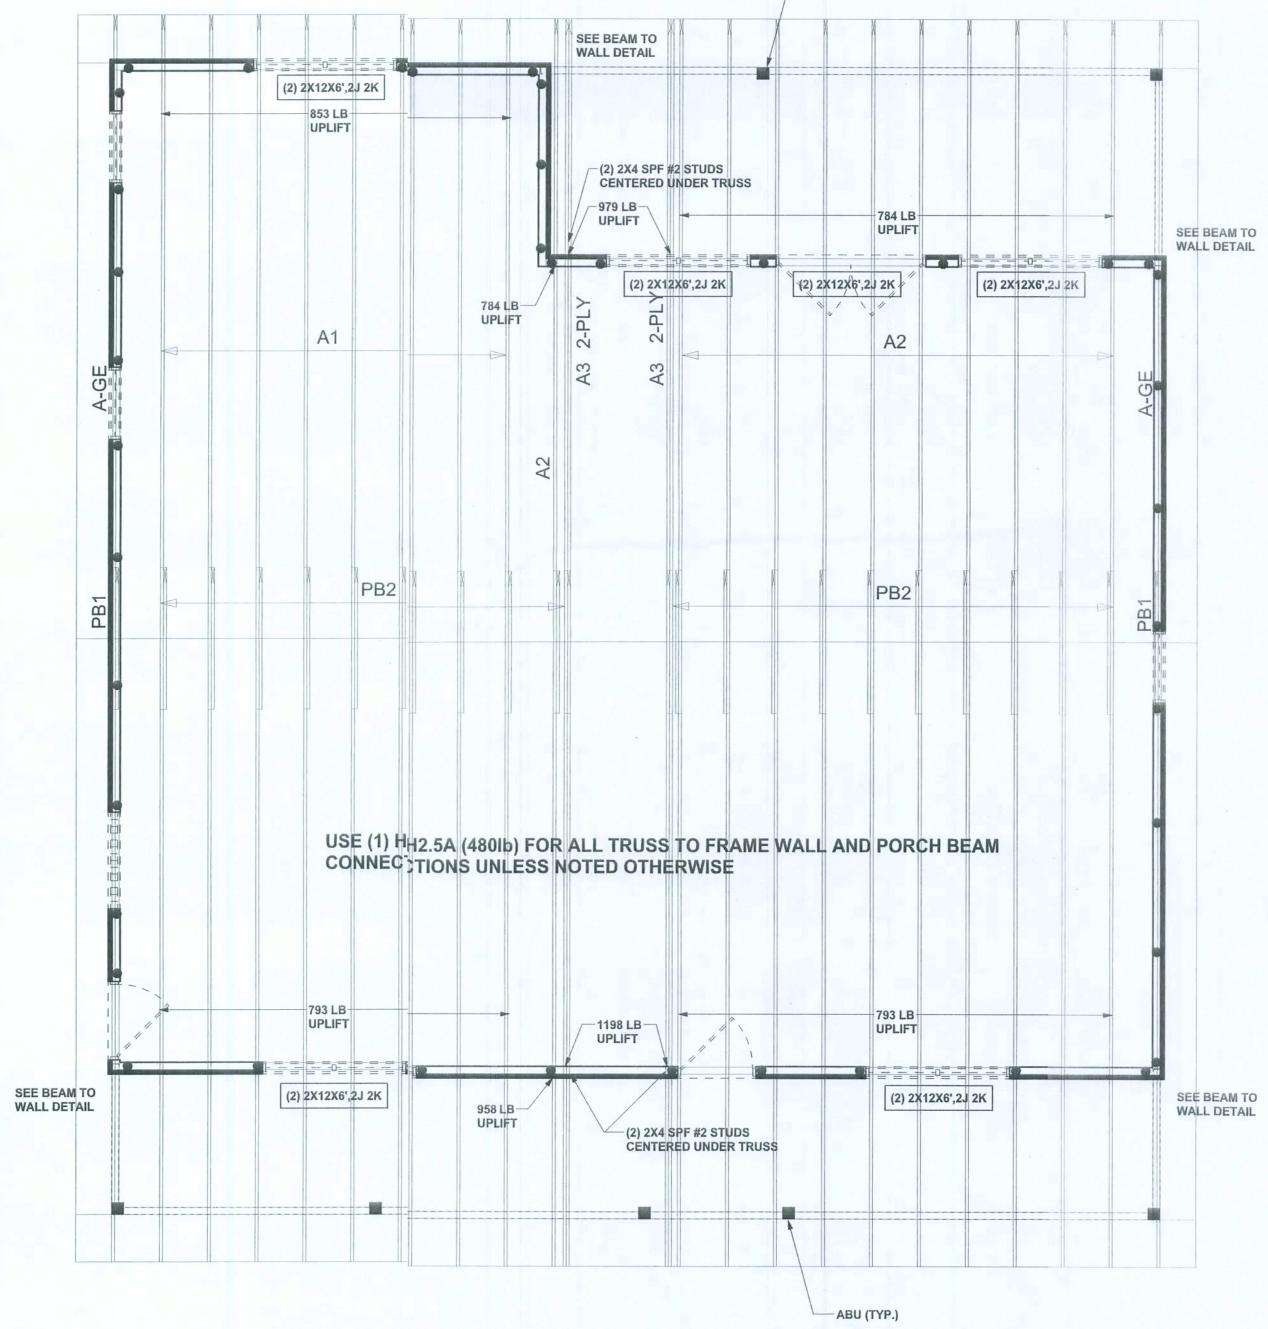

-ABU (TYP.)

STRUCTURAL PLAN
SCALE: 1/4" = 1'-0"

CONNECTIONS, WALL, & HEADER DESIGN IS BASED ON REACTIONS & UPLIFTS FROM TRUSS ENGINEERING FURNISHED BY BUILDER. ANDERSON TRUSS CO. JOB #9-193 REVISIONS

SOFIPIAN

WINDLOAD ENGINER:
Mark Disosway, PE
No.53915, POB 868, ake City, FL 32056,
386-754-5419

DIMENSIONS:
Stated dimensions suercede scaled dimensions. Refer all questions to Mark Disosway, P.E. or resolution.
Do not proceed withat clarification.

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the express written prinission and consent of Mark Disosway.

CERTIFICATION: I hreby certify that I have examined this plan, ad that the applicable portions of the plan, rlating to wind engineering comby with section R301.2.1, florida building code residential 2007, to the best of my knowledge.

LIMITATION: This deign is valid for one building, at specified scation.

MARK ESOSWAY
P.E.53915
S:AL

Jerry Wood Residence

ADIRESS: Columbia Gunty, Florida

Mark Disesway P.E. P.O. Fox 868 Lake City, Florida 32056 Phone: (386) 754 - 5419 Fax: (386) 269 - 4871

PRINT:D DATE:
October'12, 2009

DRAWN BY: STRUCTURAL BY
David Disosway David Disosway

FINALS DATE: 12Oct09

JOB NUMBER: 909172

DRAWING NUMBER

S-3 OF 3 SHEETS