










© WM DESIGN &
ASSOCIATES, NC.
4263W COMMERCE DR, STE 130
LAKE CITY, FL 32025
(386) 758-8406
will@willmyers.net

GIBRALTAR

SOFTPEN ARCHITECTURAL DESIGN SOFTWARE

ELEVATIONS

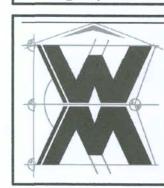

JOB NUMBER 20200512

A.1

OF 4 SHEETS



February 13, 201

May 12, 2020

May 12, 2020

SCALE:

LOT 18, WINGATE
Project Address: 218 SW Granite Court, Lake City, Florida 32024

GIBRALTAR CONTRACTING, L


LIC# 1259633 HIGH SPRINGS, FLORIDA

© WM DESIGN &
ASSOCIATES, INC.
42 SW COMMERCE DR, STE 130
LAKE CITY, FL 32025
(386) 758-8406
will@willmyers.net



JOB NUMBER 20200512

A.2
OF 4 SHEETS

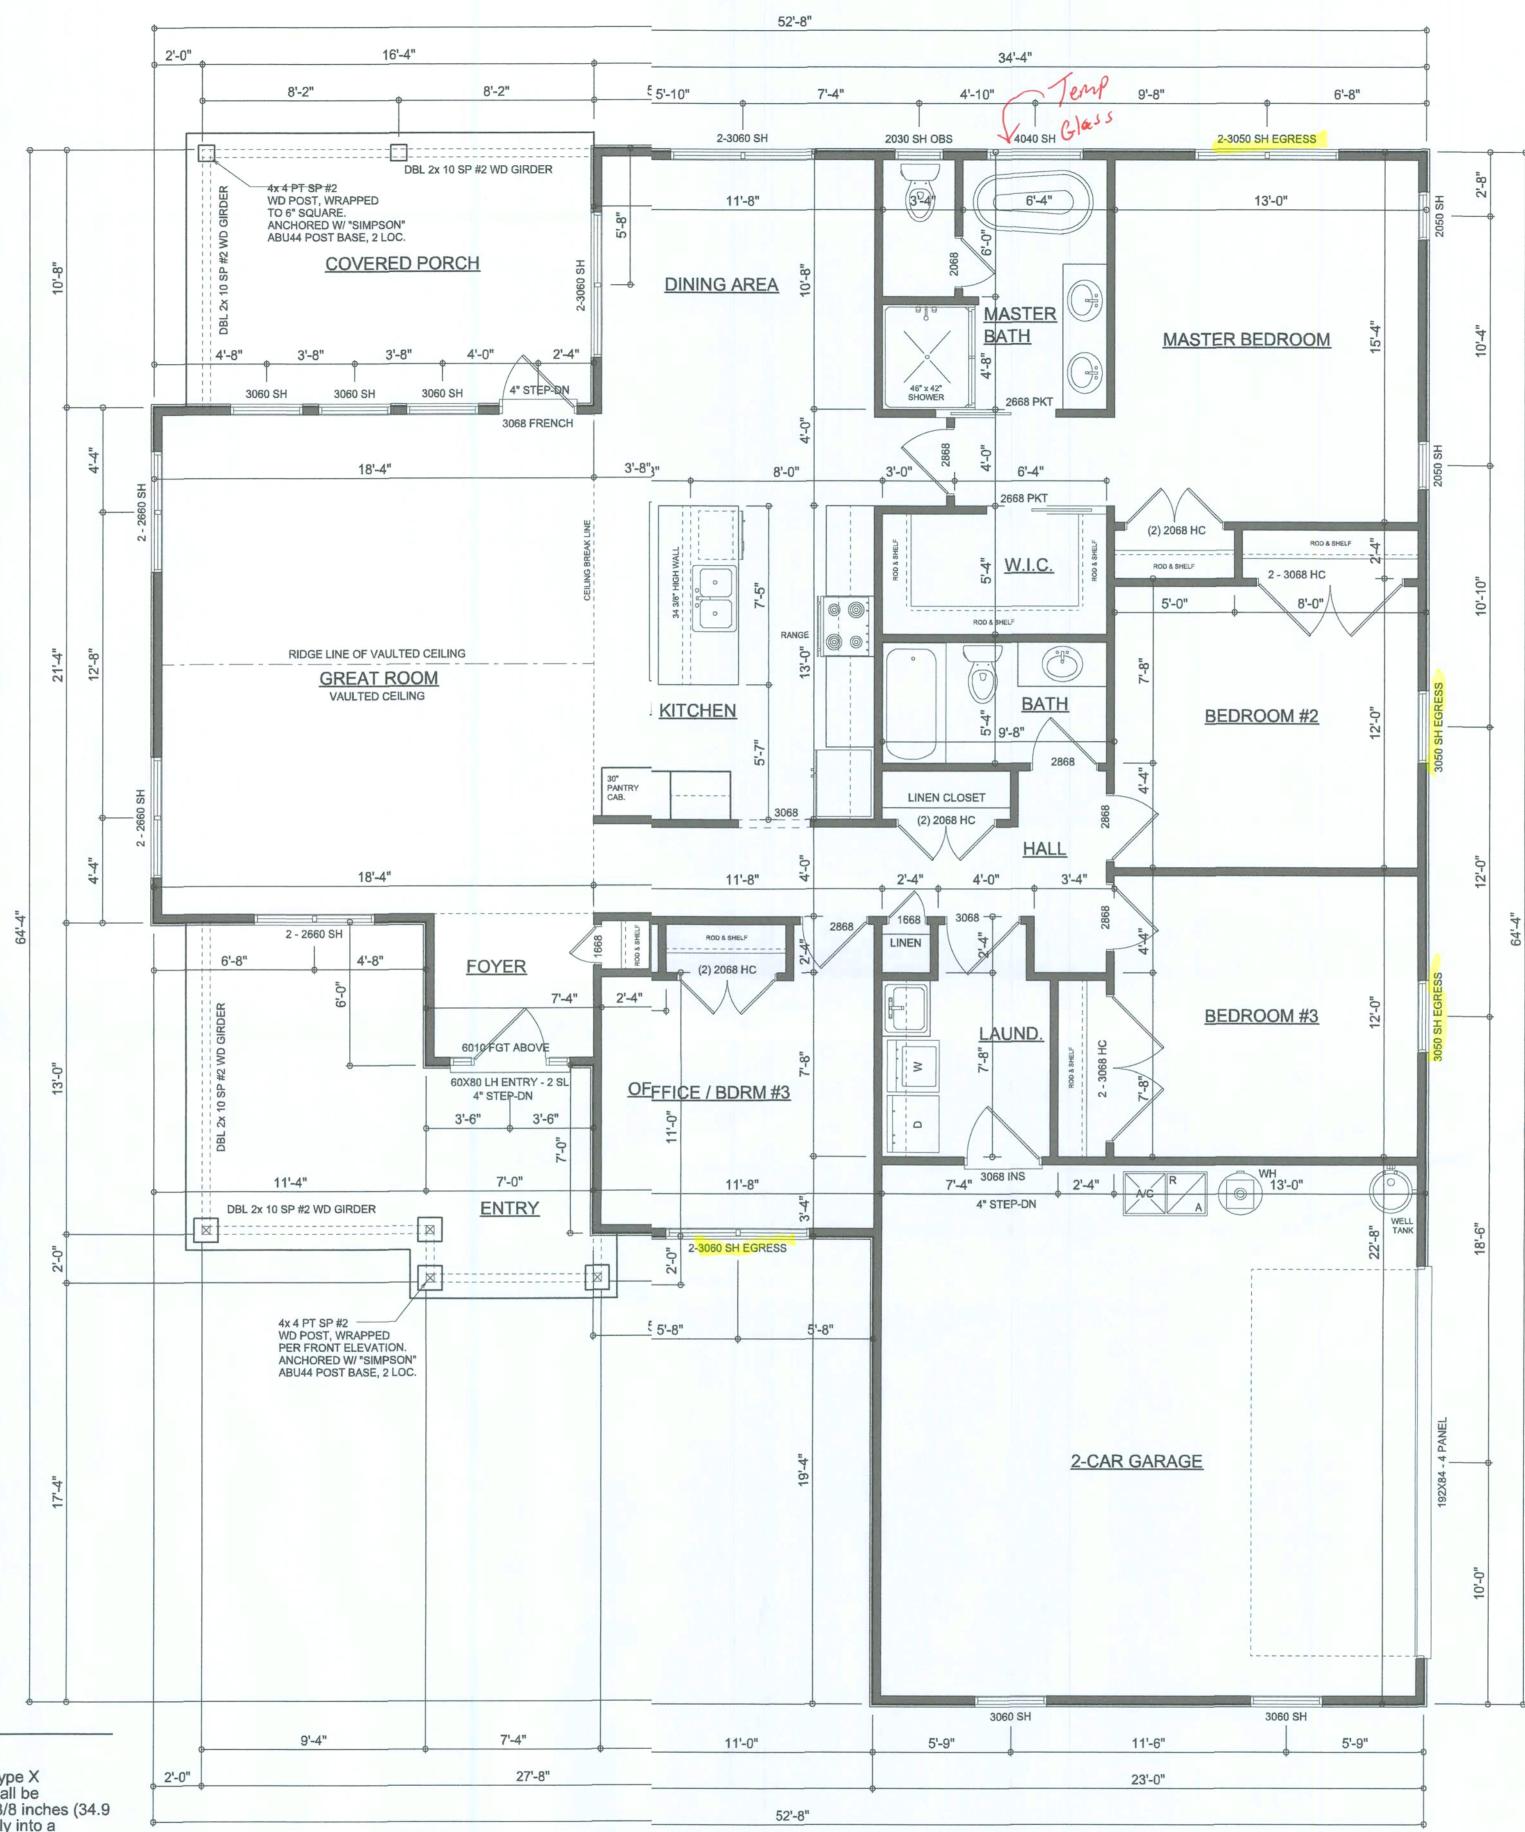

Garage fire separations shall comply with the followin:

1. The private garage shall be separated from the dwelling unit and itsattic area by means of a minimum ½-inch (12.7 mm) gypsum board applied to the garage sle. Garages beneath habitable rooms shall be separated from all habitable rooms above by ot less than 5/8-inch Type X gypsum board or equivalent. Door openings between a private garage nd the dwelling unit shall be equipped with either solid wood doors, or solid or honeycomb core steedoors not less than 13/8 inches (34.9 mm) thick, or doors in compliance with Section 715.3.3. Openings from private garage directly into a room used for sleeping purposes shall not be permitted.

2. Ducts in a private garage and ducts penetrating the walls or ceilingseparating the dwelling unit from the garage shall be constructed of a minimum 0.019-1ch (0.48 mm) sheet steel and shall have no openings into the garage.

A separation is not required between a Group R-3 and U carport proided the carport is entirely open on two or more sides and there are not enclosed areas abve.

4. When installing an attic access and/or pull-down stair unit in the garge, devise shall have a minimum 20 min. fire rating.

FLOOR PLAN

NOTE: ALL WALLS SHALL BE 9'-0" UNLESS OTHERWISE NOTED.

AREA SUMMARY

LIVING AREA 1,910 S.F. GARAGE AREA 513 S.F. COVERED PORCH AREA 174 S.F. ENTRY PORCH AREA 180 S.F.

2,777 S.F. TOTAL AREA

NOTE: ALL DRAWINGS NOT TO BE SCALED, WIRITTEN DIMENSIONS TAKE PRECEDENCE OVER SCALED DIMENSIONS

DIMENSIONED FLOOR PLAN

TE 6 60°

107 3 NOPLICE MY 6 ASSOCIATES, INC. 42 SW COMMERCE DR, STE 130 LAKE CITY, FL 32025 (386) 758-8406 will@willmyers.net



JOB NUMBER 20200512

SHEET NUMBER


	ELECTRICAL LEGEND	
	CEILING FAN (PRE-WIRE FOR LIGHT KIT)	
Q	DOUBLE SECURITY LIGHT	
((RECESSED CAN LIGHT	
€	BATH EXHAUST FAN	
-(-	LIGHT FIXTURE	
d	DUPLEX OUTLET (AFCI & TAMPER RESISTANT)	
d	220v OUTLET	
d ^a	GFI DUPLEX OUTLET (PER NEC 406.8)	
į	TELEVISION JACK	
F 7	TELEPHONE JACK	
	SMOKE / CARBON MONOXIDE DETECTOR (see note below)	
!	WALL SWITCH	
(3 WAY WALL SWITCH	
(WP/GFI	WATER PROOF GFI OUTLET	
48" FDUR.	2 OR 4 TUB FLUORESCENT FIXTURE	

NOTE: ALL INTERIR RECEPTACLES SHALL BE AFCI (ARC FAUI CIRCUIT INTERRUPT) PER NEC 210.12 & TAMPER RESISTANT PER NEC 406.1

ALL SMOK DETECTORS BE A COMBO SMOKE & CARBON MONOXIDE DETECTOR AND SHALHAVE BATTERY BACKUP POWER AND ALL VRED TOGETHER SO IF ANY ONE UNIT IS ACTUATED THEY

THE ELECTICAL SERVICE OVERCURRENT PROTECTION DEVICE SHALL BE INSTALLEON THE EXTERIOR OF STRUCTURES TO SERVE AS A DISCONNECT MEANS. CONDUCTRS USED FROM THE EXTERIOR DISCONNECTING MEANS TO A PANEL OR SUB PANEL SHLL HAVE FOUR-WIRE CONDUCTORS, OF WHICH ONE CONDUCTOR SHALL BE SED AS AN EQUIPMENT GROUND.

IT IS THE CENSED ELECTRICAL CONTRACTORS RESPONSIBILITY TO INSURE THAT ALL WORK PEFORMED AND EQUIPMENT INSTALLED MEETS OR EXCEEDS THE NFPA70 2014 NATIONAL ELECTRICODE AND ALL OTHER LOCAL CODES AND ORDINANCES.

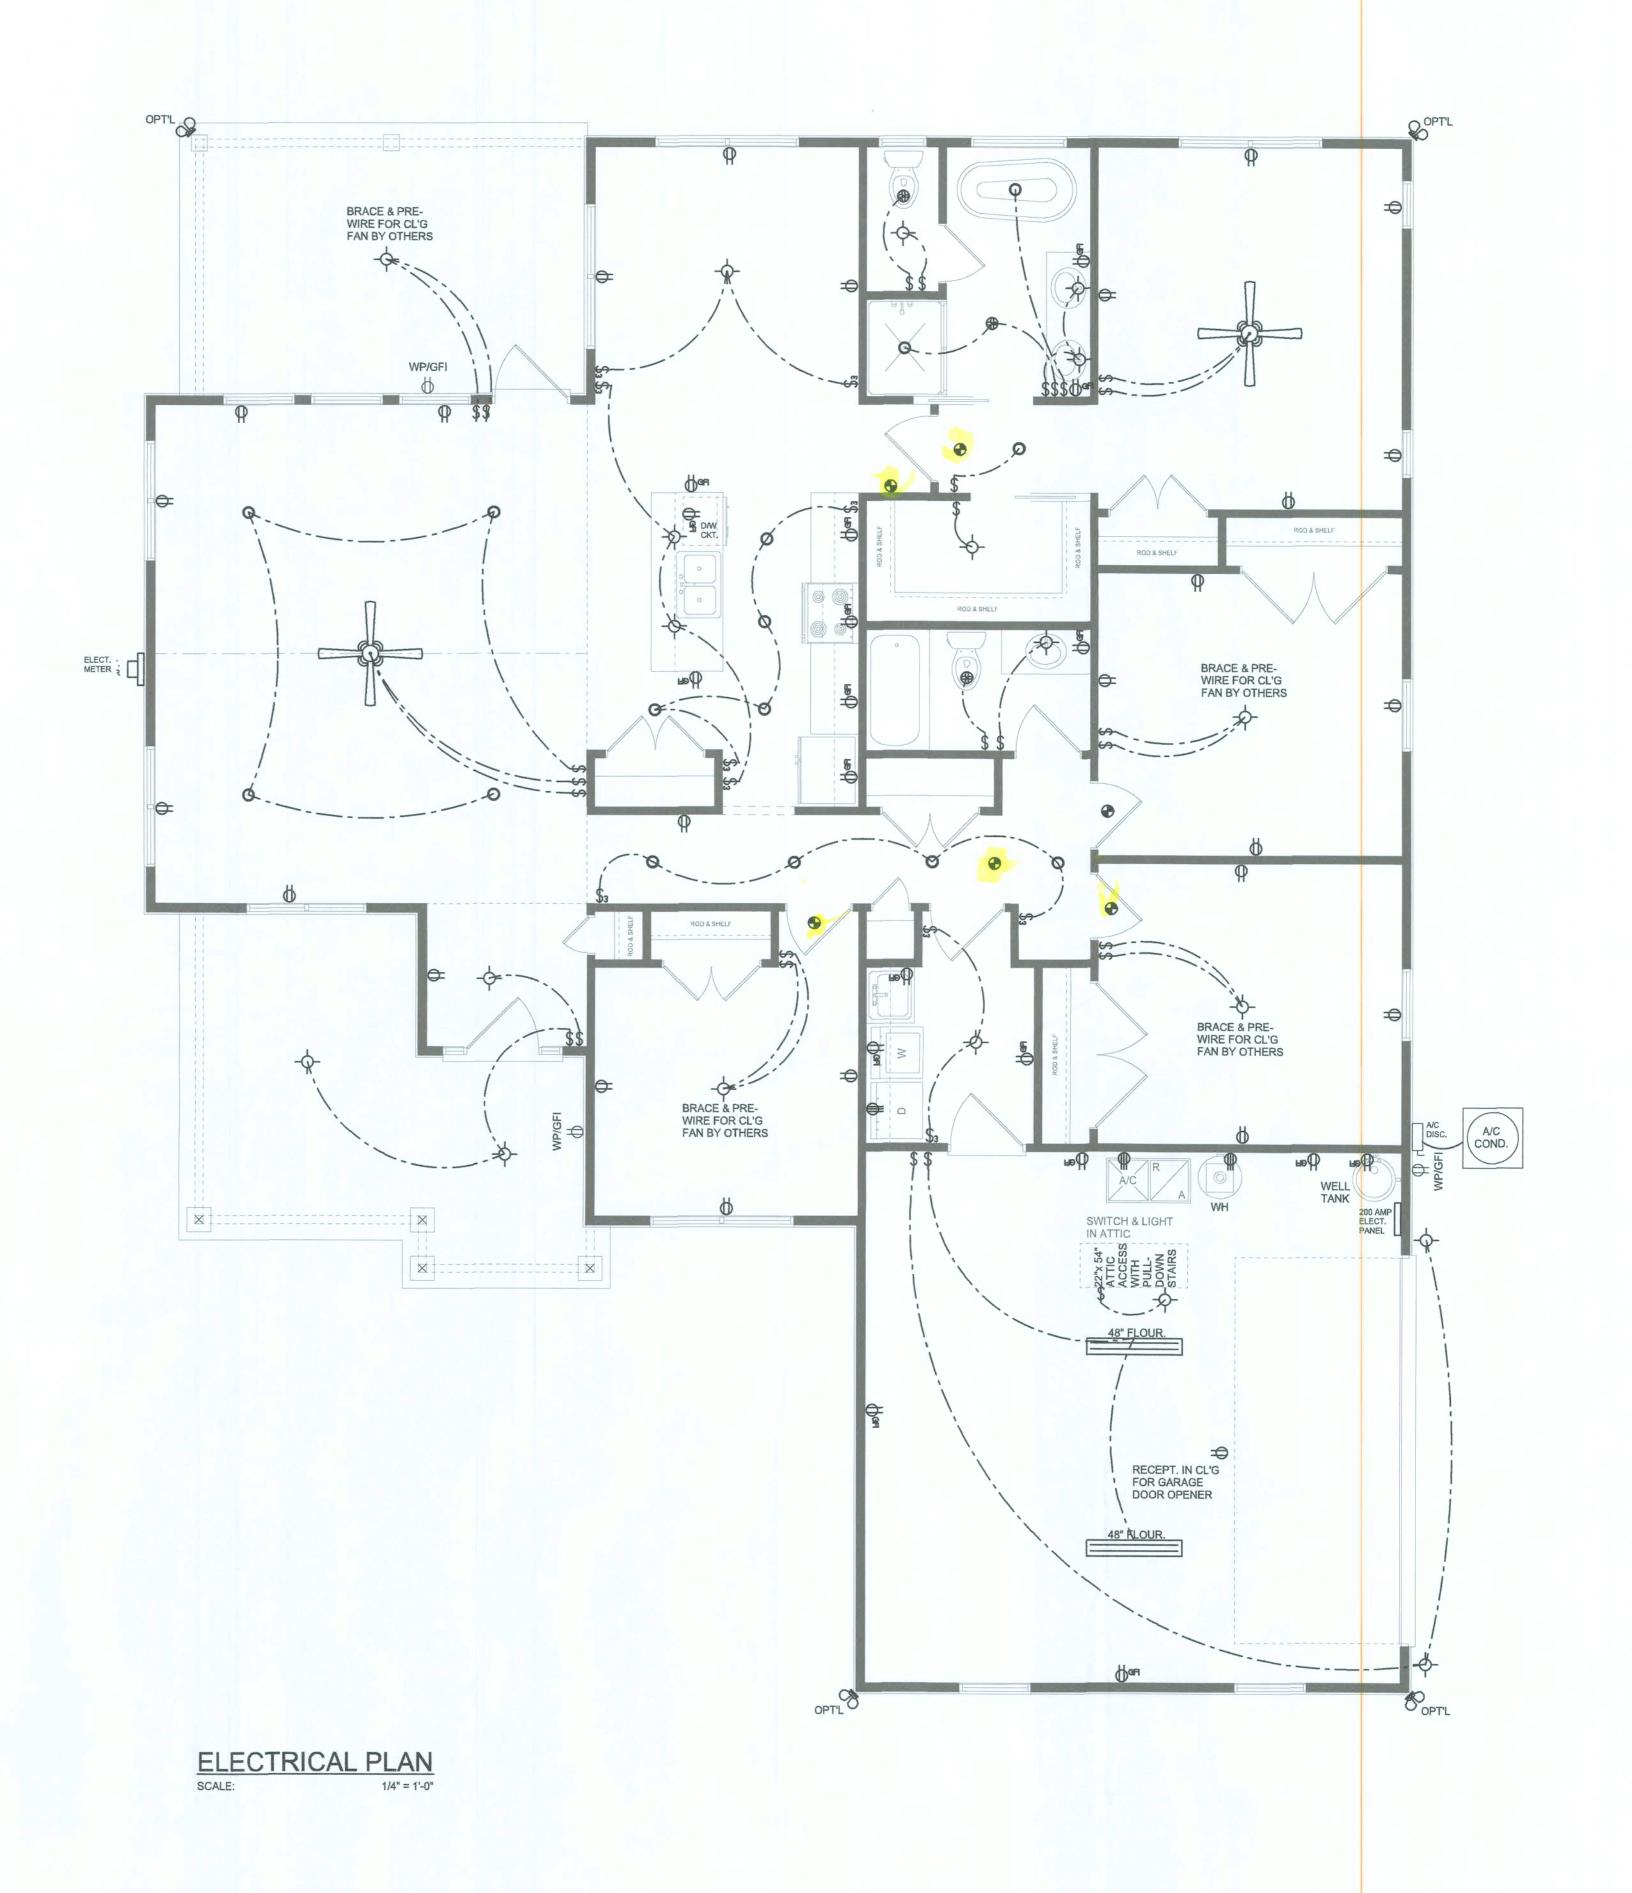

SOFTPIAN ARCHITECTURAL DESIGN SOFTWARE

ELECTRICAL PLAN SCALE: 1/4" = 1'-0"


18, WINGATE ress: 218 SW Granite Court, Lak LOT Project Add


O WM DESIGN & A550CIATE.5, INC. 42 SW COMMERCE DR, STE 130 LAKE CITY, FL 32025 (386) 758-8406 will@willmyers.net



JOB NUMBER 20200512

SHEET NUMBER OF 4 SHEETS

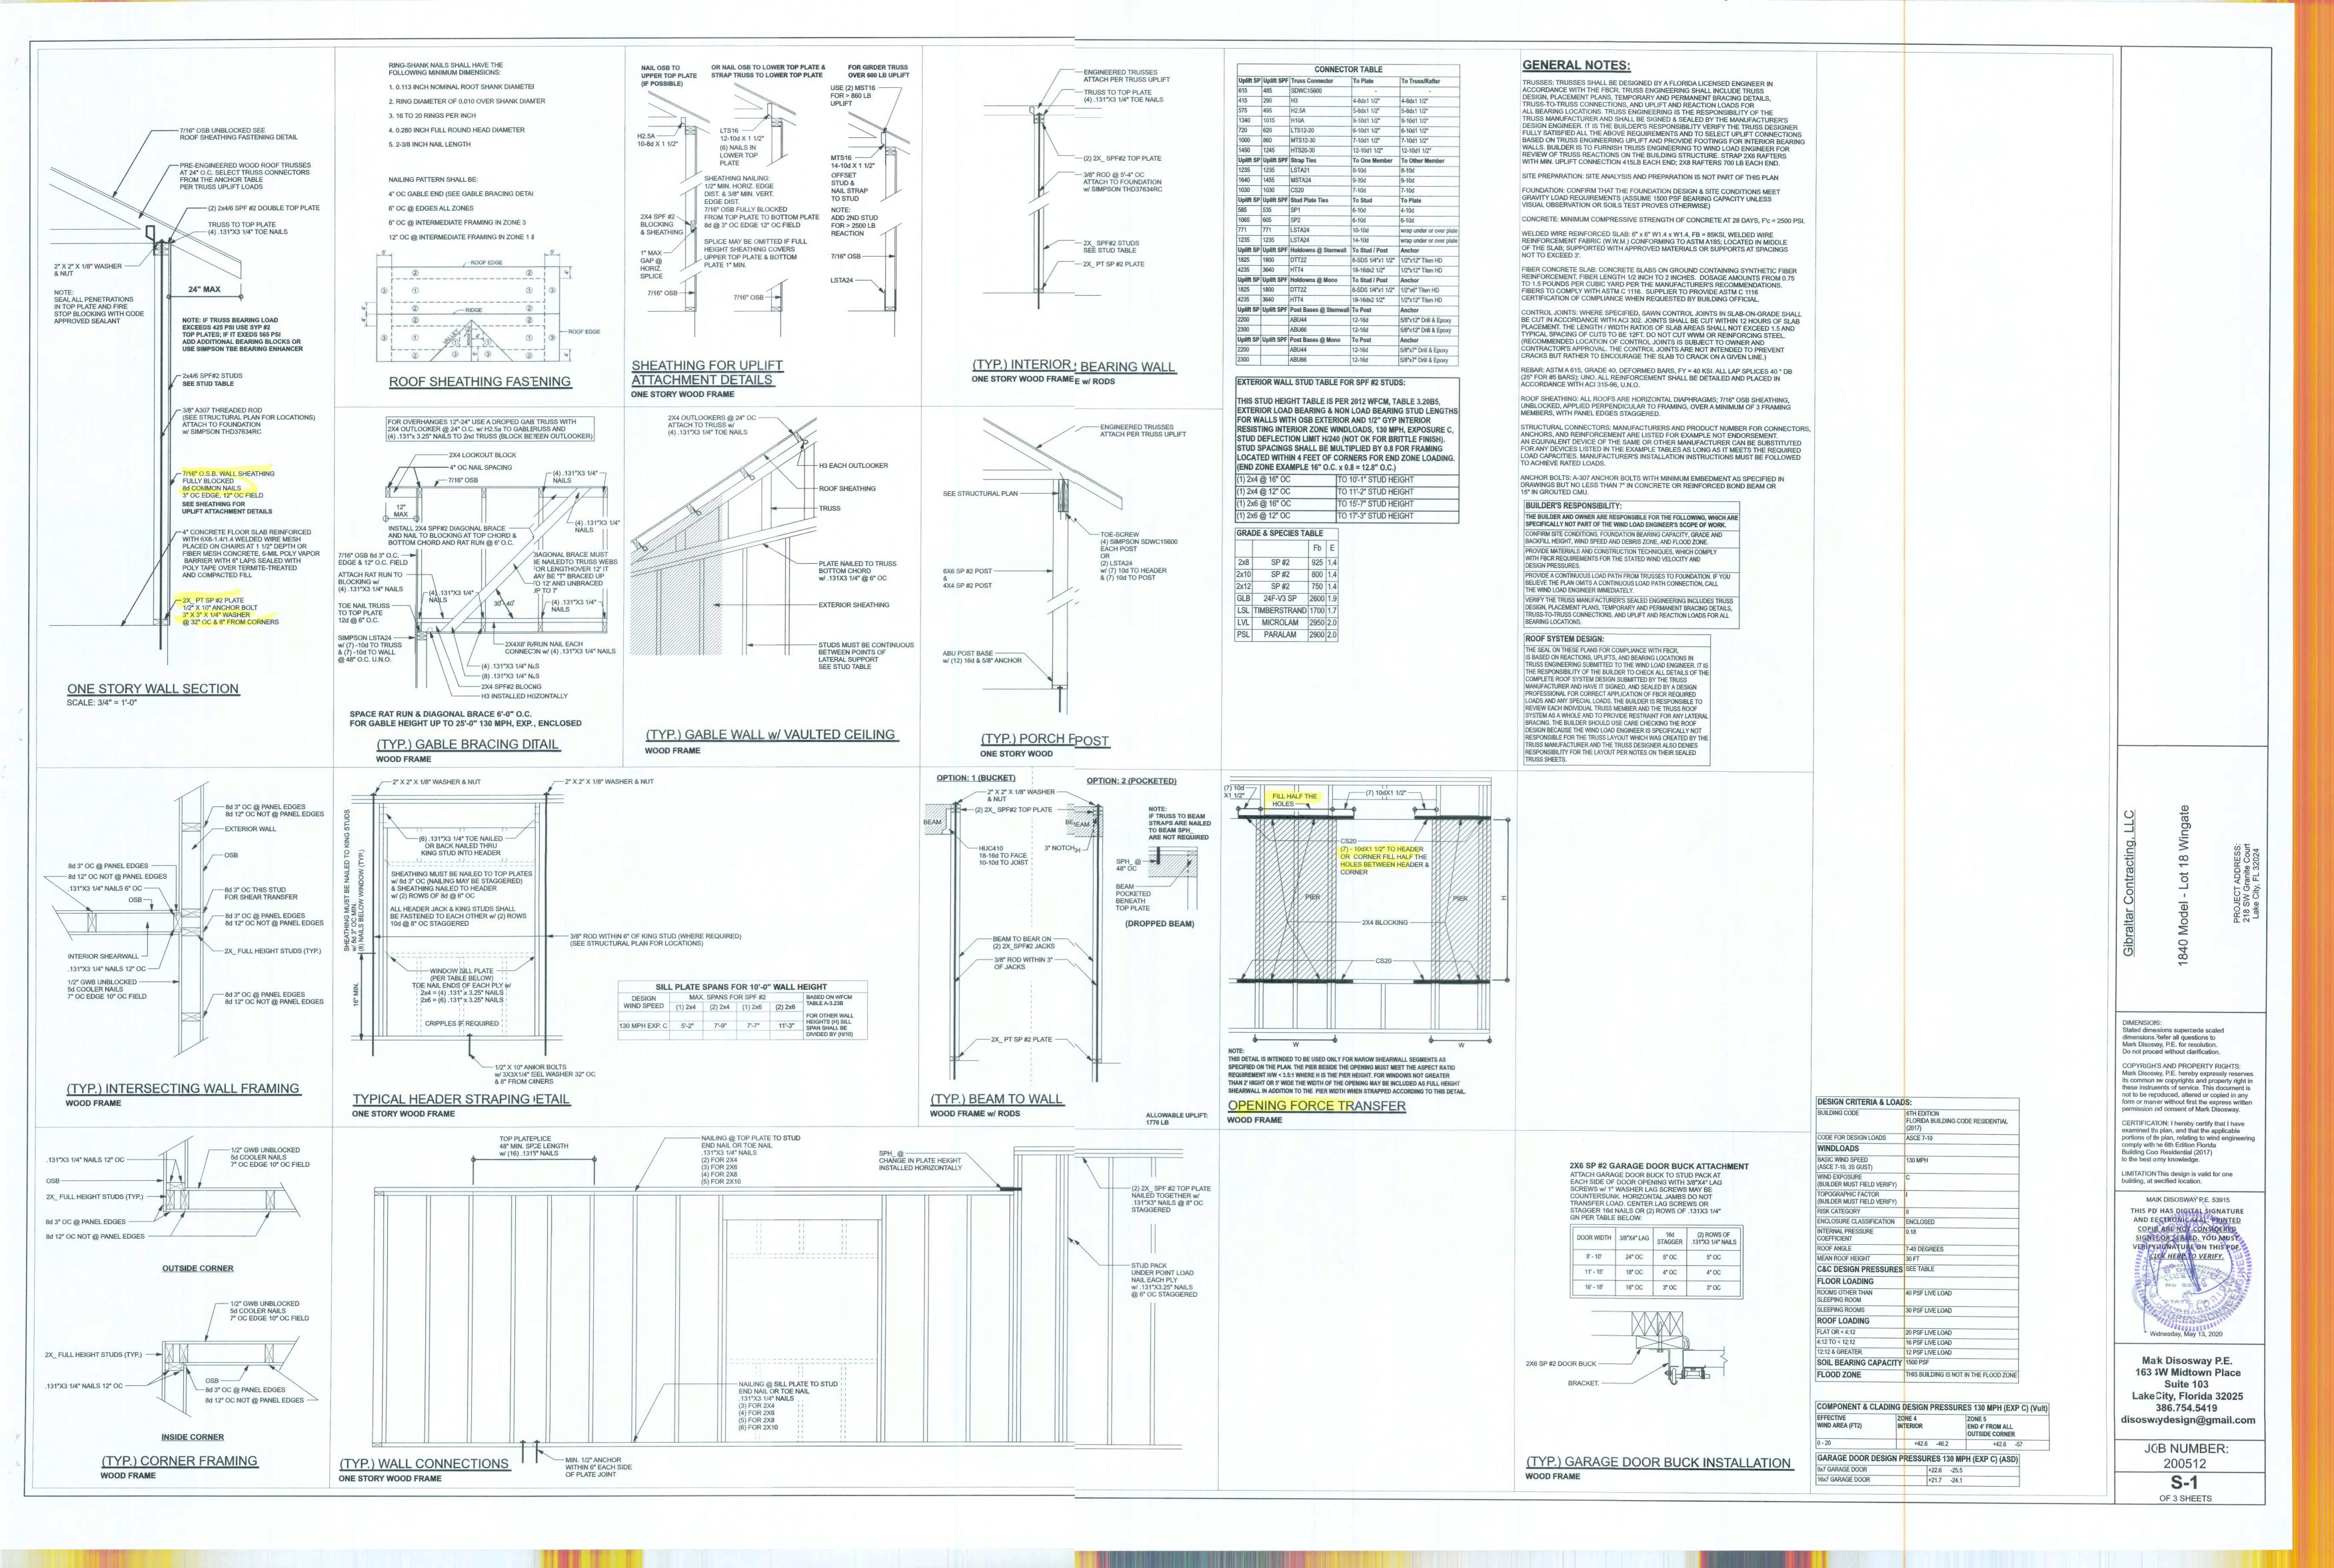

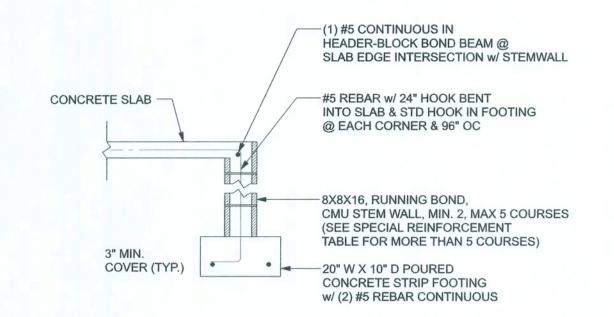

F1 OPTIONAL STEM WALL FOOTING
S-2 SCALE: 1/2" = 1'-0"

CONCRETE SLAB

12" W X 20" D FOR HOUSE

8
12" W X 16" D FOR PORCH
MONO FOOTING

F1 MONOLITHIC FOOTING
S-2 SCALE: 1/2" = 1'-0"

CONCRETE SLAB

16" W X 12" D

THICKENED SLAB FOOTING
W/ (2) #5 CONTINUOUS

w/ (2) #5 CONTINUOUS


F2 INTERIOR BEARING FOOTING
S-2 SCALE: 1/2" = 1'-0"

CONCRETE SLAB


16" W X 12" D

THICKENED SLAB FOOTING
W/ (2) #5 CONTINUOUS

F3 INTERIOR BEARING STEP FOOTING
S-2 SCALE: 1/2" = 1'-0"

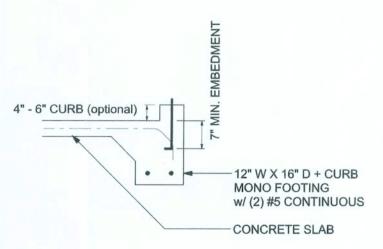

F4 MONOLITHIC CURB FOOTING
S-2 SCALE: 1/2" = 1'-0"

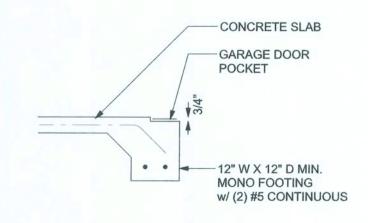

F5 GARAGE DOOR POCKET FOOTING
S-2 SCALE: 1/2" = 1'-0"

TALL FEM WALL TABLE:
The tde assumes 60 ksi reinforcing bars with 6" hook in the footing and bent 24" into the reinfoed slab at the top. The vertical steel is to be placed toward the tension side of the CMU all (away from the soil pressure, within 2" of the exterior side of the wall). If the wall is ove? high, add Durowall ladder reinforcement at 16"OC vertically or a horizontal bond beamith 1#5 continuous at mid height. For higher parts of the wall 12" CMU may be used with reforcement as shown in the table below.

STEMALL UNBALANCED BACKFILL FOR 8" CMU STEMWALL (INCHES O.C.)


#5 #7 #8 #5 #7 #8

3 3.0 96 96 96 96 96 96 96 96 96


4. 3.7 96 96 96 96 96 96 96 96

MASNRY CONSTRUCTION AND MATERIALS FOR THIS PROJECT SHAL CONFORM TO ALL REQUIREMENTS OF "SPECIFICATION FOR ASONRY STRUCTURES" (ACI 530.1/ASCE 6/TMS 602). THE ONTRACTOR AND MASON MUST IMMEDIATELY, BEFORE PROCEDING, NOTIFY THE ENGINEER OF ANY CONFLICTS BETWEN ACI 530.1-02 AND THESE DESIGN DRAWINGS. ANY KCEPTIONS TO ACI 530.1-02 MUST BE APPROVED BY THE NGINEER IN WRITING.			
	ACI530.1-02 Section	Specific Requirements	
1.4A	Compressive strength	8" block bearing walls F'm = 1500 psi	
2.1	Mortar	ASTM C 270, Type N, UNO	
2.2	Grout	ASTM C 476, admixtures require approval	
2.3	CMU standard	ASTM C 90-02, Normal weight, Hollow, medium surface finish, 8"x8"x16" running bond and 12"x12" or 16"x16" column block	
2.3	Clay brick standard	ASTM C 216-02, Grade SW, Type FBS, 5.5"x2.75"x11.5"	
2.4	Reinforcing bars, #3 - #11	ASTM 615, Grade 40, Fy = 40 ksi, Lap splices min 40 bar dia. (25" for #5)	
2.4F	Coating for corrosion protection	Anchors, sheet metal ties completely embedded in mortar or grout, ASTM A525, Class G60, 0.60 oz/ft2 or 304SS	
2.4F	Coating for corrosion protection	Joint reinforcement in walls exposed to moisture or wire ties, anchors, sheet metal ties not completely embedded in mortar or grout, ASTM A153, Class B2, 1.50 oz/ft2 or 304SS	
3.3.E.2	Pipes, conduits, and accessories	Any not shown on the project drawings require engineering approval.	
3.3.E.7	Movement joints	Contractor assumes responsibility for type and location of movement joints if not detailed on project drawings.	

BCTOM OF EXTERIOR FOOTINGS SHALL BE A MINIMUM OF 123ELOW UNDISTURBED SOIL OR ENGINEERED FILL PEFBC 2014-RES. SECTION R403.1.4

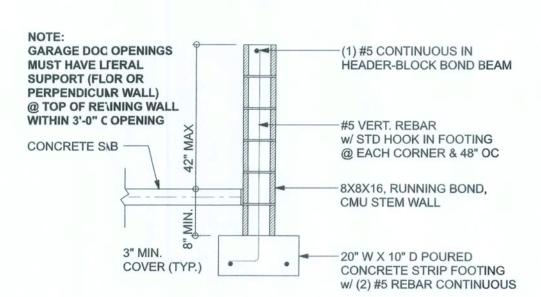

S-. SCALE: 1/2" = 1'-0"

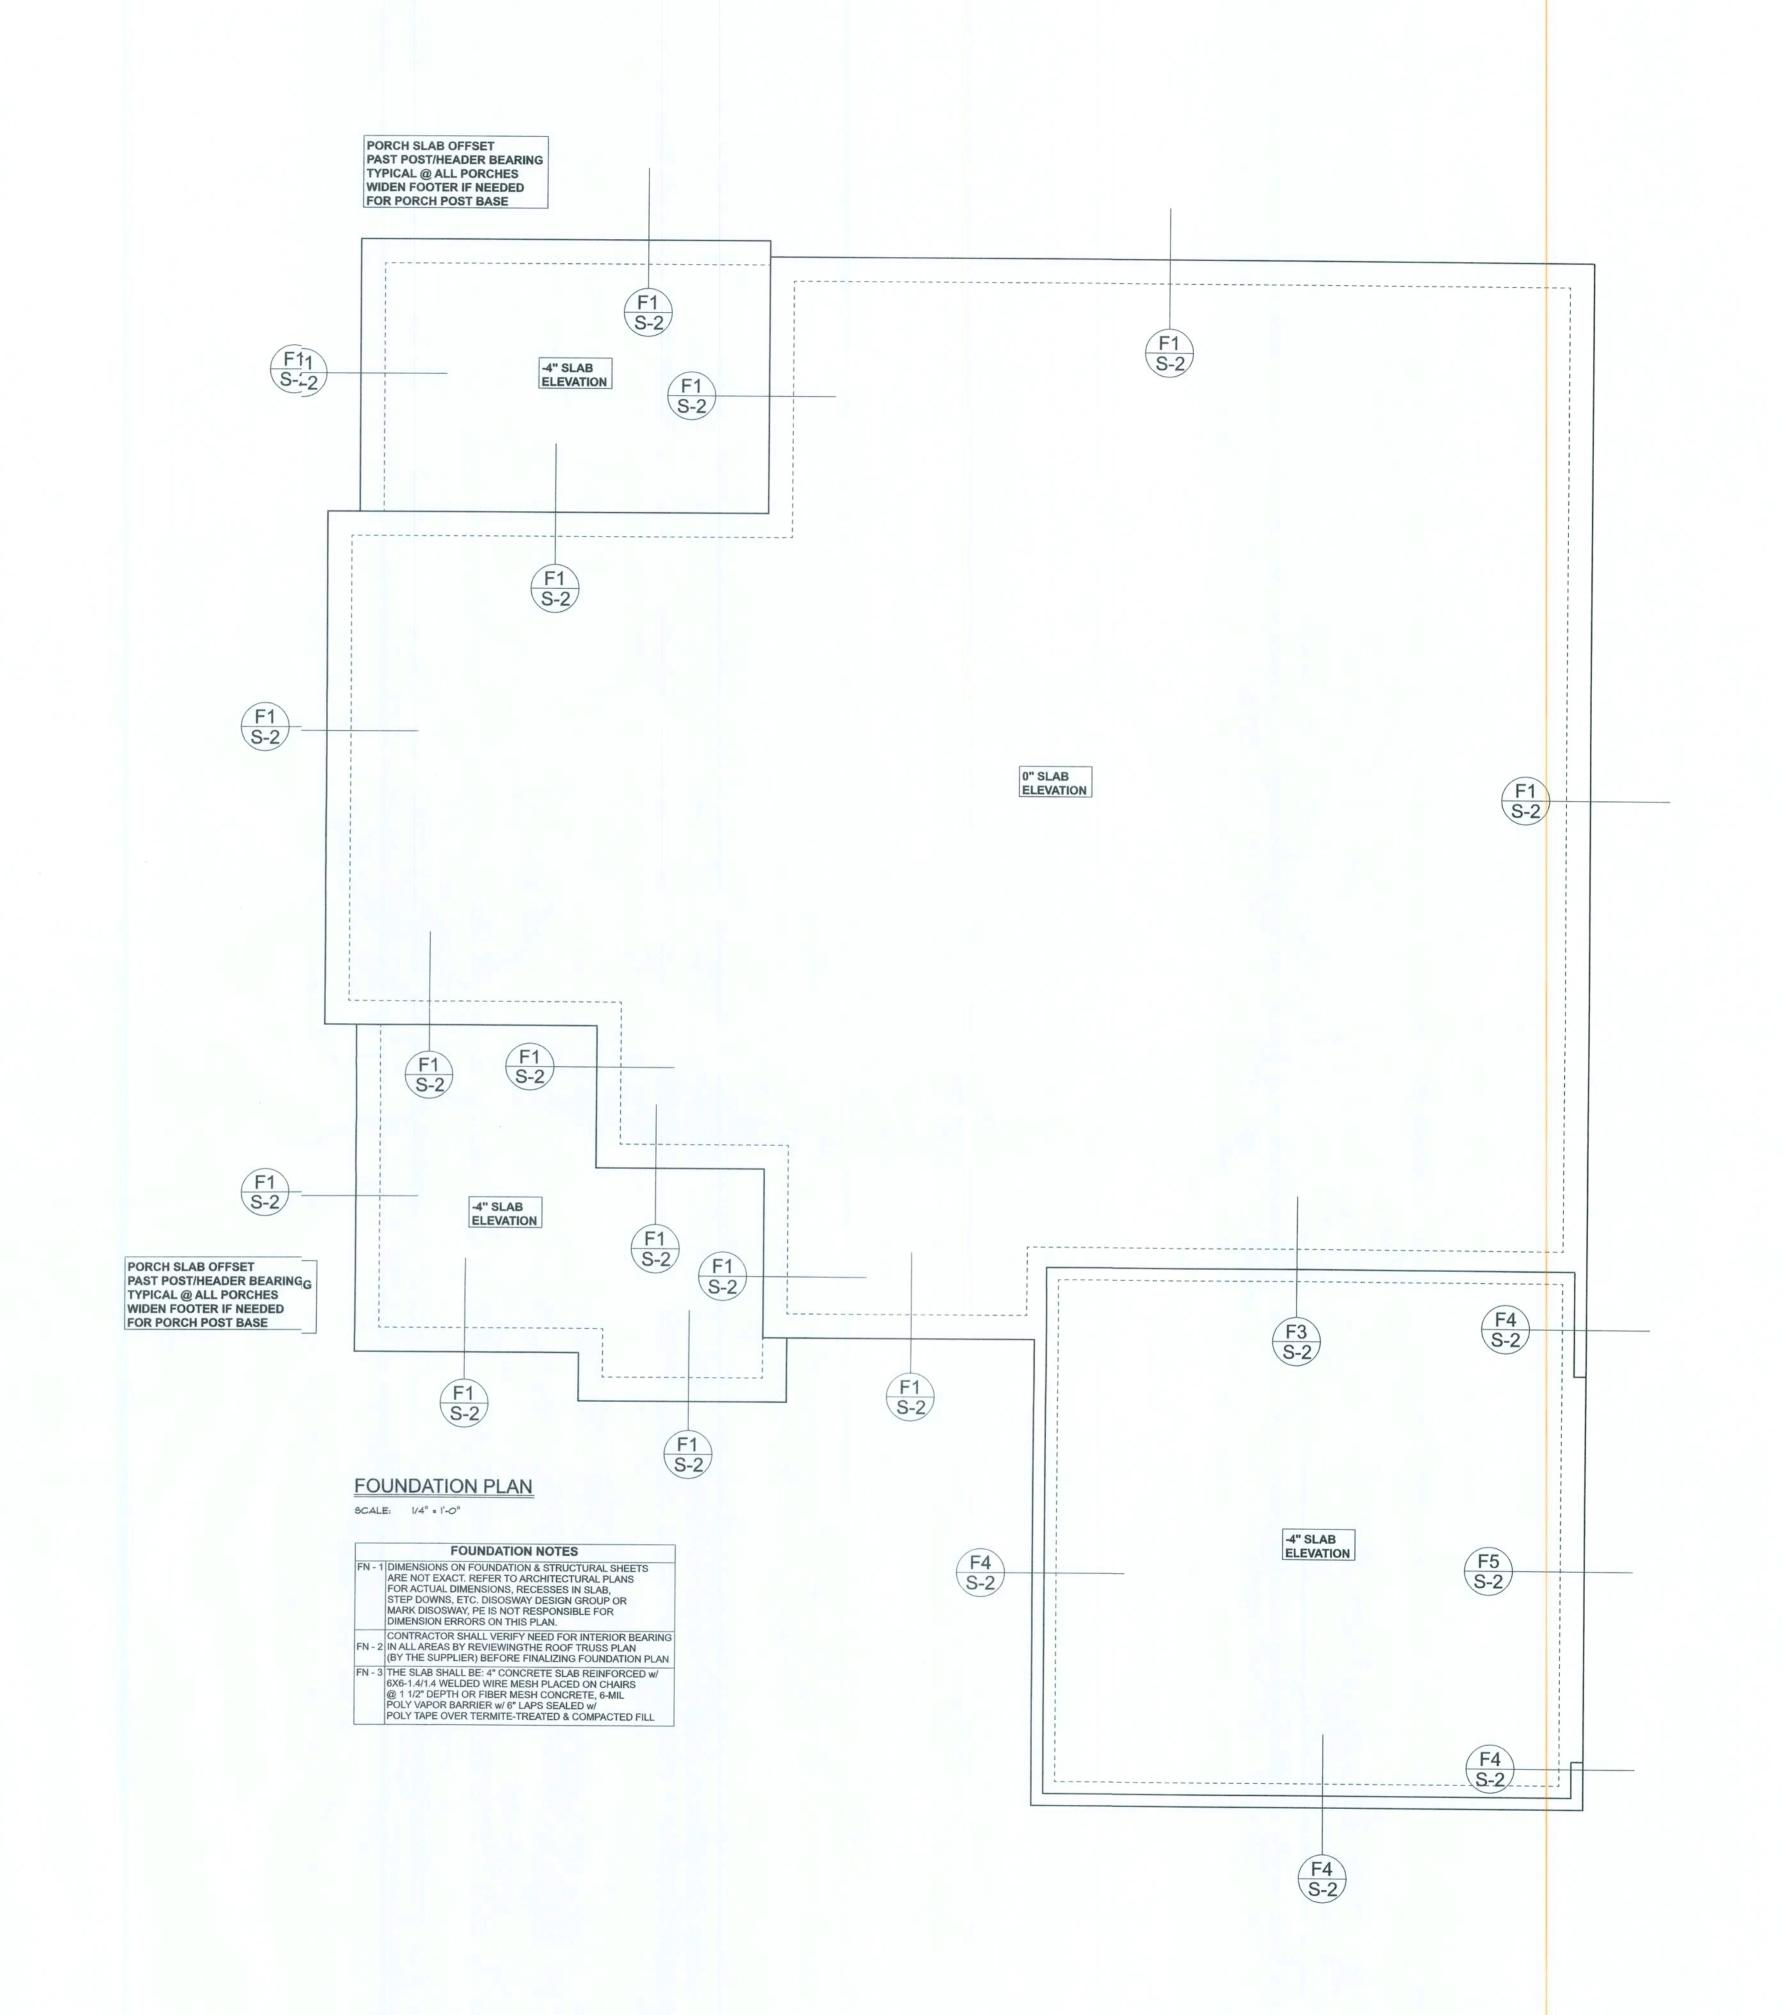

DIMENSONS:

Stated dinensions supercede scaled

dimensios. Refer all questions to Mark Dissway, P.E. for resolution.

Do not poceed without clarification.

COPYRISHTS AND PROPERTY RIGHTS: Mark Dissway, P.E. hereby expressly reserves

its common law copyrights and property right in these insruments of service. This document is not to be eproduced, altered or copied in any form or nanner without first the express written

permissin and consent of Mark Disosway.

CERTIFICATION: I hereby certify that I have

portions of the plan, relating to wind engineering comply with the 6th Edition Florida

IARK DISOSWAY P.E. 53915

THIS POF HAS DIGHTAU SIGNATURE AN ELECTRODIC SEAL PRINTED CIPIES ARE NOT CONSIDERED

VERFY SIGNATURE ON THIS POE COCK HERE TO VERIFY.

Wednesday, May 13, 2020

Nark Disosway P.E.
16: SW Midtown Place
Suite 103
Lake City, Florida 32025
386.754.5419
disosvaydesign@gmail.com

OB NUMBER: 200512

S-2 OF 3 SHEETS

examinerthis plan, and that the applicable

LIMITATION: This design is valid for one building, it specified location.

Building (ode Residential (2017) to the bet of my knowledge.

