


SECTION

FRONT & REAR ELLEVATIONS
SCALE: TYPICAL SCALE:

C. Barnet ACTING, I Patricia D, Country Lake in Woodboroug GIBRALTA

© WM DEJGN &
A550CIATE5, INC.
426 SW COMMERCE DR, STE 130
LAKE CITY, FL 32025
(386) 758-8406
will@willmyers.net

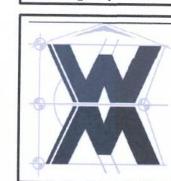

JOB NUMBER 20210417

SHEET NUMBER

A.1

NOTE: ALL DRAWINGS NOT TO BE SCALED, WRITTEN DIMENSIONS TAKE PRECEDENCE OVER SCALED DIMENSIONS






Dorough, Columbia County, Florida 32055

SCALE: SCALE: 11.0


Alvin and Patricia Barnett
PROJECT ADDRESS: Lot), Country Lake in Woodborough, Columbia County, Florida 32055
GIBRALTA? CONTRACTING, LLC.

© WM DEJGN &
A550CIATE 5. INC.
426 SW COMMERCE DR, STE 130
LAKE CITY, FL 32025
(386) 758-8406
will@willmyers.net

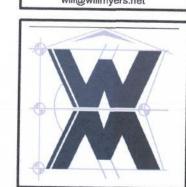

JOB NUMBER 20210417

SHEET NUMBER

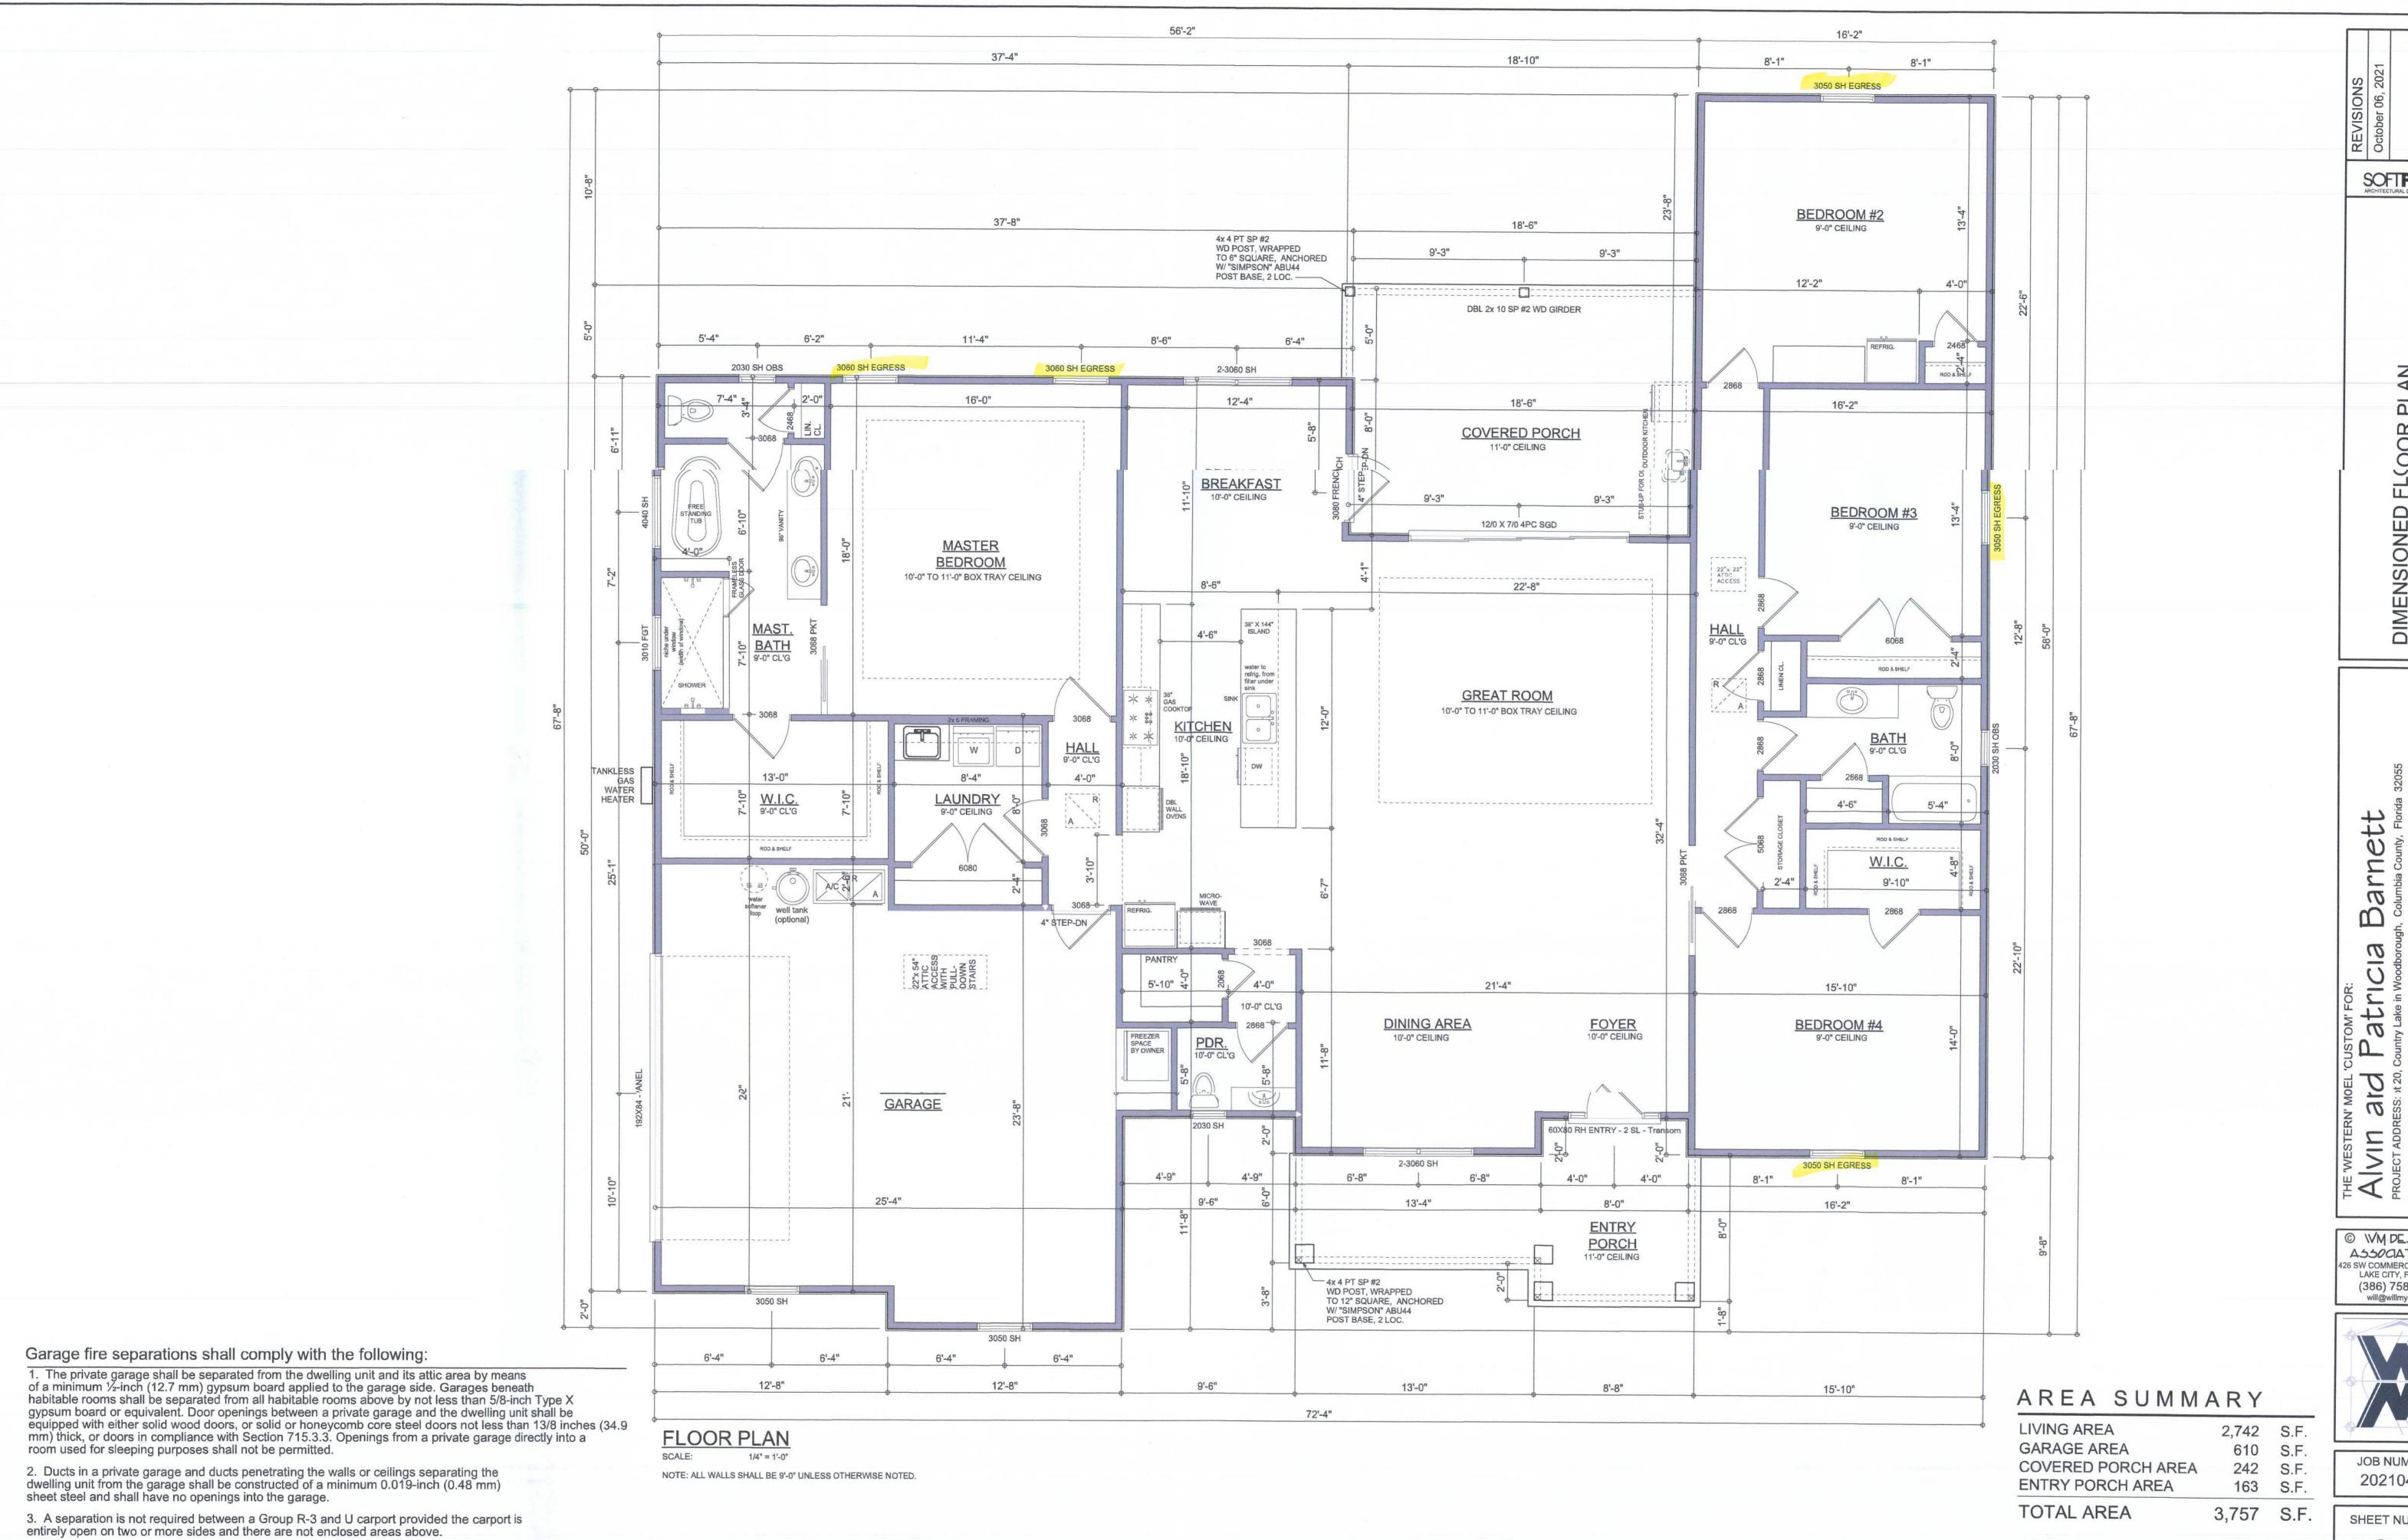

DIMENSIONED FL(OOR

Barnett TING Patricia Woodborou NO

3 NOPE SIGN O ASSOCIATES, INC. 426 SW COMMERCE DR, STE 130 LAKE CITY, FL 32025 (386) 758-8406 will@willmyers.net

GIBR




JOB NUMBER 20210417

SHEET NUMBER A.3

NOTE: ALL DRAWINGS NOT TO BE SCALED, WRITTEN DIMENSIONS TAKE PRECEDENCE OVER SCALED DIMENSIONS

4. When installing an attic access and/or pull-down stair unit in the garage, devise shall have a minimum 20 min. fire rating.

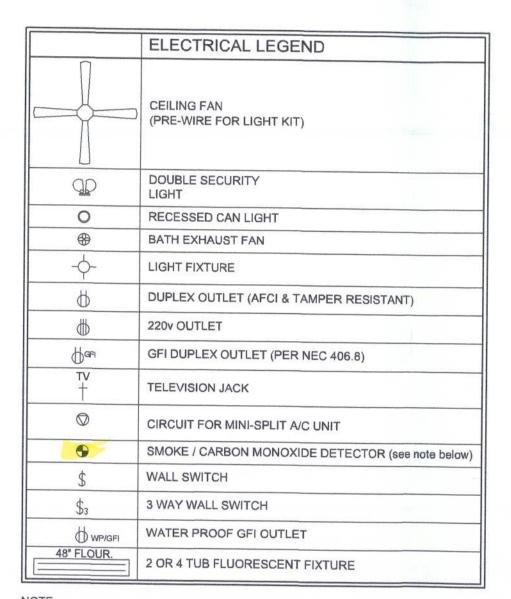


NOTE: ALL INTERIOR RECEPTACLES SHALL BE AFCI (ARC FAULT CIRCUIT INTERRUPT) PER NEC 210.12 & TAMPER RESISTANT PER NEC 406.11

ALL INTERIOR & EXTERIOR LIGHTING SHALL MEET OR EXCEED THE MIN. 75% HIGH-EFFICIENCY LIGHTING PER FBC-ENERGY CONSERVATION R404.

ALL SMOKE DETECTORS BE A COMBO SMOKE & CARBON MONOXIDE DETECTOR AND SHALL HAVE BATTERY BACKUP POWER AND ALL WIRED TOGETHER SO IF ANY ONE UNIT IS ACTUATED THEY

INSTALLED ON THE EXTERIOR OF STRUCTURES TO SERVE AS A DISCONNECT MEANS. CONDUCTORS USED FROM THE EXTERIOR DISCONNECTING MEANS TO A PANEL OR SUB PANEL SHALL HAVE FOUR-WIRE CONDUCTORS, OF WHICH ONE CONDUCTOR SHALL BE USED AS AN EQUIPMENT GROUND.

IT IS THE LICENSED ELECTRICAL CONTRACTORS RESPONSIBILITY TO INSURE THAT ALL WORK PERFORMED AND EQUIPMENT INSTALLED MEETS OR EXCEEDS THE 2017 (NFPA-70) NATIONAL ELECTRIC CODE AND ALL OTHER LOCAL CODES AND ORDINANCES.

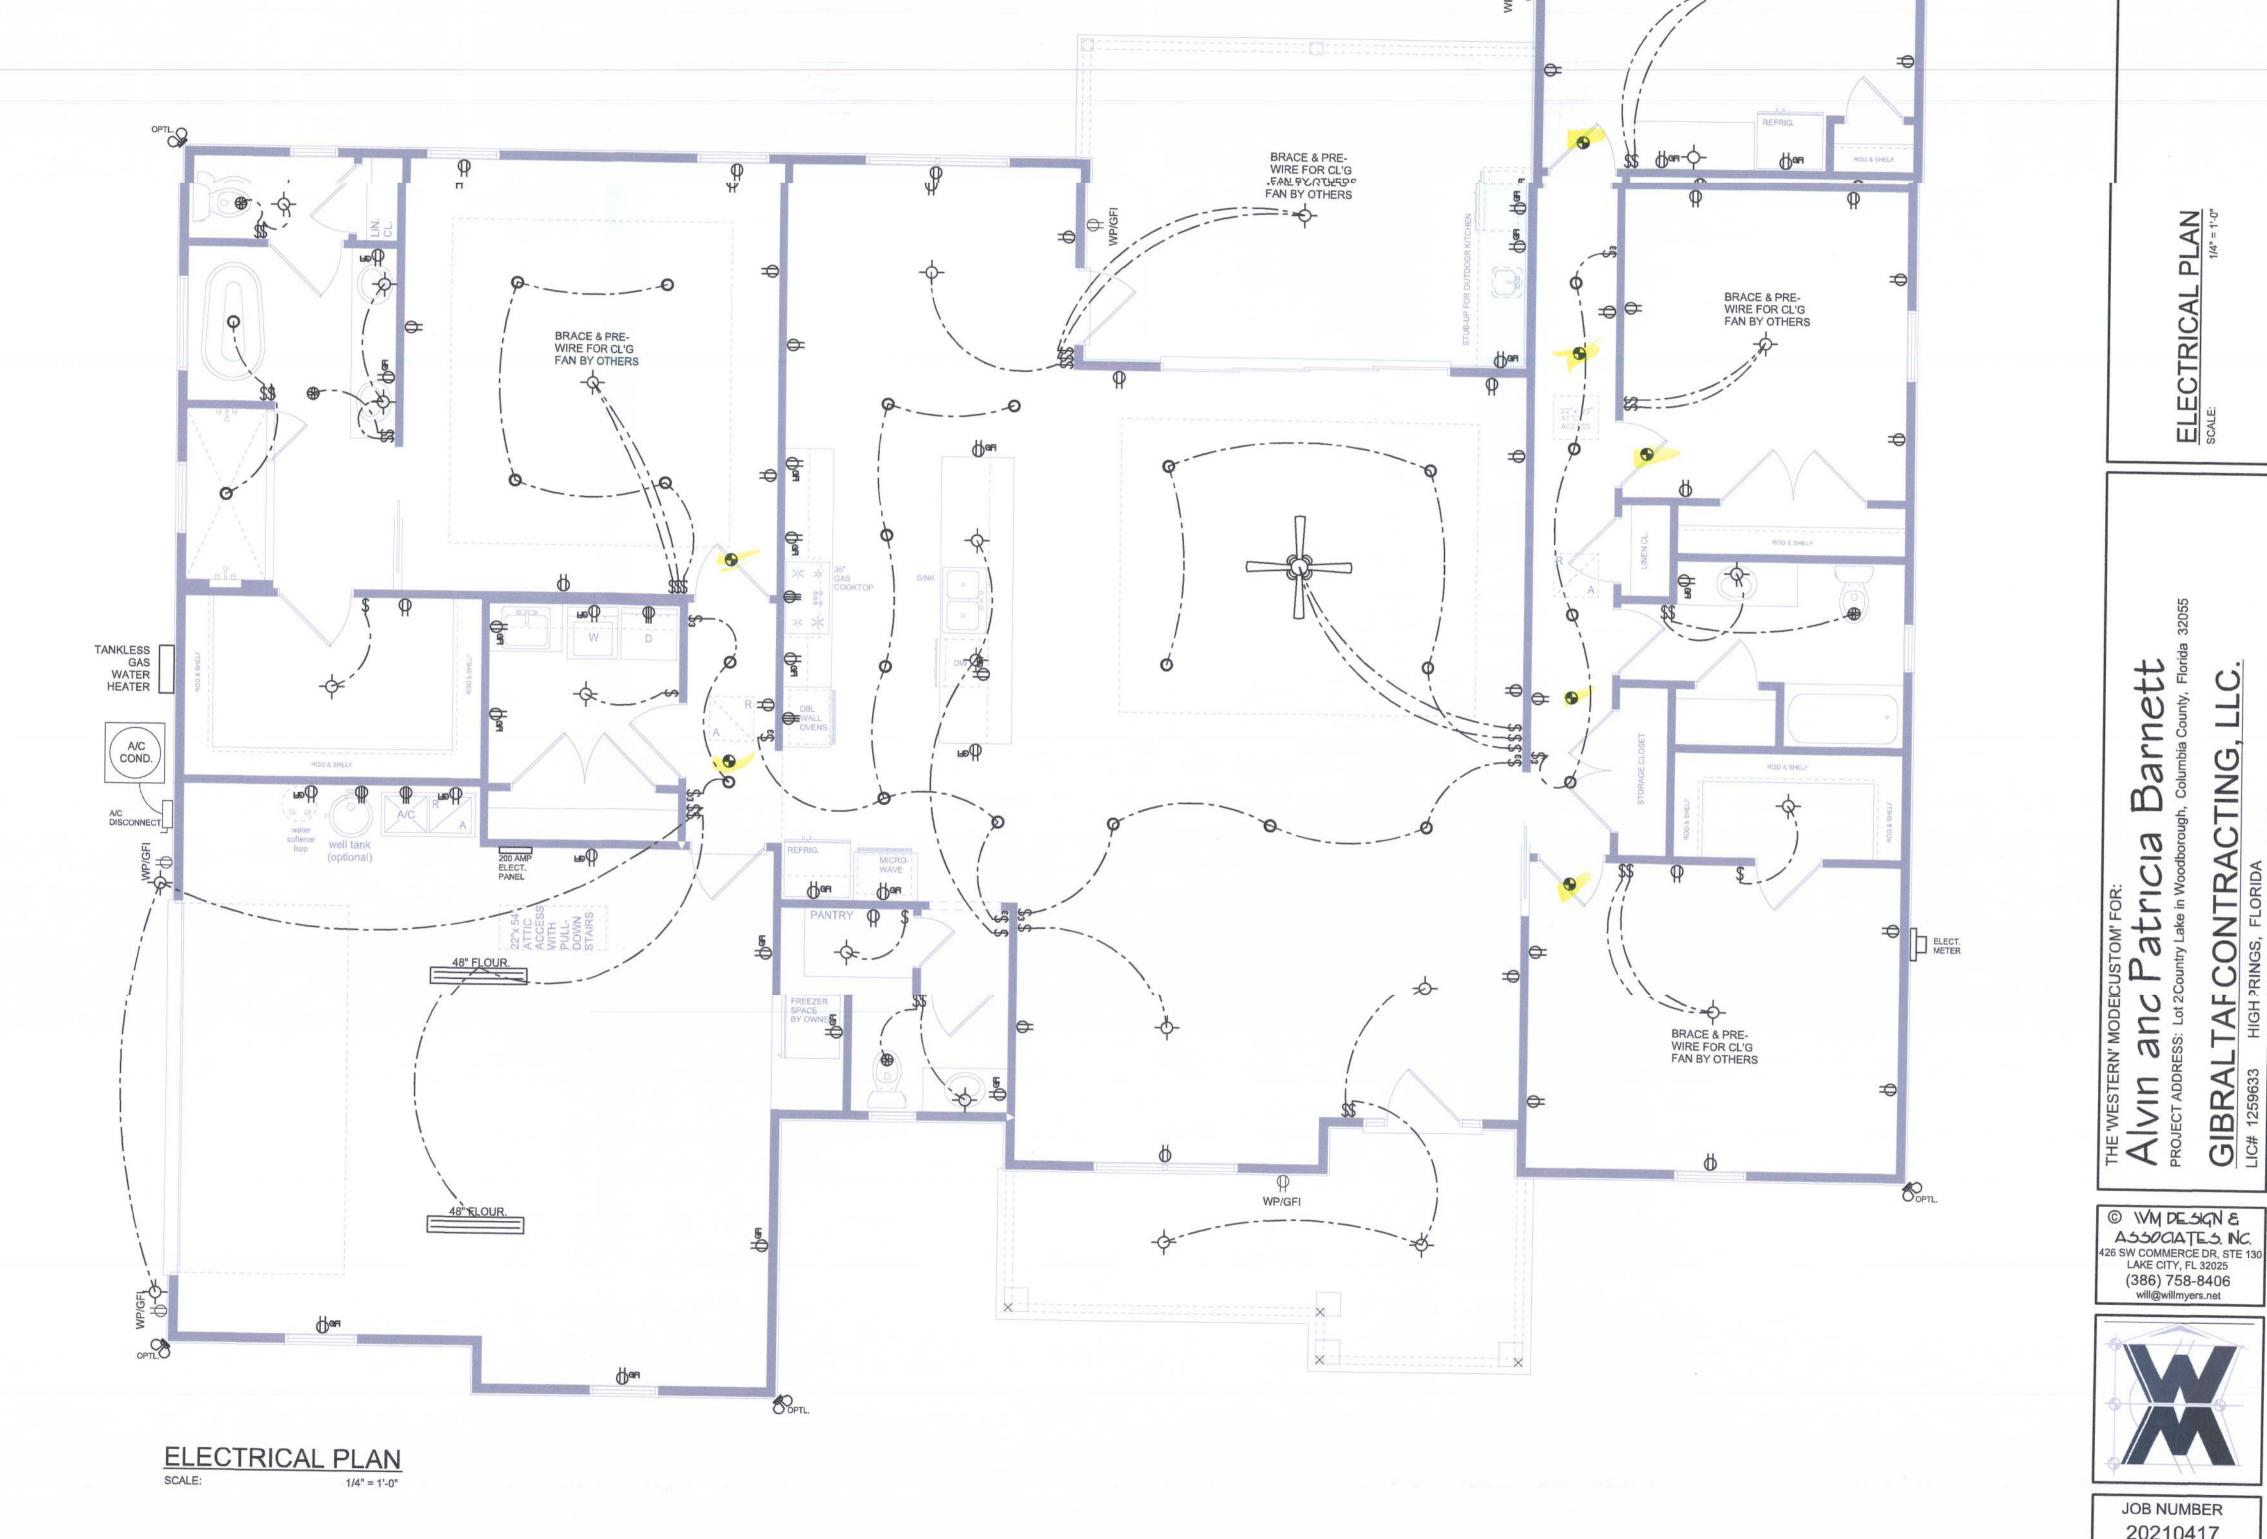

SOFTPIAN SOFTMARE

ELECTRICAL PLAN

Barnett

TOM' FUR.

atricia

frv Lake in Woodborou

DNT


GIBR.


(386) 758-8406 will@willmyers.net


JOB NUMBER 20210417


SHEET NUMBER


BRACE & PRE-WIRE FOR CL'G FAN BY OTHERS

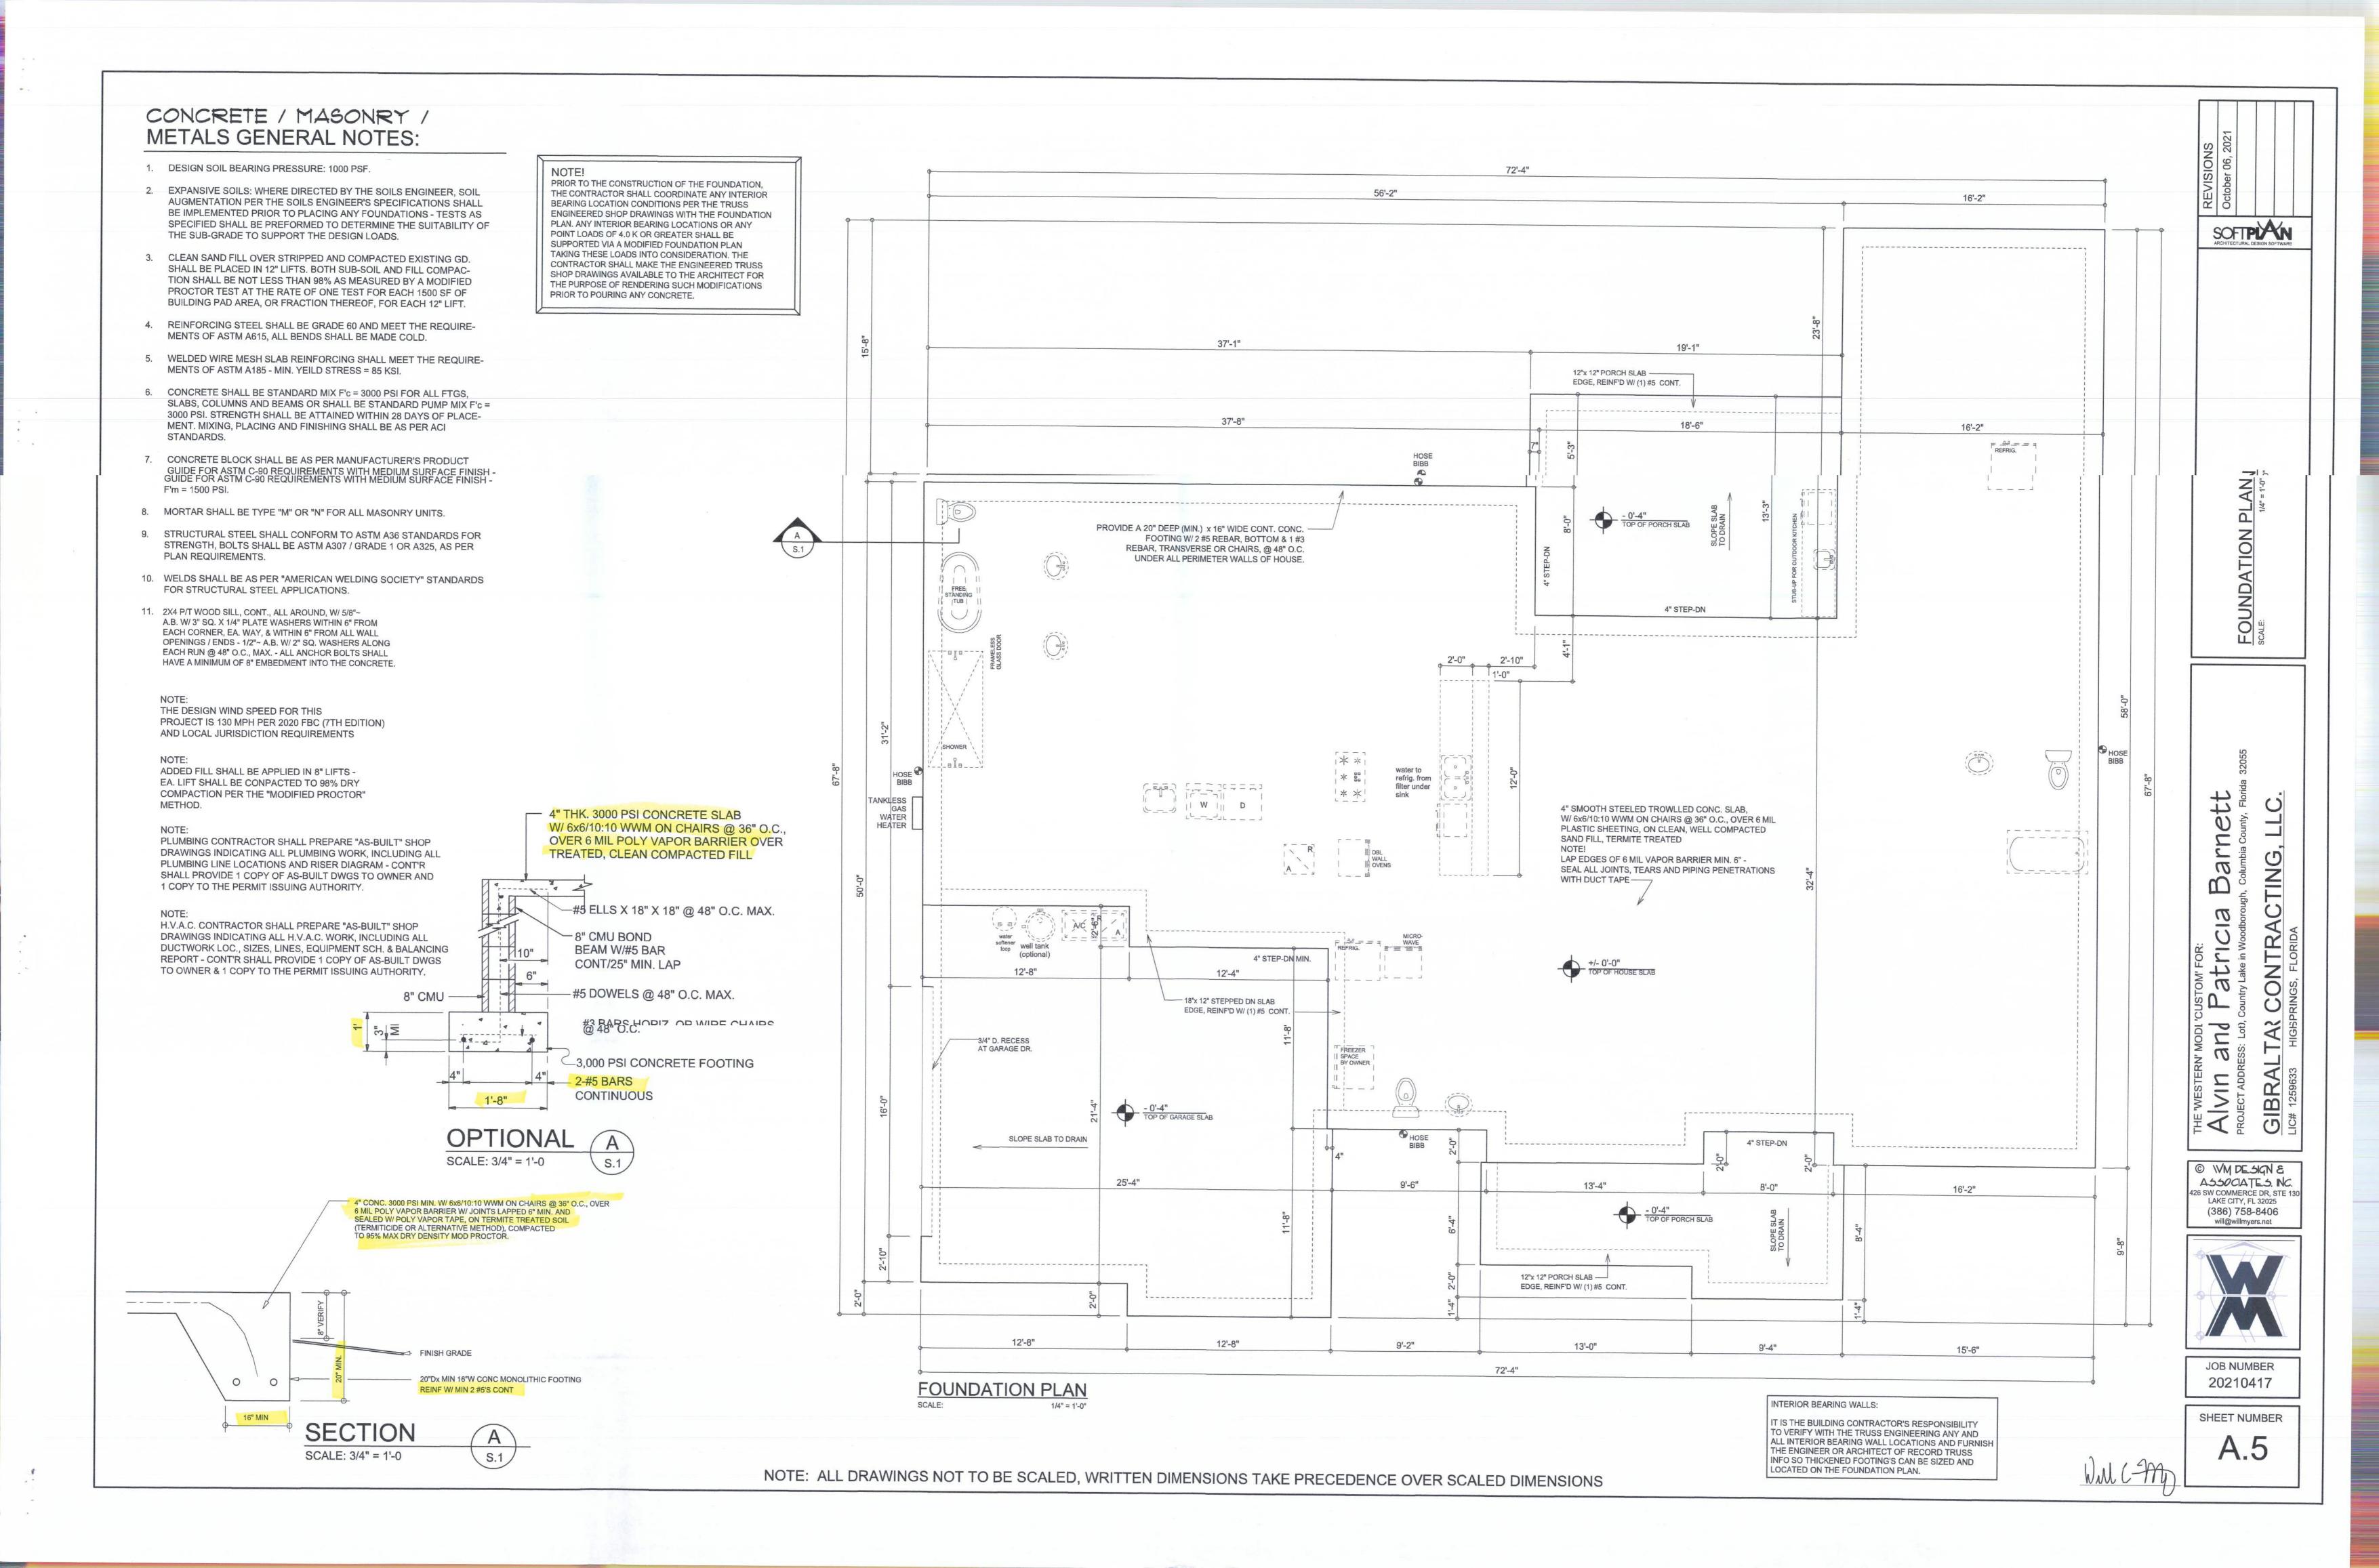

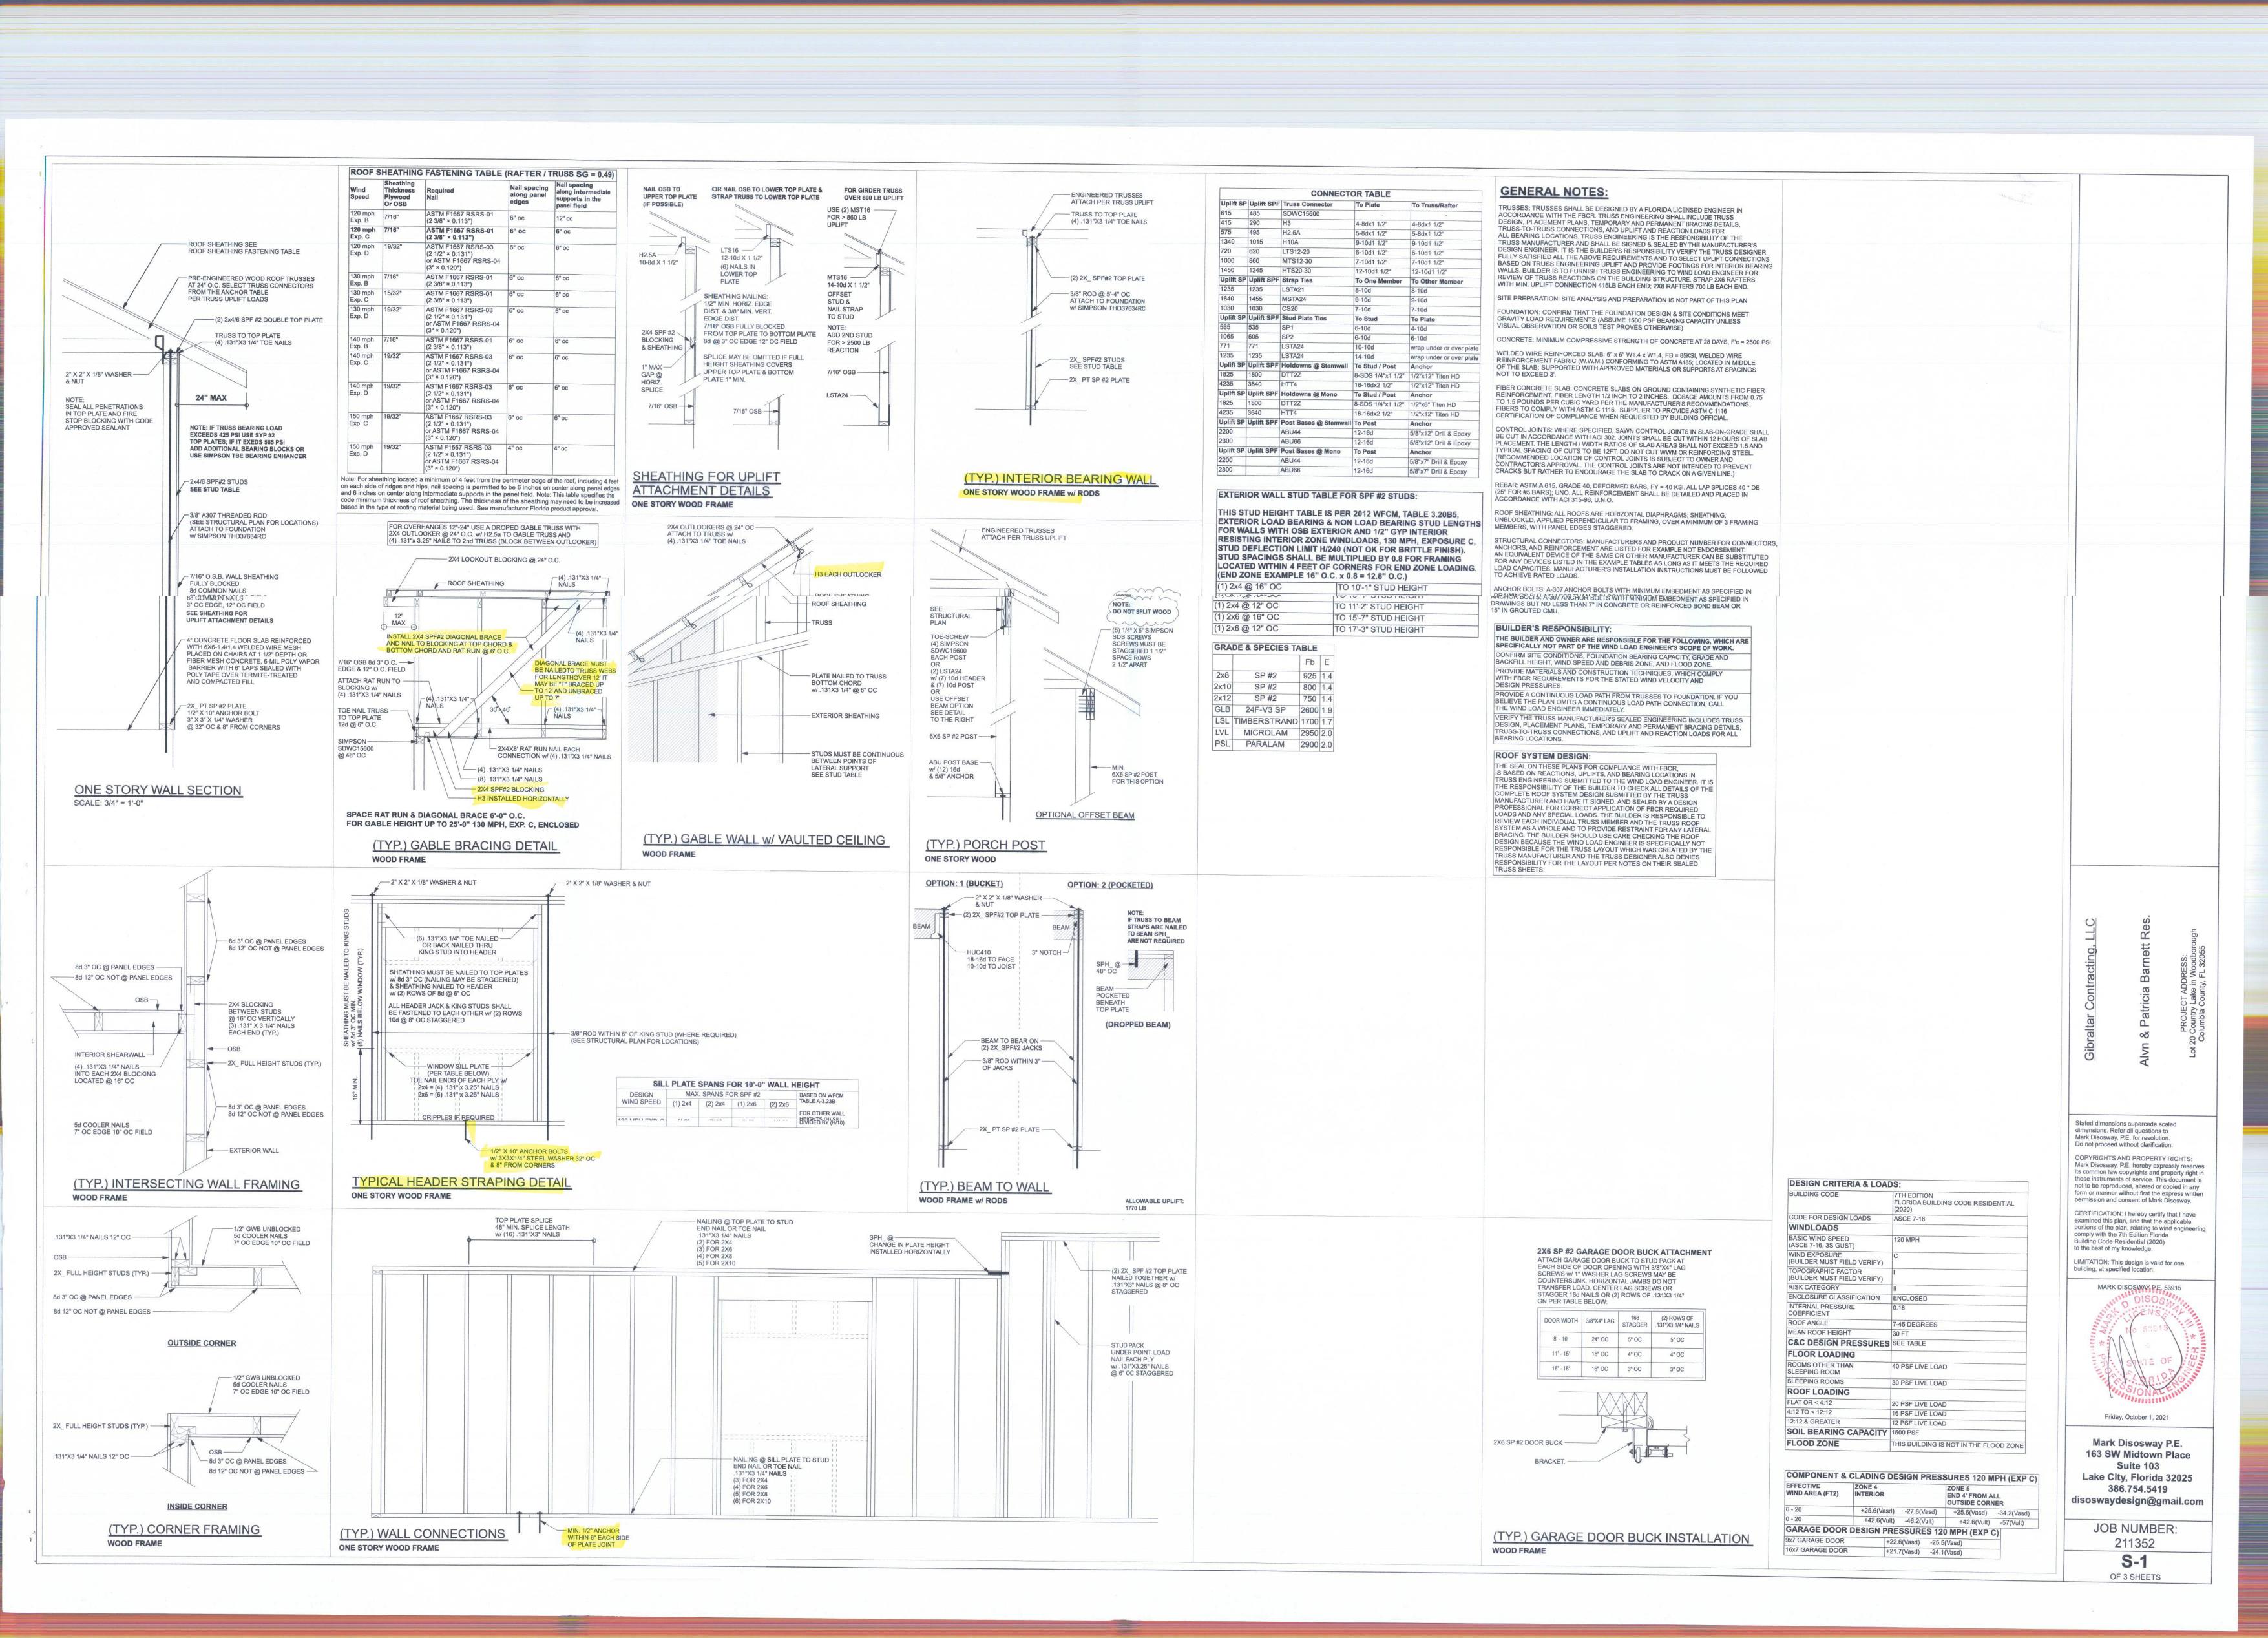


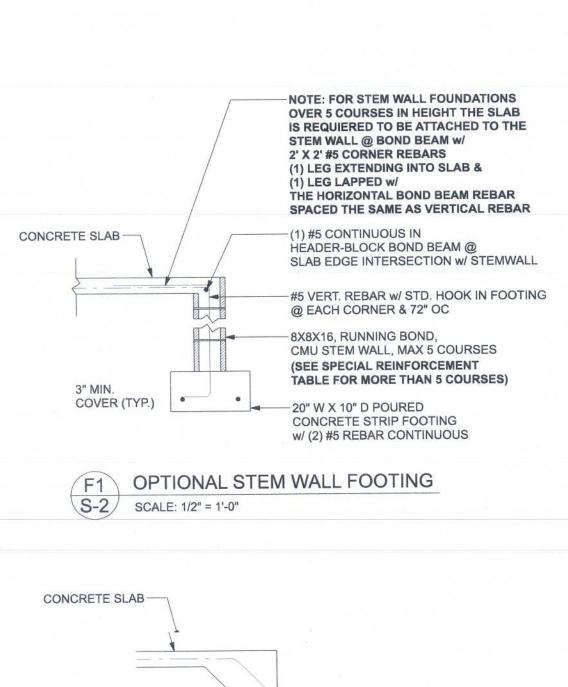

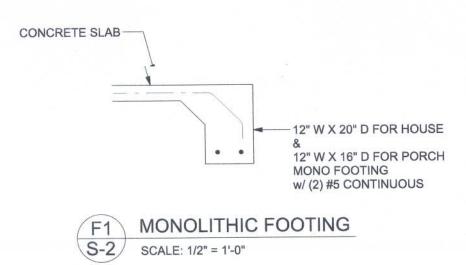


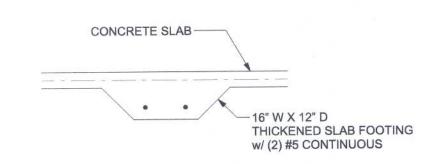


F2 INTERIOR BEARING FOOTING
S-2 SCALE: 1/2" = 1'-0"

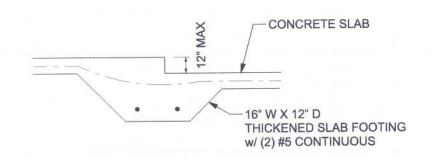

F3 INTERIOR BEARING STEP FOOTING S-2 SCALE: 1/2" = 1'-0"

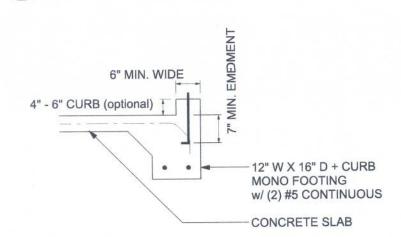

F4 MONOLITHIC S-2 SCALE: 1/2" = 1'-0" MONOLITHIC CURB FOOTING

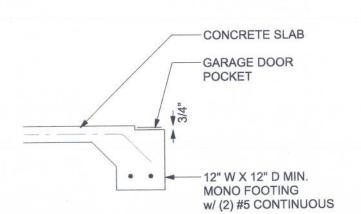


F5 GARAGE DO S-2 SCALE: 1/2" = 1'-0" GARAGE DOOR POCKET FOOTING

The table as coting and oward the table of the vertically or	WALL TABLE: sumes 40 ksi for bent 24" into the ension side of the wall). If the wall is a horizontal bor CMU may be use	e reinforce ne CMU was s over 8' had beam w	d slab at the all (away fro ligh, add Du rith 1#5 con	e top. The vom the soil urowall ladd tinuous at r	vertical steel pressure, w er reinforce nid height. F	is to be platithin 2" of the ment at 16" For higher p	aced ne exterior 'OC
STEMWALL HEIGHT (FEET)	UNBALANCED BACKFILL HEIGHT	VERTIC:	CAL REINFORCEMENT 8" CMU STEMWALL (INCHES O.C.)		VERTICAL REINFORCEMENT FOR 12" CMU STEMWALL (INCHES O.C.)		
		#5	#7	#8	#5	#7	#8
3.3	3.0	96	96	96	96	96	96
4.0	3.7	96	96	96	96	96	96
4.7	4.3	88	96	96	96	96	96
5.3	5.0	56	96	96	96	96	96
6.0	5.7	40	80	96	80	96	96
6.7	6.3	32	56	80	56	96	96
7.3	7.0	24	40	56	40	80	96
8.0	7.7	16	32	48	32	64	80
8.7	8.3	8	24	32	24	48	64
9.3	9.0	8	16	24	16	40	48


	SONRY NOTE:
MA	SONRY CONSTRUCTION AND MATERIALS FOR THIS PROJECT
	ALL CONFORM TO ALL REQUIREMENTS OF "SPECIFICATION
FO	R MASONRY STRUCTURES" (ACI 530.1/ASCE 6/TMS 602).
TH	E CONTRACTOR AND MASON MUST IMMEDIATELY, BEFORE
PR	OCEEDING, NOTIFY THE ENGINEER OF ANY CONFLICTS
	TWEEN ACI 530.1-02 AND THESE DESIGN DRAWINGS.
AN	Y EXCEPTIONS TO ACI 530.1-02 MUST BE APPROVED BY
	E ENGINEER IN WRITING.

	ACI530.1-02 Section	Specific Requirements		
1.4A	Compressive strength	8" block bearing walls F'm = 1500 psi		
.4A	Compressive strength	O DIOUN DESITING Mans, L, 111 . 1000 hor		
2.1	Mortar	ASTM C 270, Type N, UNO		
2.2	Grout	ASTM C 476, admixtures require approval		
2.3	CMU standard	ASTM C 90-02, Normal weight, Hollow, medium surface finish, 8"x8"x16" running bond and 12"x12" or 16"x16" column block		
2.3	Clay brick standard	ASTM C 216-02, Grade SW, Type FBS, 5.5"x2.75"x11.5"		
2.4	Reinforcing bars, #3 - #11	ASTM 615, Grade 40, Fy = 40 ksi, Lap splices min 40 bar dia. (25" for #5)		
2.4F	Coating for corrosion protection	Anchors, sheet metal ties completely embedded in mortar or grout, ASTM A525, Class G60, 0.60 oz/ft2 or 304SS		
2.4F	Coating for corrosion protection	Joint reinforcement in walls exposed to moisture or wire ties, anchors, sheet metal ties not completely embedded in mortar or grout, ASTM A153, Class B2, 1.50 oz/ft2 or 304SS		
3.3.E.2	Pipes, conduits, and accessories	Any not shown on the project drawings require engineering approval.		
3.3.E.7	Movement joints	Contractor assumes responsibility for type and location of movement joints if not detailed on project drawings.		

BOTTOM OF EXTERIOR FOOTINGS SHALL BE A MINIMUM OF 12" BELOW UNDISTURBED SOIL OR ENGINEERED FILL

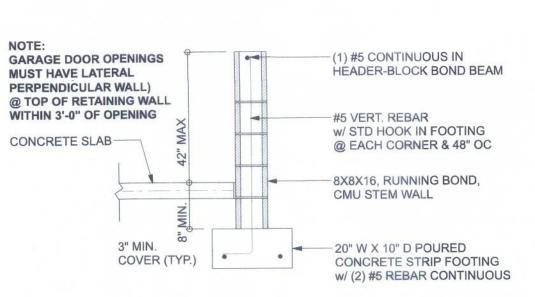

OPTIONAL STEM WALL CURB FOOTING SCALE: 1/2" = 1'-0"

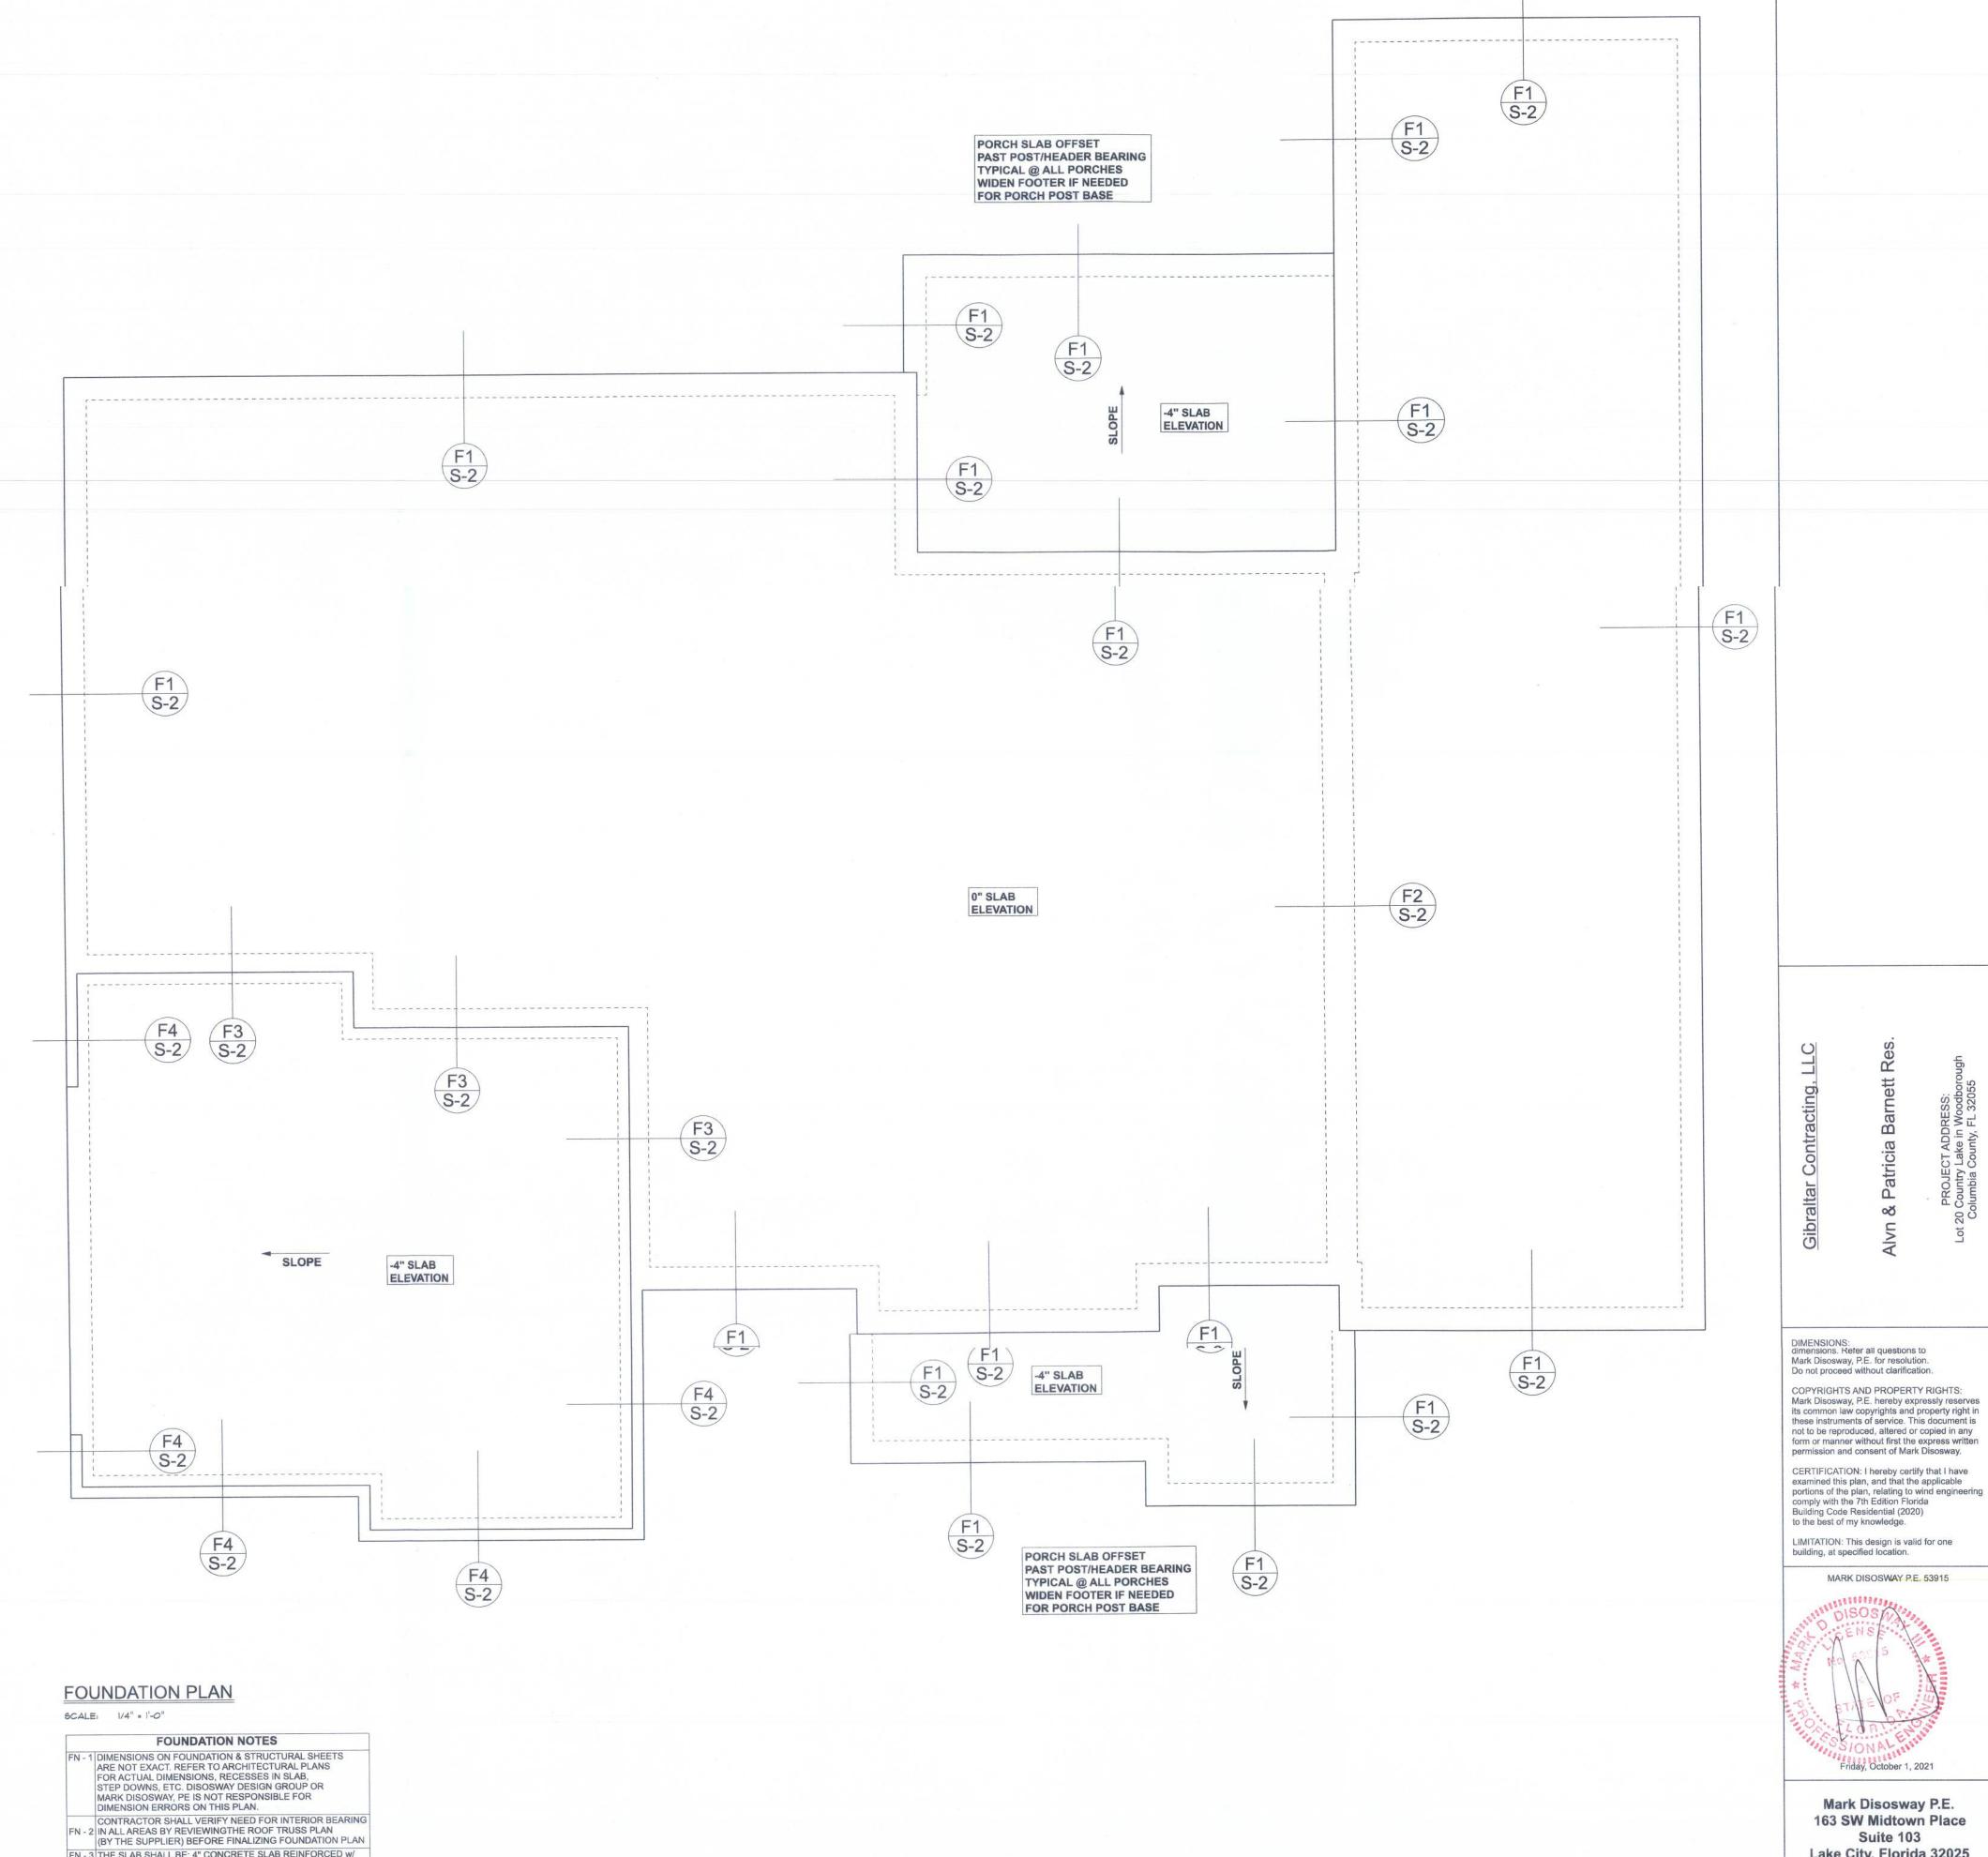


FN - 1	DIMENSIONS ON FOUNDATION & STRUCTURAL SHEETS ARE NOT EXACT. REFER TO ARCHITECTURAL PLANS FOR ACTUAL DIMENSIONS, RECESSES IN SLAB, STEP DOWNS, ETC. DISOSWAY DESIGN GROUP OR MARK DISOSWAY, PE IS NOT RESPONSIBLE FOR DIMENSION ERRORS ON THIS PLAN.
FN - 2	CONTRACTOR SHALL VERIFY NEED FOR INTERIOR BEARING IN ALL AREAS BY REVIEWINGTHE ROOF TRUSS PLAN (BY THE SUPPLIER) BEFORE FINALIZING FOUNDATION PLAN
FN - 3	THE SLAB SHALL BE: 4" CONCRETE SLAB REINFORCED W/ 6X6-1.4/1.4 WELDED WIRE MESH PLACED ON CHAIRS @ 1 1/2" DEPTH OR FIBER MESH CONCRETE, 6-MIL POLY VAPOR BARRIER W/ 6" LAPS SEALED W/ POLY TAPE OVER TERMITE-TREATED & COMPACTED FILL

Mark Disosway P.E. 163 SW Midtown Place Suite 103 Lake City, Florida 32025 386.754.5419 disoswaydesign@gmail.com

> JOB NUMBER: 211352

S-2 OF 3 SHEETS

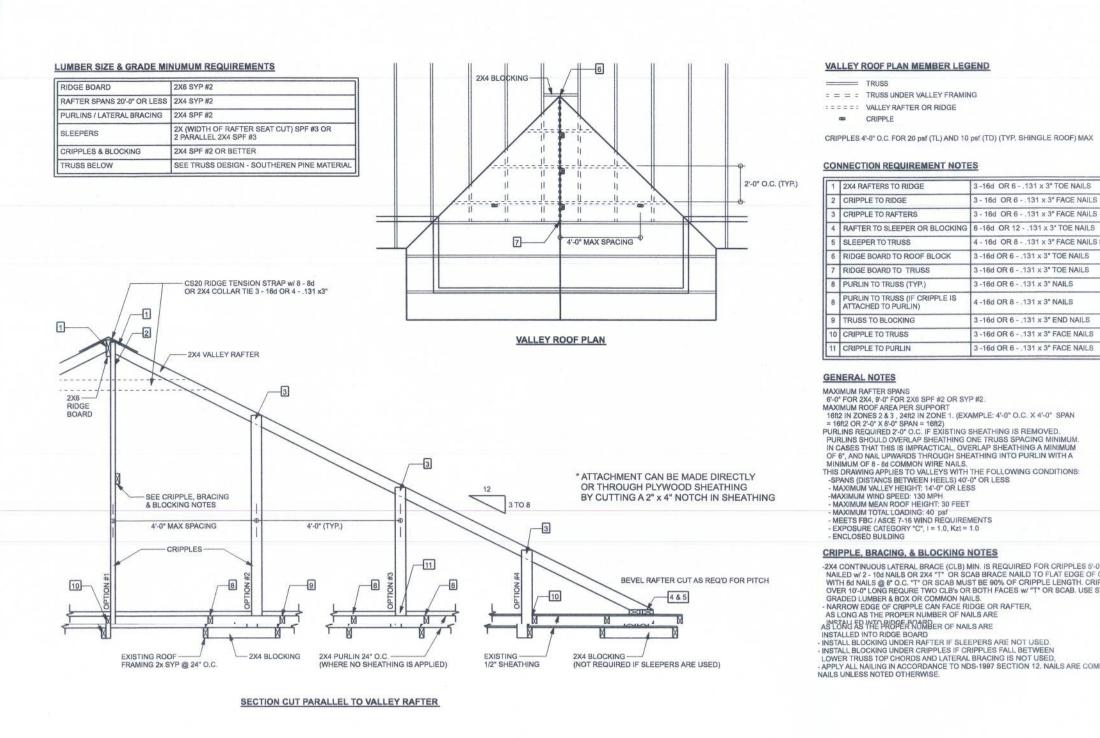

3 -16d OR 6 - .131 x 3" TOE NAILS

3 -16d OR 6 - .131 x 3" TOE NAILS 3 -16d OR 6 - .131 x 3" NAILS

3 -16d OR 6 - .131 x 3" END NAILS


3 -16d OR 6 - .131 x 3" FACE NAILS

3 -16d OR 6 - .131 x 3" FACE NAILS

3 - 16d OR 6 - .131 x 3" FACE NAILS

3 - 16d OR 6 - .131 x 3" FACE NAILS

ROOF OVER FRAMING & BRACING DETAIL

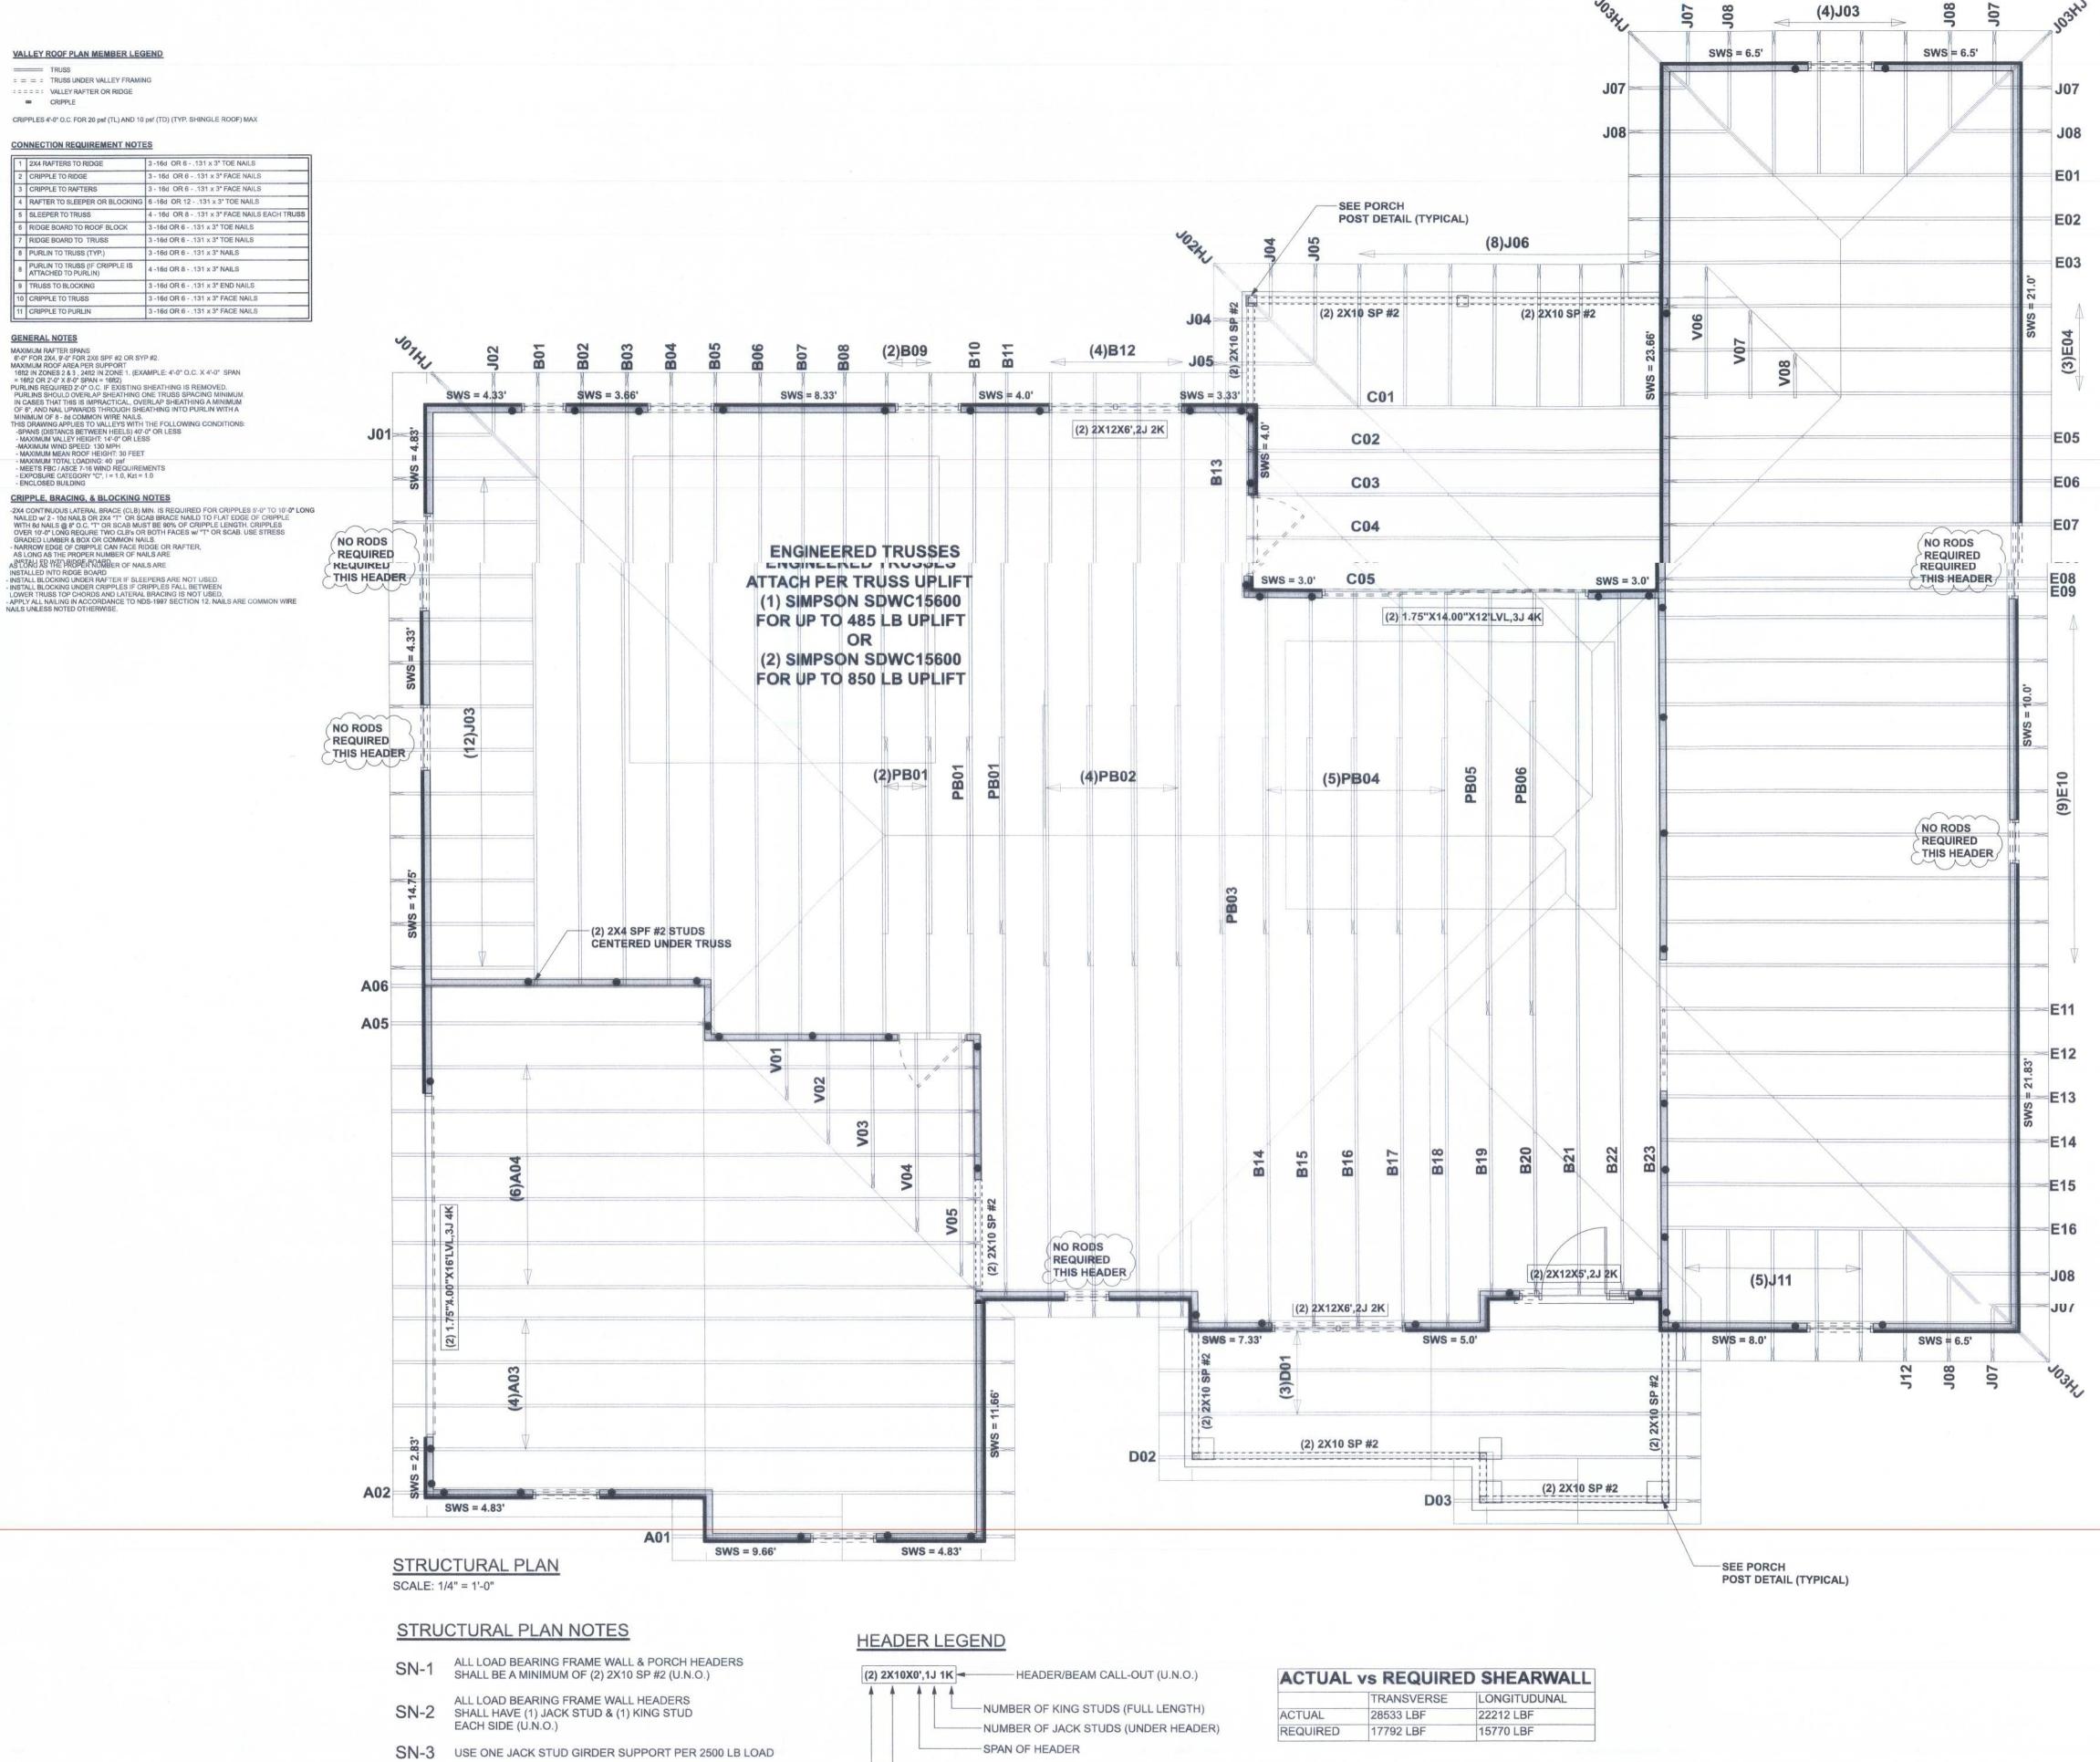

DIMENSIONS ON STRUCTURAL SHEETS ARE NOT EXACT. REFER TO ARCHITECTURAL FLOOR PLAN FOR ACTUAL DIMENSIONS

PERMANENT TRUSS BRACING IS TO BE INSTALLED AT LOCATIONS AS SHOWN ON THE SEALED TRUSS DRAWINGS. LATERAL BRACING IS TO BE RESTRAINED PER BCSI1-03, BCSI-B1, BCSI-B2, & BCSI-B3. BCSI-B1, BCSI-B2, & BCSI-B3 ARE FURNISHED BY THE TRUSS SUPPLIER, WITH THE SEALED TRUSS PACKAGE

SIZE OF HEADER MATERIAL -NUMBER OF PLIES IN HEADER

THREADED ROD LEGEND

- INDICATES LOCATION OF: 3/8" A307 ALL THREADED ROD

CONNECTIONS, WALL, & HEADER DESIGN IS BASED ON REACTIONS & UPLIFTS FROM TRUSS ENGINEERING FURNISHED BY BUILDER. W.B. HOWLAND TRUSS CO. JOB #21-6101

Stated dimensions supercede scaled dimensions. Refer all questions to Mark Disosway, P.E. for resolution.

Do not proceed without clarification. COPYRIGHTS AND PROPERTY RIGHTS: Mark Disosway, P.E. hereby expressly reserves its common law copyrights and property right in these instruments of service. This document is not to be reproduced, altered or copied in any form or manner without first the express written permission and consent of Mark Disosway. CERTIFICATION: I hereby certify that I have

examined this plan, and that the applicable portions of the plan, relating to wind engineering comply with the 7th Edition Florida

LIMITATION: This design is valid for one

MARK DISOSWAY P.E. 53915

Building Code Residential (2020) to the best of my knowledge.

building, at specified location.

Mark Disosway P.E. 163 SW Midtown Place Suite 103 Lake City, Florida 32025 386.754.5419 disoswaydesign@gmail.com

JOB NUMBER: 211352 **S-3**

OF 3 SHEETS