



ATC SITE NAME: COLUMBIA (CHARLES) FL

ATC SITE NUMBER: 417139

T-MOBILE SITE NAME: 9JK2817A (USA) T-MOBILE SITE NUMBER: 9JK2817A SITE ADDRESS: CHARLES TERRACE LAKE CITY,FL 32024



PROJECT SUMMARY

CHARLES LUTHER DANIEL

1119 SW CYPRESS LAKE DR

LAKE CITY,FL 32024



LOCATION MAP

REV:

DATE

BY:

SHEET INDEX

DESCRIPTION:

SUPPLEMENTAL

SUPPLEMENTAL

SUPPLEMENTAL

ANTENNA MOUNTS:

PROPOSED (3) SECTOR FRAME BY SABRE, PART NUMBER #C10857001C

T-MOBILE COVERAGE STRATEGY COLLOCATION PLAN 4SEC-67E5D998E 6160 CONFIGURATION

PROJECT DESCRIPTION

SHEET NO:

R-612

R-613

R-614

COMPLIANCE CODE ALL WORK SHALL BE PERFORMED AND MATERIALS INSTALLED IN ACCORDANCE WITH THE CURRENT EDITIONS OF THE FOLLOWING CODES AS ADOPTED BY THE LOCAL GOVERNMENT AUTHORITIES. NOTHING IN THESE PLANS IS TO BE CONSTRUED TO PERMIT WORK NOT CONFORMING TO

- 2023 FLORIDA BUILDING CODE, 8TH EDITION
- ANSI/TIA-222-H
- 8TH EDITION FLORIDA FIRE PREVENTION CODE (NFPA 70)

Call 811 or visit sunshine811 com two full

business days before digging to have buried

facilities located and marked

check positive response codes before you dig!

- 2020 NATIONAL ELECTRICAL CODE
- BASIC WIND SPEED: 118 MPH Vult (3-SECOND GUST) EXPOSURE CATEGORY: C RISK CATEGORY: II

CITY/COUNTY ORDINANCES

SITE ADDRESS: G-001 TITLE SHEET 01/19/24 MS CHARLES TERRACE LAKE CITY FL 32024 G-002 GENERAL NOTES MS 01/19/24 COUNTY: COLUMBIA THE PROPOSED PROJECT INCLUDES INSTALLING C-101 DETAILED COMPOUND PLAN MS 01/19/24 EQUIPMENT CABINETS ON A PROPOSED CONCRETE PAD INSIDE A 10' X15' GROUND SPACE WITHIN THE EXISTING C-201 TOWER ELEVATION 01/19/24 MS GEOGRAPHIC COORDINATES: COMPOUND, AND INSTALLING NEW EQUIPMENT AND C-401 ANTENNA INFORMATION & SCHEDULE 01/19/24 MS LATITUDE: 30.106319° MOUNTS ON THE EXISTING TOWER LONGITUDE: -82 7600589 C-501 CONSTRUCTION DETAILS 01/19/24 MS GROUND ELEVATION: 104' AMSL C-502 CONSTRUCTION DETAILS MS 01/19/24 C-503 CONSTRUCTION DETAILS MS 01/19/24 ZONING INFORMATION: CONSTRUCTION DETAILS MS JURISDICTION: COLUMBIA COUNTY, FL APN: 304S1603249000 FENCE DETAILS 01/19/24 MS C-505 ZONING CODE: N/A **PROJECT NOTES** GROUNDING DETAILS & ELECTRICAL SCHEMATIC 01/19/24 MS THE FACILITY IS UNMANNED. E-102 PANEL SCHEDULE & ONE-LINE DIAGRAM MS 01/19/24 **PROJECT TEAM** A TECHNICIAN WILL VISIT THE SITE APPROXIMATELY ONCE A E-501 GROUNDING DETAILS 01/19/24 MS MONTH FOR ROUTINE INSPECTION AND MAINTENANCE TOWER OWNER: APPLICANT: THE PROJECT WILL NOT RESULT IN ANY SIGNIFICANT LAND SUPPLEMENTAL R-601 DISTURBANCE OR EFFECT OF STORM WATER DRAINAGE. AMERICAN TOWER T-MOBILE NO SANITARY SEWER, POTABLE WATER OR TRASH DISPOSAL R-602 SUPPLEMENTAL 10 PRESIDENTIAL WAY 5901 BENJAMIN CENTER IS REQUIRED. R-603 SUPPLEMENTAL DRIVE, SUITE 110 A-B HANDICAP ACCESS IS NOT REQUIRED. UTILITY COMPANIES WOBURN, MA 01801 THE PROJECT DEPICTED IN THESE PLANS QUALIFIES AS AN ELIGIBLE FACILITIES REQUEST ENTITLED TO EXPEDITED TAMPA, FL 33634 R-604 SUPPLEMENTAL POWER COMPANY: N/A REVIEW UNDER 47 U.S.C. § 1455(A) AS A MODIFICATION OF AN R-605 SUPPLEMENTAL PHONE: N/A EXISTING WIRELESS TOWER THAT INVOLVES THE PROFESSIONAL OF RECORD SUPPLEMENTAL TELEPHONE COMPANY: N/A COLLOCATION, REMOVAL, AND/OR REPLACEMENT OF TRANSMISSION EQUIPMENT THAT IS NOT A SUBSTANTIAL ROBERT J. LARA, AIA PHONE: N/A R-607 SUPPLEMENTAL CHANGE UNDER CFR § 1.61000 (B)(7). 2 S UNIVERSITY DR., UNIT 245 R-608 SUPPLEMENTAL PLANTATION, FL 33324 PROJECT LOCATION DIRECTIONS (954) 577-4668 R-609 SUPPLEMENTAL rlara@morrisonhershfield.com SUPPLEMENTAL SUPPLEMENTAL FROM I-75 TAKE EXIT 427 ONTO US-90.3 MILES TURN LEFT ONTO W PROPERTY OWNER:

US 90.6 MILES TURN LEFT ONTO SW CTY RD 252B2.2 MILES TURN

RIGHT ONTO SW STATE RD 2474.2 MILES TURN RIGHT ONTO

CYPRESS LAKE RD1 MILE TURN RIGHT ONTO SW CHARLES TER.4

MILES ACCESS ROAD ON RIGHT



MORRISON HERSHFIELD 2 S UNIVERSITY DR., UNIT 245 PLANTATION, FL 33324

Tel: 954.577.4655 FL C OF A #8508 FL Architect business #AA26002368 www.morrisonhershfield.com

VERIFY ALL DIMENSIONS AND ADVISE CONSULTANTS OF ANY ERRORS OR OMISSIONS. THE INFORMATION CONTAINED IN THIS SET OF DOCUMENTS IS PROPRIETARY BY NATURE. ANY USE OR DISCLOSURI OTHER THAN WHICH IS RELATED TO NAMED CLIENT I STRICTLY PROHIBITED. NEITHER THE ARCHITECT NOR THE ENGINEER WILL BE PROVIDING ON-SITE CONSTRUCTION REVIEW OF THIS PROJECT. ALL PREVIOUS ISSUES OF THIS DRAWING ARE

DO NOT SCALE DRAWING. CONTRACTOR MUST

SUPERSEDED BY THE LATEST REVISION. NY 01/10/23 MS 02/06/23 MS 01/19/24

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Date: 2024.01.24 17:11:43-05'00

T Mobile

MH PROJ NO:	220329500
ATC PROJ. #:	14192636
CUST. ID:	9JK2817A (USA)
CUST. #:	9JK2817A

TITLE SHEET

G-001

GENERAL CONSTRUCTION NOTES:

- OWNER FURNISHED MATERIALS, T-MOBILE "THE COMPANY" WILL PROVIDE AND THE CONTRACTOR WILL INSTALL
- A. BTS EQUIPMENT FRAME (PLATFORM) AND ICEBRIDGE SHELTER (GROUND BUILD/CO-LOCATE ONLY)
 - B. AC/TELCO INTERFACE BOX (PPC)
 - C. ICE BRIDGE (CABLE TRAY WITH COVER) (GROUND BUILD/CO-LOCATE ONLY, GC TO FURNISH AND INSTALL FOR ROOFTOP INSTALLATION)
- D. TOWERS MONOPOLES
- E. TOWER LIGHTING
- F. GENERATORS & LIQUID PROPANE TANK
- G. ANTENNA STANDARD BRACKETS, FRAMES AND PIPES FOR MOUNTING
- H. ANTENNAS (INSTALLED BY OTHERS)
- I. TRANSMISSION LINE
- J. TRANSMISSION LINE JUMPERS
- K. TRANSMISSION LINE CONNECTORS WITH WEATHERPROOFING KITS
- L. TRANSMISSION LINE GROUND KITS
- M. HANGERS
- N. HOISTING GRIPS
- O. BTS EQUIPMENT
- 2. THE CONTRACTOR IS RESPONSIBLE TO PROVIDE ALL OTHER MATERIALS FOR THE COMPLETE INSTALLATION OF THE SITE INCLUDING, BUT NOT LIMITED TO, SUCH MATERIALS AS FENCING, STRUCTURAL STEEL SUPPORTING SUB-FRAME FOR PLATFORM, ROOFING LABOR AND MATERIALS, GROUNDING RINGS, GROUNDING WIRES, COPPER-CLAD OR XIT CHEMICAL GROUND ROD(S), BUSS BARS, TRANSFORMERS AND DISCONNECT SWITCHES WHERE APPLICABLE, TEMPORARY ELECTRICAL POWER, CONDUIT, LANDSCAPING COMPOUND STONE, CRANES, CORE DRILLING, SLEEPERS AND RUBBER MATTING, REBAR, CONCRETE CAISSONS, PADS AND/OR AUGER MOUNTS, MISCELLANEOUS FASTENERS, CABLE TRAYS, NON-STANDARD ANTENNA FRAMES AND ALL OTHER MATERIAL AND LABOR REQUIRED TO COMPLETE THE JOB ACCORDING TO THE DRAWINGS AND SPECIFICATIONS. IT IS THE POSITION OF T-MOBILE TO APPLY FOR PERMITTING AND CONTRACTOR RESPONSIBLE FOR PICKUP AND PAYMENT OF REQUIRED PERMITS.
- ALL WORK SHALL CONFORM TO ALL CURRENT APPLICABLE FEDERAL, STATE, AND LOCAL CODES, INCLUDING ANSI/EIA/TIA-222, AND COMPLY WITH ATC CONSTRUCTION SPECIFICATIONS.
- CONTRACTOR SHALL CONTACT LOCAL 811 FOR IDENTIFICATION OF UNDERGROUND
 UTILITIES BRIDGETO START OF CONSTRUCTION
- CONTRACTOR SHALL BE RESPONSIBLE FOR COORDINATING ALL REQUIRED INSPECTIONS.
- ALL DIMENSIONS TO, OF, AND ON EXISTING BUILDINGS, DRAINAGE STRUCTURES, AND SITE IMPROVEMENTS SHALL BE VERIFIED IN FIELD BY CONTRACTOR WITH ALL DISCREPANCIES REPORTED TO THE ENGINEER.
- 7. DO NOT CHANGE SIZE OR SPACING OF STRUCTURAL ELEMENTS.
- 8. DETAILS SHOWN ARE TYPICAL; SIMILAR DETAILS APPLY TO SIMILAR CONDITIONS UNLESS OTHERWISE NOTED.
- THESE DRAWINGS DO NOT INCLUDE NECESSARY COMPONENTS FOR CONSTRUCTION SAFETY WHICH SHALL BE THE SOLE RESPONSIBILITY OF THE CONTRACTOR.
- CONTRACTOR SHALL BRACE STRUCTURES UNTIL ALL STRUCTURAL ELEMENTS NEEDED FOR STABILITY ARE INSTALLED. THESE ELEMENTS ARE AS FOLLOWS: LATERAL BRACING, ANCHOR BOLTS, ETC.
- 11. CONTRACTOR SHALL DETERMINE EXACT LOCATION OF EXISTING UTILITIES, GROUNDS DRAINS, DRAIN PIPES, VENTS, ETC. BEFORE COMMENCING WORK.
- 12. INCORRECTLY FABRICATED, DAMAGED, OR OTHERWISE MISFITTING OR NONCONFORMING MATERIALS OR CONDITIONS SHALL BE REPORTED TO THE T-MOBILE REP PRIOR TO REMEDIAL OR CORRECTIVE ACTION. ANY SUCH REMEDIAL ACTION SHALL REQUIRE WRITTEN APPROVAL BY THE T-MOBILE REP PRIOR TO PROCEEDING.
- 13. EACH CONTRACTOR SHALL COOPERATE WITH THE T-MOBILE REP, AND COORDINATE HIS WORK WITH THE WORK OF OTHERS.
- 14. CONTRACTOR SHALL REPAIR ANY DAMAGE CAUSED BY CONSTRUCTION OF THIS PROJECT TO MATCH EXISTING PRE-CONSTRUCTION CONDITIONS TO THE SATISFACTION OF THE T-MORILE CONSTRUCTION MANAGER
- ALL CABLE/CONDUIT ENTRY/EXIT PORTS SHALL BE WEATHERPROOFED DURING INSTALLATION USING A SILICONE SEALANT.
- WHERE EXISTING CONDITIONS DO NOT MATCH THOSE SHOWN IN THIS PLAN SET, CONTRACTOR SHALL NOTIFY THE T-MOBILE REP AND ENGINEER OF RECORD IMMEDIATELY.
- 17. CONTRACTOR SHALL ENSURE ALL SUBCONTRACTORS ARE PROVIDED WITH A COMPLETE AND CURRENT SET OF DRAWINGS AND SPECIFICATIONS FOR THIS PROJECT.
- 18. CONTRACTOR SHALL REMOVE ALL RUBBISH AND DEBRIS FROM THE SITE AT THE END OF
- CONTRACTOR SHALL COORDINATE WORK SCHEDULE WITH AMERICAN TOWER CORPORATION (ATC), AND TAKE PRECAUTIONS TO MINIMIZE IMPACT AND DISRUPTION OF OTHER OCCUPANTS OF THE FACILITY.
- CONTRACTOR SHALL FURNISH T-MOBILE AND AMERICAN TOWER CORPORATION (ATC)
 WITH A PDF MARKED UP AS-BUILT SET OF DRAWINGS UPON COMPLETION OF WORK.
- 11. PRIOR TO SUBMISSION OF BID, CONTRACTOR SHALL COORDINATE WITH T-MOBILE REP TO DETERMINE WHAT, IF ANY, ITEMS WILL BE PROVIDED. ALL ITEMS NOT PROVIDED SHALL BE PROVIDED AND INSTALLED BY THE CONTRACTOR. CONTRACTOR WILL INSTALL

- PRIOR TO SUBMISSION OF BID, CONTRACTOR SHALL COORDINATE WITH T-MOBILE REP
 TO DETERMINE IF ANY PERMITS WILL BE OBTAINED BY CONTRACTOR. ALL REQUIRED PERMITS NOT OBTAINED BY T-MOBILE MUST BE OBTAINED, AND PAID FOR, BY THE CONTRACTOR.
- CONTRACTOR SHALL INSTALL ALL SITE SIGNAGE IN ACCORDANCE WITH T-MOBILE SPECIFICATIONS AND REQUIREMENTS.
- 24. CONTRACTOR SHALL SUBMIT ALL SHOP DRAWINGS TO T-MOBILE FOR REVIEW AND APPROVAL PRIOR TO FABRICATION.
- ALL EQUIPMENT SHALL BE INSTALLED ACCORDING TO MANUFACTURER'S SPECIFICATIONS AND LOCATED ACCORDING TO T-MOBILE SPECIFICATIONS, AND AS SHOWN IN THESE PLANS
- 26. THE CONTRACTOR SHALL SUPERVISE AND DIRECT THE PROJECT DESCRIBED HEREIN. THE CONTRACTOR SHALL BE SOLELY RESPONSIBLE FOR ALL THE CONSTRUCTION MEANS, METHODS, TECHNIQUES, SEQUENCES AND PROCEDURES AND FOR COORDINATING ALL PORTIONS OF THE WORK UNDER THE CONTRACT.
- CONTRACTOR SHALL NOTIFY T-MOBILE REP A MINIMUM OF 48 HOURS IN ADVANCE OF POURING CONCRETE OR BACKFILLING ANY UNDERGROUND UTILITIES, FOUNDATIONS OR SEALING ANY WALL, FLOOR OR ROOF PENETRATIONS FOR ENGINEERING REVIEW AND APPROVAL
- 28. CONTRACTOR SHALL BE RESPONSIBLE FOR SITE SAFETY INCLUDING COMPLIANCE WITH ALL APPLICABLE OSHA STANDARDS AND RECOMMENDATIONS AND SHALL PROVIDE ALL NECESSARY SAFETY DEVICES INCLUDING PPE AND PPM AND CONSTRUCTION DEVICES SUCH AS WELDING AND FIRE PREVENTION, TEMPORARY SHORING, SCAFFOLDING, TRENCH BOXES/SLOPING, BARRIERS, ETC.
- 29. THE CONTRACTOR SHALL PROTECT AT HIS OWN EXPENSE, ALL EXISTING FACILITIES AND SUCH OF HIS NEW WORK LIABLE TO INJURY DURING THE CONSTRUCTION PERIOD. ANY DAMAGE CAUSED BY NEGLECT ON THE PART OF THIS CONTRACTOR OR HIS REPRESENTATIVES, OR BY THE ELEMENTS DUE TO NEGLECT ON THE PART OF THIS CONTRACTOR OR HIS REPRESENTATIVES, EITHER TO THE EXISTING WORK, OR TO HIS WORK OR THE WORK OF ANY OTHER CONTRACTOR, SHALL BE REPAIRED AT HIS EXPENSE TO THE OWNER'S SATISFACTION.
- 30. ALL WORK SHALL BE INSTALLED IN A FIRST CLASS, NEAT AND WORKMANLIKE MANNER BY MECHANICS SKILLED IN THE TRADE INVOLVED. THE QUALITY OF WORKMANSHIP SHALL BE SUBJECT TO THE APPROVAL OF THE T-MOBILE REP. ANY WORK FOUND BY THE T-MOBILE REP TO BE OF INFERIOR QUALITY AND/OR WORKMANSHIP SHALL BE REPLACED AND/OR REWORKED AT CONTRACTOR EXPENSE UNTIL APPROVAL IS
- 31. IN ORDER TO ESTABLISH STANDARDS OF QUALITY AND PERFORMANCE, ALL TYPES OF MATERIALS LISTED HEREINAFTER BY MANUFACTURER'S NAMES AND/OR MANUFACTURER'S CATALOG NUMBER SHALL BE PROVIDED BY THESE MANUFACTURERS AND PROPERTY
- 32. T-MOBILE FURNISHED EQUIPMENT SHALL BE PICKED-UP AT THE T-MOBILE WAREHOUSE, NO LATER THAN 48HR AFTER BEING NOTIFIED INSURED, STORED, UNCRATE, PROTECTED AND INSTALLED BY THE CONTRACTOR WITH ALL APPURTENANCES REQUIRED TO PLACE THE EQUIPMENT IN OPERATION, READY FOR USE. THE CONTRACTOR SHALL BE RESPONSIBLE FOR THE EQUIPMENT AFTER PICKING IT UP.
- 33. T-MOBILE OR HIS ARCHITECT/ENGINEER RESERVES THE RIGHT TO REJECT ANY EQUIPMENT OR MATERIALS WHICH, IN HIS OWN OPINION ARE NOT IN COMPLIANCE WITH THE CONTRACT DOCUMENTS, EITHER BEFORE OR A FTER INSTALLATION AND THE EQUIPMENT SHALL BE REPLACED WITH EQUIPMENT CONFORMING TO THE REQUIREMENTS OF THE CONTRACT DOCUMENTS BY THE CONTRACTOR AT NO COST TO T-MOBILE OR THEIR ARCHITECT/ENGINEER.

SPECIAL CONSTRUCTION ANTENNA INSTALLATION NOTES:

- WORK INCLUDED:
 - A. ANTENNA AND COAXIAL CABLES ARE FURNISHED BY T-MOBILE UNDER A SEPARATE CONTRACT. THE CONTRACTOR SHALL ASSIST ANTENNA INSTALLATION CONTRACTOR IN TERMS OF COORDINATION AND SITE ACCESS. ERECTION SUBCONTRACTOR SHALL BE RESPONSIBLE FOR THE PROTECTION OF PERSONNE!
 - B. INSTALL ANTENNAS AS INDICATED ON DRAWINGS AND T-MOBILE SPECIFICATIONS.
 - C. INSTALL GALVANIZED STEEL ANTENNA MOUNTS AS INDICATED ON DRAWINGS.
 - D. INSTALL FURNISHED GALVANIZED STEEL OR ALUMINUM WAVEGUIDE AND PROVIDE PRINTOUT OF THAT TEST.
 - E. CONTRACTOR SHALL PROVIDE FOUR (4) SETS OF SWEEP TESTS USING ANRITZU-PACKARD 8713B RF SCALAR NETWORK ANALYZER. SUBMIT FREQUENCY DOMAIN REFLECTOMETER(FDR) TESTS RESULTS TO THE PROJECT MANAGER. SWEEP TESTS SHALL BE AS PER ATTACHED RFS "MINIMUM FIELD TESTING RECOMMENDED FOR ANTENNA AND HELIAX COAXIAL CABLE SYSTEMS" DATED 10/5/93. TESTING SHALL BE PERFORMED BY AN INDEPENDENT TESTING SERVICE AND BE BOUND AND SUBMITTED WITHIN ONE WEEK OF WORK COMPLETION.
 - F. INSTALL COAXIAL CABLES AND TERMINATING BETWEEN ANTENNAS AND EQUIPMENT PER MANUFACTURER'S RECOMMENDATIONS. WEATHERPROOF ALL CONNECTIONS BETWEEN THE ANTENNA AND EQUIPMENT PER MANUFACTURER'S REQUIREMENTS. TERMINATE ALL COAXIAL CABLE THREE (3) FEET IN EXCESS OF ENTRY PORT LOCATION UNLESS OTHERWISE STATED.
 - G. ANTENNA AND COAXIAL CABLE GROUNDING:
- ALL EXTERIOR #6 GREEN GROUND WIRE "DAISY CHAIN" CONNECTIONS ARE TO BE WEATHER SEALED WITH RFS CONNECTORS/SPLICE WEATHERPROOFING KIT #221213 OR FOLIAL

 ALL COAXIAL CABLE GROUNDING KITS ARE TO BE INSTALLED ON STRAIGHT RUNS OF COAXIAL CABLE (NOT WITHIN BENDS).

CONCRETE AND REINFORCING STEEL NOTES:

- DESIGN AND CONSTRUCTION OF ALL CONCRETE ELEMENTS SHALL CONFORM TO THE LATEST EDITIONS OF ALL APPLICABLE CODES INCLUDING: ACI 301 "SPECIFICATIONS FOR STRUCTURAL CONCRETE FOR BUILDINGS", ACI 117 "SPECIFICATIONS FOR TOLERANCES FOR CONCRETE CONSTRUCTION AND MATERIALS", AND ACI 318 "BUILDING CODE REQUIREMENTS FOR REINFORCED CONCRETE."
- MIX DESIGN SHALL BE APPROVED BY T-MOBILE REP PRIOR TO PLACING CONCRETE.
- . CONCRETE SHALL BE NORMAL WEIGHT, 6 % AIR ENTRAINED (+/- 1.5%) WITH A SLUMP RANGE OF 3-6" AND HAVE A MINIMUM 28-DAY COMPRESSIVE STRENGTH OF 4500 PSI UNLESS OTHERWISE NOTED.
- . THE FOLLOWING MATERIALS SHALL BE USED:

PORTLAND CEMENT: ASTM C150, TYPE 2

REINFORCEMENT: ASTM A185, PLAIN STEEL WELDED WIRE FABRIC

REINFORCEMENT BARS: ASTM A615, GRADE 60, DEFORMED
NORMAL WEIGHT AGGREGATE: ASTM C33

WATER: ASTM C 94/C 94M

WELDED WIRE FABRIC: ASTM A185

ADMIXTURES:

-WATER-REDUCING AGENT: ASTM C 494/C 494M, TYPE A
-AIR-ENTERING AGENT: ASTM C 260/C 260M
-SUPERPLASTICIZER: ASTM C494, TYPE F OR TYPE G
-RETARDING: ASTM C 494/C 494M, TYPE B

- 5. MINIMUM CONCRETE COVER FOR REINFORCING STEEL SHALL BE NO LESS THAN 3".
- A 3/4" CHAMFER SHALL BE PROVIDED AT ALL EXPOSED EDGES OF CONCRETE IN ACCORDANCE WITH ACI 301 SECTION 4.2.4. UNLESS NOTED OTHERWISE.
- 7. INSTALLATION OF CONCRETE EXPANSION/WEDGE ANCHOR SHALL BE PER MANUFACTURER'S WRITTEN RECOMMENDED PROCEDURE. THE ANCHOR BOLT, DOWEL, OR ROD SHALL CONFORM TO MANUFACTURER'S RECOMMENDATION FOR EMBEDMENT DEPTH OR AS SHOWN ON THE DRAWINGS. NO REBAR SHALL BE CUT WITHOUT PRIOR APPROVAL FROM AN ATC ENGINEER WHEN DRILLING HOLES IN CONCRETE.
- ADMIXTURES SHALL CONFORM TO THE APPROPRIATE ASTM STANDARD AS REFERENCED IN "METHOD 1" OF ACI 301.
- DO NOT WELD OR TACK WELD REINFORCING STEEL.
- ALL DOWELS, ANCHOR BOLTS, EMBEDDED STEEL, ELECTRICAL CONDUITS, PIPE SLEEVES, GROUNDS AND ALL OTHER EMBEDDED ITEMS AND FORMED DETAILS SHALL BE IN PLACE BEFORE START OF CONCRETE PLACEMENT.
- 11. REINFORCEMENT SHALL BE COLD BENT WHENEVER BENDING IS REQUIRED.
- 12. DO NOT PLACE CONCRETE IN WATER, ICE, OR ON FROZEN GROUND.
- FOR COLD-WEATHER (ACI 306) AND HOT-WEATHER (ACI 301M) CONCRETE PLACEMENT, CONFORM TO APPLICABLE ACI CODES AND RECOMMENDATIONS. IN EITHER CASE, MATERIALS CONTAINING CHLORIDE, CALCIUM, SALTS, ETC. SHALL NOT BE USED. PROTECT FRESH CONCRETE FROM WEATHER FOR 7 DAYS, MINIMUM.
- 14. ALL CONCRETE SHALL HAVE A "SMOOTH FORM FINISH."
- 15. SPLICING OF REINFORCEMENT IS PERMITTED ONLY AT LOCATIONS SHOWN IN THE CONTRACT DRAWINGS OR AS ACCEPTED BY THE ENGINEER. UNLESS OTHERWISE SHOWN OR NOTED REINFORCING STEEL SHALL BE SPLICED TO DEVELOP ITS FULL TENSILE CAPACITY (CLASS A) IN ACCORDANCE WITH ACI 318.
- DETAILING OF REINFORCING STEEL SHALL CONFORM TO "ACI MANUAL OF STANDARD PRACTICE FOR DETAILING REINFORCED CONCRETE STRUCTURES" (ACI 315).
- ALL SLAB CONSTRUCTION SHALL BE CAST MONOLITHICALLY WITHOUT HORIZONTAL CONSTRUCTION JOINTS, UNLESS SHOWN IN THE CONTRACT DRAWINGS.
- 18. LOCATION OF ALL CONSTRUCTION JOINTS ARE SUBJECT TO THE REQUIREMENTS OF THE CONTRACT DOCUMENTS, CONFORMANCE WITH ACI 318, AND ACCEPTANCE OF THE ENGINEER. DRAWINGS SHOWING LOCATION OF DETAILS OF THE PROPOSED CONSTRUCTION JOINTS SHALL BE SUBMITTED WITH REINFORCING STEEL PLACEMENT DRAWINGS
- SPLICES OF WWF, AT ALL SPLICED EDGES, SHALL BE SUCH THAT THE OVERLAP MEASURED BETWEEN OUTERMOST CROSS WIRES OF EACH FABRIC SHEET IS NOT LESS THAN THE SPACING OF THE CROSS WIRE PLUS 2 INCHES, NOR LESS THAN 67.
- 20. BAR SUPPORTS SHALL BE ALL-GALVANIZED METAL WITH PLASTIC TIPS.
- 21. ALL REINFORCEMENT SHALL BE SECURELY TIED IN PLACE TO PREVENT DISPLACEMENT BY CONSTRUCTION TRAFFIC OR CONCRETE. TIE WIRE SHALL BE OF SUFFICIENT STRENGTH FOR INTENDED PURPOSE, BUT NOT LESS THAN NO. 18 GAUGE.
- SLAB ON GROUND: COMPACT STRUCTURAL FILL TO 95% DENSITY AND THEN PLACE 6" GRAVEL BENEATH SLAB.

ELECTRICAL NOTES:

ELECTRICAL DESIGN SHALL BE PERFORMED BY ELECTRICAL CONTRACTOR.
STRUCTURAL DESIGN SHALL BE PERFORMED BY GENERAL CONTRACTOR. ELECTRICAL
CONTRACTOR SHALL ENSURE THAT ALL WORK COMPLIES WITH ALL APPLICABLE LOCAL

AND STATE CODES AND NATIONAL ELECTRICAL CODE.

- ALL SUGGESTED ELECTRICAL ELEMENTS (SUCH AS BREAKER SIZES, WIRE SIZES, CONDUITS SIZES ARE FOR ZONING PURPOSES ONLY. IT IS THE RESPONSIBILITY TO OF THE ELECTRICAL CONTRACTOR TO CONFIRM COMPLIANCE WITH LOCAL ELECTRICAL CODES AND PASS ALL APPLICABLE AND NECESSARY INSPECTIONS. IN SOME EVENTS, IT MAY BE NECESSARY TO PERFORM AN ELECTRICAL LOAD STUDY TO VERIFY THE CAPACITY OF THE EXISTING SERVICE. THIS IS NOT THE RESPONSIBILITY OF CONCORDIA IT IS THE RESPONSIBILITY OF THE ELECTRICAL CONTRACTOR.
- CONTRACTOR SHALL FIELD LOCATE ALL BELOW GRADE GROUND LINES AND UTILITY LINES PRIOR TO CONSTRUCTION. CONTRACTOR IS RESPONSIBLE FOR RELOCATION OF ALL UTILITIES AND GROUND LINES THAT MAY BECOME DISTURBED OR CONFLICTING IN THE COURSE OF CONSTRUCTION.

ALL DISCREPANCIES FROM WHAT IS SHOWN ON THESE
CONSTRUCTION DRAWINGS SHALL BE COMMUNICATED TO ATC
ENGINEERING IMMEDIATELY FOR CORRECTION OR RE-DESIGN.
FAILURE TO COMMUNICATE DIRECTLY WITH ATC ENGINEERING OR
ANY CHANGES FROM THE DESIGN CONDUCTED WITHOUT PRIOR
APPROVAL FROM ATC ENGINEERING SHALL BE THE SOLE
RESPONSIBILITY OF THE GENERAL CONTRACTOR.



MORRISON HERSHFIELD 2 S UNIVERSITY DR., UNIT 245

PLANTATION, FL 33324 Tel: 954.577.4655 FL C OF A #8508

FL Architect business #AA26002368 www.morrisonhershfield.com DO NOT SCALE DRAWING. CONTRACTOR MUST

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	SUPERSEDED BY THE LATEST	<u>REVIS</u>	ION.
REV.	DESCRIPTION	BY	DATE
\mathbb{A}_{-}	PRELIM	NY	01/10/23
△_	FINALS	MS	02/06/23
Λ	FINALS	MS	01/19/24
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ATC SITE NUMBER: 417139
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COLUMBIA (CHARLES) FL

T-MOBILE SITE NAME:

9JK2817A (USA)

SITE ADDRESS: CHARLES TERRACE LAKE CITY,FL 32024

SEAL:

OF FLORE

ON AR 92824

Digitally Control of Lara
Date: 2024.01.24 17:11:58-05'00'

T Mobile

MH PROJ NO:	220329500
ATC PROJ. #:	14192636
CUST. ID:	9JK2817A (USA)
CUST. #:	9JK2817A

GENERAL NOTES

SHEET NUMBER:

G-002

COMPOUND PLAN NOTES:


- THIS SITE PLAN REPRESENTS THE BEST PRESENT KNOWLEDGE AVAILABLE TO THE ENGINEER AT THE TIME OF THIS DESIGN THE CONTRACTOR SHALL VISIT THE SITE PRIOR TO CONSTRUCTION AND VERIFY ALL EXISTING CONDITIONS RELATED TO THE SCOPE OF WORK FOR THIS PROJECT.
- ICE BRIDGE, CABLE LADDER, COAX PORT, AND COAX CABLE ARE SHOWN FOR REFERENCE ONLY. CONTRACTOR SHALL CONFIRM THE EXACT LOCATION OF ALL PROPOSED AND EXISTING **EQUIPMENT AND STRUCTURES DEPICTED ON** THIS PLAN. BEFORE UTILIZING EXISTING CABLE SUPPORTS, COAX PORTS, INSTALLING NEW PORTS OR ANY OTHER EQUIPMENT, CONTRACTOR SHALL VERIFY ALL ASPECTS OF THE COMPONENTS MEET THE ATC SPECIFICATIONS
- IT IS THE RESPONSIBILITY OF THE CONTRACTOR TO COORDINATE WITH THE T-MOBILE REPRESENTATIVE AND LOCAL UTILITY COMPANY FOR THE INSTALLATION OF CONDUITS, CONDUCTORS, BREAKERS, DISCONNECTS, OR ANY OTHER EQUIPMENT REQUIRED FOR ELECTRICAL SERVICE. ALL ELECTRICAL WORK SHALL BE PERFORMED IN ACCORDANCE WITH LATEST EDITION OF THE STATE AND NATIONAL CODES, ORDINANCES AND REGULATIONS APPLICABLE TO THIS PROJECT


LEGEND GROUNDING TEST WELL AUTOMATIC TRANSFER SWITCH ATS CELL SITE CABINET CSC DISCONNECT ELECTRICAL FIRER GEN GENERATOR GENERATOR RECEPTACLE HH. V HAND HOLE, VAULT ICE BRIDGE KENTROX BOX LC LIGHTING CONTROL METER **PULL BOX** PP POWER POLE TELCO TRN TRANSFORMER

CHAINI INK FENCE

PROPOSED CABLE NOTES:

- ESTIMATED LENGTH OF PROPOSED CABLE IS ±298'. ESTIMATED LENGTH OF CABLE WAS PROVIDED BY CUSTOMER OR CALCULATED BY ADDING THE RAD CENTER AND THE DISTANCE FROM THE SHELTER ENTRY PLATE TO THE TOWER (ALONG THE ICE BRIDGE) AND A SAFETY FACTOR MEASUREMENT OF 15% (OF THE TWO PREVIOUS VALUES), CDS DEFER TO GREATEST CABLE LENGTH.
- ROUTE PROPOSED CABLES ALONG SAME PATH AS EXISTING CABLES AND IN ACCORDANCE WITH STRUCTURAL ANALYSIS. WHERE POSSIBLE UTILIZE EXISTING CABLE SUPPORT STRUCTURES AS PROVIDED FOR CARRIER TO ADEQUATELY SECURE CABLES, USING EITHER APPROPRIATELY SIZED STAINLESS STEEL SNAP-INS OR MOUNTING HARDWARE AND BRACKETS AS SPECIFIED BY CABLE MANUFACTURER. OTHERWISE, ATTACH CABLES TO HORIZONTAL OR DIAGONAL TOWER MEMBERS USING PROPOSED STAINLESS STEEL ADAPTERS (DO NOT ATTACH TO TOWER LEG)

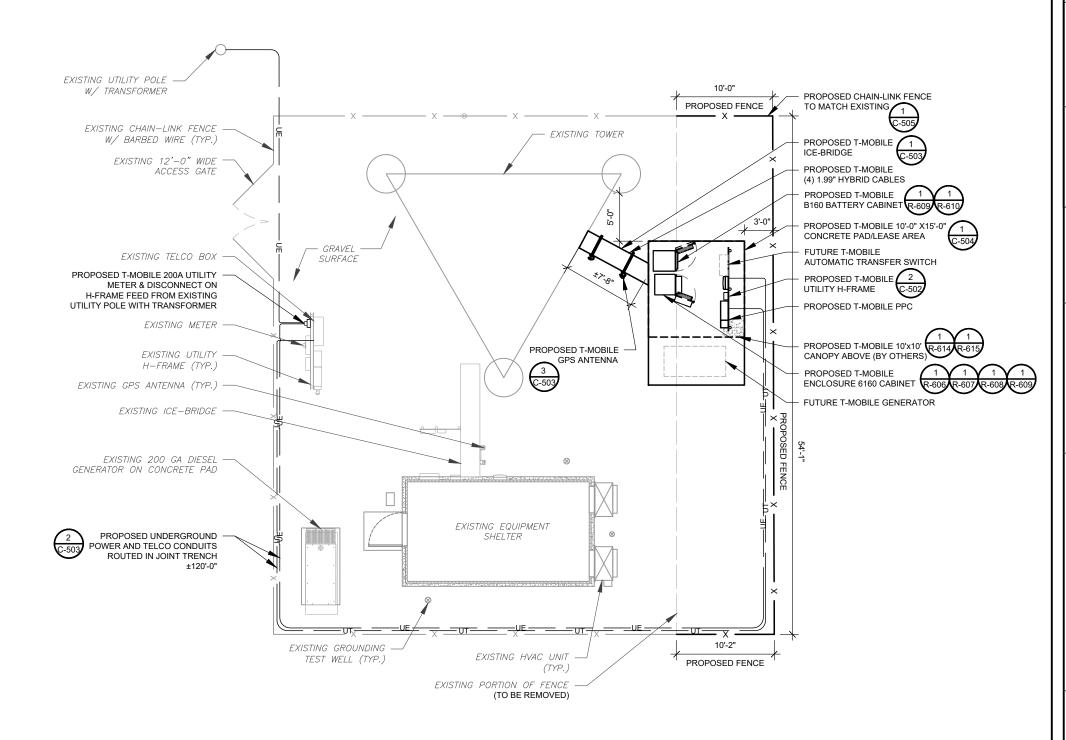

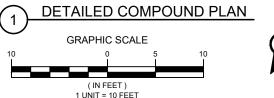





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<u>1_</u>	FINALS	MS	01/19/24
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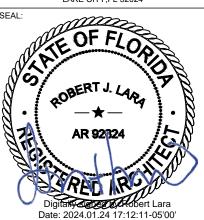
ATC SITE NUMBER: 417139 ATC SITE NAME:

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T-MOBILE SITE NAME

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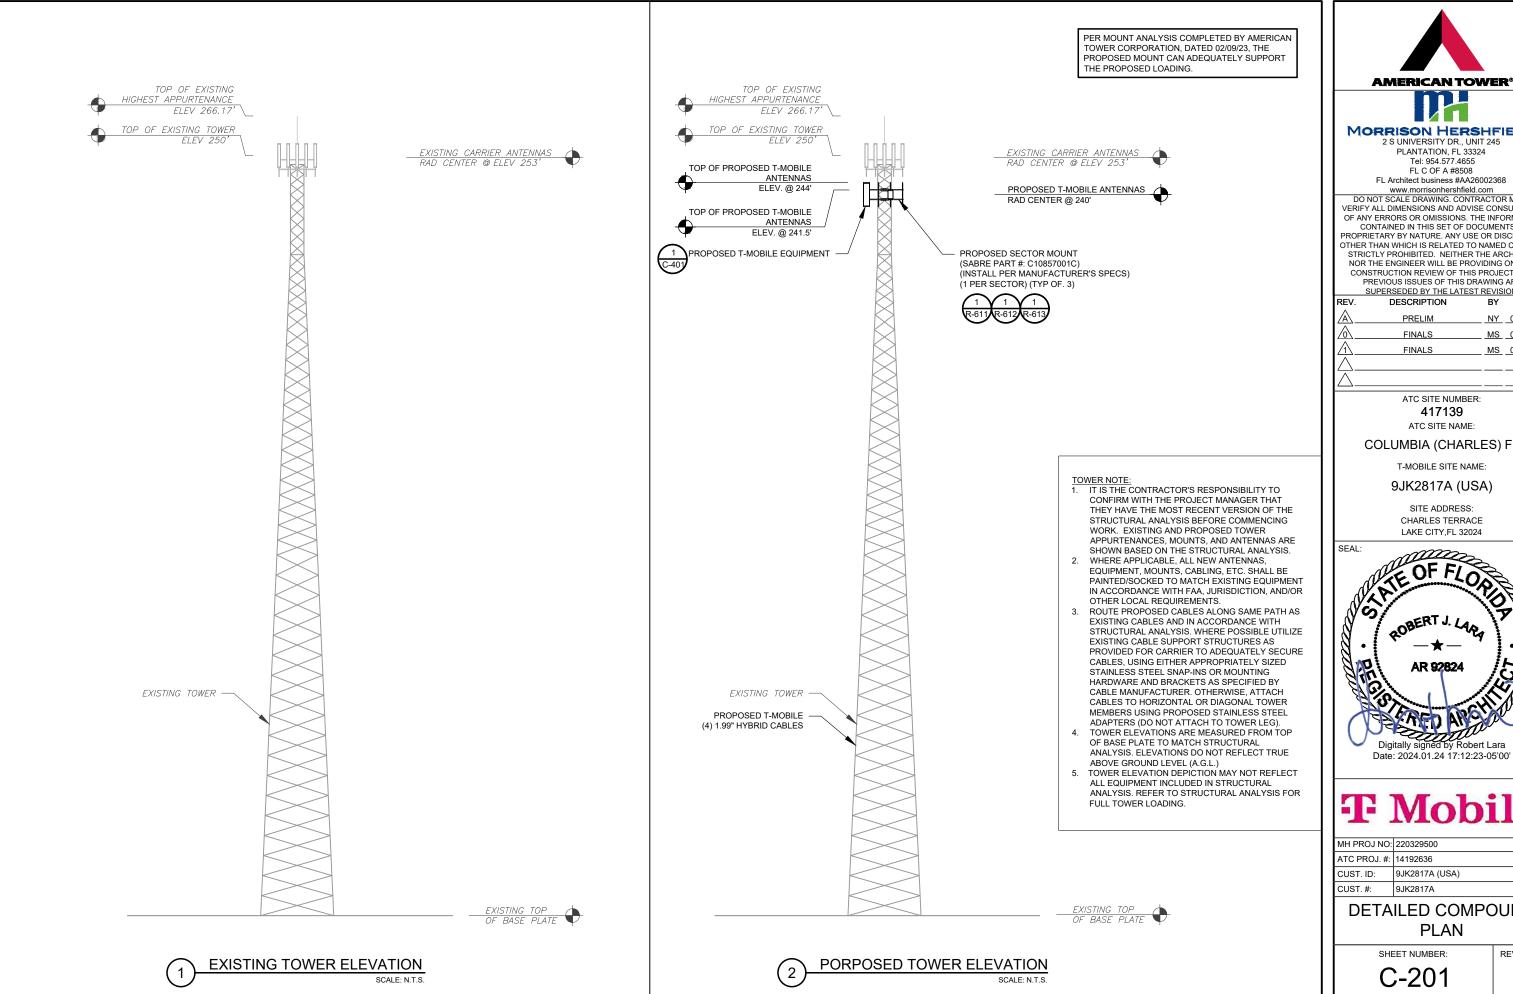
MH PROJ NO:	220329500
ATC PROJ. #:	14192636
CUST. ID:	9JK2817A (USA)
CUST. #:	9JK2817A

DETAILED COMPOUND PLAN

SHEET NUMBER:

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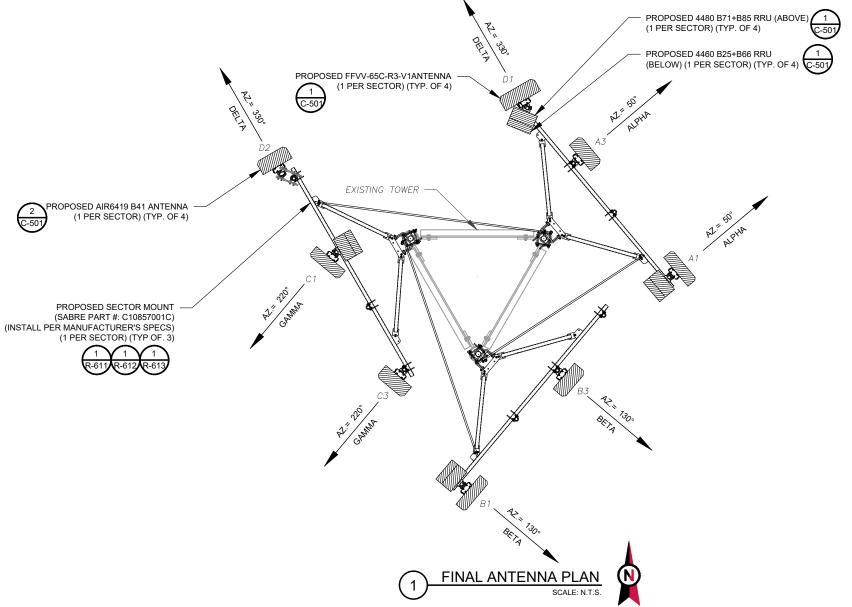
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SHEET NUMBER:

C-201



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	FINAL ANTENNA/ COAX SCHEDULE														
SECTOR	RAD	AZ	POS.	ANTENNA	BAND	MECH/ELEC D-TILT	ADDITIONAL TOWER MOUNTED EQUIPMENT	CABLE DESCRIPTION							
ALPHA	240'	50°	A1	FFVV-65C-R3-V1	L700/L600/N600/L2100/L1900/N1900	0°/-	(1) 4480 B71+B85 RRU (1) 4460 B25+B66 RRU								
			A3	AIR 6419 B41	N2500	0°/-	-								
ВЕТА	240'	240' 130	240'	240'	240'	240'	240'	240'	240' 130°	B1	FFVV-65C-R3-V1	L700/L600/N600/L2100/L1900/N1900	0°/-	(1) 4480 B71+B85 RRU (1) 4460 B25+B66 RRU	
			В3	AIR 6419 B41	N2500	0°/-	-	(4) 4 00" LIVEDID CARLED							
	240' 2	240'	220°	C1	FFVV-65C-R3-V1	L700/L600/N600/L2100/L1900/N1900	0°/-	(1) 4480 B71+B85 RRU (1) 4460 B25+B66 RRU	(4) 1.99" HYBRID CABLES						
										C3	AIR 6419 B41	N2500	0°/-	-	
	240'	330°	D1	FFVV-65C-R3-V1	L700/L600/N600/L2100/L1900/N1900	0°/-	(1) 4480 B71+B85 RRU (1) 4460 B25+B66 RRU								
			D2	AIR 6419 B41	N2500	0°/-	-								

- 1. CONFIRM WITH CARRIER REP FOR APPLICABLE UPDATES/REVISIONS AND MOST RECENT RFDS.
- 2. ALL PROPOSED EQUIPMENT INCLUDING ANTENNAS, COAX, ETC. SHALL BE MOUNTED IN ACCORDANCE WITH THE TOWER STRUCTURAL ANALYSIS ON FILE WITH THE ATC CM.
- 3. SPACING OF PROPOSED EQUIPMENT SHALL BE CONFIRMED FOR TOWER CONFLICTS AND PROPOSED MOUNTS SHALL NOT IMPEDE TOWER CLIMBING PEGS.
- 4. INSTALL [TOWER JUNCTION BOX MODEL AND QUANTITY].

ANTENNA SCHEDULE

PER MOUNT ANALYSIS COMPLETED BY AMERICAN TOWER CORPORATION, DATED 02/09/23, THE PROPOSED MOUNT CAN ADEQUATELY SUPPORT THE PROPOSED LOADING.



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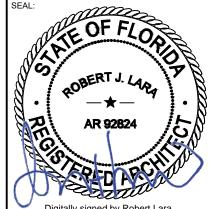
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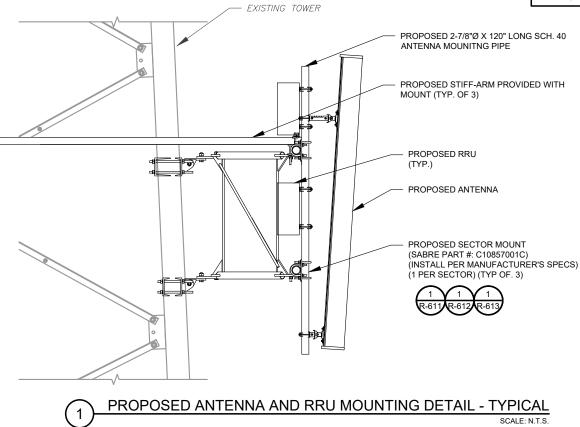
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	CUST. ID:	9JK2817A (USA)	
	CUST. #:	9JK2817A	

ANTENNA INFORMATION & SCHEDULE

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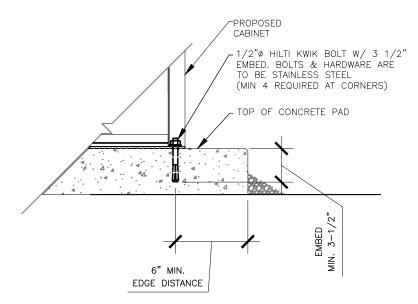
C-401

PER MOUNT ANALYSIS COMPLETED BY AMERICAN TOWER CORPORATION, DATED 02/09/23, THE PROPOSED MOUNT CAN ADEQUATELY SUPPORT THE PROPOSED LOADING.




EXISTING TOWER PROPOSED 2-7/8"Ø X 120" LONG SCH. 40 ANTENNA MOUNITNG PIPE PROPOSED STIFF-ARM PROVIDED WITH MOUNT (TYP. OF 3) PROPOSED ANTENNA PROPOSED SECTOR MOUNT (SABRE PART #: C10857001C) (INSTALL PER MANUFACTURER'S SPECS) (1 PER SECTOR) (TYP OF. 3)

PROPOSED 5G ANTENNA MOUNTING DETAIL - TYPICAL



CABINET ANCHORING DETAIL

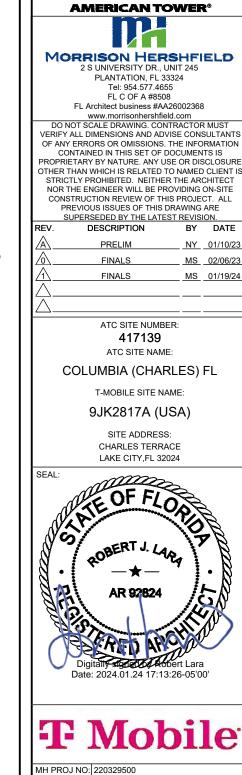

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CUST. ID:

CUST. #:

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CONSTRUCTION

DETAILS

REVISION

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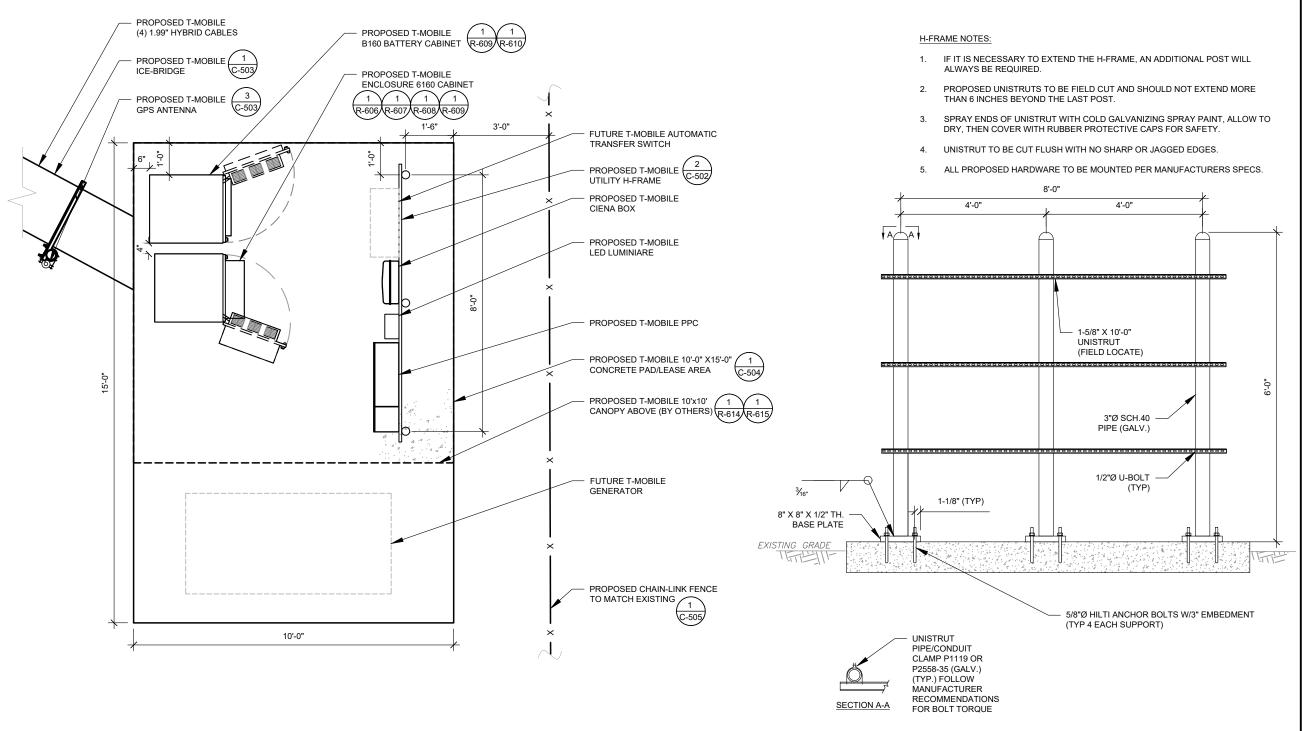
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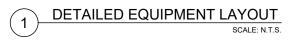
MS 02/06/23

MS 01/19/24



CABINETS SHALL BE ORIENTED AND INSTALLED EXACTLY AS SHOWN

WEIGHT OF BTS UNIT IS 1,060 LBS (WEIGHT IS WITHOUT EQUIPMENT)





TYPICAL H-FRAME DETAIL SCALE: NOT TO SCALE



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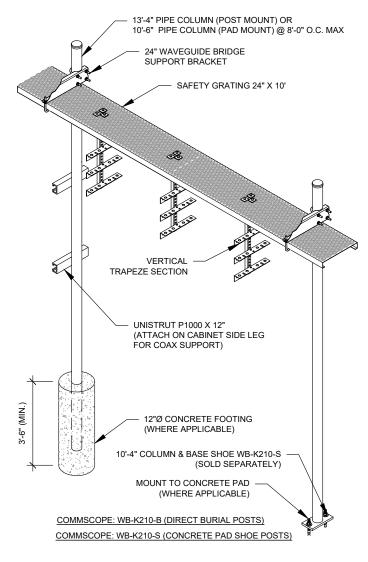
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CONSTRUCTION **DETAILS**


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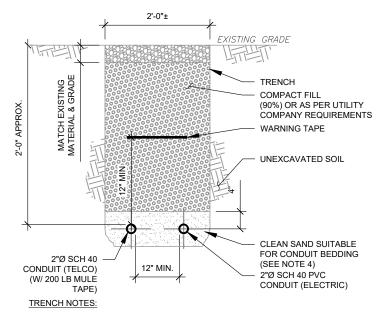
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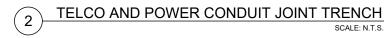
CONSTRUCTION NOTE:


- 1. INSTALL ICE BRIDGE TO ALLOW 7 FEET CLEARANCE ABOVE GRADE TO LOWEST APPURTENANCE.
- 2. INSTALL PER MANUFACTURES SPECIFICATION.





- IF FREE OF ORGANIC OR OTHER DELETERIOUS MATERIAL, EXCAVATED MATERIAL MAY BE USED FOR BACKFILL.
- IF NOT, PROVIDE CLEAN, COMPACTIBLE MATERIAL. COMPACT IN 8" LIFTS.
 REMOVE ANY LARGE ROCKS PRIOR TO BACKFILLING. CONTRACTOR TO VERIFY
 LOCATION OF EXISTING LIGHTLIST PRIOR TO DIGGING.
- 3. IF CURRENT AS-BUILT DRAWINGS ARE NOT AVAILABLE CONTRACTOR SHALL HAND DIG U/G TRENCHING.
- 4. CONCRETE ENCASE CONDUIT WHEN TRENCHING UNDER SITE ACCESS ROAD.

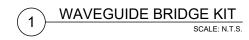

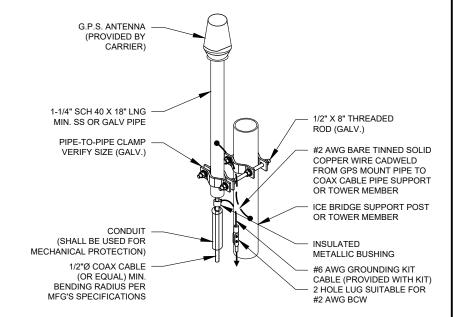

NOTE:

- 1. GPS SHALL BE PLACED WITH CLEAR SIGHT LINE TO THE SOUTHERN SKY.
- CONTRACTOR TO SUPPLY COAX FOR GPS UNIT.

GPS ANTENNA ATTACHMENT DETAIL

AMERICAN TOWER®

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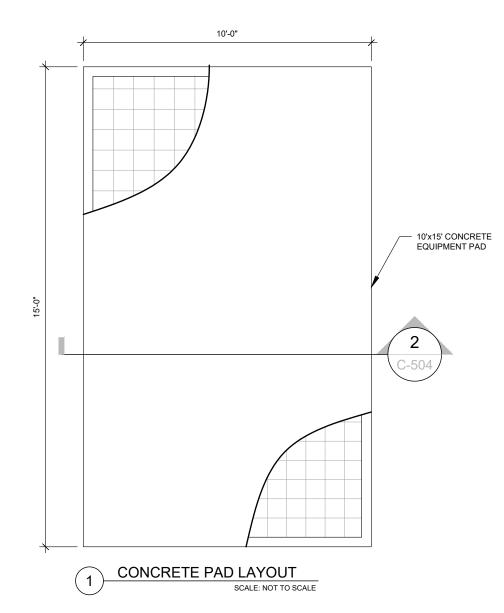
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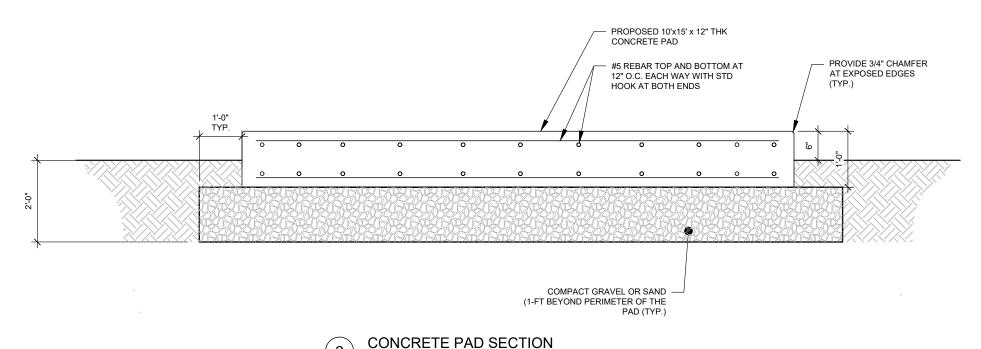
CONTRACTOR NOTES:

- ALL CONCRETE FOR SLAB FOUNDATION SHALL BE 3000 P.S.I. (MIN.)
- IF BUILDER SET DATE WILL BE WITHIN 24 HRS OF SLAB POUR THEN SITE CONTRACTOR SHALL USE 5000 P.S.I. CONCRETE (MIN.) TO OBTAIN MIN. 1800 P.S.I. CONCRETE WITHIN THE ALLOTED 48 HOURS. (NO EXCEPTIONS)
- ELECTRICAL CONTRACTOR SHALL COORDINATE STUB-UP LOCATIONS WITH PROPOSED EQUIPMENT. (FIELD VERIFY AT STAGING YARD.)
- CONTRACTOR SHALL ANCHOR EQUIPMENT PER MANUFACTURES RECOMMENDATIONS.
- ALL FOUNDATIONS SHALL BE POURED WITHIN A $\frac{1}{4}$ " OF LEVEL IN ALL DIRECTIONS AND SMOOTH FINISHED.

FOUNDATION NOTES:

- COMPRESSIVE STRENGTH OF CONCRETE SHALL BE 3000-PSI AT 28-DAY CURE, AND SHALL MEET SPECIFICATION FOR READY-MIXED CONCRETE (ASTM C94). CONCRETE SHALL BE PLACED AND CURED AS PER ACI-318 " BUILDING CODE REQUIREMENTS FOR REINFORCED CONCRETE".
- CONCRETE SLUMP SHALL RANGE BETWEEN 4 INCHES TO 8 INCHES.
- ALL CONCRETE WORK SHALL CONFORM TO ACI 318 BUILDING CODE REQUIREMENTS FOR REINFORCED
- THE SURFACE. OVER WHICH THE CONCRETE WILL BE POURED, SHALL BE CLEAN OF LOOSE MATERIAL AND LEVELED PRIOR TO CONCRETE PLACEMENT
- CONCRETE SHALL BE PLACED IN A MANNER THAT WILL PREVENT SEGREGATION OF CONCRETE MATERIALS AND OTHER OCCURRENCES THAT MAY DECREASE THE STRENGTH OR DURABILITY OF THE FOUNDATION.
- MECHANICALLY VIBRATE CONCRETE, PARTICULARLY WHEN POURED IN DIFFERENT LIFTS, TO ENSURE CONSOLIDATION AND TO AVOID JOINTS
- ALL REINFORCING STEEL BARS SHALL BE DOMESTIC, NEW BILLET STEEL, ASTM A-615, GRADE 60. REINFORCING SHALL BE DETAILED AND FABRICATED IN ACCORDANCE WITH ACI 315-LATEST EDITION -"MANUAL OF STANDARD FOR DETAILING REINFORCED CONCRETE".
- ALL LOAD BEARING FOOTING SHALL BEAR ON TOP OF COMPACTED SOIL.
- WELDING OF REINFORCING BARS AND DOWEL BARS IS PROHIBITED UNLESS OTHERWISE APPROVED BY
- 10. PRIOR TO THE EXCAVATION, CHECK AREA FOR LOCATION OF UNDERGROUND PIPES, CABLES, ETC.







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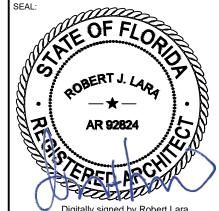
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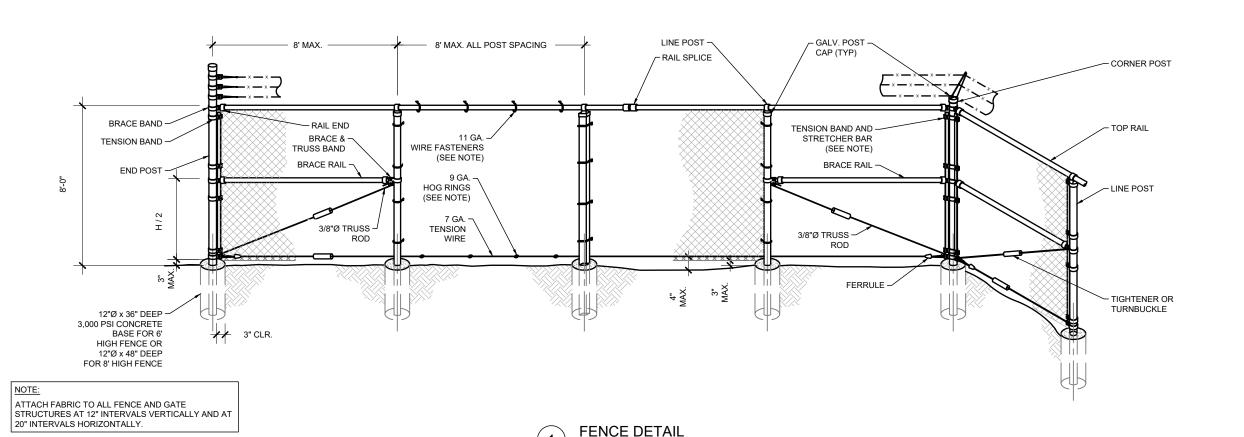
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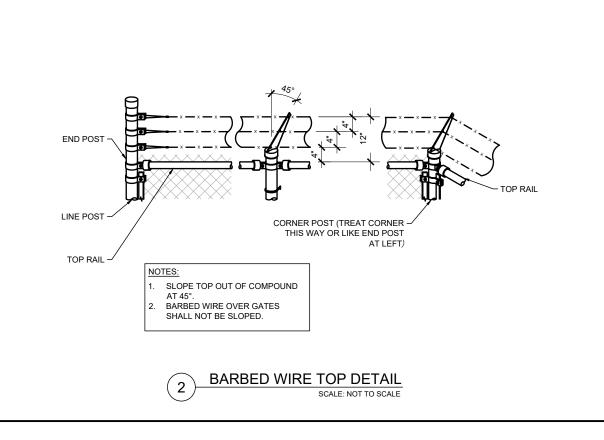
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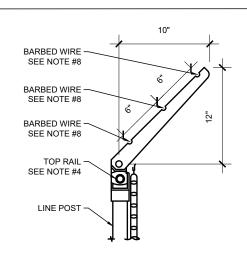
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- GATE POST, CORNER, TERMINAL OR PULL POST SHALL BE 27/8"Ø SCHEDULE 40 PIPE FOR GATE WIDTHS UPTO 6 FEET OR 12 FEET FOR DOUBLE SWING GATE PER ASTM-F1083.
- 2. LINE POST: 2%"Ø SCHEDULE 40 PIPE PER ASTM-F1083.
- GATE FRAME: 1½"Ø SCHEDULE 40 PIPE PER ASTM-F1083 & ASTM F900.
 TOP RAIL & BRACE RAIL: 1¾"Ø SCHEDULE 40 PIPE PER ASTM-F1083.
- FABRIC: 2" MESH No. 9 GAĞE GALVANIZED WIRE SECURELY FASTENED TO TENSION WIRE, LINE POST, BARS CONFORMING TO ASTM-A392, & AASHTO M 181.
- TIE WIRE: MINIMUM 11 GA GALVANIZED STEEL. INSTALL A SINGLE WRAP TIE WIRE AT POSTS AND RAILS AT MAX. 12" INTERVALS VERT & 20" HORIZ. INSTALL HOG RINGS ON TENSION WIRE AT 20" INTERVALS.
- . TENSION WIRE: 7 GA. GALVANIZED STEEL.
- BARBED WIRE: 3 STRANDS OF DOUBLE STRANDED 12½ GAUGE TWISTED WIRE, 4 PT. BARBS SPACED ON APPROXIMATELY 5" CENTERS CONFORMING TO AASHTO M 280.
- LOCAL ORDINANCE FOR BARBED WIRE PERMIT SHALL GOVERN INSTALLATION.
- 10. INSTALL FENCING PER CURRENT BUILDING CODE.

BARBED WIRE SUPPORT DETAIL

SCALE: NOT TO SCALE



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SHEET NUMBER:

GROUNDING NOTES: ALL EQUIPMENT ENCLOSURES, DEVICES AND CONDUITS SHALL BE GROUNDED TO CONFORM WITH THE LATEST REQUIREMENTS OF THE NEC BY THE INSTALLATION OF A SEPARATE, GREEN, INSULATED GROUND CONDUCTOR FOR ALL FEEDER AND BRANCH CIRCUITS. GROUND CONDUCTORS SHALL BE OF THE SIZE INDICATED ON THE DRAWINGS. GROUND CONDUCTORS SHALL BE CONTINUOUS IN LENGTH AND SHALL BE BONDED TO EACH ENCLOSURE THEY PASS THROUGH. CONDUIT SHALL NOT BE USED AS A GROUNDING CONDUCTOR. GROUNDING CONDUCTORS SHALL: A. BE #2 AWG SOLID BARE TINNED COPPER (SBTC) FOR ALL GROUNDING SYSTEM WIRE UNLESS OTHERWISE NOTED, OR OTHERWISE REQUIRED BY CODE. B. BE MINIMUM 12" BEND RADIUS. KEEP NUMBER OF BENDS TO A MINIMUM. AVOID LONG BONDING CONNECTION RUNS. MAKE DIRECT AS POSSIBLE NOT HAVE ANY U-SHAPED RUNS. BE IN NON-METALLIC CONDUIT ONLY, IF IN CONDUIT BE PLACED THROUGH NON-METALLIC SLEEVES IN FLOORS, WALLS, CEILINGS, ETC. G. PROTECTED IN NON-METALLIC CONDUIT WHERE EXPOSED ABOVE GRADE INSTALL ALL GROUNDING RINGS AND RADIALS WITH CONDUCTIVE

CEMENT, SANKOSHA AS DISTRIBUTED BY ELECTRIC MOTION COMPANY, INC., WINSTED, CT 06098, OR AS SPECIFICALLY INDICATED. INSTALL PER MANUFACTURER'S SPECIFICATIONS.

A. MINIMUM 30" BELOW GRADE, OR BELOW FROST LINE


B. MINIMUM 2' FROM FOUNDATIONS, FOOTINGS, OTHER

SYSTEMS AND ALL CONDUCTIVE OBJECTS.

C. WITH MINIMUM 12" BEND RADII.

GROUND RINGS SHALL BE

WHICHEVER IS

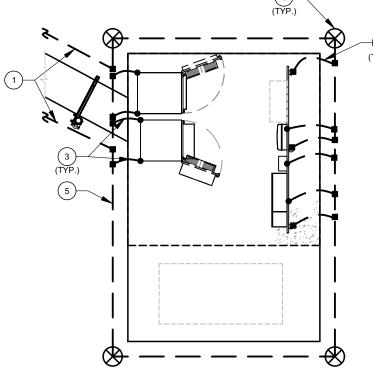


GROUNDING PLAN LEGEND: 5/8"Ø X 10' COPPER --- EXISTING GROUND WIRE **GROUND ROD** GROUND WIRE EXOTHERMIC WELD TEST WELL MECHANICAL WELD


GROUNDING KEYED NOTES:

- BOND TO TOWER GROUND RING W/ (2) #2 AWG SBTC CONDUCTORS
- #2 AWG BOND FROM VERTICAL H-FRAME AND ICE BRIDGE POST TO EXTERNAL GROUND RING (TYP. EVERY POST).
- #2 AWG SBTC EQUIPMENT BOND TO GROUND RING (TYP.)
- 5/8Ø" X 10 FT GROUND ROD.
- #2 AWG SBTC GROUND RING

(4)

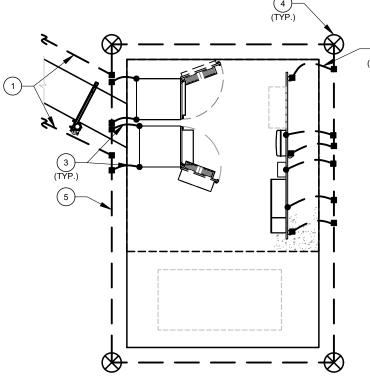

DETAILED GROUNDING PLAN

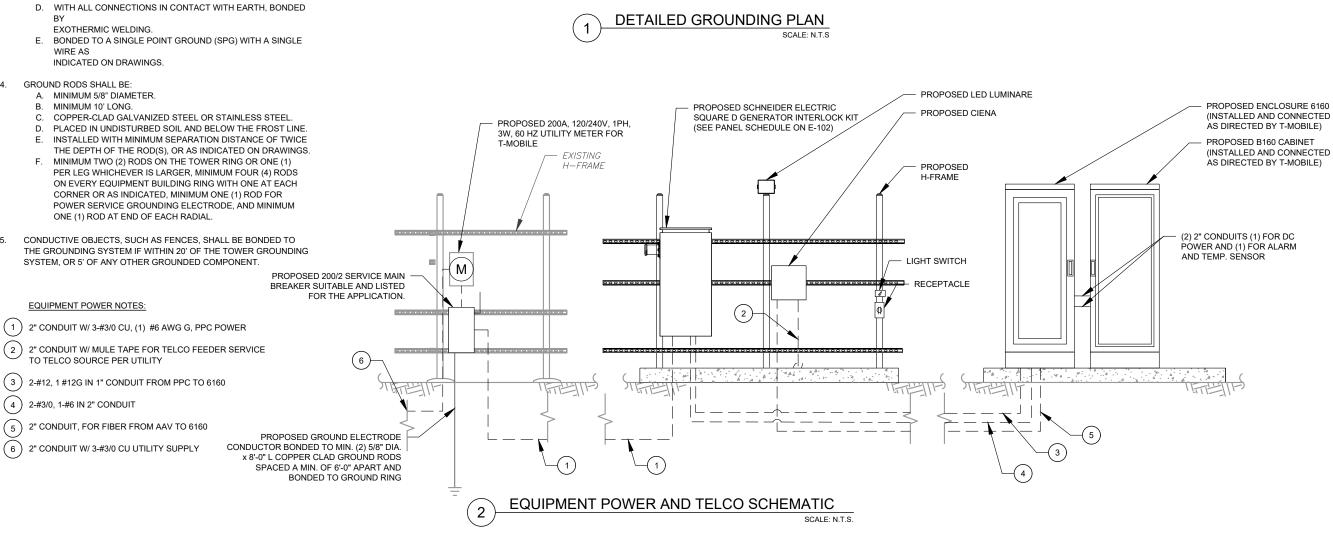



Tel: 954.577.4655 FL C OF A #8508 FL Architect business #AA26002368

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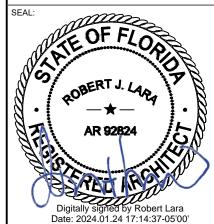
ATC SITE NUMBER: 417139 ATC SITE NAME:

COLUMBIA (CHARLES) FL

T-MOBILE SITE NAME

9JK2817A (USA)

SITE ADDRESS: CHARLES TERRACE LAKE CITY,FL 32024



T Mobile

MH PROJ NO:	220329500
ATC PROJ. #:	14192636
CUST. ID:	9JK2817A (USA)
CUST. #:	9JK2817A


GROUNDING DETAILS & |ELECTRICAL SCHEMATIC

SHEET NUMBER:

E-101

	BUS kVA						BUS								BUS kVA
Α	В	LOAD	WIRE	GND	COND	AMPS	A B		AMPS	COND	GND	WIRE	LOAD	А	В
0.00		PROPOSED SURGE SUPPRESSOR	#6	#10	1"	60	1	2	20	3/4"	#12	#12	PROPOSED GFI RECEPTACLE	0.18	
	0.00						3	4	200	2"	#6	2-#3/0	NEW 6160 SSC **		7.00
0.40		PROPOSED SERVICE LIGHT	#12	#12	3/4"	20] 5 🕂	6						7.00	
	0.18	PROPOSED NEW GFI RECEPT. INTO 6160 **	#12	#12	3/4"	20	7	8							7.00
-		SPACE	1	1	-	-	9 🕂	10						7.00	
	-	SPACE	-	-	-	-	11	12	-	-	-	-	SPACE		-
-		SPACE	-	-	-	-	13—	14	-	-	-	-	SPACE	-	
	-	SPACE	-	-	-	-	15	16	-	-	-	-	SPACE		-
-		SPACE	1	1	-	-	17—	18	-	-	-	-	SPACE	-	
	-	SPACE	-	-	-	-	19	20	-	-	-	-	SPACE		
-		SPACE	-	i	-	-	21	22	-	-	-	-	SPACE	-	
	-	SPACE	-	-	-	-	23	24	-	-	-	-	SPACE		-
0.40	0.18						А		В	TO	DTAL			14.18	14.00
CONTRA	0700 70 00	ONEIDM ALL DEOLUDEMENTO MUTU MANUE		TION ODE	.00 DD10D	LINGTALLA	14.	6	14.2	2	28.8	CONNEC	TED LOAD (kVA)		
		ONFIRM ALL REQUIREMENTS WITH MANUF NON-CONTINUOUS LOADS WITH THE EXC				INSTALLA	.TION 14.	7	14.2		28.9	DEMAND	LOAD (kVA)	ND LOAD AMPS:	

PANEL SCHEDULE

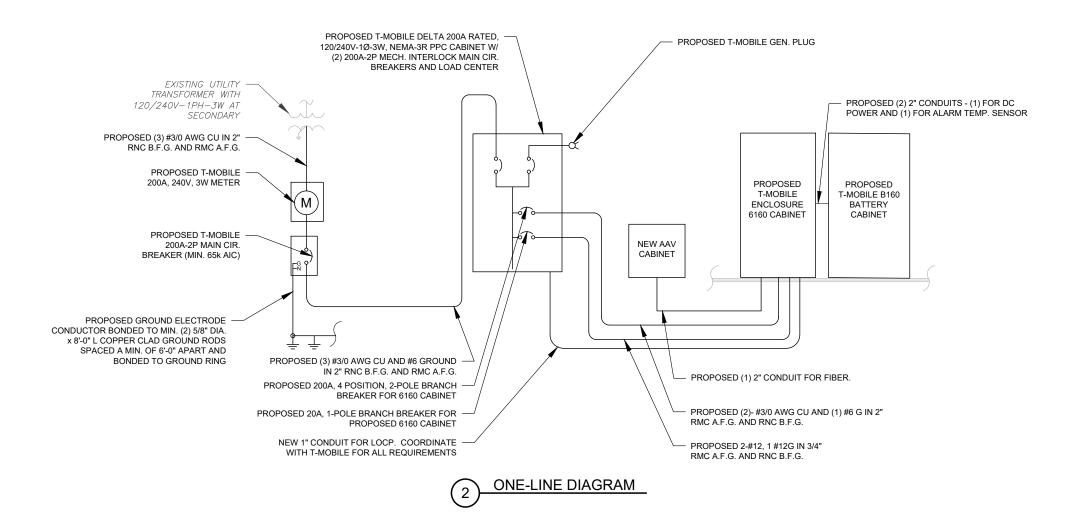



MORRISON HERSHFIELD 2 S UNIVERSITY DR., UNIT 245

PLANTATION, FL 33324 Tel: 954.577.4655 FL C OF A #8508

FL Architect business #AA26002368 www.morrisonhershfield.com

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OF ANY ERRORS OR OMISSIONS. THE INFORMATION CONTAINED IN THIS SET OF DOCUMENTS IS PROPRIETARY BY NATURE. ANY USE OR DISCLOSURE OTHER THAN WHICH IS RELATED TO NAMED CLIENT IS STRICTLY PROHIBITED. NEITHER THE ARCHITECT NOR THE ENGINEER WILL BE PROVIDING ON-SITE CONSTRUCTION REVIEW OF THIS PROJECT. ALL PREVIOUS ISSUES OF THIS DRAWING ARE SUPERSEDED BY THE LATEST REVISION.

REV.	DESCRIPTION	BY	DATE
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Λ_{-}	FINALS	MS	01/19/24
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417139 ATC SITE NAME:


COLUMBIA (CHARLES) FL

ATC SITE NUMBER:

T-MOBILE SITE NAME:

9JK2817A (USA)

SITE ADDRESS: CHARLES TERRACE LAKE CITY,FL 32024

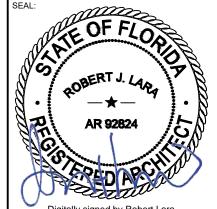


Digitally signed by Robert Lara Date: 2024.01.24 17:14:50-05'00'

	MH PROJ NO:	220329500
	ATC PROJ. #:	14192636
	CUST. ID:	9JK2817A (USA)
	CUST. #:	9JK2817A

PANEL SCHEDULE & ONE-LINE DIAGRAM


SHEET NUMBER:

E-102

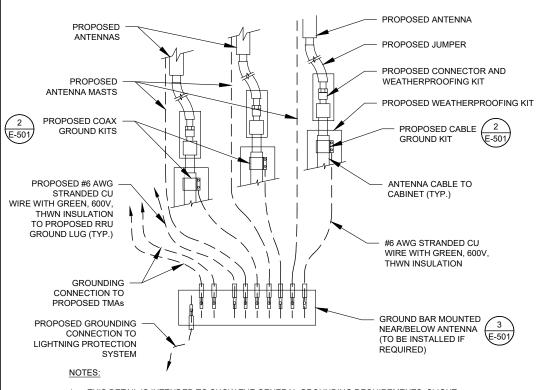


- THIS DETAIL IS INTENDED TO SHOW THE GENERAL GROUNDING REQUIREMENTS. SLIGHT ADJUSTMENTS MAY BE REQUIRED BASED ON EXISTING SITE CONDITIONS. THE CONTRACTOR SHALL MAKE FIELD ADJUSTMENTS AS NEEDED AND INFORM THE CONSTRUCTION MANAGER OF ANY CONFLICTS.
- SITE GROUNDING SHALL COMPLY WITH T-MOBILE GROUNDING STANDARDS, LATEST EDITION, AND COMPLY WITH T-MOBILE GROUNDING CHECKLIST, LATEST VERSION. WHEN NATIONAL AND LOCAL GROUNDING CODES ARE MORE STRINGENT THEY SHALL GOVERN.



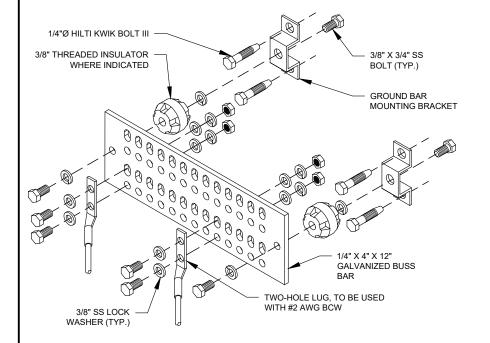

GROUND BAR NOTES


- GROUND KITS COME WITH ALL HARDWARE, NUTS, BOLTS, WASHERS, ETC. EXCEPT THE STRUCTURAL MOUNTING MEMBER(S)
- 2. GROUND BAR SHALL BE BOLTED TO STRUCTURAL MEMBER OR ANCHORED TO CONCRETE SLAB W/ HILTI KWIK BOLT III.

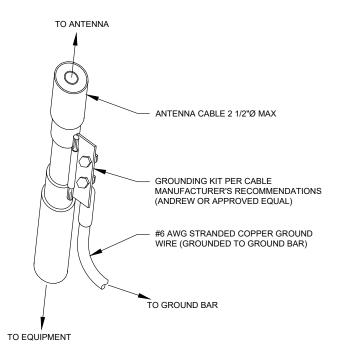

- GROUND KIT NOTES:

 1. DO NOT INSTALL CABLE GROUND KIT AT A BEND AND ALWAYS DIRECT GROUND WIRE DOWN TO GROUND BAR.
- 2. CONTRACTOR SHALL PROVIDE WEATHERPROOFING KIT (ANDREW PART NUMBER 221213) AND INSTALL/TAPE PER MANUFACTURER'S SPECIFICATIONS

CABLE GROUND KIT CONNECTION DETAIL

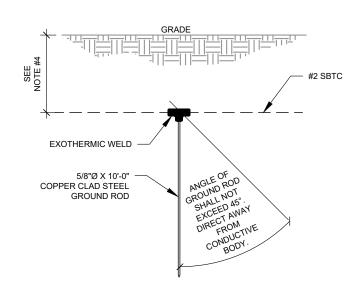


NOTES:

- SEPARATION DIMENSION TO BE VERIFIED WITH LOCAL UTILITY COMPANY
- 2. COORDINATE UTILITY, LOCATE BEFORE DIGGING.
- CONDUIT TRENCHING DEPTHS AT 36" OR 6" BELOW FROST LINE, WHICHEVER IS GREATER.
- ALL RING AND RADIAL DEPTHS AT 30" OR 6" BELOW FROST LINE, WHICHEVER IS GREATER.

GROUND ROD DETAIL SCALE: N.T.S.




TIE CONNECTION DETAIL

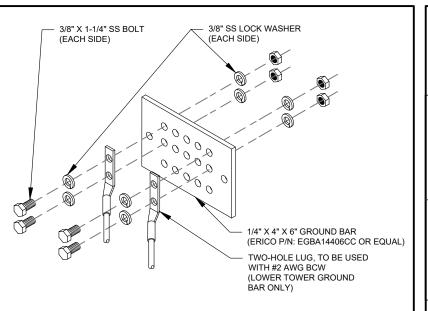

GROUND BAR NOTES:

- GROUND BAR KITS COME WITH ALL HARDWARE, NUTS, BOLTS, WASHERS, ETC. EXCEPT THE STRUCTURAL MOUNTING MEMBER(S).
- 2. GROUND BAR TO BE BONDED DIRECTLY TO TOWER

TOWER GROUND BAR DETAIL

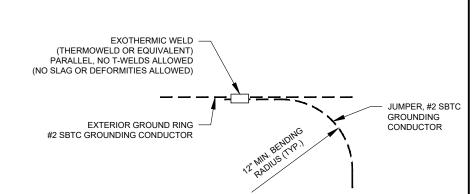

AMERICAN TOWER

MORRISON HERSHFIELD 2 S UNIVERSITY DR., UNIT 245 PLANTATION, FL 33324

Tel: 954.577.4655 FL C OF A #8508

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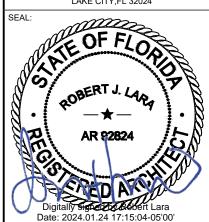
ATC SITE NUMBER: 417139 ATC SITE NAME:

COLUMBIA (CHARLES) FL

T-MOBILE SITE NAME

9JK2817A (USA)

SITE ADDRESS: CHARLES TERRACE LAKE CITY.FL 32024



T Mobile

MH PROJ NO:	220329500
ATC PROJ. #:	14192636
CUST. ID:	9JK2817A (USA)
CUST. #:	9JK2817A

GROUNDING DETAILS

SHEET NUMBER

E-501

REVISION



MAIN GROUND BAR DETAIL

RAN Template: 4Sec-67E5D998E 6160 (no GSM)

A&L Template: 4Sec-67E5998E_1xAIR+10P 9JK2817A_Coverage Strategy_1

Print Name: Standard PORs: Coverage Strategy_Regional Coverage

Section 1 - Site Information

Site ID: 9JK2817A Status: ReadyForReview

Version: 1

Sector Count: 4

Project Type: Coverage Strategy Approved: Not approved Approved By: Not approved

Last Modified: 11/10/2022 9:52:39 AM

Last Modified By: Ernest.Shuman@T-Mobile.com

RAN Template: 4Sec-67E5D998E 6160 (no GSM)

Site Name: 9JK2817A (UsA) Site Class: Self Support Tower Site Type: Structure Non Building

Plan Year: Market: JACKSONVILLE FL

Vendor: Nokia Landlord: Not Specified

Latitude: 30.106319 Longitude: -82.760058 Address: Charles Terrace City, State: Charles Terrace, FL

Region: SOUTH

AL Template: 4Sec-67E5998E_1xAIR+1OP

Antenna Count: 8 Coax Line Count: 0 TMA Count: 0 RRU Count: 8

Section 2 - Existing Template Images

RFDS HEADER SCALE: NOT TO SCALE

11/10/22, 9:53 AM 9JK2817A_Coverage Strategy_1_2022-11-10

A&I. Template: o-67E5998E_1 xAIR+1OP

9JK2817A_Coverage Strategy_1 Print Name: Standard PORs: Coverage Strategy_Regional Coverage

Section 6 - A&L Equipment

	Sec	tor 1 (Propose	d) view from fr	ont (Note: the	images show view fro	m behind)		
Coverage Type	A - Outdoor Macro	9		/	1 10			
Antenna			1		/ /	2		
Antenna Model	Commscope - FF	VV-65C-R3-V1 (Oct	0)	AIR 8419 B41 (Active Anter	ne - Massive MIMO)			
Azimuth	(50)			50				
M. Tilt	0				0			
Height	(240)			(240)				
Ports	P1	P2	P3	P4	P5	P6		
Active Tech	L700 L600	L700 L600 N600	(L2100) (L1900) (N1900)	(L2100) (L1900) (N1900)	N2500)	N2500)		
Dark Tech								
Restricted Tech								
Decomm. Tech								
E. Tilt								
Cables	Coax Jumper (x2)	Coax Jumper (x2)	Coax Jumper (x2)	Goax Jumper (x2)				
TMAs								
Diplexer / Combiners								
Radio	Radio 4480 B71+B85 (At Antenns)	Radio 4480 (B71+B86 (At (Antenna)	Radio 4450 825+856 (At Antenna)	Radio 4460 B25+B66 (Al Antenna)				
Sector Equipment								
Unconnected Equip	oment:					-		
Scope of Work:								
Scope of Work:								

11/10/22, 9:53 AM

9JK2817A_Coverage Strategy_1_2022-11-10

9JK2B17A_Coverage Strategy_1 Print Name: Standard PORs: Coverage Strategy_Regional Coverage

	Sec	tor 2 (Propose	d) view from fr	ont (Note: the	images show view from	behind)
Coverage Type	A - Outdoor Macro	9				
Antenna		Total .	1		1	2
Antenna Model	Commscope - FF	VV-65C-R3-V1 (Od	0)		(AIR 6419 B41 (Active Antenn	a - Massive MIMO))
Azimuth	[130]				(130)	
M. Tilt	0				0	
Height	(240)				(240)	
Ports	P1	P2	P3	P4	P5	P6
Active Tech	(L700) (L600) (N600)	(L700) (L600) (N600)	(L2100) (L1900) (N1900)	(L2100) (L1900) (N1900)	(N2500)	(N2500)
Dark Tech						
Restricted Tech						
Decomm. Tech						
E. Tilt					İ	
Cables	Coax Jumper (x2)	Coax Jumper (x2)	Cosx Jumper (x2)	Coax Jumper (x2)		
TMAs						
Diplexer / Combiners						
Radio	Radio 4480 B71+B85 (At Antenna)	Radio 4480 IB71+B86 (At IAntenna)	Radio 4480 B25+B66 (At Antenna)	Radio 4450 825+866 (At Antenna)		
Sector Equipment					Ī	
Unconnected Equip	oment			,	***	*
*A dashed border in	dicates shared conn	ected equipment. A	ny shared equipmen	t, besides the first, it	s denoted with the SHARED key	word.

BETA SECTOR INFORMATION SCALE: NOT TO SCALE

NOTE: THIS SHEET CREATED BY OTHERS AND PROVIDED BY REQUEST OF CUSTOMER WITHOUT EDIT.

SUPPLEMENTAL

REVISION:

SHEET NUMBER:

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9JK2817A_Coverage Strategy_1_2022-11-10

RAN Template:	A&L Template:
4Sec-67E5D998E 6160 (no GSM)	4Sec-67E5998E_1xAIR+10P

9JK2817A_Coverage Strategy_1 Print Name: Standard PORs: Coverage Strategy_Regional Coverage

	Sec	tor 3 (Propose	d) view from fr	ont (Note: the	images show view fron	n behind)
Coverage Type	A - Outdoor Macro	9				
Antenna	1 2					
Antenna Model	Commscope - FF	VV-65C-R3-V1 (Oct	0)		(AIR 6419 B41 (Active Antenn	a - Massive MIMO)
Azimuth	220				(220)	
M. Tilt	0				0	
Height	240				(240)	
Ports	P1	P2	P3	P4	P5	P6
Active Tech	L700 L600 N600	L700 L600 N600	(L2100) (L1900) (N1900)	L2100 (L1900) N1900	N2500	(N2500)
Dark Tech						
Restricted Tech						
Decomm. Tech						
E. Tilt						
Cables	Coax Jumper (x2)	Coax Jumper (x2)	Coax Jumper (x2)	Ccax Jumper (x2)		
TMAs						
Diplexer / Combiners						
Radio	Radio 4480 B71+B85 (At IAntenna)	Radio 4480 1871+885 (At 1Antenna)	Radio 4460 B25+B66 (At Antenna)	Radio 4480 B25+866 (At Antenna)		
Sector Equipment						
Unconnected Equip	oment:					
Scope of Work:						
and at their						

1	GAMMA SECTOR INFORMATION
\bigcup	SCALE: NOT TO SCALE

44161	nma	0.53	481	

9JK2817A_Coverage Strategy_1_2022-11-10

RAN Template:	A&L Template:
4Sec-67E5D998E 6160 (no GSM)	4Sec-67E5996E_1xAIR+1OP

9JK2817A_Coverage Strategy_1 Print Name: Standard PORs: Coverage Strategy_Regional Coverage

Coverage Type	(A - Outdoor Macro)					
Antenna			1		2	
Antenna Model	Commscope - FF	VV-65C-R3-V1 (Oct	(0)		(AIR 6419 B41 (Active Antenn	a - Massive MIMO))
Azimuth	330				(330)	
M. Tilt	0				0	
Height	240				240	
Ports	P1	P2	P3	P4	P5	P6
Active Tech	L700 L600 N600	L700 (L600) N600)	(L2100) (L1900) (N1900)	(L2100 (L1900) (N1900)	N2500)	N2500)
Dark Tech						
Restricted Tech						
Decomm, Tech						
E. Tilt						
Cables	Coax Jumper (x2)	Coax Jumper (x2)	Coax Jumper (x2)	Coax Jumper (x2)		
TMAs						
Diplexer / Combiners						
Radio	Radio 4480 B71+885 (At Antenna)	Radio 4480 B71-B85 (At Antenna)	Radio 4480 B25+B66 (At Antenna)	Radio 4460 1825+866 (At Antenna)		
Sector Equipment						
Unconnected Equip	oment:		•			

1	\sim	1
(2)
/		/

DELTA SECTOR INFORMATION

SCALE: NOT TO SCALE

SUPPLEMENTAL

SHEET NUMBER:

REVISION:

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1/10/22, 9:53 AM	. 1	40.7	
RAN Template 4Sec-67E5D998E 6160		ASL Template: 4Sec-67E5998E_1xA/R+1CP	9JK2817A_Coverage Strategy_1
		1	Print Name: Standard PORs: Coverage Strategy_Regional Coverage
		///	Section 5 - RAN Equipment
			Existing RAN Equipment
			This section is intentionally blank
			Proposed RAN Equipment
			emplate: 4Sec-67E5D998E 6160 (no GSM)
Enclosure		1	2
Enclosure Type	Enclosur	e 6160 AC V1)	(B160)
Baseband	RP 6651 N600 L600 L700	RP 6651 N2500 RP 6651 N1900 L1900 L2100	
Transport System	CSR IXR	e V2 (Gen2)	
Hybrid Cable System	(Hybrid Tr	unk 6/24 4AWG 90m (x4)) (PSU 48	3 vR4A (Kit) (x2)
RAN Scope of Work	G		· ·

CABINET CONFIGURATION

Section 3 - Proposed Template Images 4Sec-67E5A998E.jpg Final Config: 4Sec-67E5A998E MB+LB Octo Passive Antenna L600 L700 AJR6449 B41 2xL19 2.5GHz NR+LTE GSM Radio 4460 825+866 Radio 4480 B12+B71 Top Ground

9JK2817A_Coverage Strategy_1_2022-11-10

11/10/22, 9:53 AM

2 ANTENNA CONFIGURATION


SUPPLEMENTAL

SHEET NUMBER:


R-603

REVISION:


NOTE: THIS SHEET CREATED BY OTHERS AND PROVIDED BY REQUEST OF CUSTOMER WITHOUT EDIT.

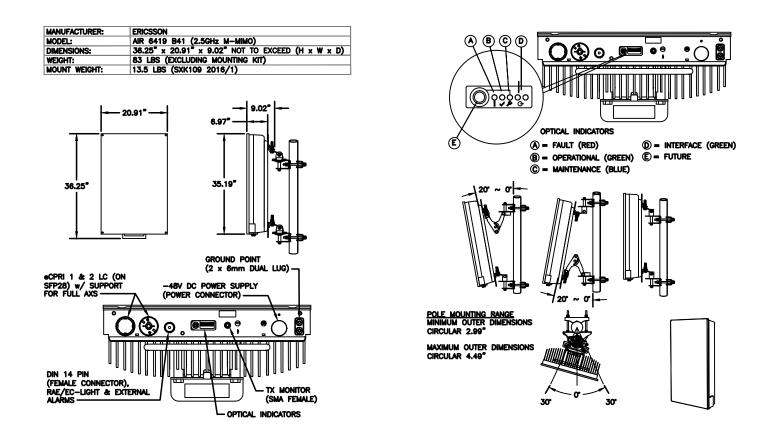

34552 - ERICSSON AIR 6419 BAND 41

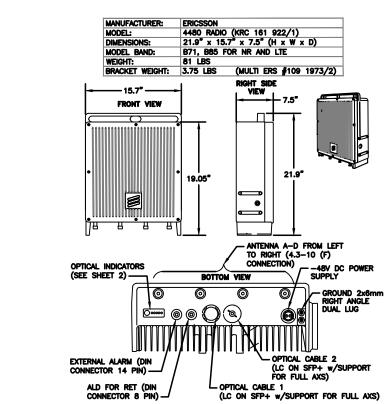

SCALE: N.T.S.

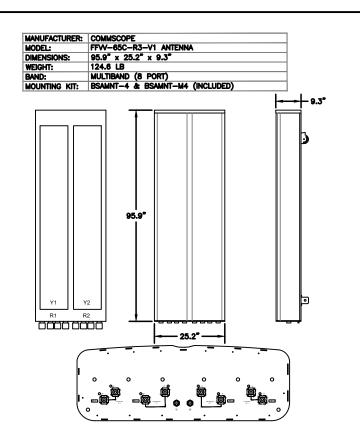

34074 - COMMSCOPE FFVV-65C-R3-V1 SCALE: N.T.S.

GROUND 2x6mm RIGHT ANGLE DUAL LUG

SUPPLEMENTAL

SHEET NUMBER:

REVISION

34373 - ERICSSON 4460 RADIO B2/25 B66 SCALE: N.T.S.

OPT2_2 2+2 CPRI PORTS

- OPT2_1 2+2 CPRI PORTS

__EAC 1

ANTENNA B1 4.3-10 CONNECTOR

ANTENNA A2 4.3-10 CONNECTOR - GROUND 2

(2 WIRE)

OPT1_2 2+2 CPRI PORTS

MANUFACTURER: ERICSSON
MODEL: 4460 RADIO B2/25 B66 (KRC 161 912/3)
DIMENSIONS: 19.7" x 15.8" x 12.2" (H" x W" x D")

BRACKET WEIGHT: 4.8 LBS (ERS HEAVY #SXK1255993/1)

₱ ० ○

15.8"

OPT1_1 2+2 CPRI PORTS -

ALD 2

EAC 2

19.7"

GROUND

ANTENNA A1


(3)


34372 - ERICSSON 4480 RADIO B71/85


MANUFACTURER: ERICSSON
MODEL: PSU 48 13
WEIGHT: 17.1 LBS
DIMENSIONS: 19"x 1.7"x 14.3"

NEEDED INSTALL KIT (PICK 1)


34133 PSU4813 INSTALL KIT FOR RBS61XX 34134 PSU4813 INSTALL KIT FOR PBC6200 34135 PSU4813 INSTALL KIT FOR 6X60/RBS6230

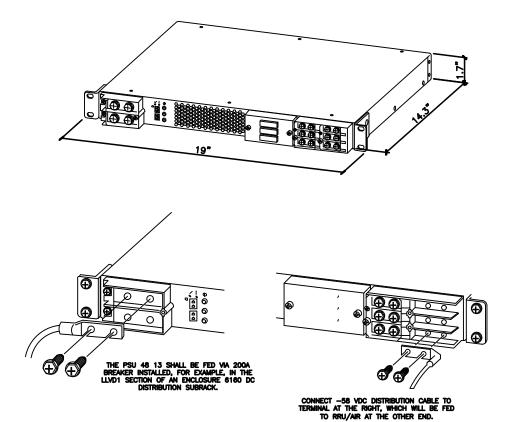

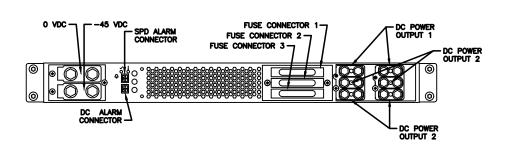

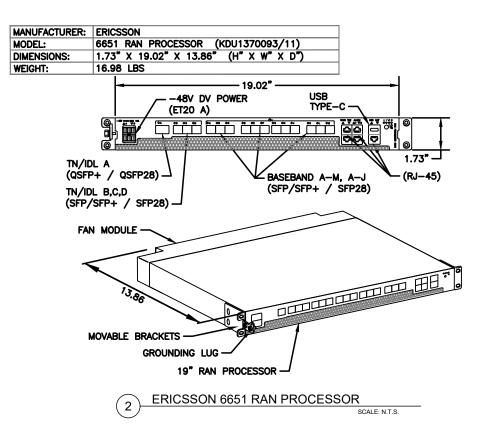

NOKIA	
IXR-E MODULE	
17.25"x10.0"x1.75" (HxWxD)	
TBD	

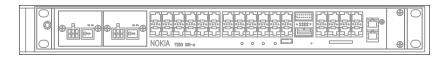



3 IXRE VPSCALE

SUPPLEMENTAL


SHEET NUMBER:

R-605

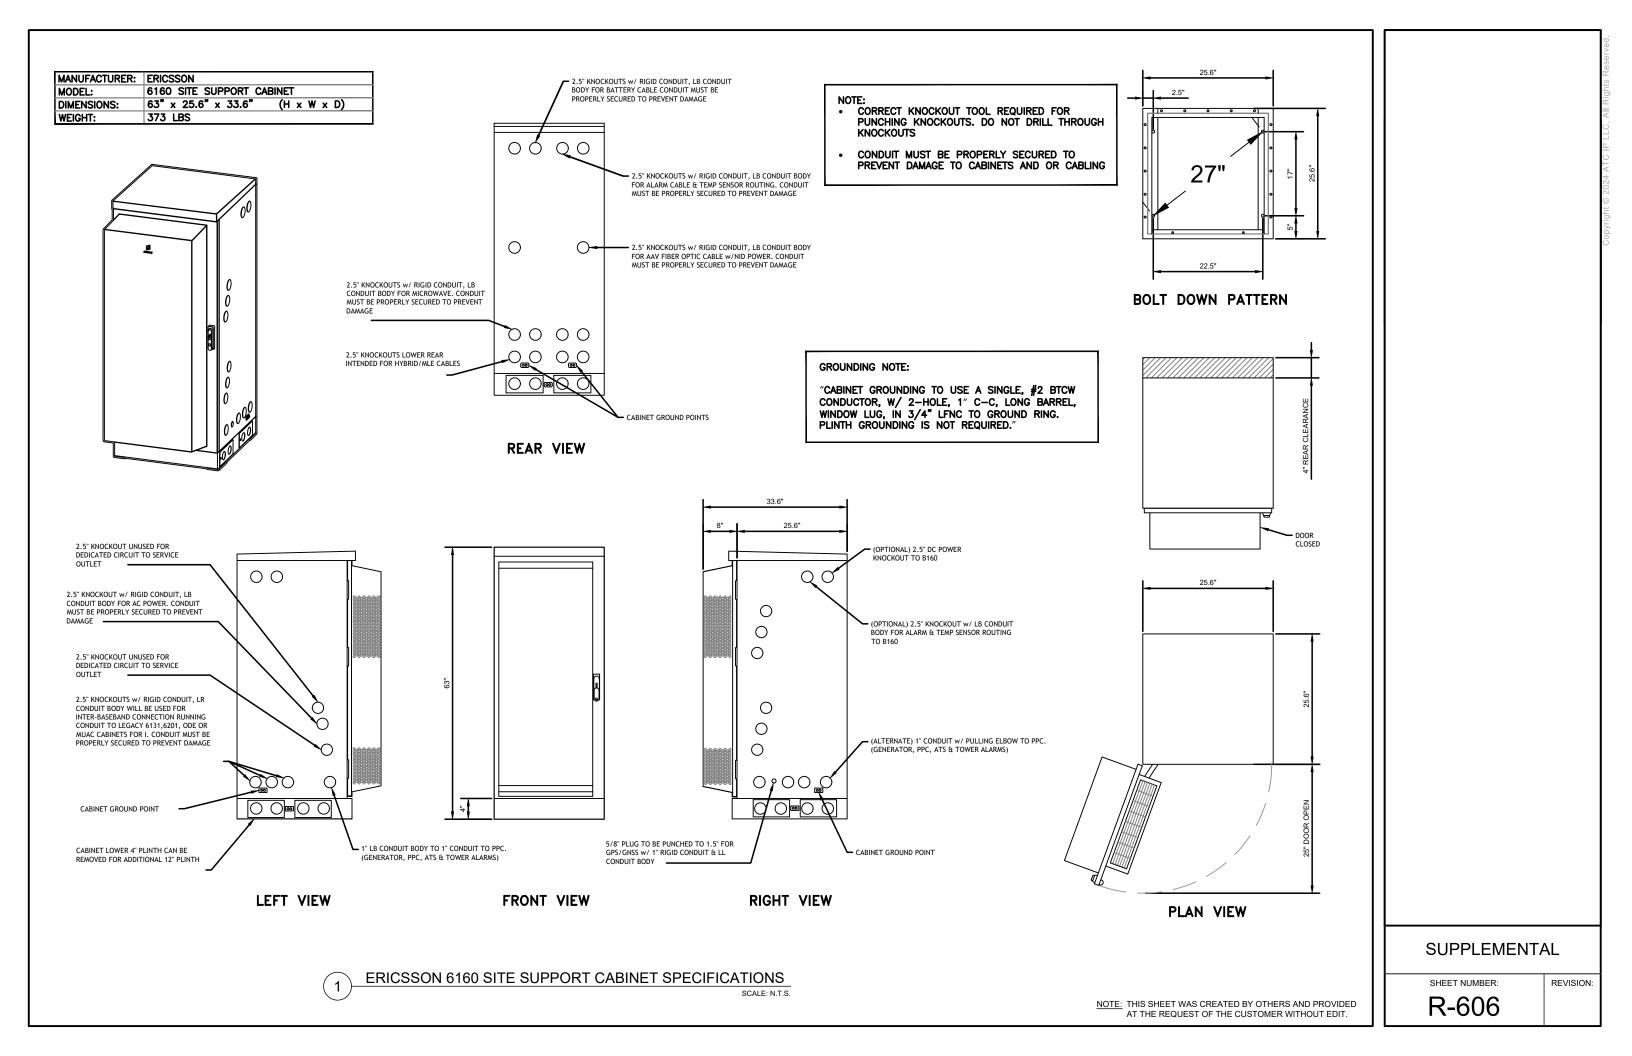

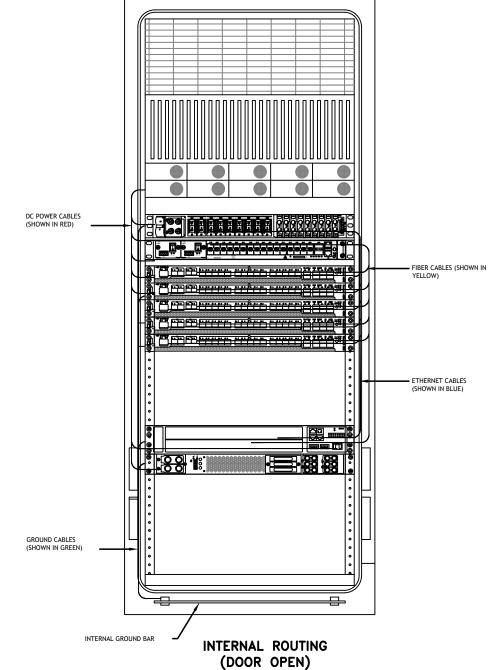

RA	ACK ASSIGNMENTS
RU SLOTS	DESCRIPTION
1	
2	DC DISTRIBUTION
3	DO DISTRIBUTION
4	
5	RECTIFIER SHELF
6	RECTIFIER SHELF
7	FIBER BOX
8	DCDU
9	BACKHAUL ROUTER
10	BACKHAUL KOUTEK
11	1ST BASEBAND
12	2ND BASEBAND
13	3RD BASEBAND
14	4TH BASEBAND
15	5TH BASEBAND
16	
17	EXPANSION
18	EM ANOION
19	
20	EXPANSION / LEGACY
21	BASEBAND / VOLTAGE BOOSTER
22	VOLTAGE BOOSTER
23	
24	OPEN SPACE FOR SPD ACCESS
25	,

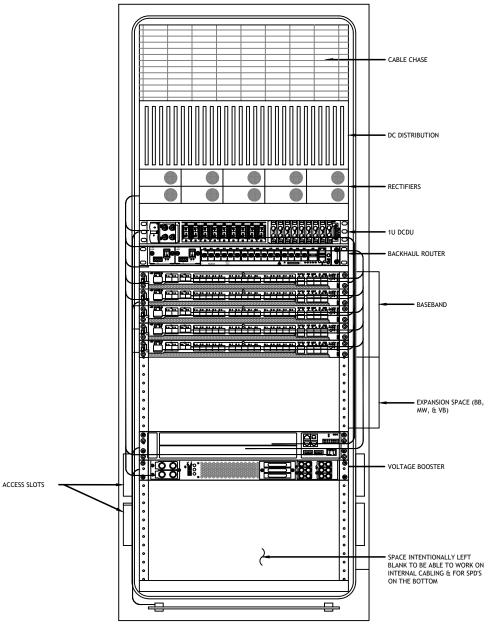

FRONT VIEW (DOOR OPEN)

SUPPLEMENTAL

SHEET NUMBER:


R-607

REVISION:

ERICSSON 6160 CABINET DETAILS

NOTE:
THIS IS FOR REFERENCE ONLY, CHECK
FOR SPECIFIC DETAIL IN T-MOBILE
CABINET SPECIFIC INSTALLATION GUIDES

Breaker Allocation for LG160								
CR SECLE	Ckt#		w/ DCDU Prior to availability of the 4460 and 4480	w/ DCDU Tater Design Post- 4460 and Post 4480	w/ DCDU 4 and 6 Sector designs			
-		1	Router PS 2*/Future		ta dio 4460 825/56 (-1			
2	.VD1 47.0V	2	F	Radio / 460 B25/S6 ζ-2				
3		3	PSU 4813 feeding B25	PSU 4813 feeding B41 & & B71/12 &				
4		۷		(Air 6449s and Radio 4480s)				
5		5	nc	AC- V				
6		G	1.25	PSU 7813 feeting B41 α, β and γ (Air S				
1		1	P5.J 4813 feecing B71/12	UVII 4917/ fooding 211/11 g	PSU 4813 feeding 371/12 o. H and y (Pacin 4480s)			
8		2	α, 3 and γ (tadio 4449s)	, рэно удваси: 44805)				
9	VD2	3	F	Radio 4460 B25/66 δ-1				
10	45.17	۷	ı	ta dio 445H B25/56 6-2				
11		5	F	Radio / 450 B25/56 e-1				
12		ń	F	ta dio 445H R25/56 e-2				
13		1		Couter PS-1				
14		2	Radio 4415 B25/66 α	Radio 4460 B	25/66 α-1			
15		3	tadio 4415 B25/S6 H	ta din 4460 B	25/55 p-2			
16		1	Radio 4/15 325/65 y Radio //60 B		25/55 β-1			
17	3LVD 43.2V	5	PSU 4813 feeding 32/25 tadio 4460 8		25/55 β-2			
13	43.21	6	α, β and γ (Racic 4424a)	σ, β and γ (Paero 4424a) Racio 4760 B				
19		7	Futine	Future Radio 4460 325/66				
20		К						
21		9						
	Sector Identification							

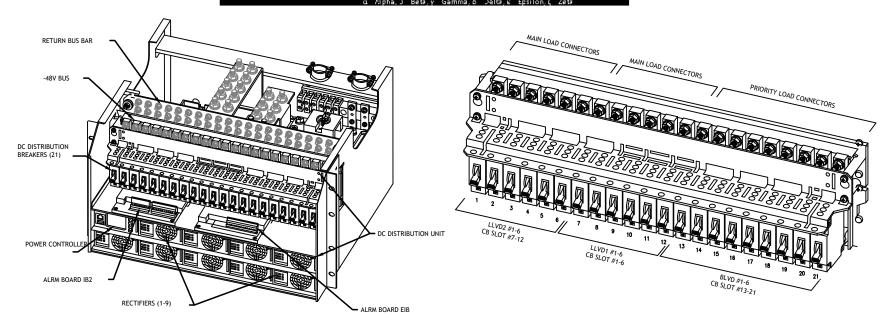

POWER SUBRACK

DC DISTRIBUTION

ERICSSON 6160 ELECTRICAL DETAILS

SCALE: N.T.S.

NOTE: THIS SHEET WAS CREATED BY OTHERS AND PROVIDED AT THE REQUEST OF THE CUSTOMER WITHOUT EDIT.

SUPPLEMENTAL

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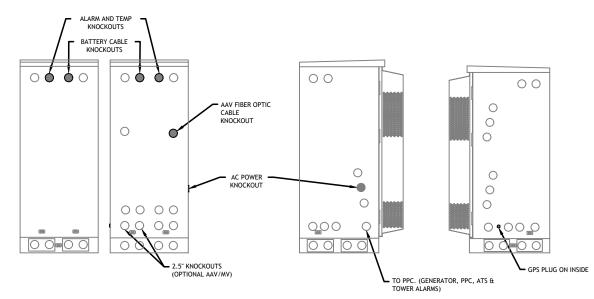
REVISION:

NOTE:


- 1. ALL CONDUIT AND FITTING ENTRANCES INTO CABINETS AND ENCLOSURES MUST UTILIZE MYERS OR EQUIVALENT HUBS OR SEALING WASHERS TO PREVENT WATER ENTRY/SEEPAGE INTO CABINETS AND ENCLOSURES.
- 2. (LIQUIDFLEX) FLEXIBLE METALLIC CONDUIT (LFMC) & ASSOCIATED FITTINGS CAN BE USED AS NEEDED BUT ONLY FOR TIGHT CONDUIT BENDS AND RUNS SUBJECT TO UL AND NEC LIMITATIONS. 6' MAX PER CONDUIT RUN.
- 3. POWER CONDUIT BODY ATTACHED WITH SHORT NIPPLE AND SEALING WASHER INSIDE & OUT. (FOR DOOR HOOD CLEARANCE)
- 4. PULLING ELBOWS MAY BE USED IN LIEU OF A CONDUIT BODIES WHEN CLEARANCE IS LIMITED.
- 5. ALL EXTERNAL ALARM CONDUITS ARE TOO TERMINATE AT THE PPC WITH A SINGLE 1" ALARM CONDUIT TO THE 6160.

REAR VIEW

6. (DO NOT USE CHASE NIPPLES) CONDUIT SHOULD HAVE SEALING WASHERS INSIDE AND OUT w/ LOCK NUT AND CAP.




CONDUIT LOCATIONS

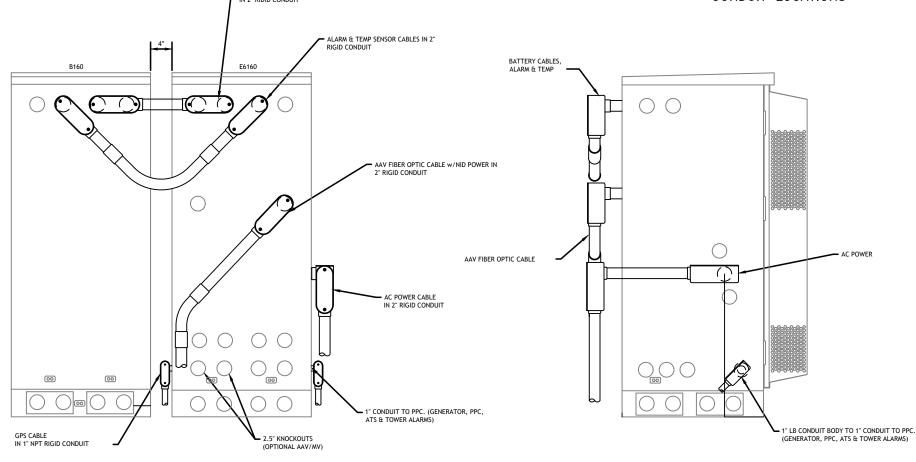


SIDE VIEW

ERICSSON 6160/B160 CONDUIT ROUTING DETAILS

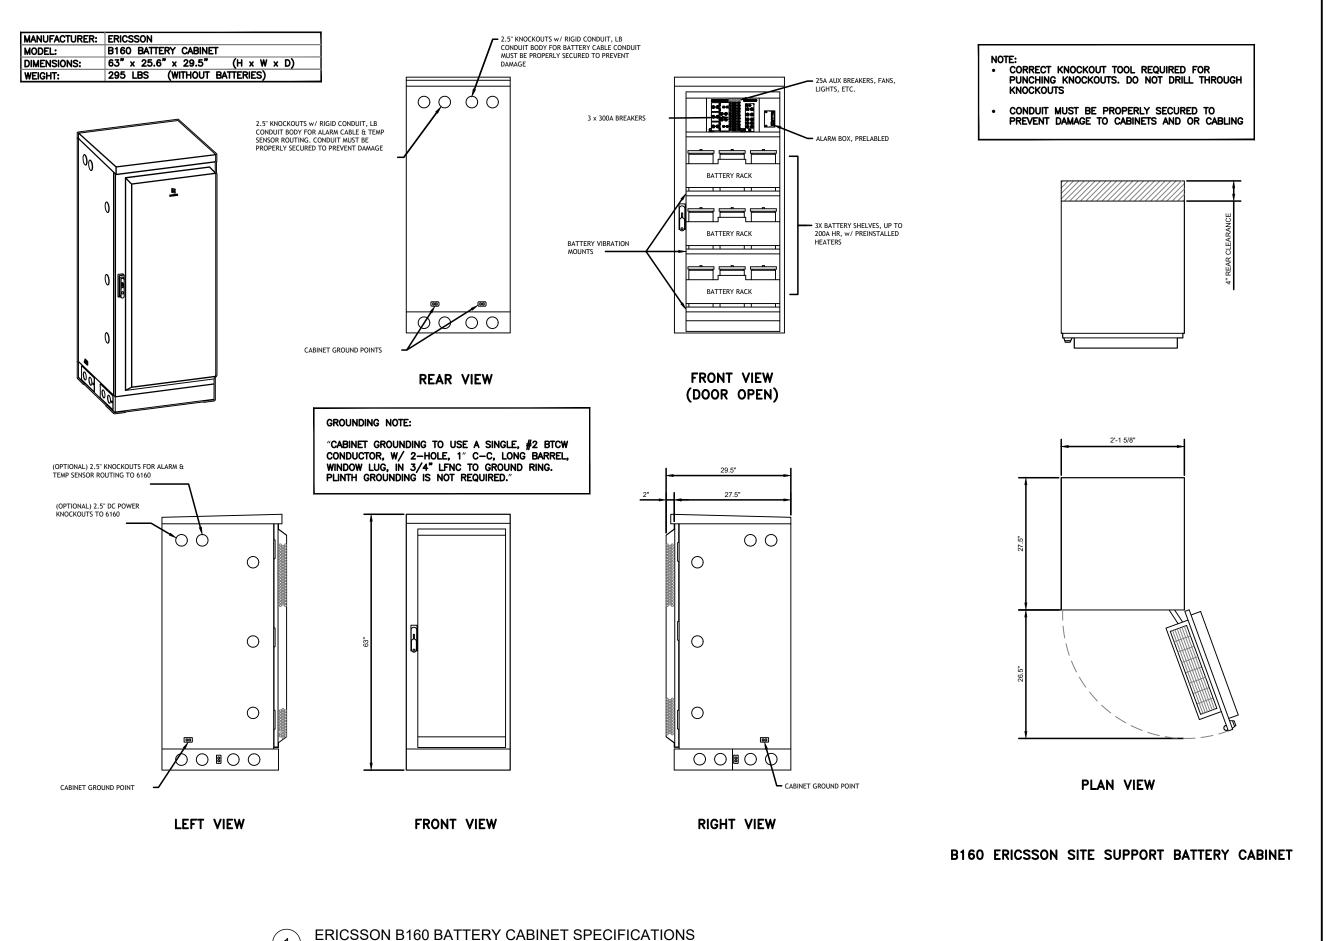

SHEET NUMBER:

R-610

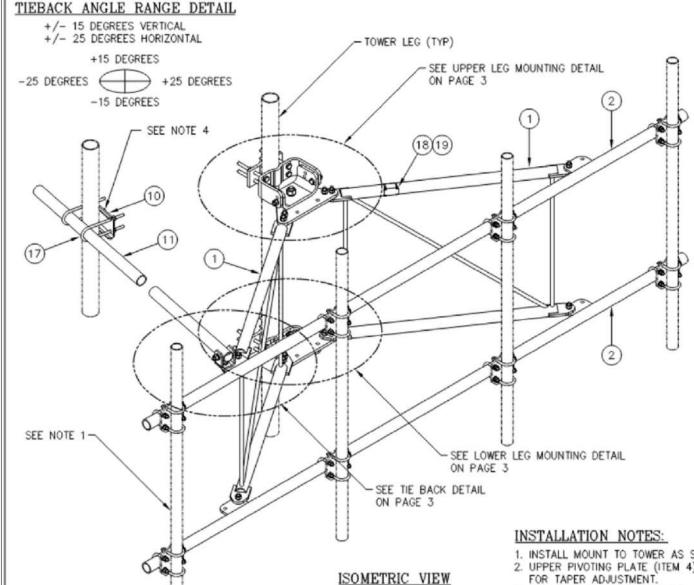

C10857001C 12' HD V-BOOM ASSEMBLY W/TIEBACK							
ITEM	EM QTY. PART NO.		DESCRIPTION	WEIGHT			
1.	2	CW01222	WELDMENT, STANDOFF ARM	126			
2.	2 CW01223 WELDMENT, FACE PIPE						
3.	2	CS03109	PLATE, ROTATING	34			
4.	1	CS03110	PLATE, PIVOTING (UPPER)	16			
5.	1	CS03111	PLATE, LEG CLAMP (UPPER)	17			
6.	1	CS03112	PLATE, PIVOTING (LOWER)	14			
7.	1	CS03113	PLATE, LEG CLAMP (LOWER)	17			
8.	2	CS03114	PLATE, LEG CLAMP (BACK)	14			
9.	1	CS00098	PLATE, TIE BACK SWIVEL	3			
10.	1	CS03285	PLATE, TIE BACK CLAMP	4			
11.	1	CS03333	PIPE, TIE BACK	38			
12.	2	C40026073	BOLT ASSEMBLY, 1 Ø X 3 A325	4			
13.	8	C40140004	BOLT ASSEMBLY, 5/8 Ø X 8 A307	13			
14.	1	C40026033	BOLT ASSEMBLY, 5/8 Ø X 4 1/2 A325	1			
15.	12	C40026025	BOLT ASSEMBLY, 5/8 Ø X 2 1/2 A325	6			
16.	5	C40026024	BOLT ASSEMBLY, 5/8 Ø X 2 1/4 A325	3			
17.	2	C40034183	U-BOLT ASSEMBLY, 1/2 Ø X 2 9/16 C-C	3			
18.	1	Z30992001	MOUNT CLASSIFICATION TAG C10857001C	1			
19.	2	C40062103	STAINLESS STEEL SELF-LOCKING CABLE TIE	1			
			TOTAL WEIGHT	462			

PACKAGING NOTE

CK00386 INCLUDES ITEMS 1, 3, 4, 5, 6, 7, 12 & 15 (8 QTY) CK00387 INCLUDES ITEMS 2, 8, 9, 10, 11, 13, 14, 15 (4 QTY), 16, 17, 18 & 19

- 1. INSTALL MOUNT TO TOWER AS SHOWN, SO THAT WELDED STANDOFF DIAGONAL IS SLOPING DOWNWARD FROM TOWER END TO FACE PIPE END. 2. UPPER PIVOTING PLATE (ITEM 4) HAS THREE HOLES ON EACH SIDE AND UPPER LEG CLAMP PLATE (ITEM 5) HAS TWO HOLES ON EACH SIDE FOR TAPER ADJUSTMENT.
- 3. INSTALL PRODUCT EXACTLY AS SHOWN IN DRAWING, WITH ALL BOLTS FACING UPWARDS.

DESCRIPTION

ALL DIMENSIONS INCLUDE FINISHES AND ARE IN INCHES Sabre Industries TOLERANCES: FRACTIONS ± 1/16" ANGLES ± 1/2 DEG. TOLERANCES DO NOT APPLY DECIMALS ± .010" TO RAW MATERIAL CONFIDENTIAL

UNLESS OTHERWISE SPECIFIED

REV DATE DRWICHK

Towers and Poles

This document and the information contained herein is the confidential trade secret property of Sabre Communications Corporation ("Sabre") and must not be reproduced, copied or used, in whole or in 3 10/19/16 KLE DEL ADDED INSTALLATION NOTES
2 02/05/16 DLWIDEL ADDED PACKAGING NOTE
1 01/21/16 KLE EK REMSED NOTES & ADDED TIEBACK ANGLE RANGE DETAIL
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12' HD V-BOOM ASSEMBLY W/TIEBACK (3' STANDOFF) W/NO ANTENNA MOUNTING PIPES

		SIZE	DRAWING NO.	REV	
DATE	12/22/15	B	C10857001C	3	
DRAWN BY	WRF	\vdash	SCALE	PAGE	
CHECKED BY	EK		None	1 OF 3	

SUPPLEMENTAL


SHEET NUMBER:

REVISION:

R-611

NOTES:


- 1. MOUNTING PIPES & CROSSOVER PLATE KITS MUST BE PURCHASED SEPARATELY. 2. QUANTITIES SHOWN IN LISTS OF MATERIAL ARE FOR ONE (1) V-BOOM ONLY.
- 3. THIS V-BOOM WILL MOUNT TO THE FOLLOWING: 1 1/2" TO 5 9/16" ROUND LEG.
- 4. TIEBACK MUST BE CONNECTED TO A RIGID MEMBER THAT PROVIDES ADEQUATE SUPPORT WITHIN THE LIMITS NOTED ABOVE IN THE TIEBACK ANGLE RANGE DETAIL UNLESS APPROVED BY THE ENGINEER OF RECORD.

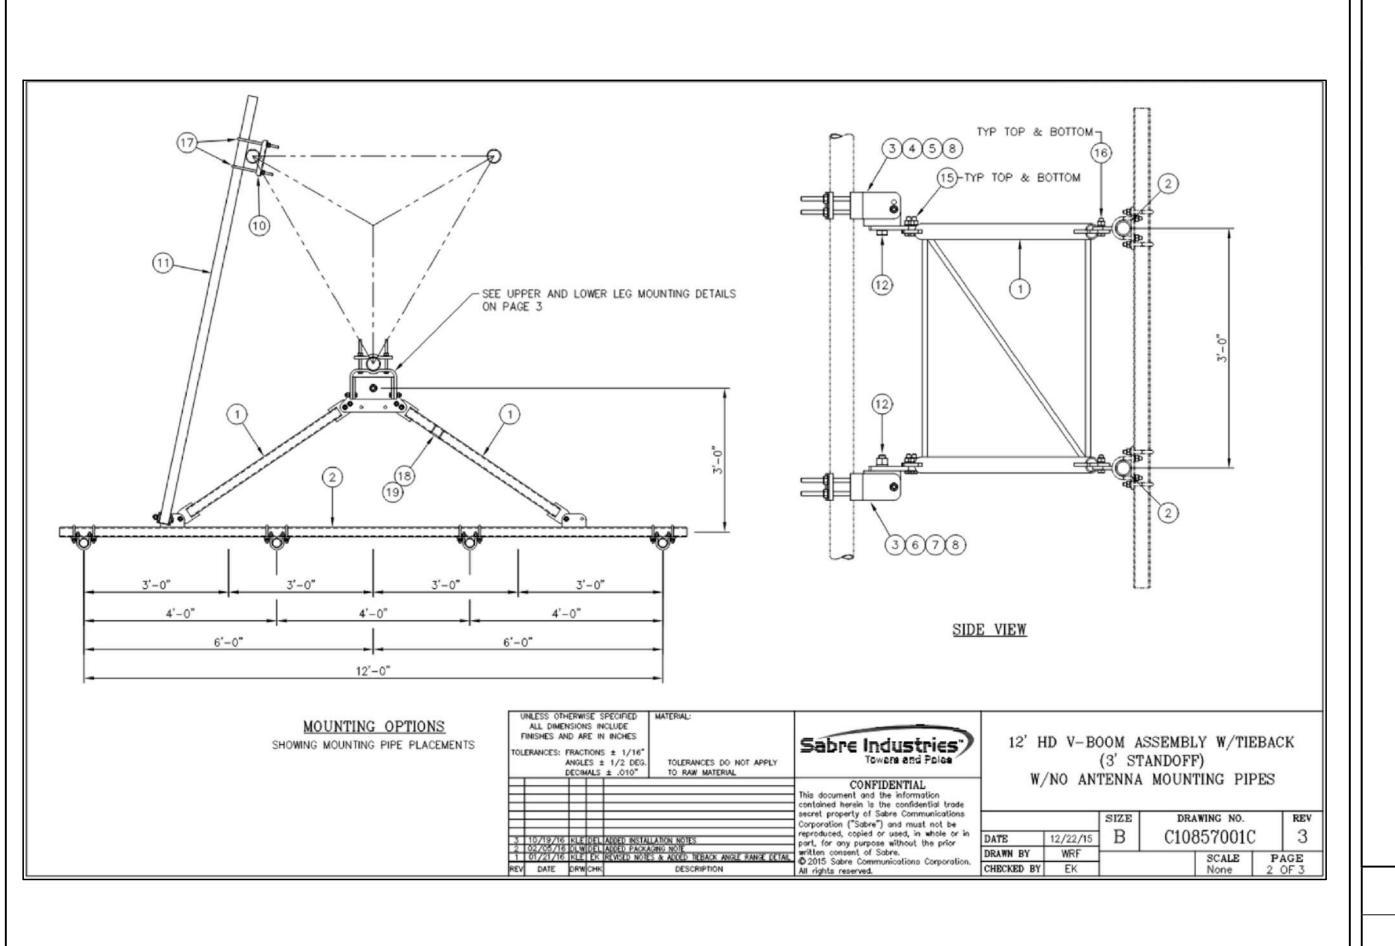

SHEET NUMBER:


340

REVISION:

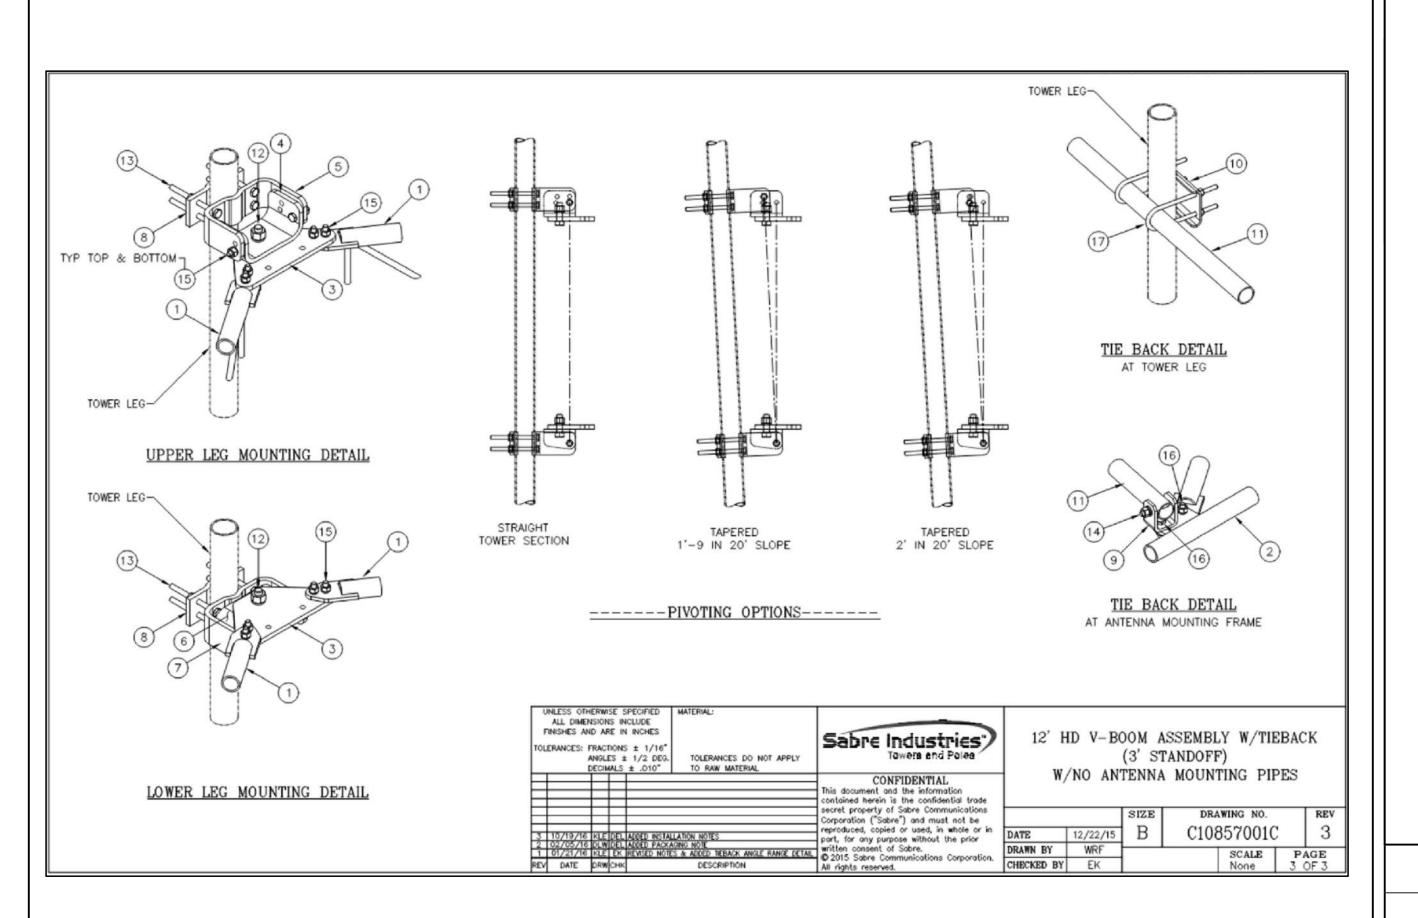


SHEET NUMBER:

REVISION:

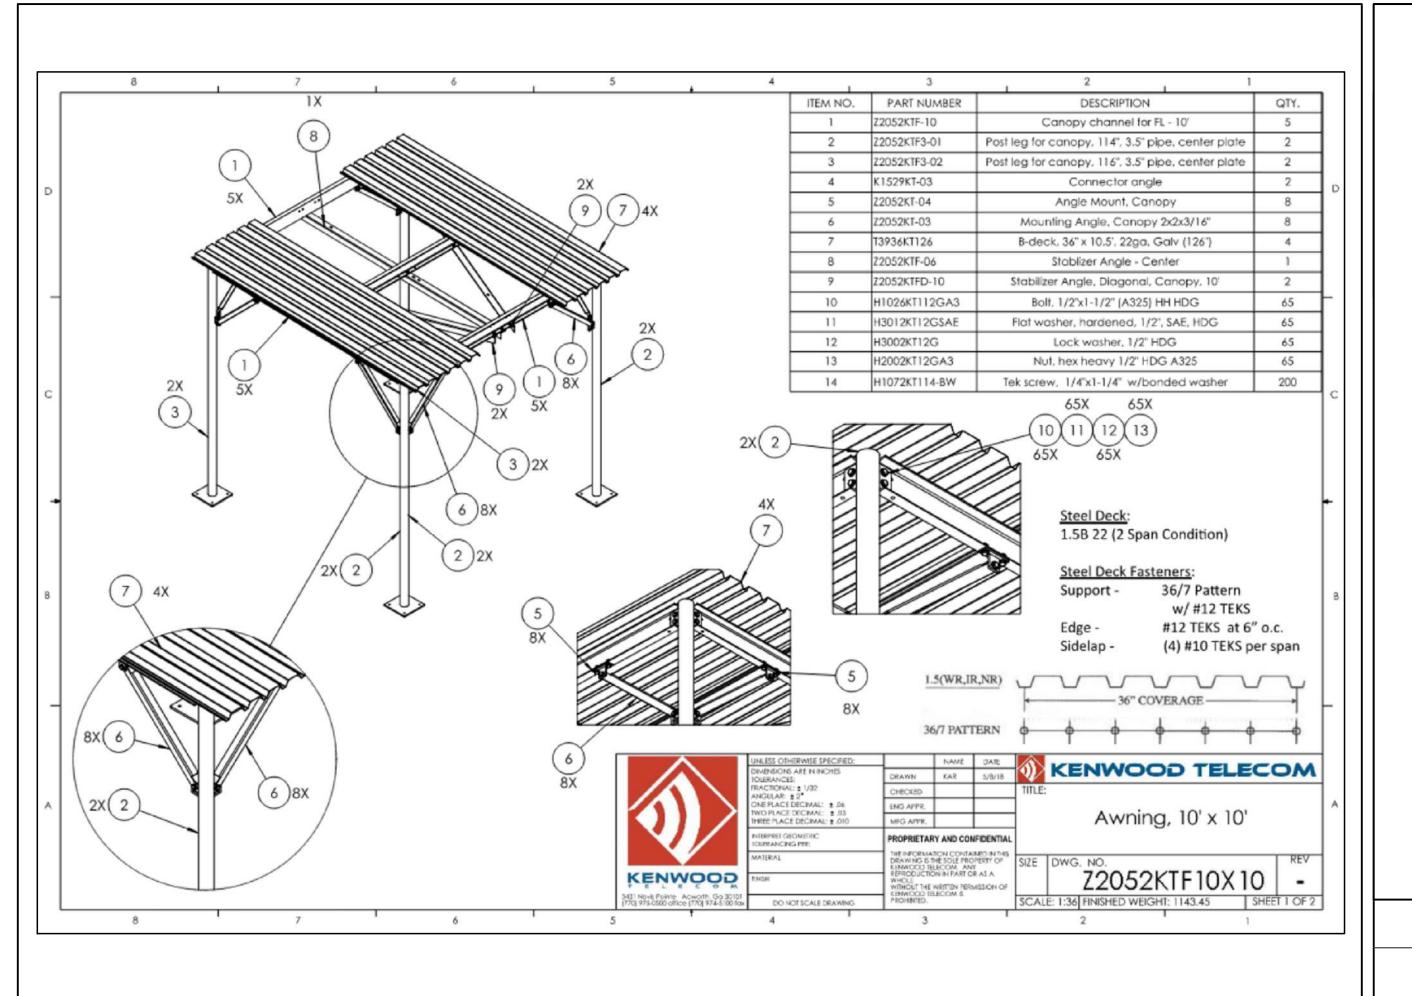

SHEET NUMBER:

REVISION:

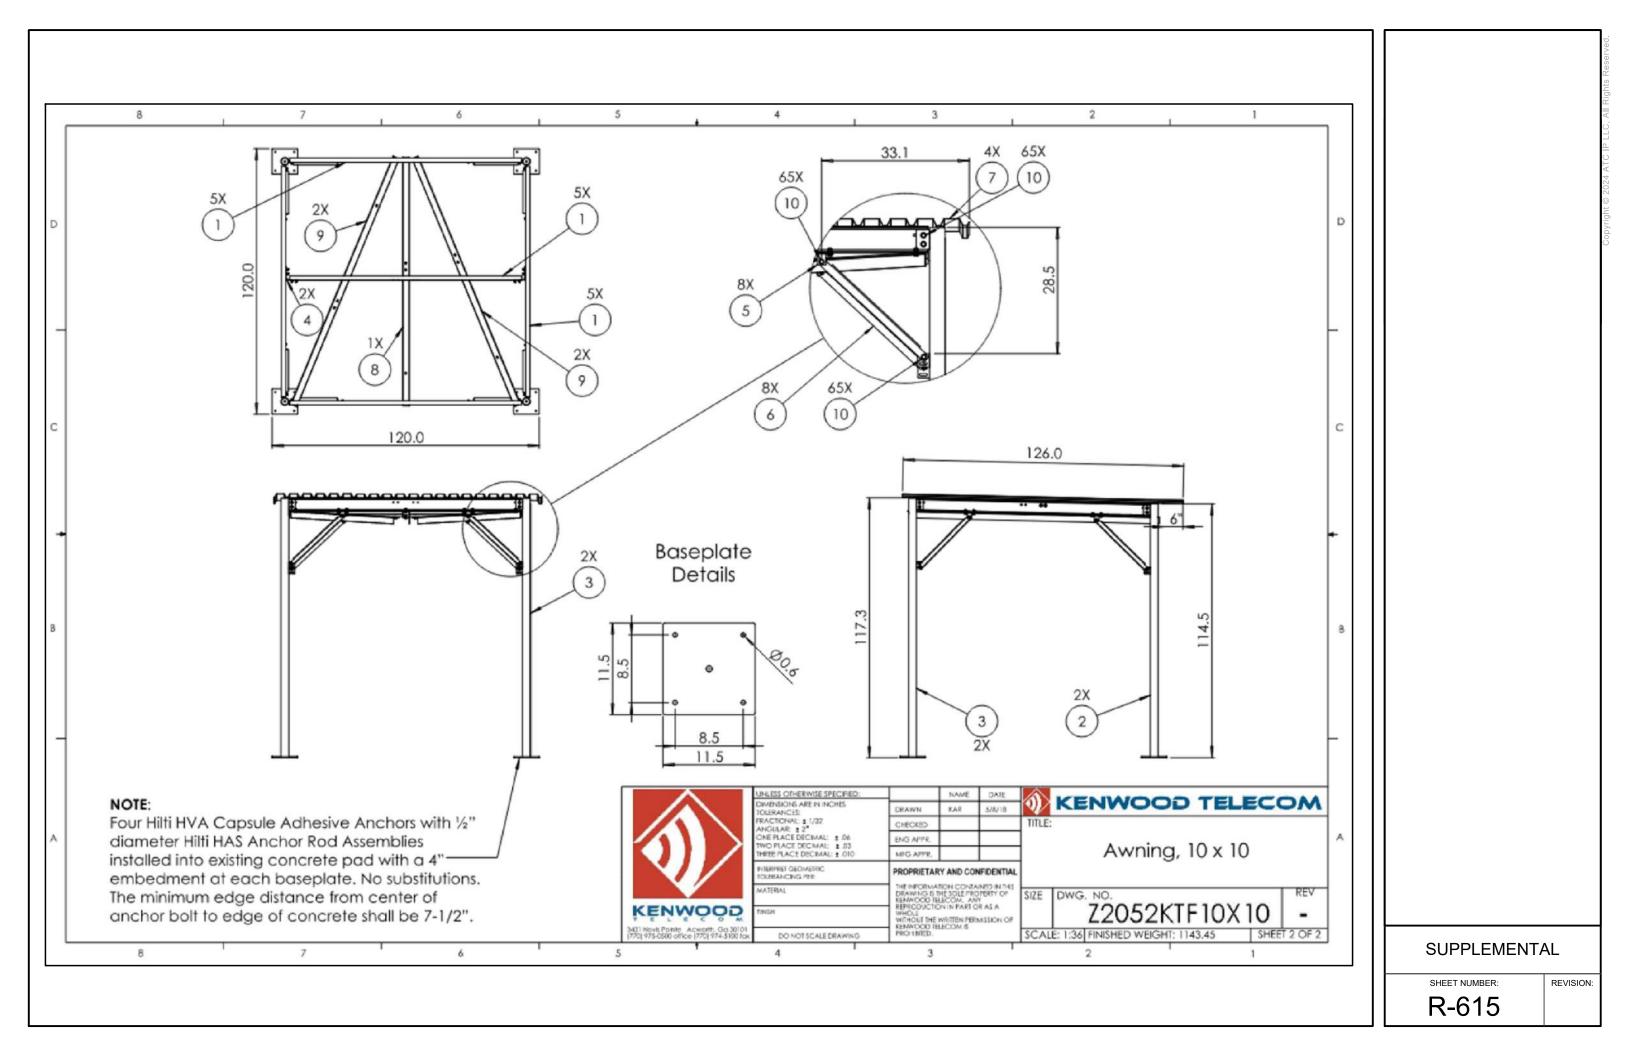



January 30, 2024

Columbia County, Florida

135 NE Hernando Ave # 21, Lake City, FL 32055

RE: Communications Tower Permit #000046554 Amendment Request

To Whom It May Concern:

I, Larry Sweatt, Qualifier for Ericsson, Inc. State of Florida, General Contractors License #CGC1532010 do hereby request an amendment plan review for the Communications Tower Permit #000046554 for the project located at 917 SW CHARLES TER LAKE CITY, FL 32024. The project was on hold by the Tower Owner and is now off hold and ready to begin.

T-Mobile had advised that there wasn't enough room to accommodate their proposed 10x15 pad. So, the approved drawings were revised into the new submitted set dated 01/19/2024.

Sincerely Larry Sweat

Sworn and subscribed before me this _______ day of _____ Feb

who is personally known to me.

JULIE G SWEATT Notary Public - State of South Carolina My Commission Expires 05/26/2032

1765 Sidewinder Drive, Park City, UT, 84060

www.TruNorthe.com