A CUSTOM HOME FOR:

TERRY CANTER

PROJECT ADDRESS:

Lot 6, Canon Creek S/D Columbia County, Florida 32025



SHEET INDEX

- FRONT & REAR ELEVATIONS
- LEFT & RIGHT ELEVATIONS
- IST FLOOR DIMENSIONED PLAN
- 2ND FLOOR DIMENSIONED PLAN
- FOUNDATION PLAN & DETAILS
- ROOF PLAN, DETAILS & NOTES WINDLOAD INFO, NOTES & DETAILS
- FRAMING DETAILS & NOTES

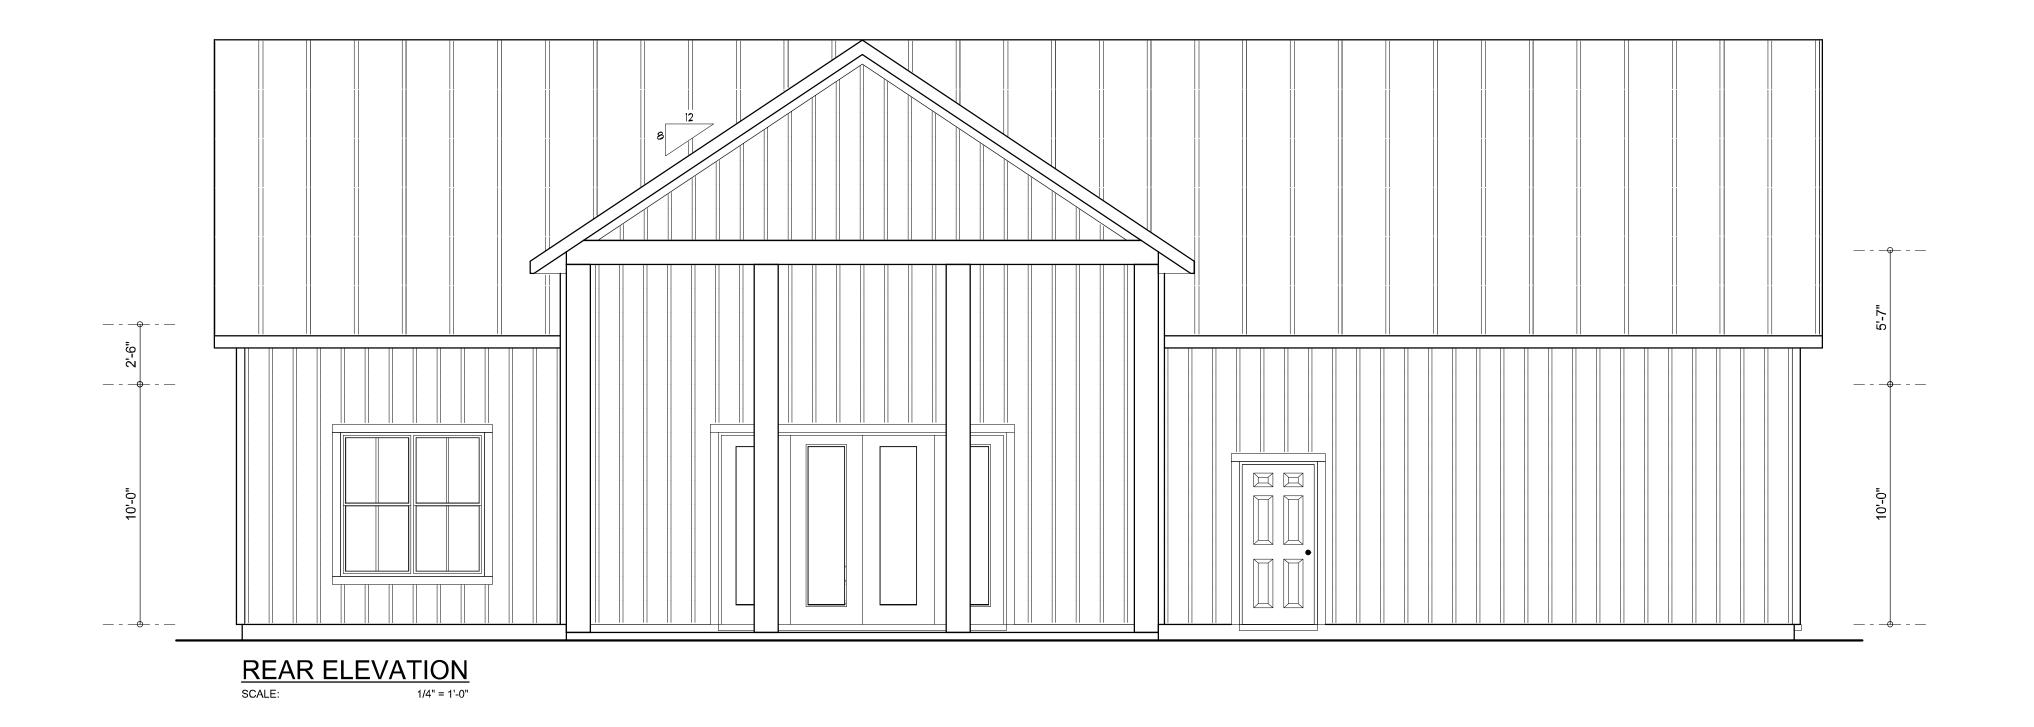
AREA SUM	MARY
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1ST FLOOR LIVING AREA	1,443	S.F.
2ND FLOOR LIVING AREA	1,401	S.F.
TOTAL LIVING AREA	2,844	S.F.

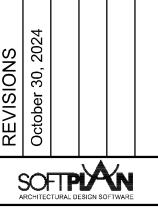
TOTAL AREA	4,093	S.F.
ENTRY PORCH AREA	197	S.F.
COVERED PORCH AREA	247	S.F.
GARAGE AREA	805	S.F.

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REAR ELEVATIONS FRONT SCALE:

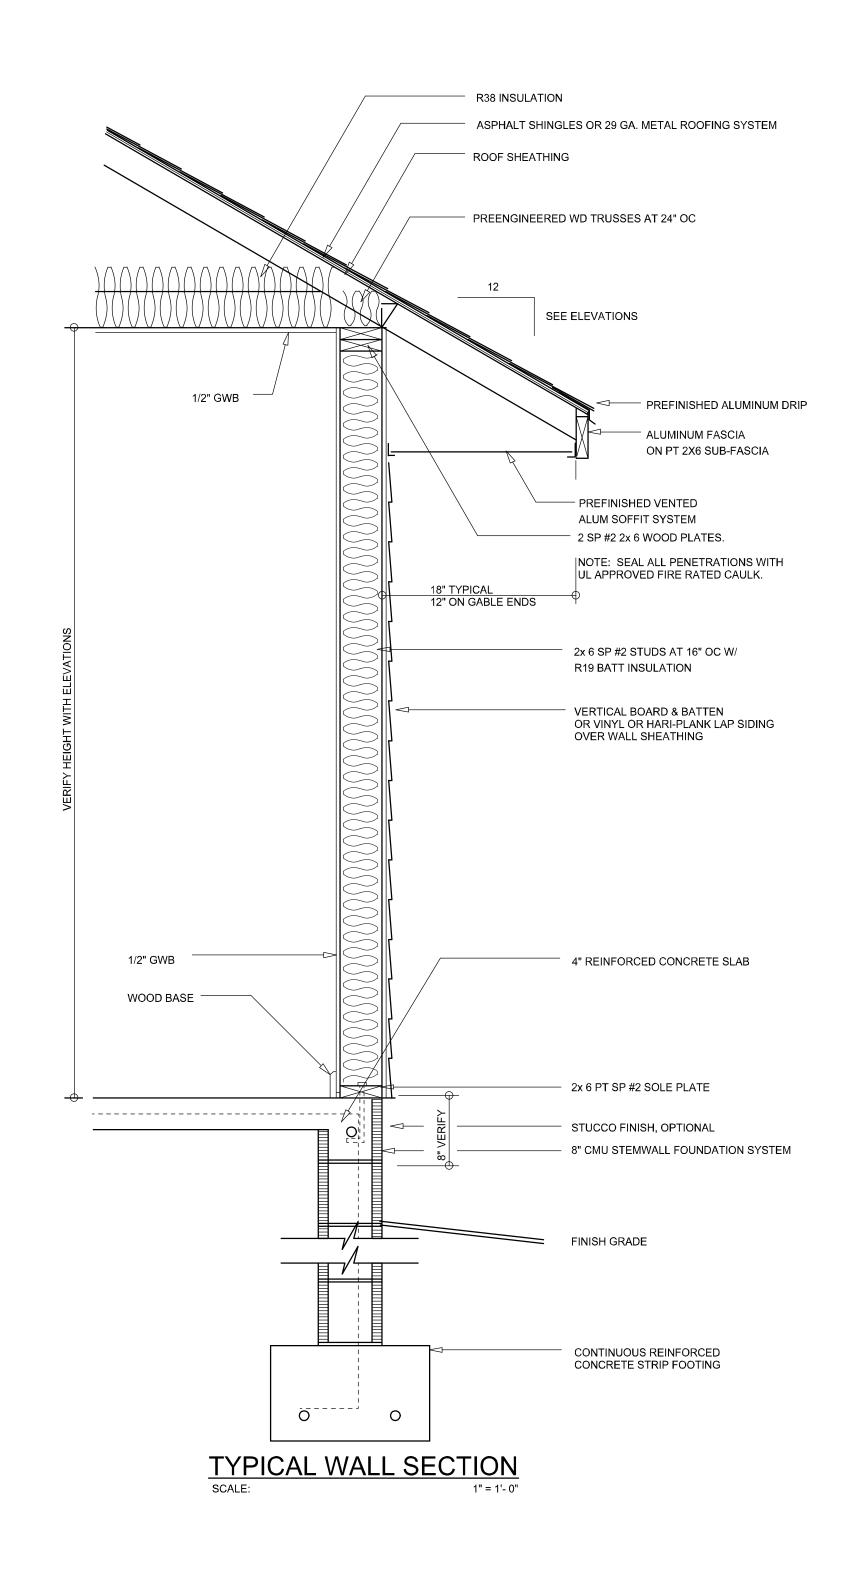
A CUSTOM HOME D

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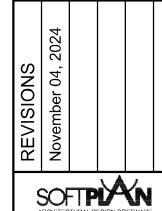
JOB NUMBER 20240701

SHEET NUMBER **A.1**









ELEVATIONS RIGHT TYPICAL ∞ర

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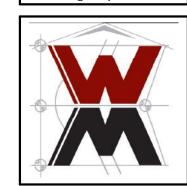
MENSIONED 1ST FLOOR PLAN

CUSTOM HOME DESIGN FOR:

ERRY CANTER

OJECT ADDRESS: Lot 6, Canon Creek S/D, Columbia County, Florida 32025

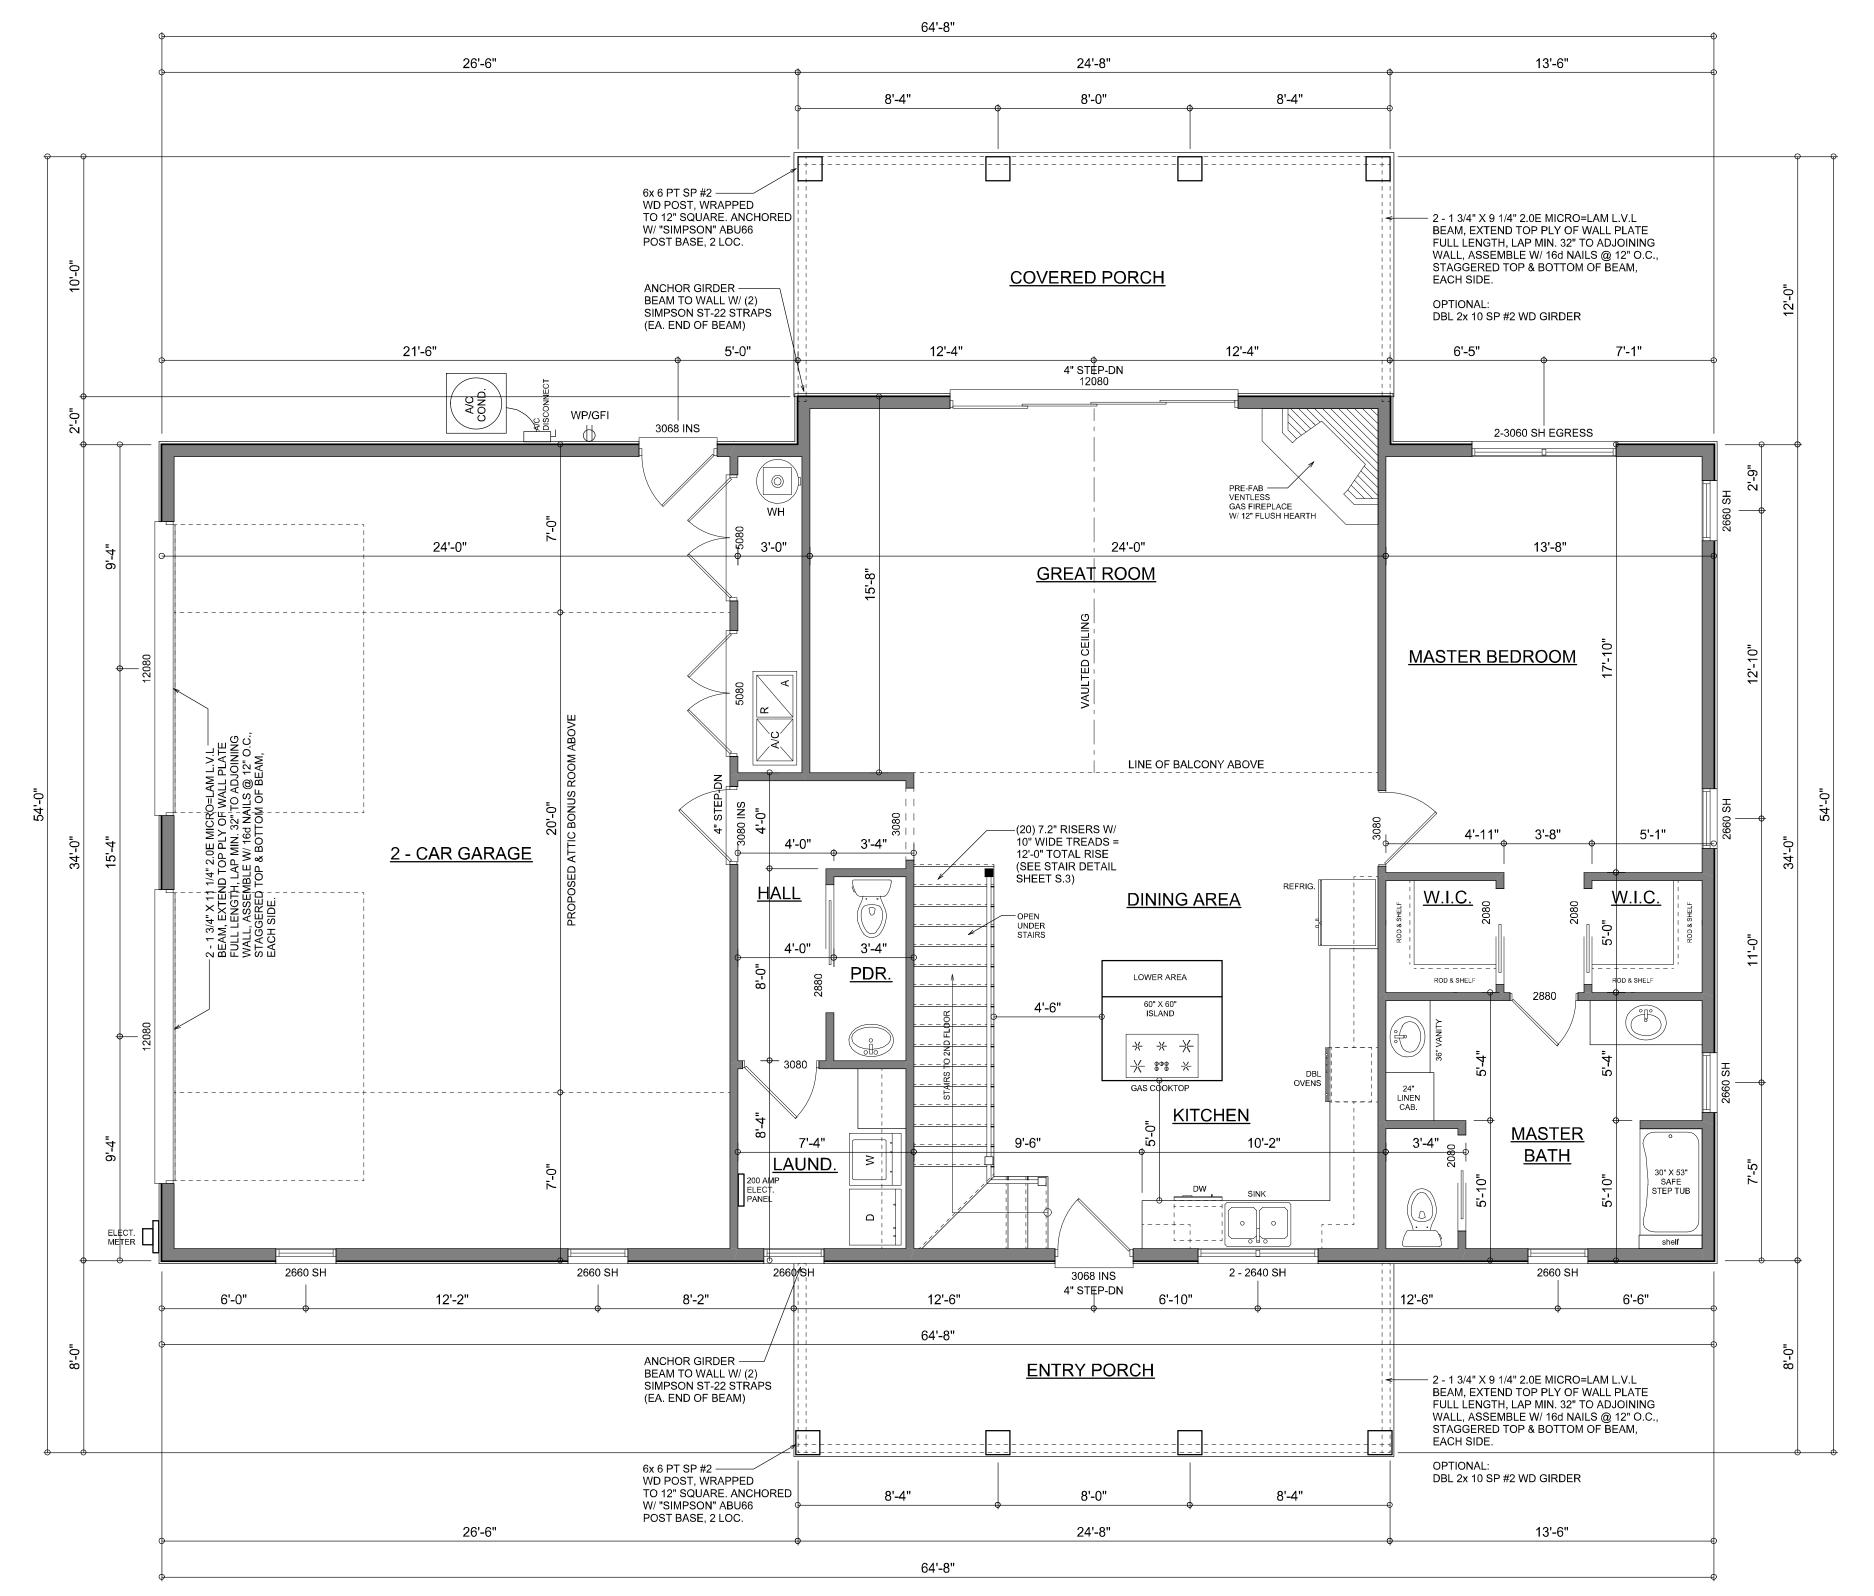
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JOB NUMBER 20240701

SHEET NUMBER

A.3



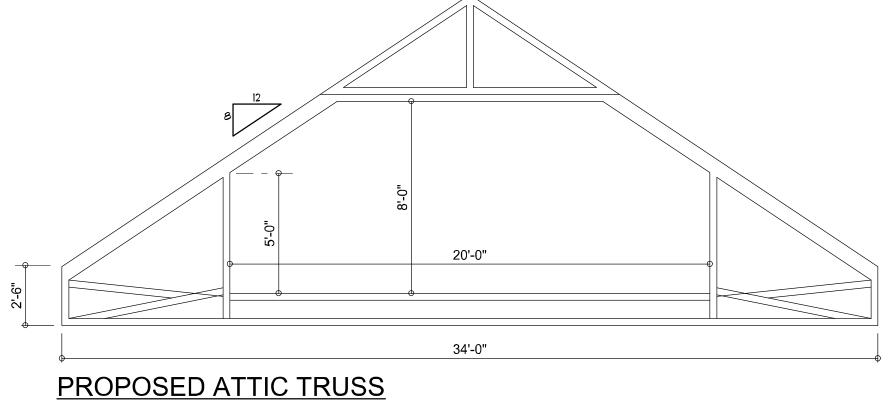
DIMENSIONED 1ST FLOOR PLAN SCALE: 1/4" = 1'-0"

NOTE: ALL WALLS SHALL BE 10'-0" UNLESS OTHERWISE NOTED.

Garage fire separations shall comply with the following:

1. The private garage shall be separated from the dwelling unit and its attic area by means of a minimum ½-inch (12.7 mm) gypsum board applied to the garage side. Garages beneath habitable rooms shall be separated from all habitable rooms above by not less than 5/8-inch Type X gypsum board or equivalent. Door openings between a private garage and the dwelling unit shall be equipped with either solid wood doors, or solid or honeycomb core steel doors not less than 13/8 inches (34.9 mm) thick, or doors in compliance with Section 715.3.3. Openings from a private garage directly into a room used for sleeping purposes shall not be permitted.

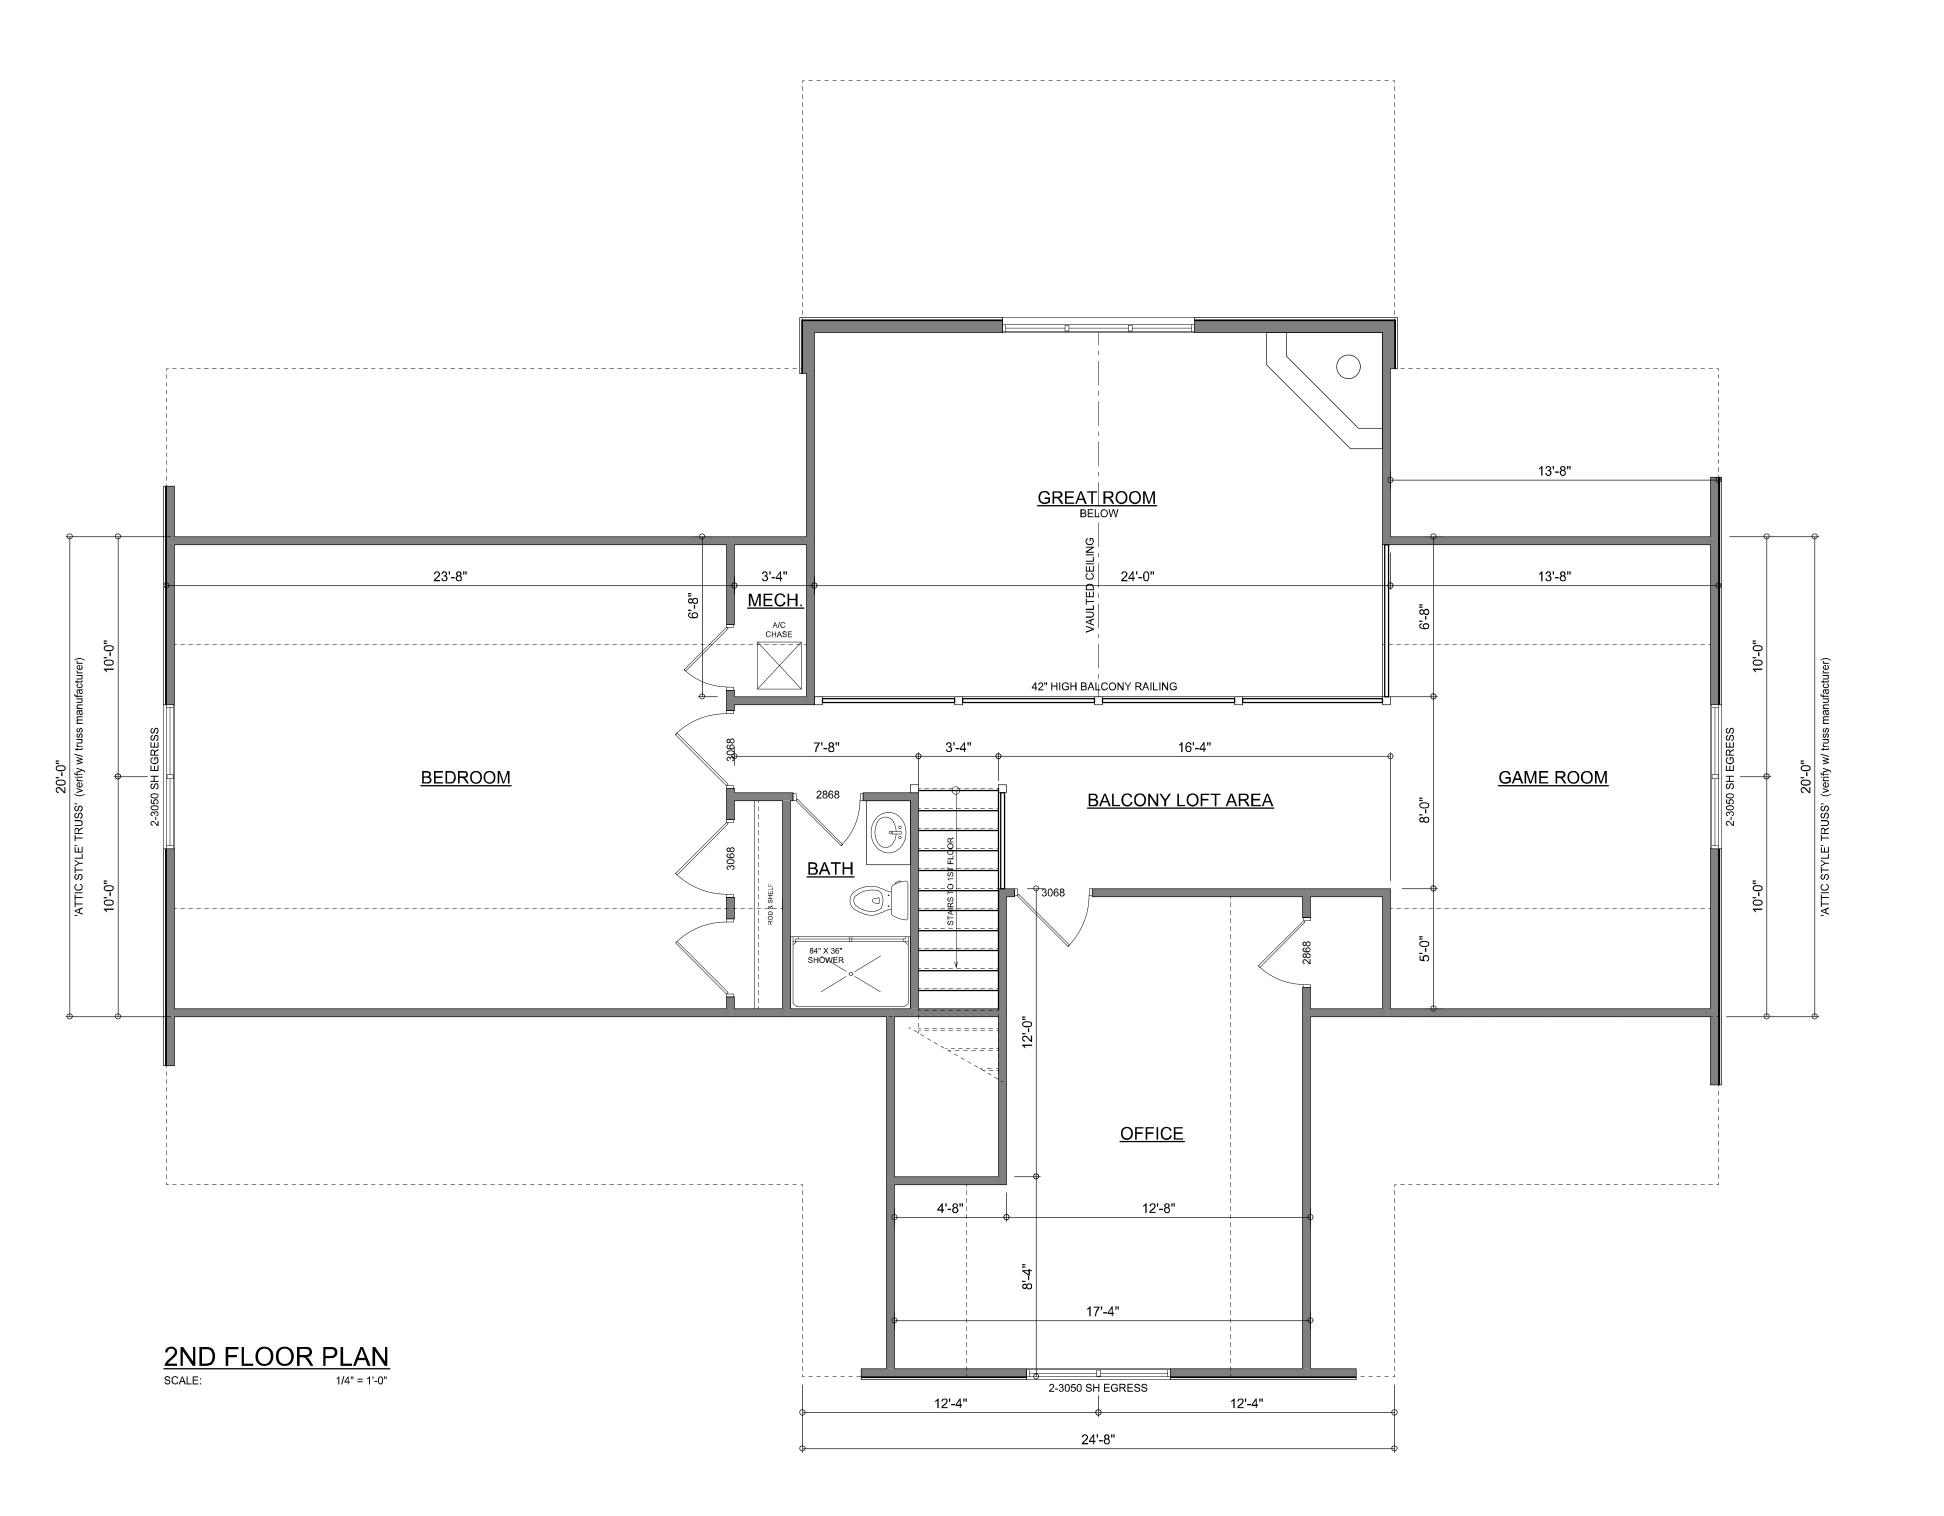
- 2. Ducts in a private garage and ducts penetrating the walls or ceilings separating the dwelling unit from the garage shall be constructed of a minimum 0.019-inch (0.48 mm) sheet steel and shall have no openings into the garage.
- 3. A separation is not required between a Group R-3 and U carport provided the carport is entirely open on two or more sides and there are not enclosed areas above.
- When installing an attic access and/or pull-down stair unit in the garage, devise shall have a minimum 20 min. fire rating.

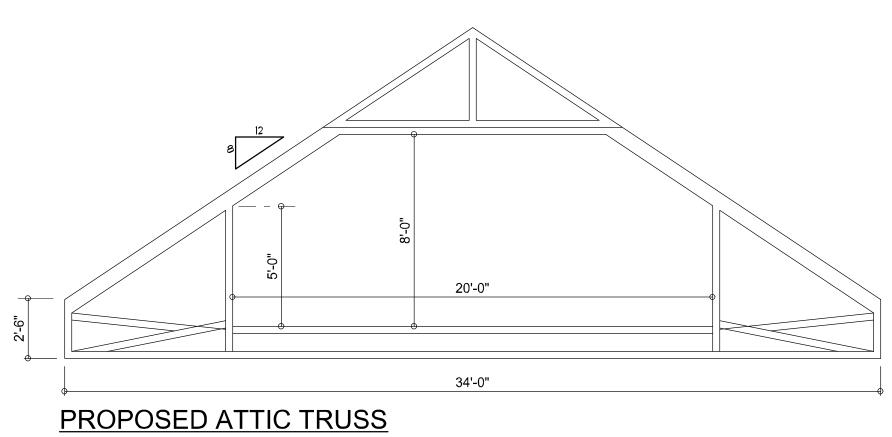


SCALE: 1/4" = 1'-0" NOTE: SIZE AND CONFIGURATION OF 'ATTIC TRUSS' SHALL BE DETERMINED BY THE TRUSS ENGINEER / MANUF.

AREA SUMMARY

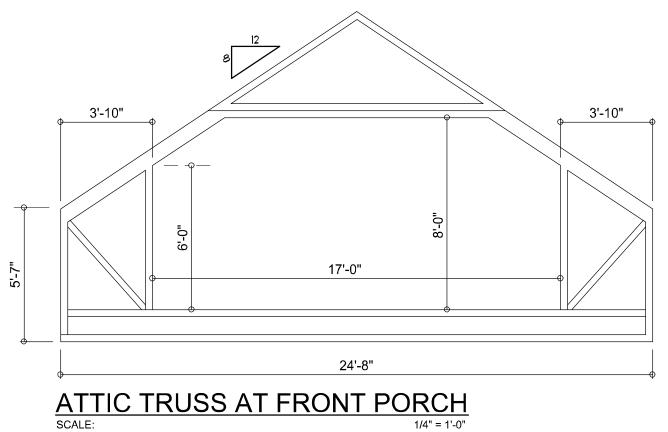
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ENTRY PORCH AREA	197	S.F.
TOTAL AREA	4.093	S.F





PROPOSED ATTIC TRUSS
SCALE: 1/4" = 1'-0"

NOTE: SIZE AND CONFIGURATION OF 'ATTIC TRUSS' SHALL BE DETERMIINED BY THE TRUSS ENGINEER / MANUF.



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A CUSTOM HOME D

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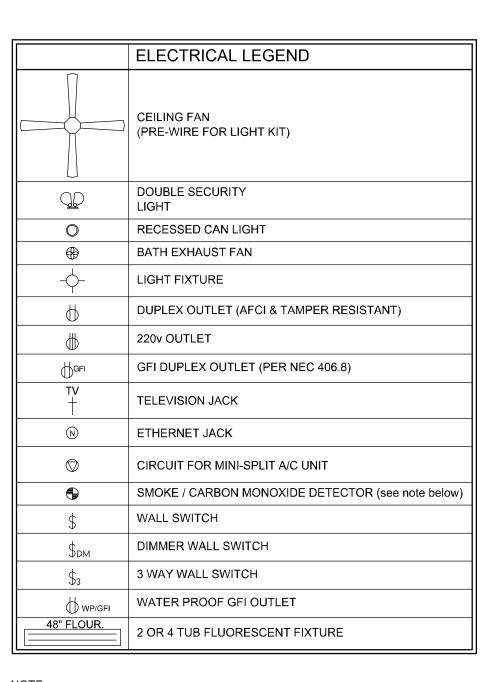
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PRELIMINARY SCALE:



JOB NUMBER 20240701

SHEET NUMBER **A.4**



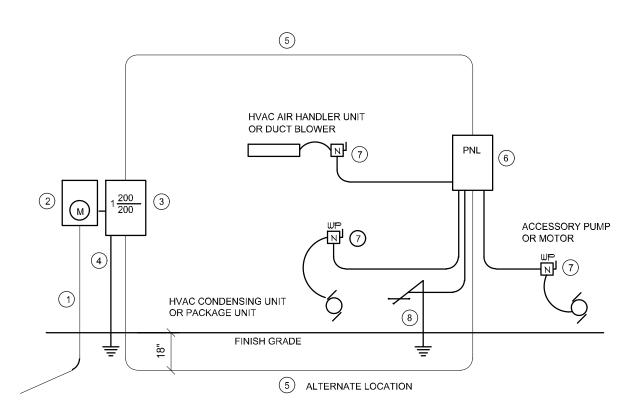
NOTE:
ALL INTERIOR RECEPTACLES SHALL BE AFCI
(ARC FAULT CIRCUIT INTERRUPT) PER NEC 210.12 & TAMPER RESISTANT PER

ALL INTERIOR & EXTERIOR LIGHTING SHALL MEET OR EXCEED THE MIN. 75% HIGH-EFFICIENCY LIGHTING PER FBC-ENERGY CONSERVATION R404.

ALL SMOKE DETECTORS BE A COMBO SMOKE & CARBON MONOXIDE DETECTOR AND SHALL HAVE BATTERY BACKUP POWER AND ALL WIRED TOGETHER SO IF ANY ONE UNIT IS ACTUATED THEY ALL ACTIVATE.

THE ELECTRICAL SERVICE OVERCURRENT PROTECTION DEVICE SHALL BE INSTALLED ON THE EXTERIOR OF STRUCTURES TO SERVE AS A DISCONNECT MEANS. CONDUCTORS USED FROM THE EXTERIOR DISCONNECTING MEANS TO A PANEL OR SUB PANEL SHALL HAVE FOUR-WIRE CONDUCTORS, OF WHICH ONE CONDUCTOR SHALL BE USED AS AN EQUIPMENT GROUND.

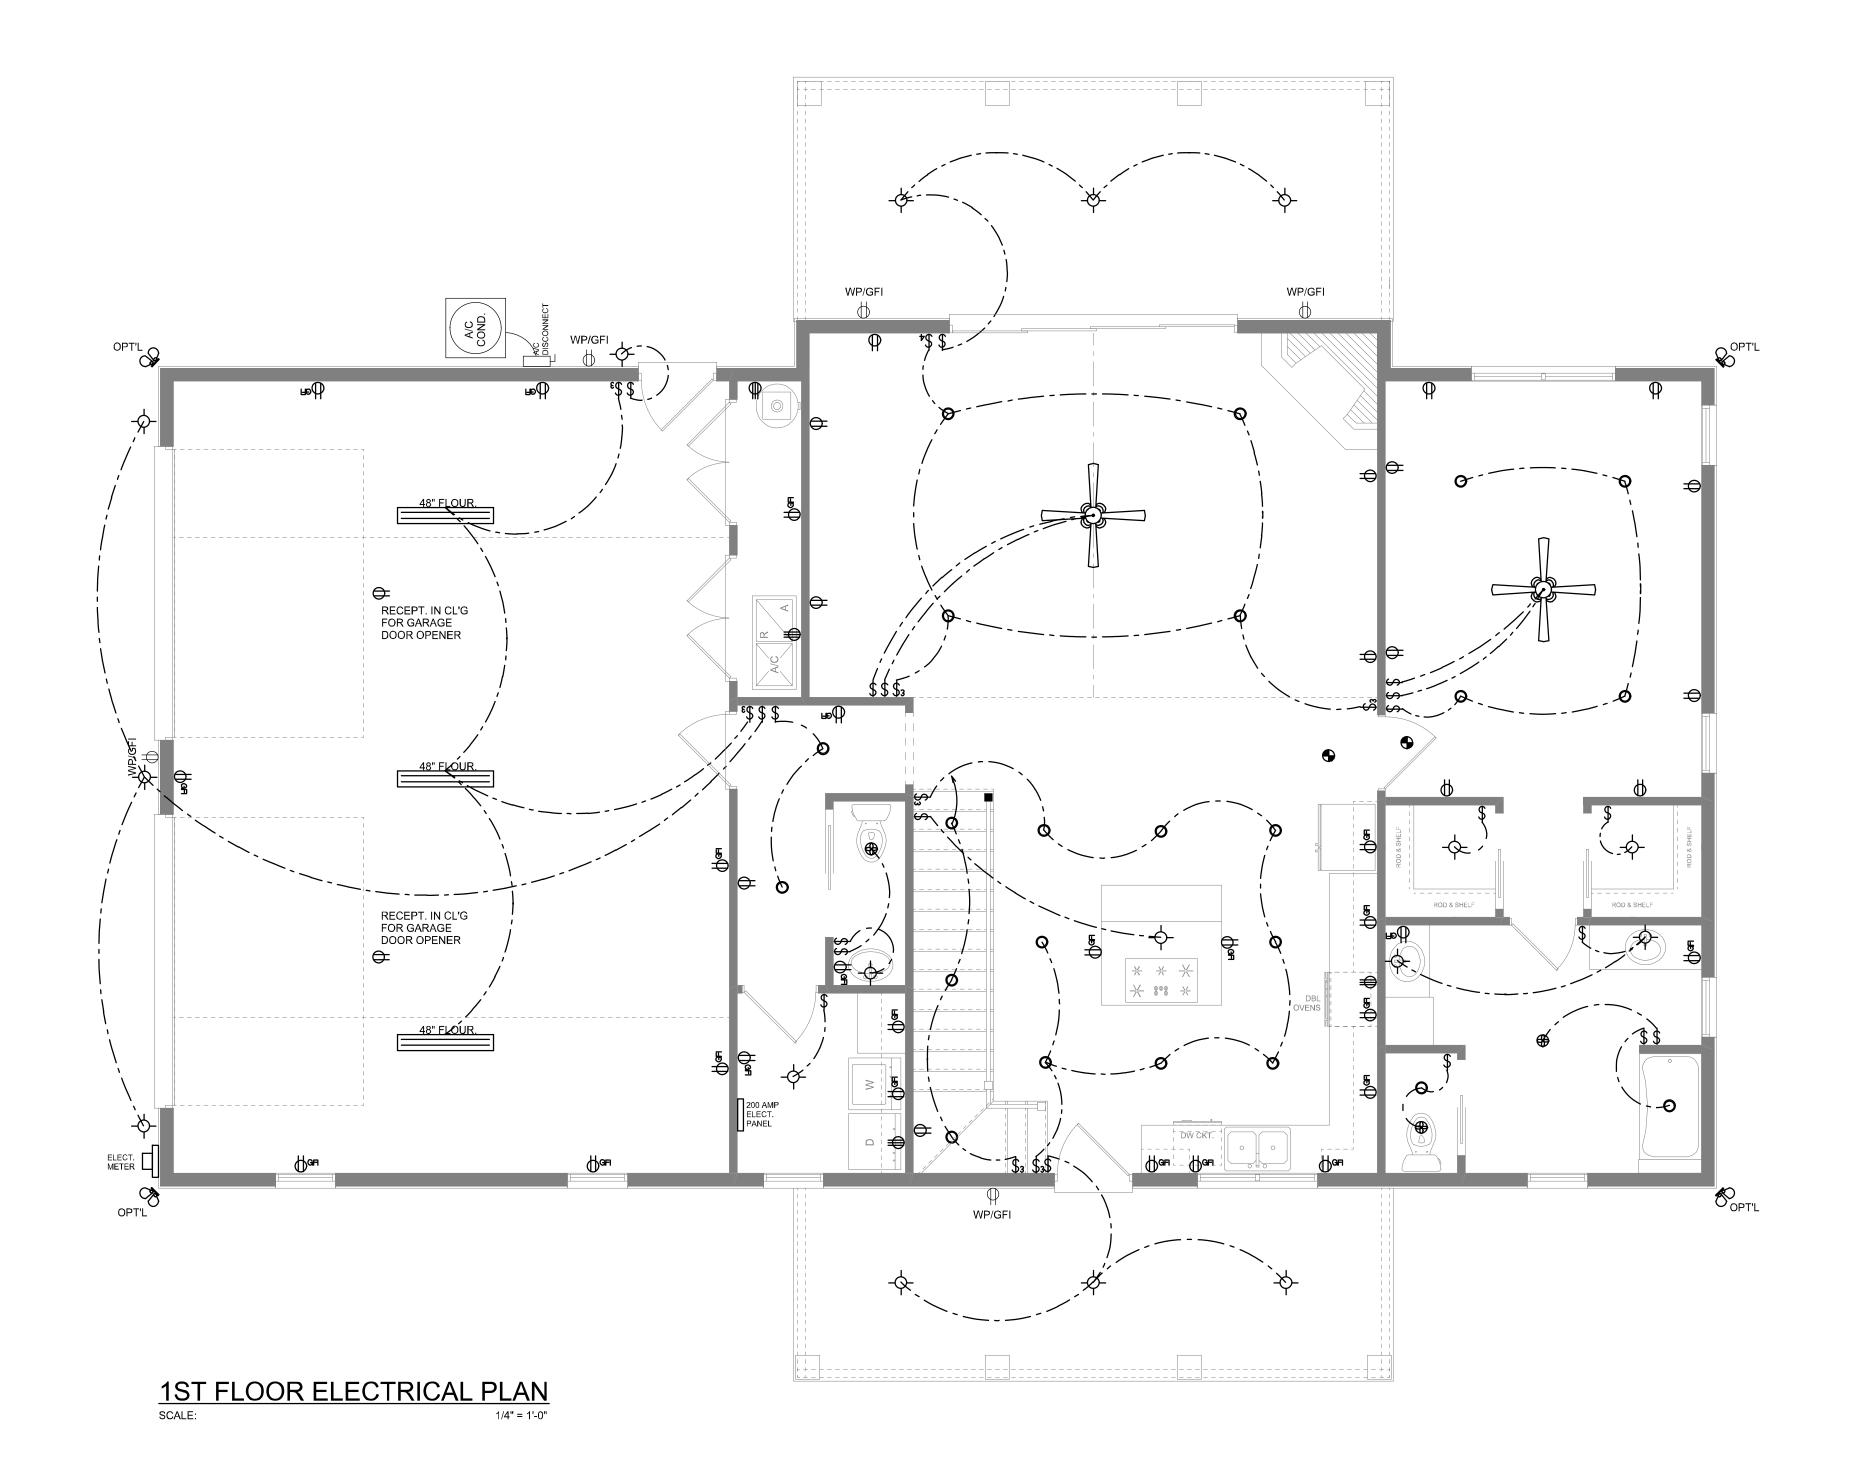
IT IS THE LICENSED ELECTRICAL CONTRACTORS RESPONSIBILITY TO INSURE THAT ALL WORK PERFORMED AND EQUIPMENT INSTALLED MEETS OR EXCEEDS THE 2020 (NFPA-70) NATIONAL ELECTRIC CODE AND ALL OTHER LOCAL CODES AND ORDINANCES.



- Service/Feeder Entrance Conductors: 2" rigid conduit, min.
 18" deep, w/ continuous Ground Bonding Conductor, Service/
 Entrance Conductors shall not be spliced except that bolted connections at the Meter, Disconnecting Devices and Panel
- 2 Meter Enclosure, weatherproof, U.L. Listed.
- 3 Main Disconnect Switch: fused or Main BRKR, weatherproof, U.L. Listed.
- 4 Service entrance Ground: }" ~ iron/steel rod x 8'-0" long and/or concrete encased foundation steel rebar x 20'-0" long. Grounding Conductor shall be bonded to each piece of Service/ Entrance Equipment, and shall be sized per Item #5, below.
- 5 200 AMPERE SERVICE: 3-#2/0-USE-Cu, 1-#4-Cu-GND, 2" Conduit.
- 6 House Panel (PNL), U.L. Lised, sized per schedule.
- 7 Equipment Disconnect Switch: non-fused, in weatherproof enclosure, size according to Panel Schedule loads.
- 8 Provide Ground Bond Wire to metal piping, size in accordance with the Service Ground Conductor.

THE MINIMUM AIC RATING FOR PANEL BOARDS, BRKRS AND DISCONNECT SWITCHES SHALL BE 22,000 AIC.

ELECTRICAL RISER DIAGRAM: 200A SCALE: NONE



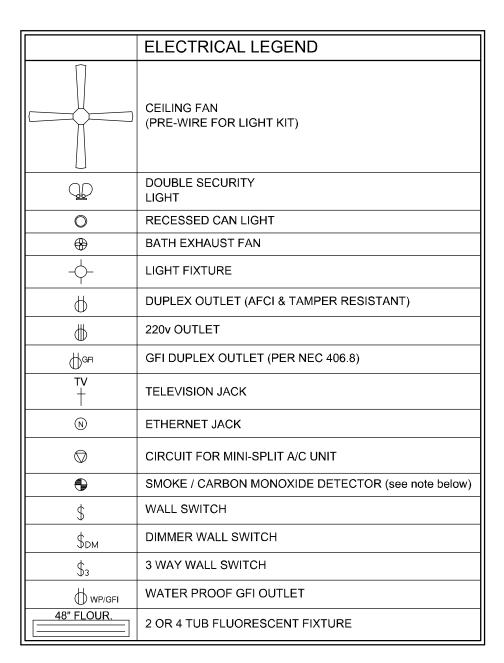
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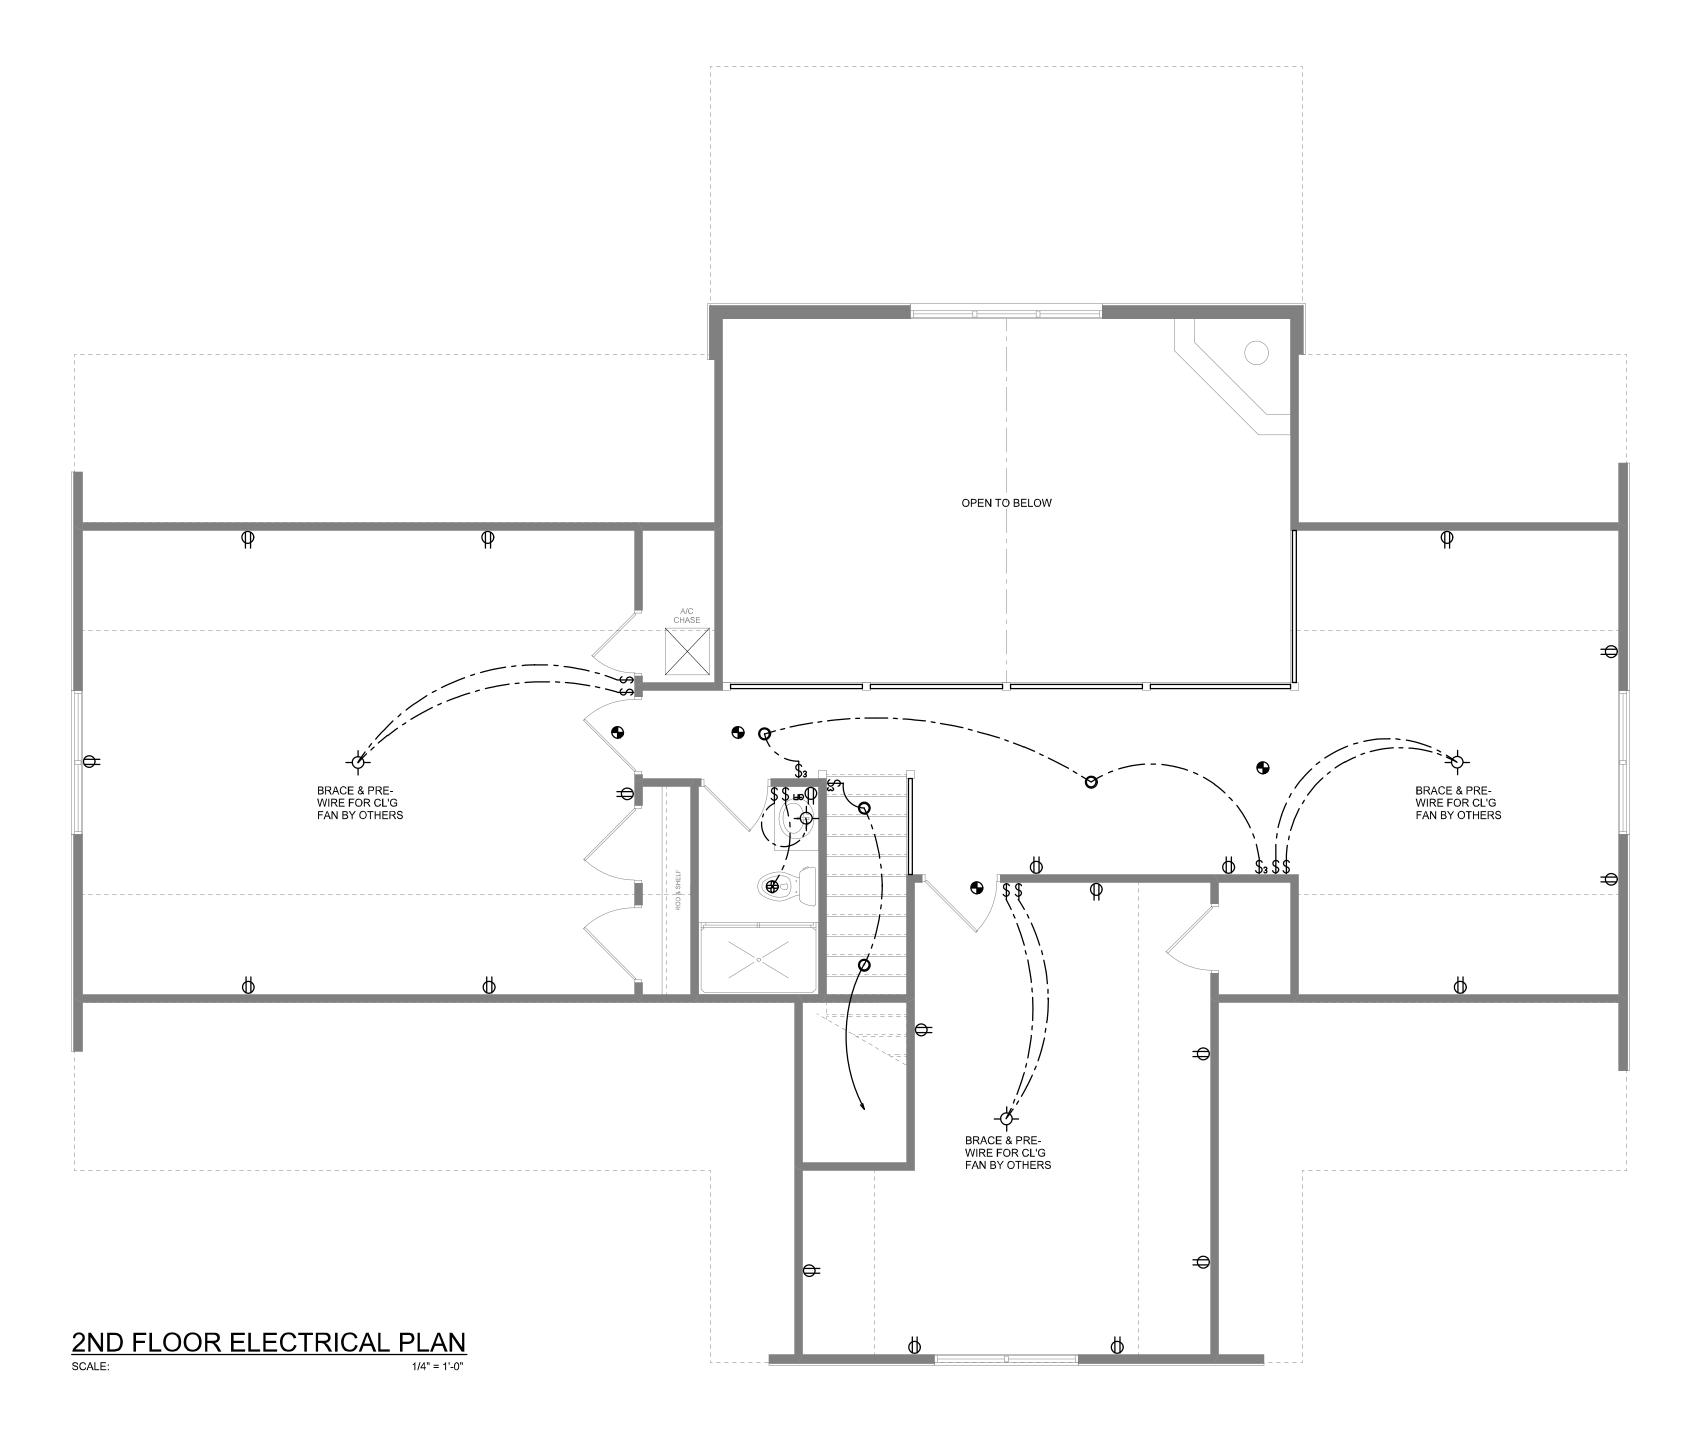
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