




MONOLITHIC FOOTING SCALE: 1/2" = 1'-0"

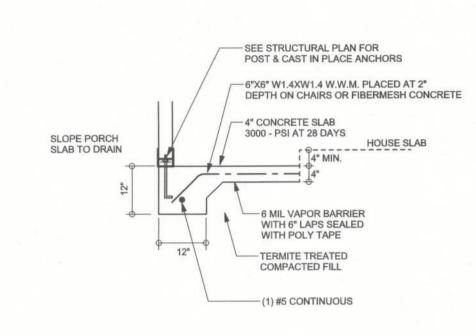


PORCH FOOTING

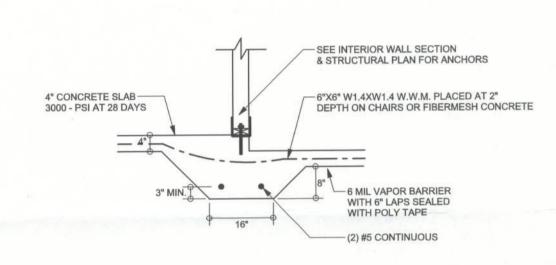


INTERIOR BEARING STEP FOOTING SCALE: 1/2" = 1'-0"

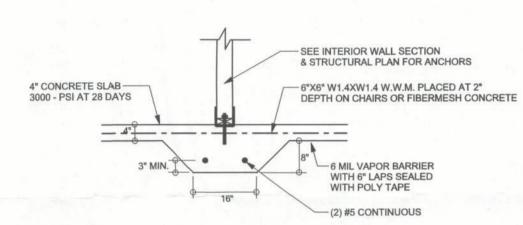

INTERIOR BEARING FOOTING SCALE: 1/2" = 1'-0"

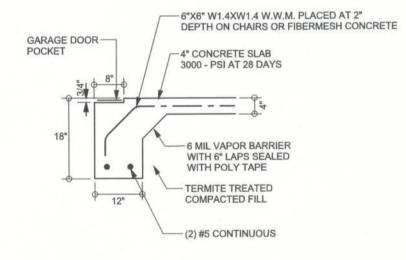


F4 GARAGE DOOR FOOTING S-2 SCALE: 1/2" = 1'-0"

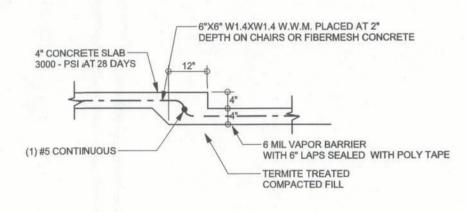

F6 TYPICAL NON - BEARING STEP FOOTING SCALE: 1/2" = 1'-0"

SCALE: 1/4" = 1'-0"

DIMENSIONS ON STRUCTURAL SHEETS ARE NOT EXACT. REFER TO ARCHITECTURAL FLOOR PLAN FOR ACTUAL DIMENSIONS

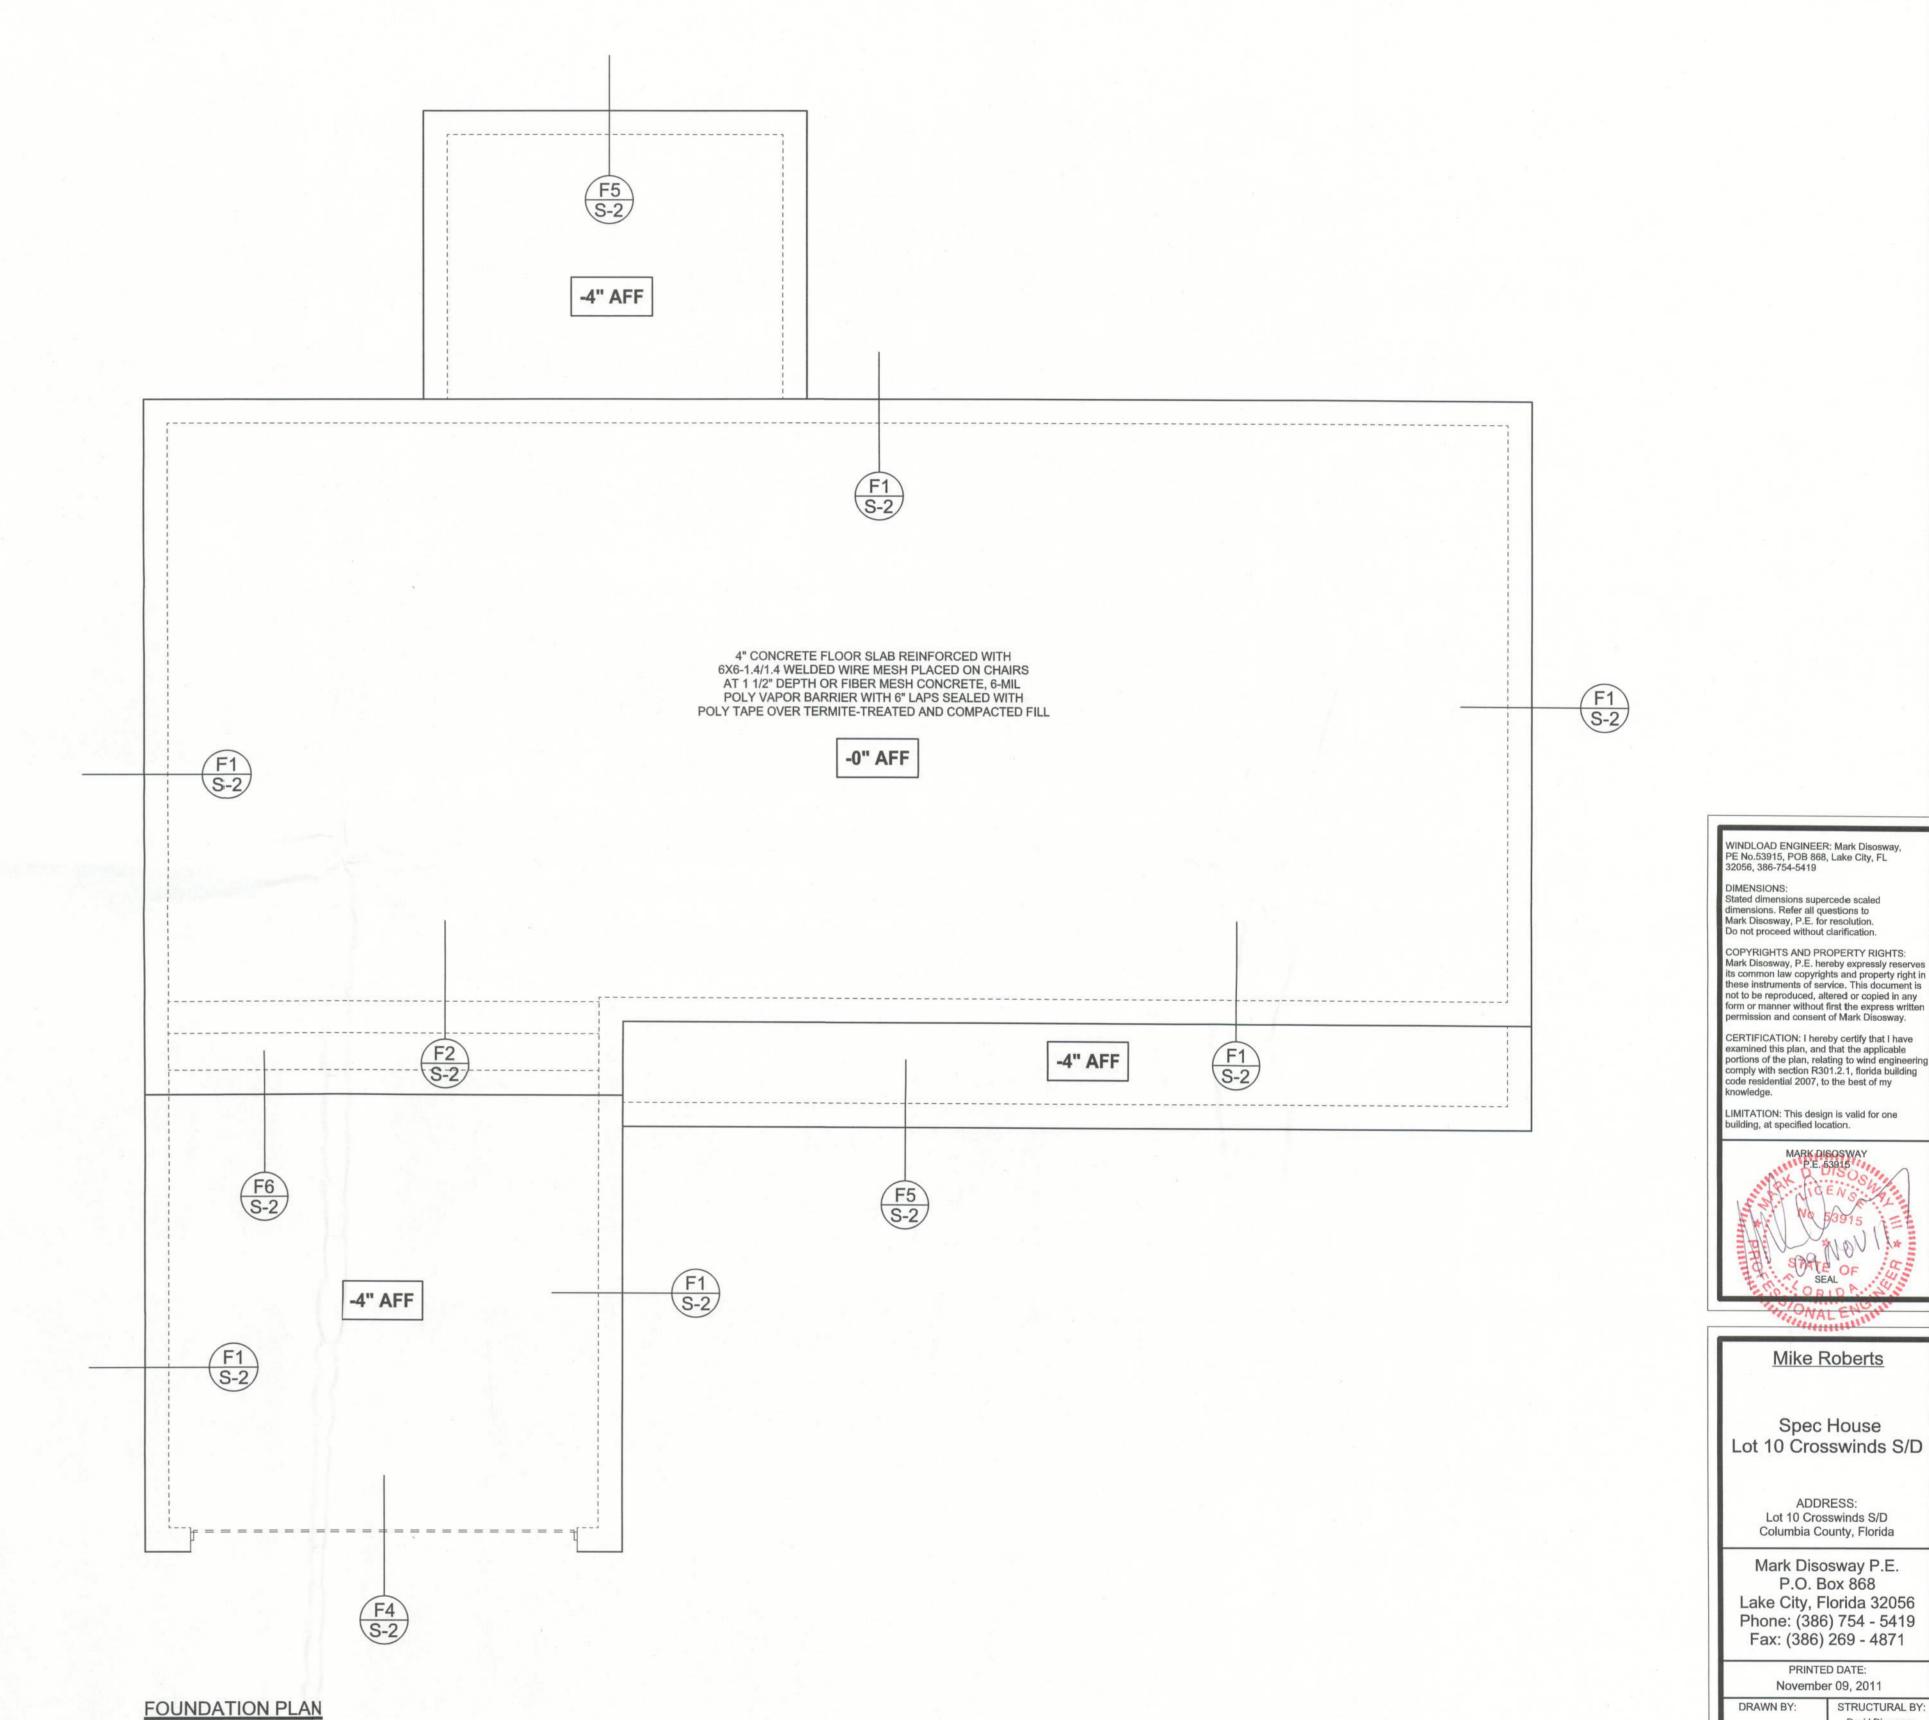

WINDLOAD ENGINEER: Mark Disosway, PE No.53915, POB 868, Lake City, FL 32056, 386-754-5419

COPYRIGHTS AND PROPERTY RIGHTS:

CERTIFICATION: I hereby certify that I have examined this plan, and that the applicable

portions of the plan, relating to wind engineerin comply with section R301.2.1, florida building code residential 2007, to the best of my

LIMITATION: This design is valid for one building, at specified location.

DIMENSIONS:

Mike Roberts

Spec House Lot 10 Crosswinds S/D

ADDRESS: Lot 10 Crosswinds S/D Columbia County, Florida

Mark Disosway P.E. P.O. Box 868 Lake City, Florida 32056 Phone: (386) 754 - 5419 Fax: (386) 269 - 4871

PRINTED DATE:

November 09, 2011 STRUCTURAL BY: DRAWN BY: David Disosway

FINALS DATE: 9Nov11

JOB NUMBER: 1111017 DRAWING NUMBER

> **S-2** OF 3 SHEETS