

REVISIONS

SOFTPIAN ARCHITECTURAL DESIGN SOFTWARE

WINDIOAD ENGINEER: Mark Disosway, PE No53915, POB 868, Lake City, FL 32056386-754-5419

tated/imensions supercede scaled


dimenions. Refer all questions to
Mark Isosway, P.E. for resolution.
Do notproceed without clarification.

COPYLIGHTS AND PROPERTY RIGHTS:
Mark Isosway, P.E. hereby expressly reserves its cormon law copyrights and property right in these istruments of service. This document is not to le reproduced, altered or copied in any form ormanner without first the express written permission and consent of Mark Discosway.

permision and consent of Mark Disosway.

CERTFICATION: I hereby certify that I have examired this plan, and that the applicable portion of the plan, relating to wind engineeric complywith section R301.2.1, florida building code reidential 2004, to the best of my

LIMITATION: This design is valid for one buildin, at specified location.

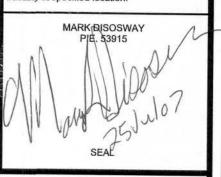

kaac Construction

Nancy Ferguson Residence

> ADDRESS: 152 SW Chris Terrace Lake City, FL 32024

Mark Disosway P.E. P.O. Box 868 Late City, Florida 32056 Phone: (386) 754 - 5419 Fax: (386) 269 - 4871


> PRINTED DATE: July 25, 2007


DRAWN BY: CHECKED BY:
Davi Disosway


FINAS DATE: 18 /Jul / 07


JOB NUMBER: 707172 DRAWING NUMBER


S-2
OF 3 SHEETS

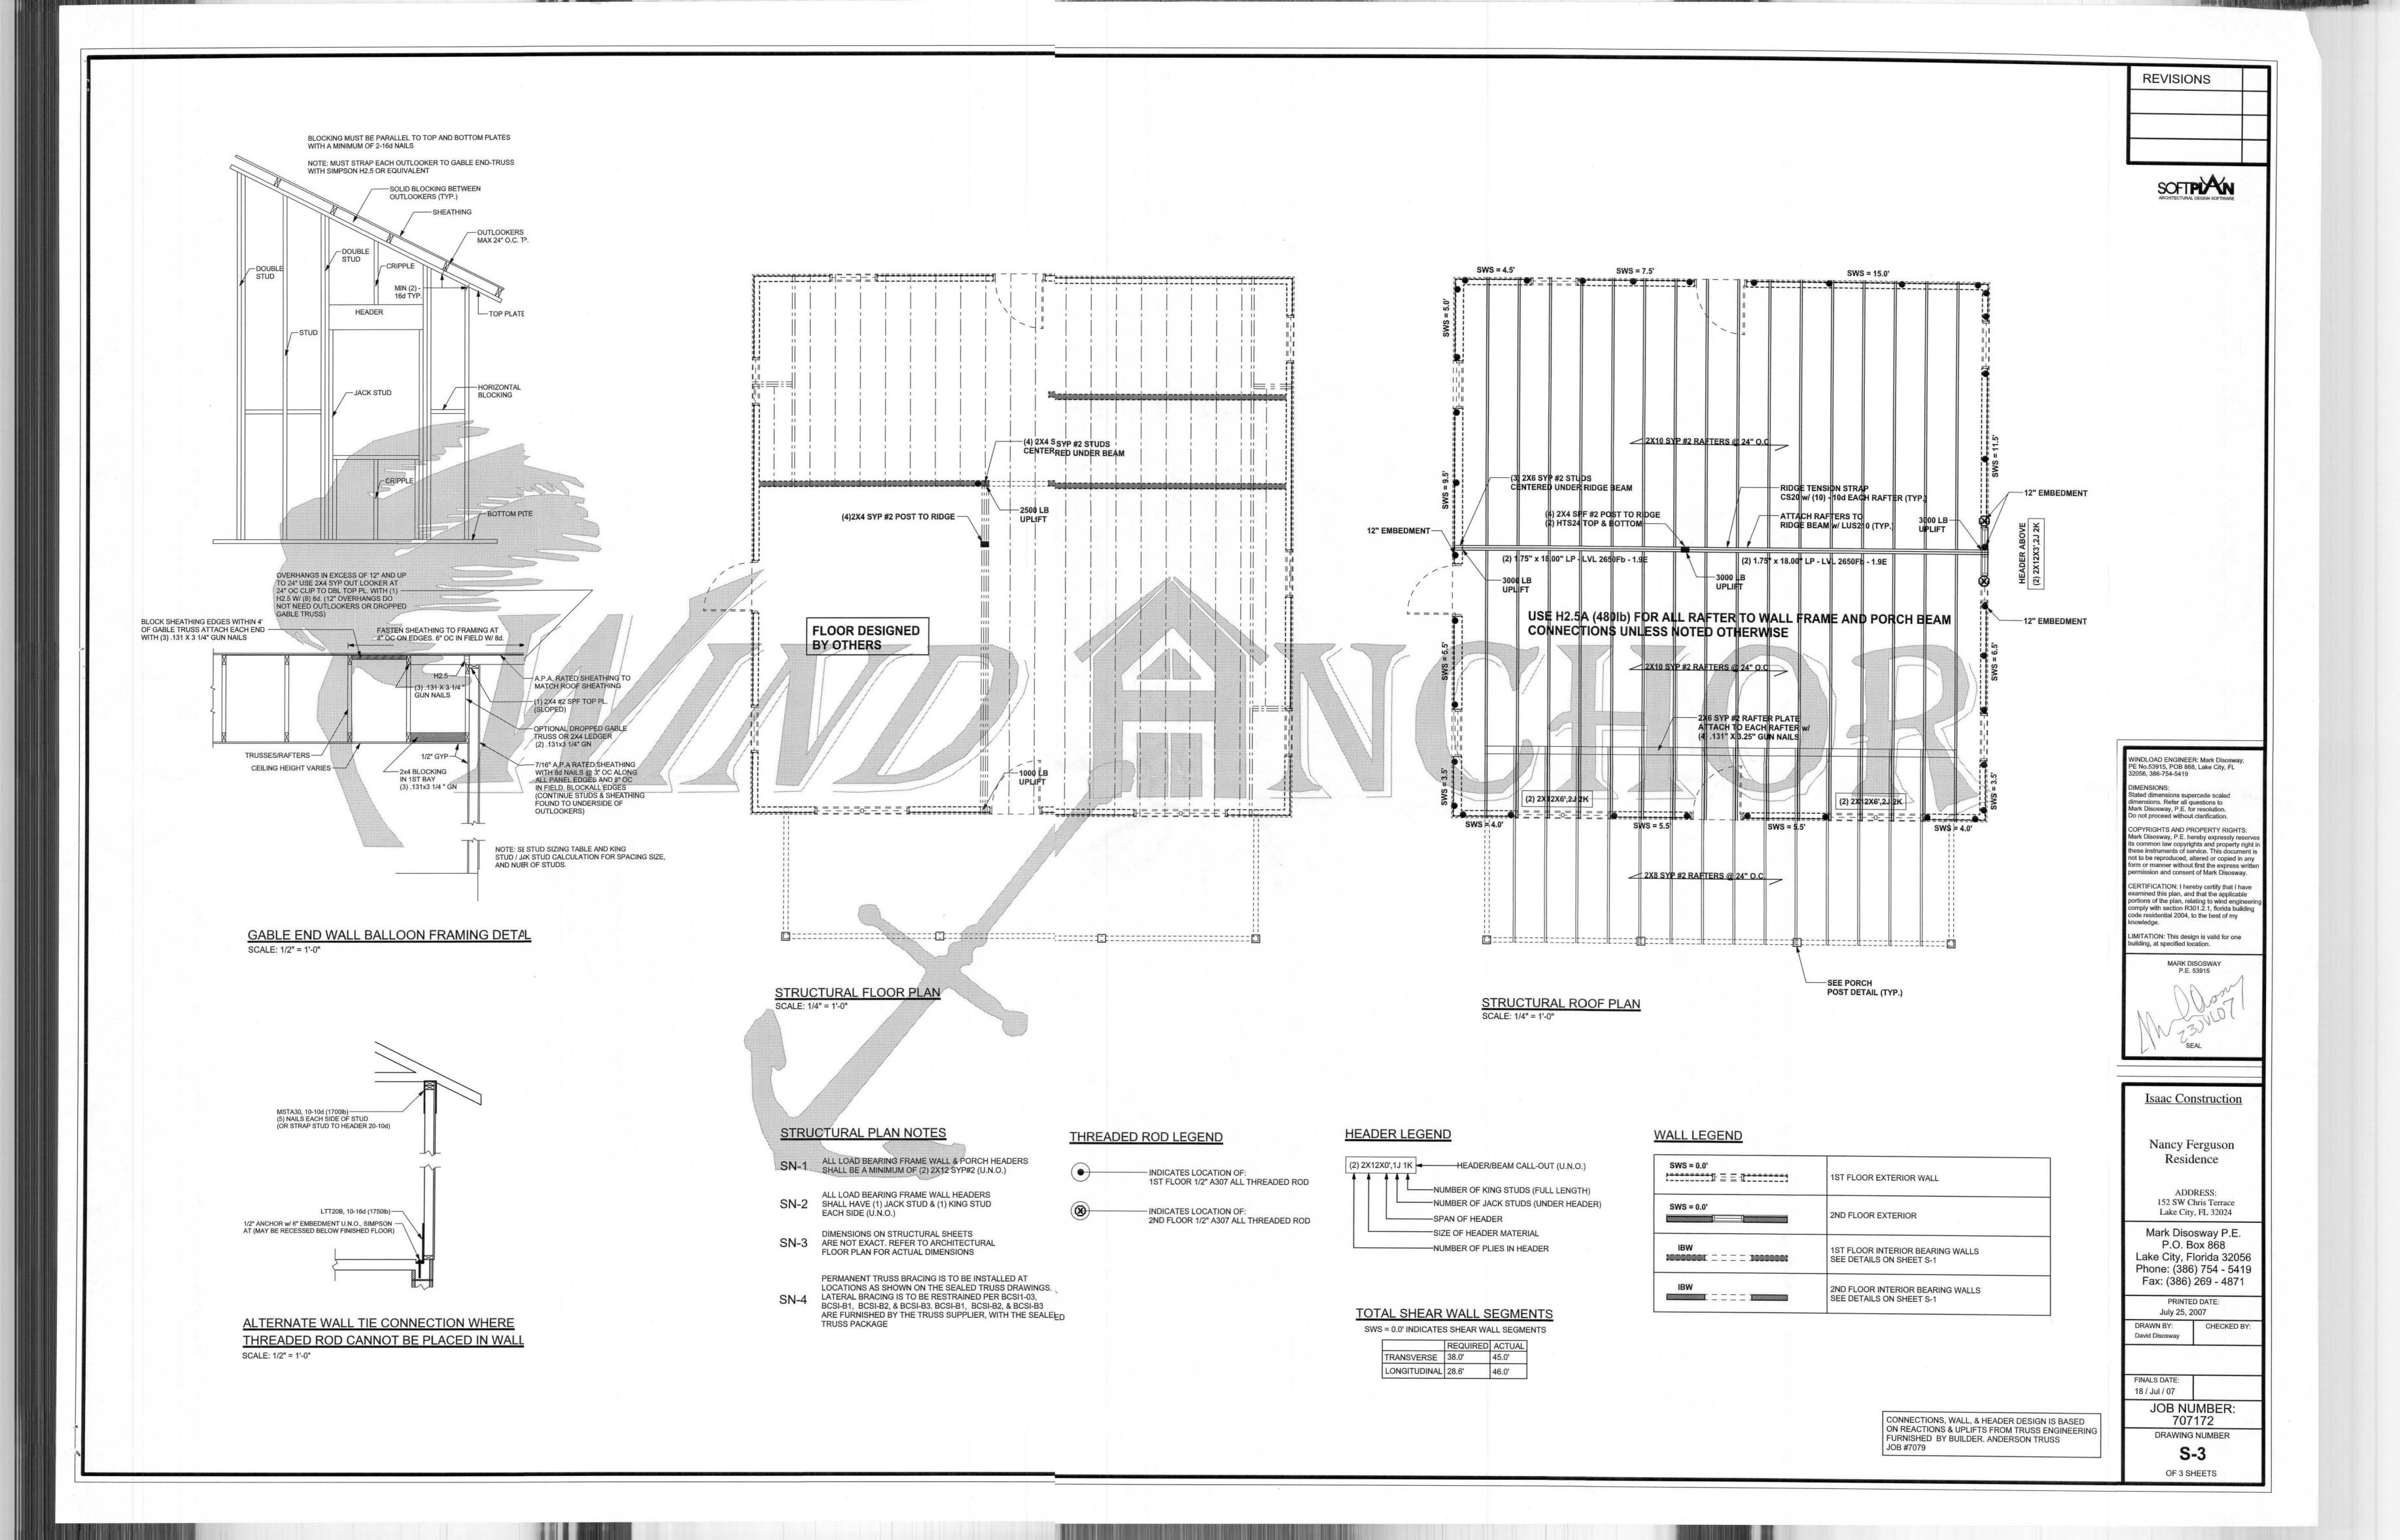


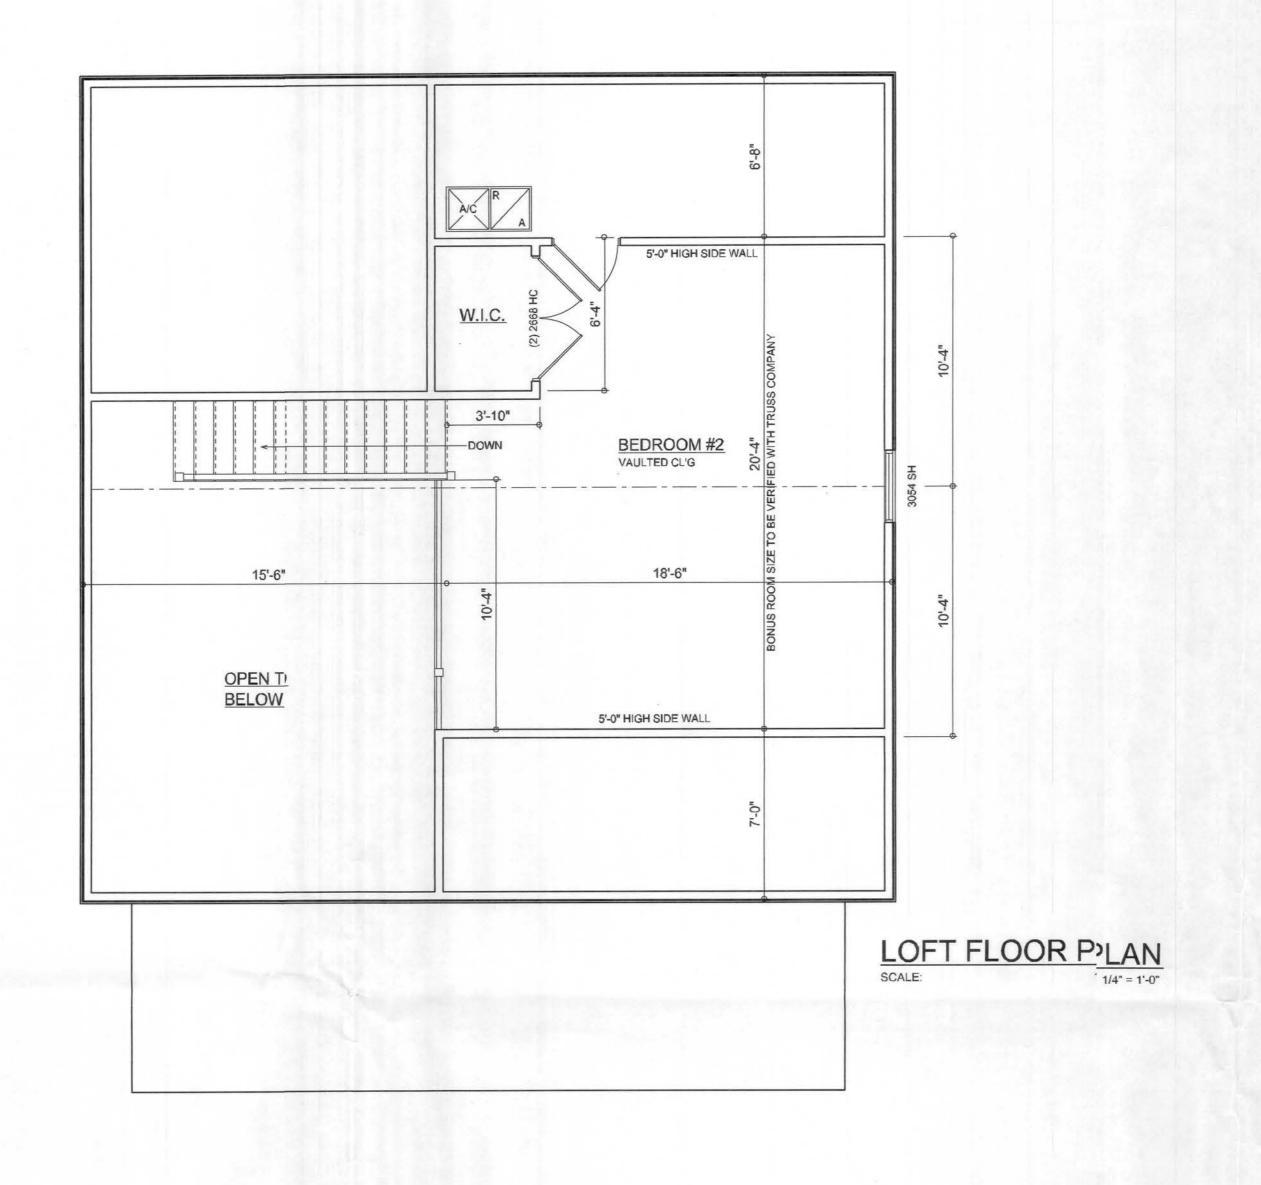


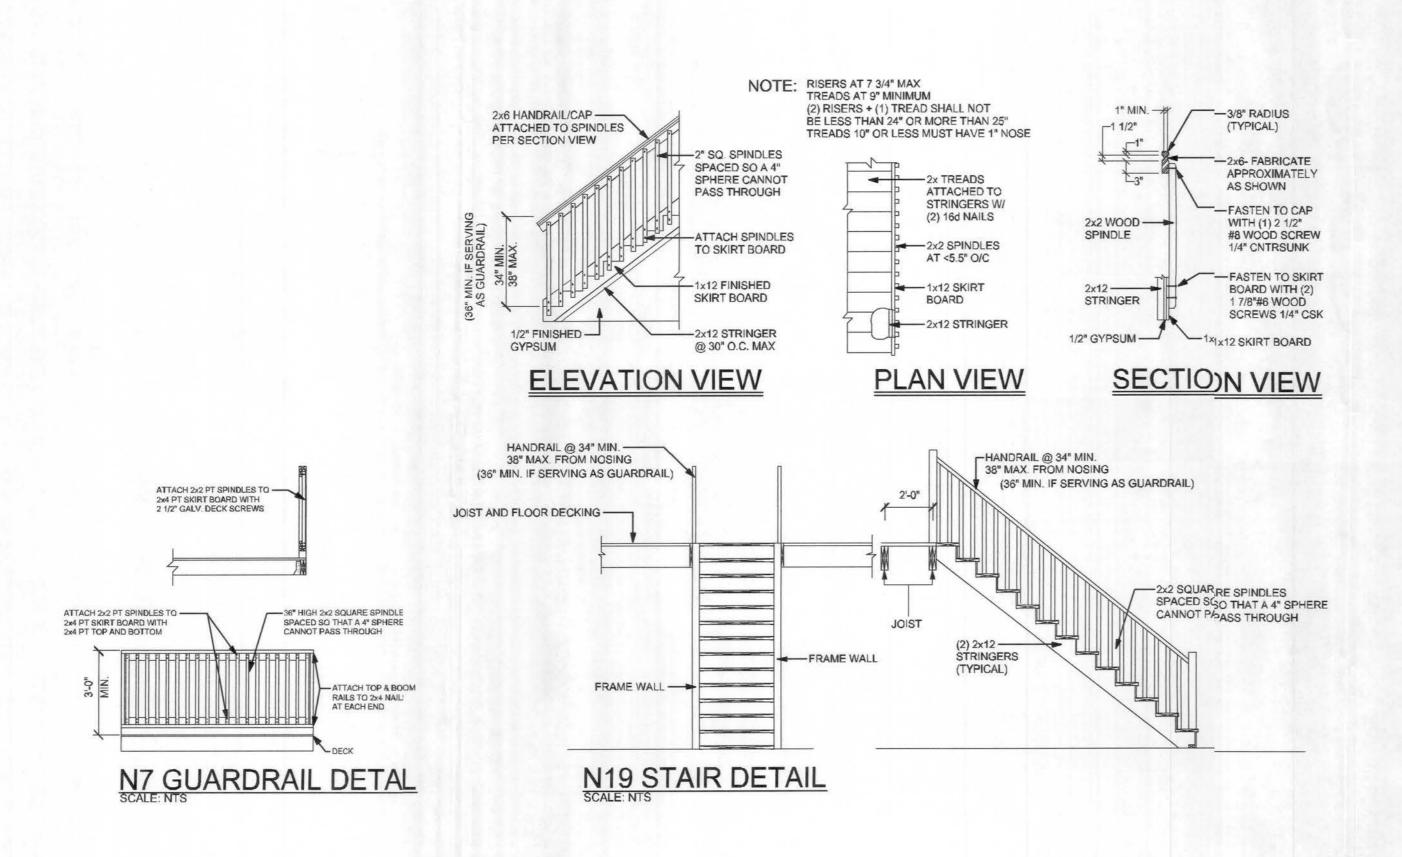


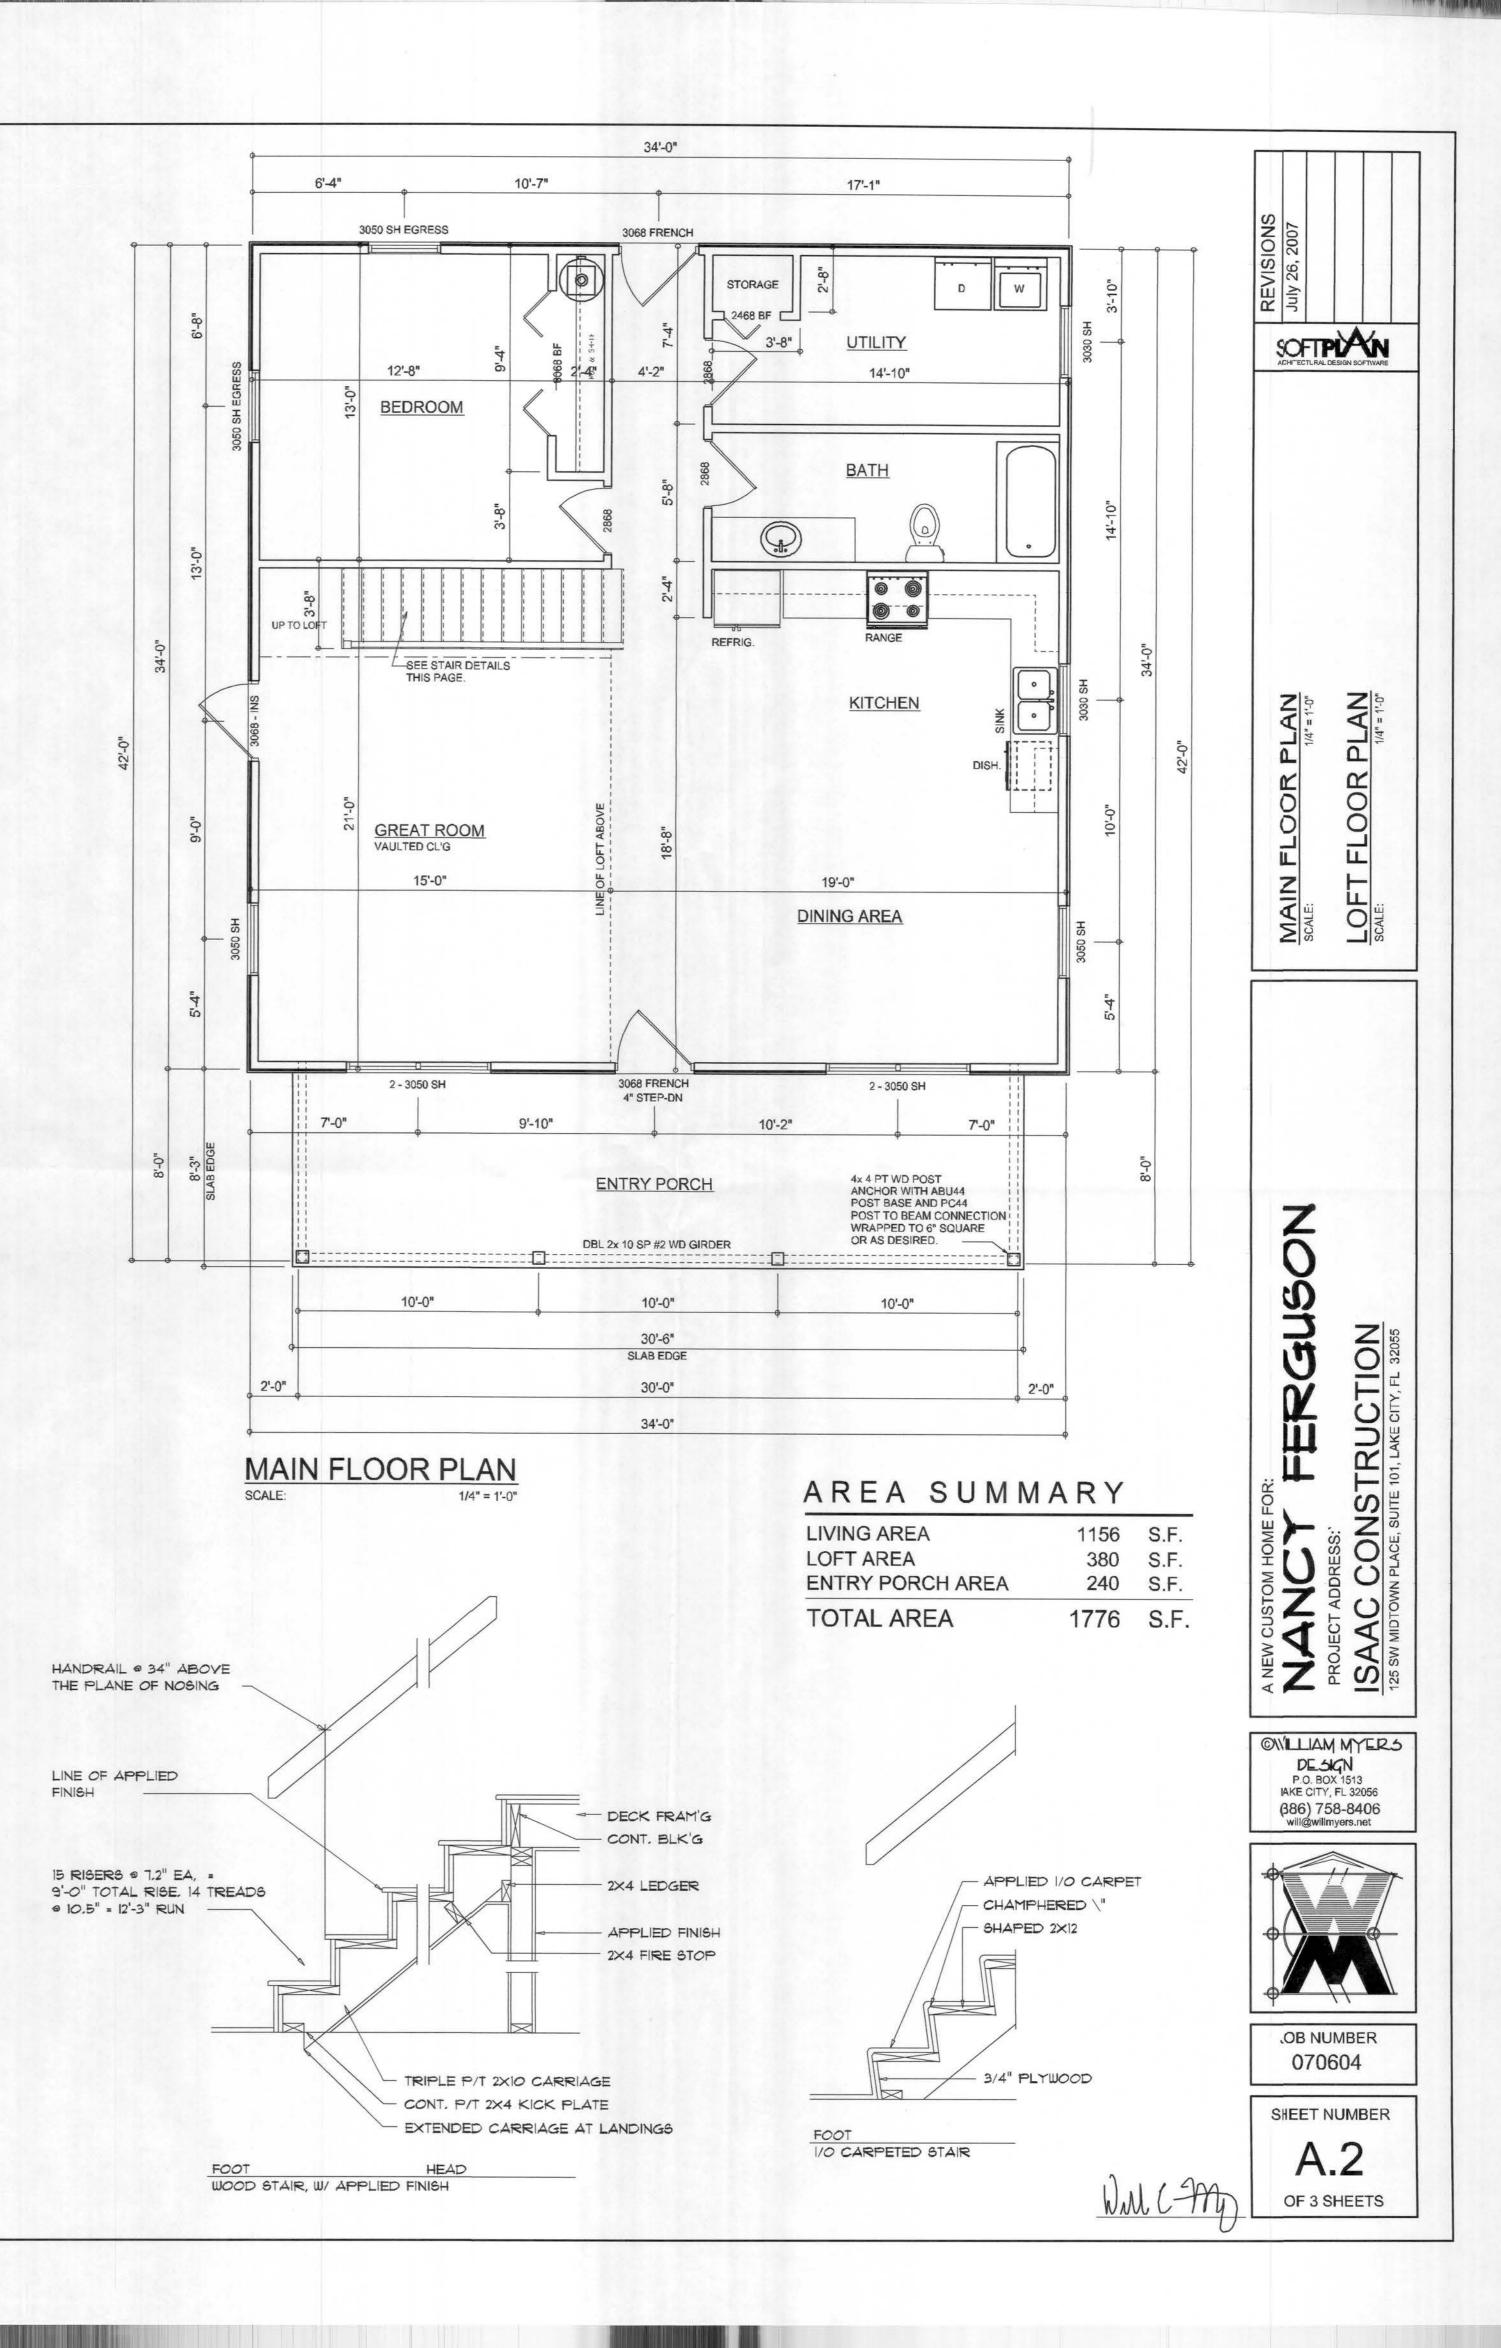

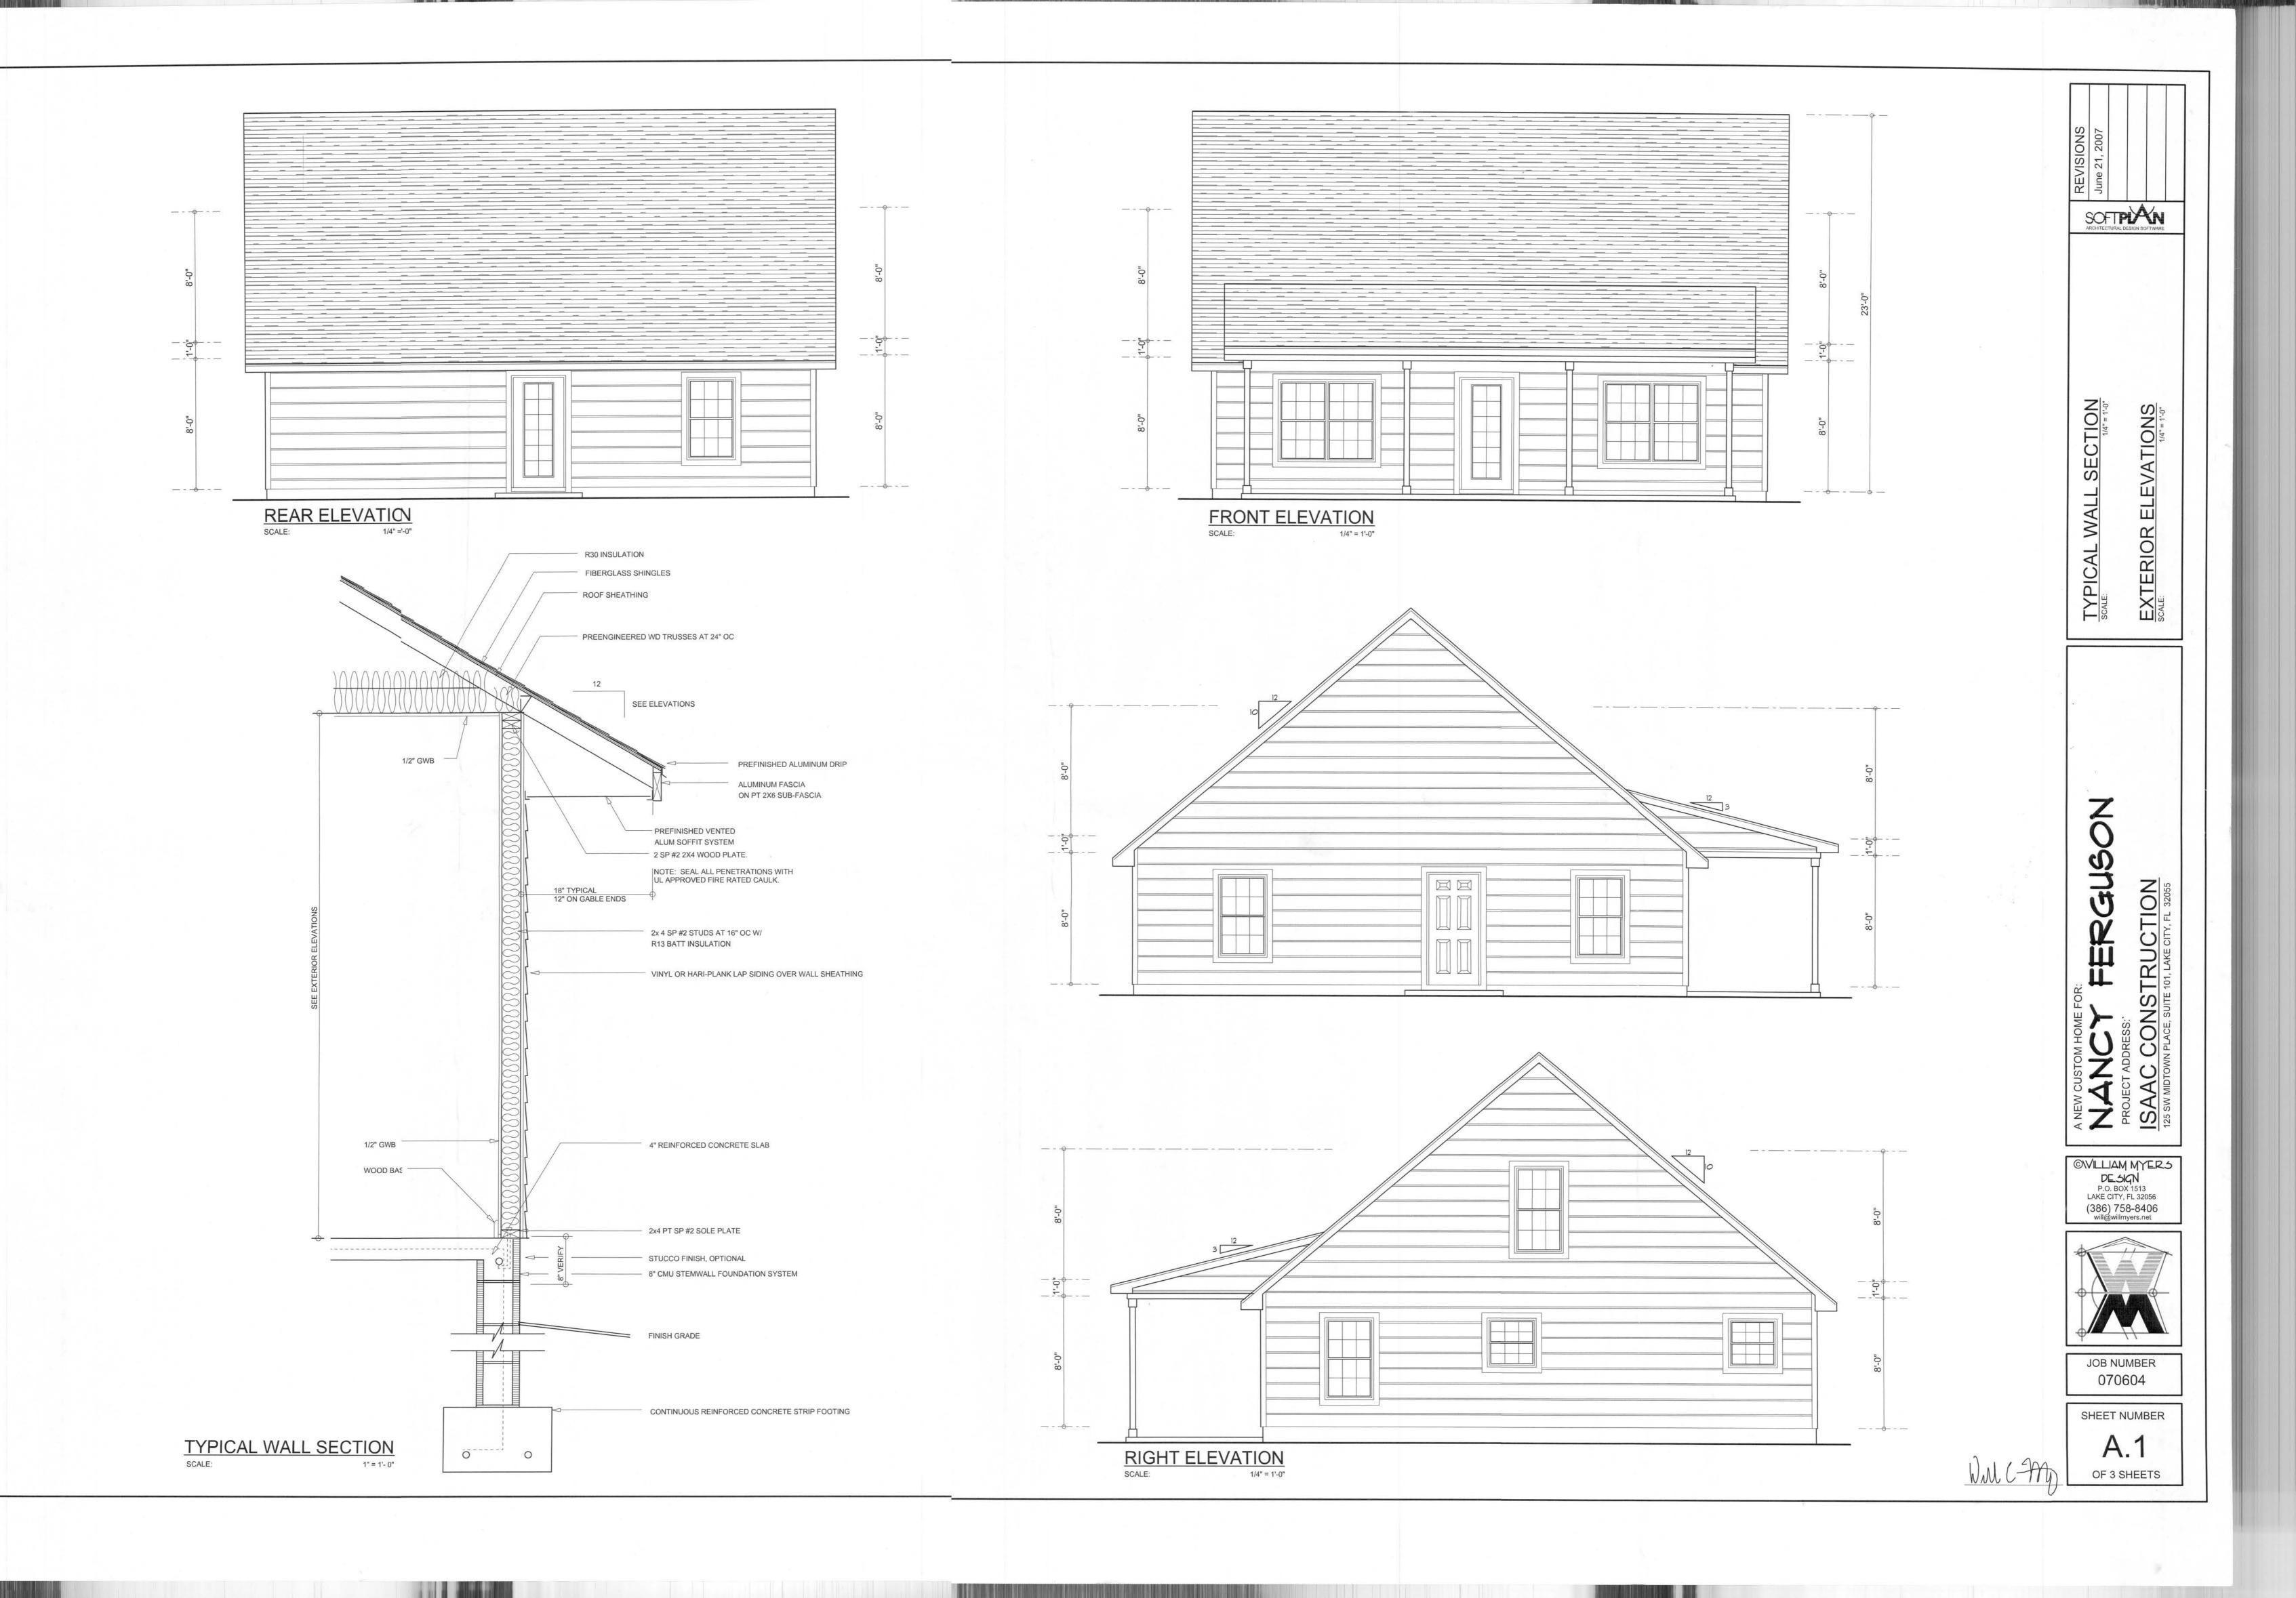

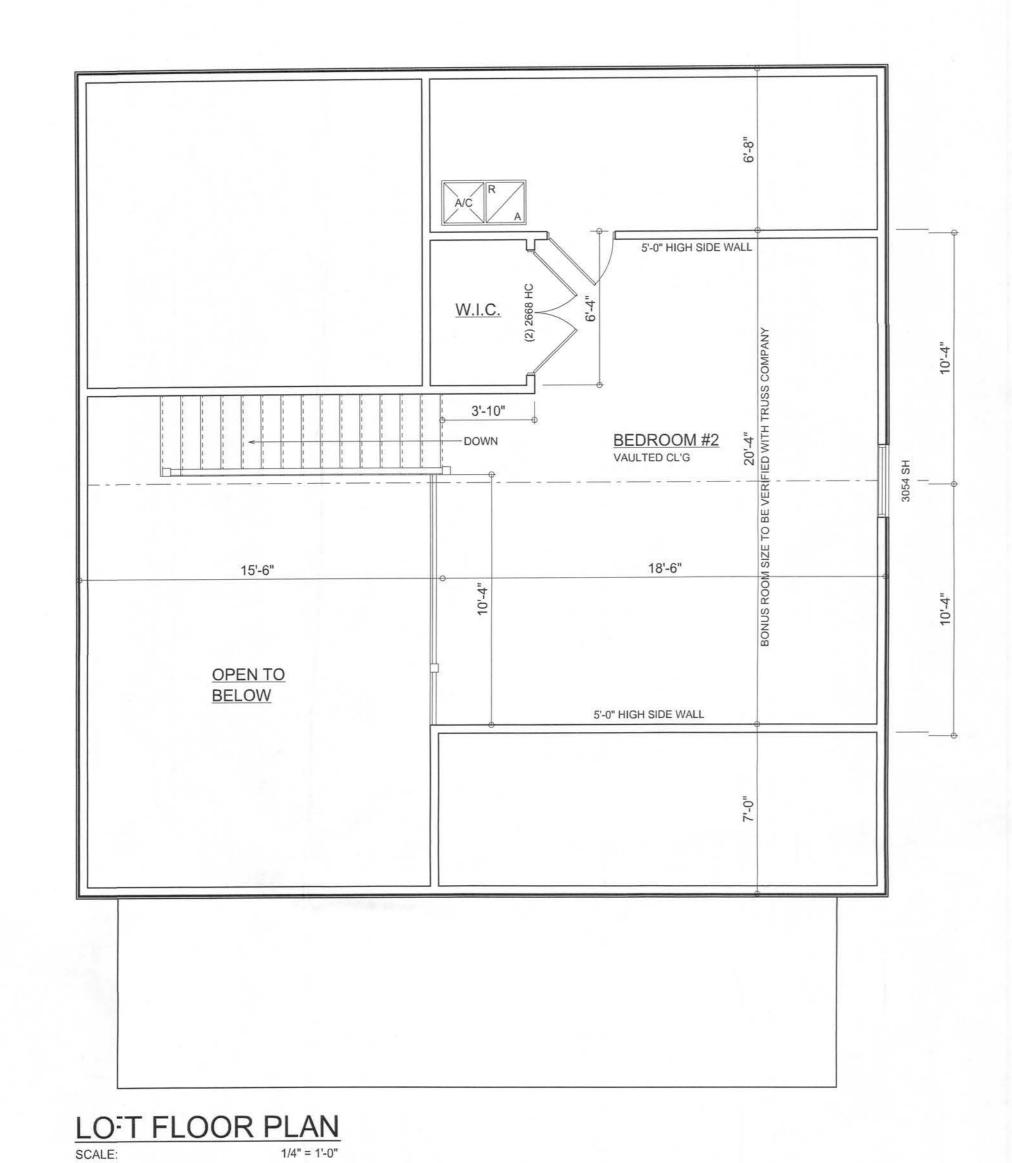

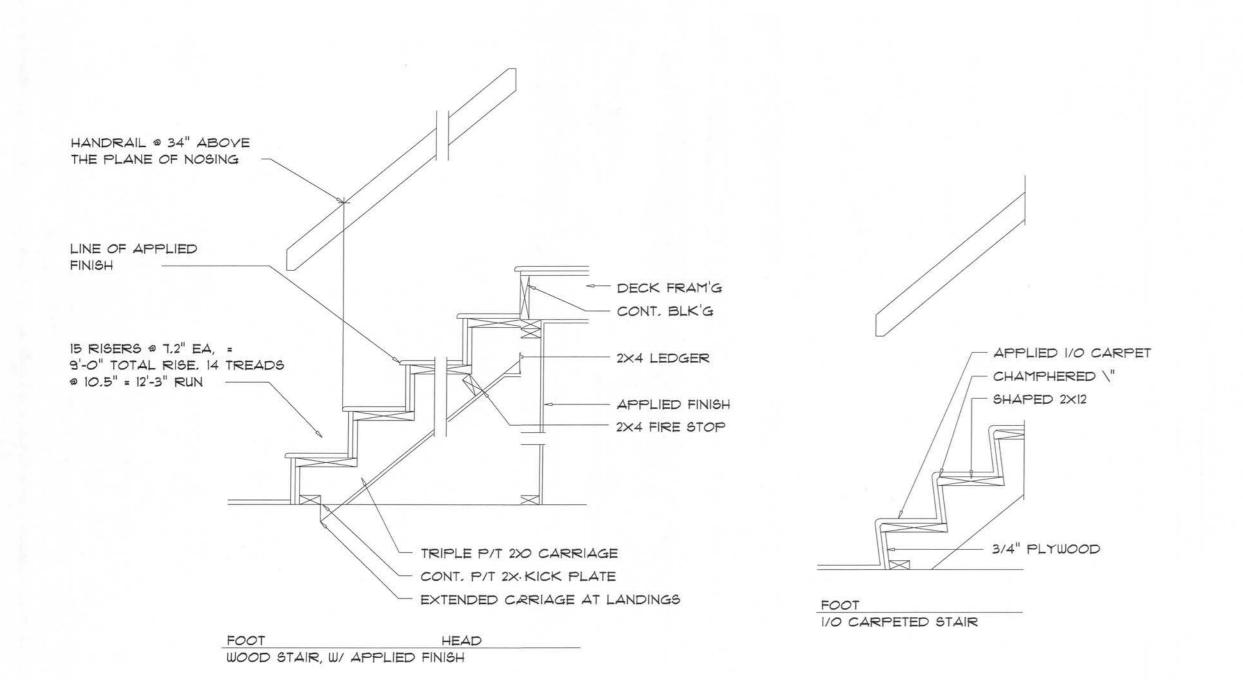

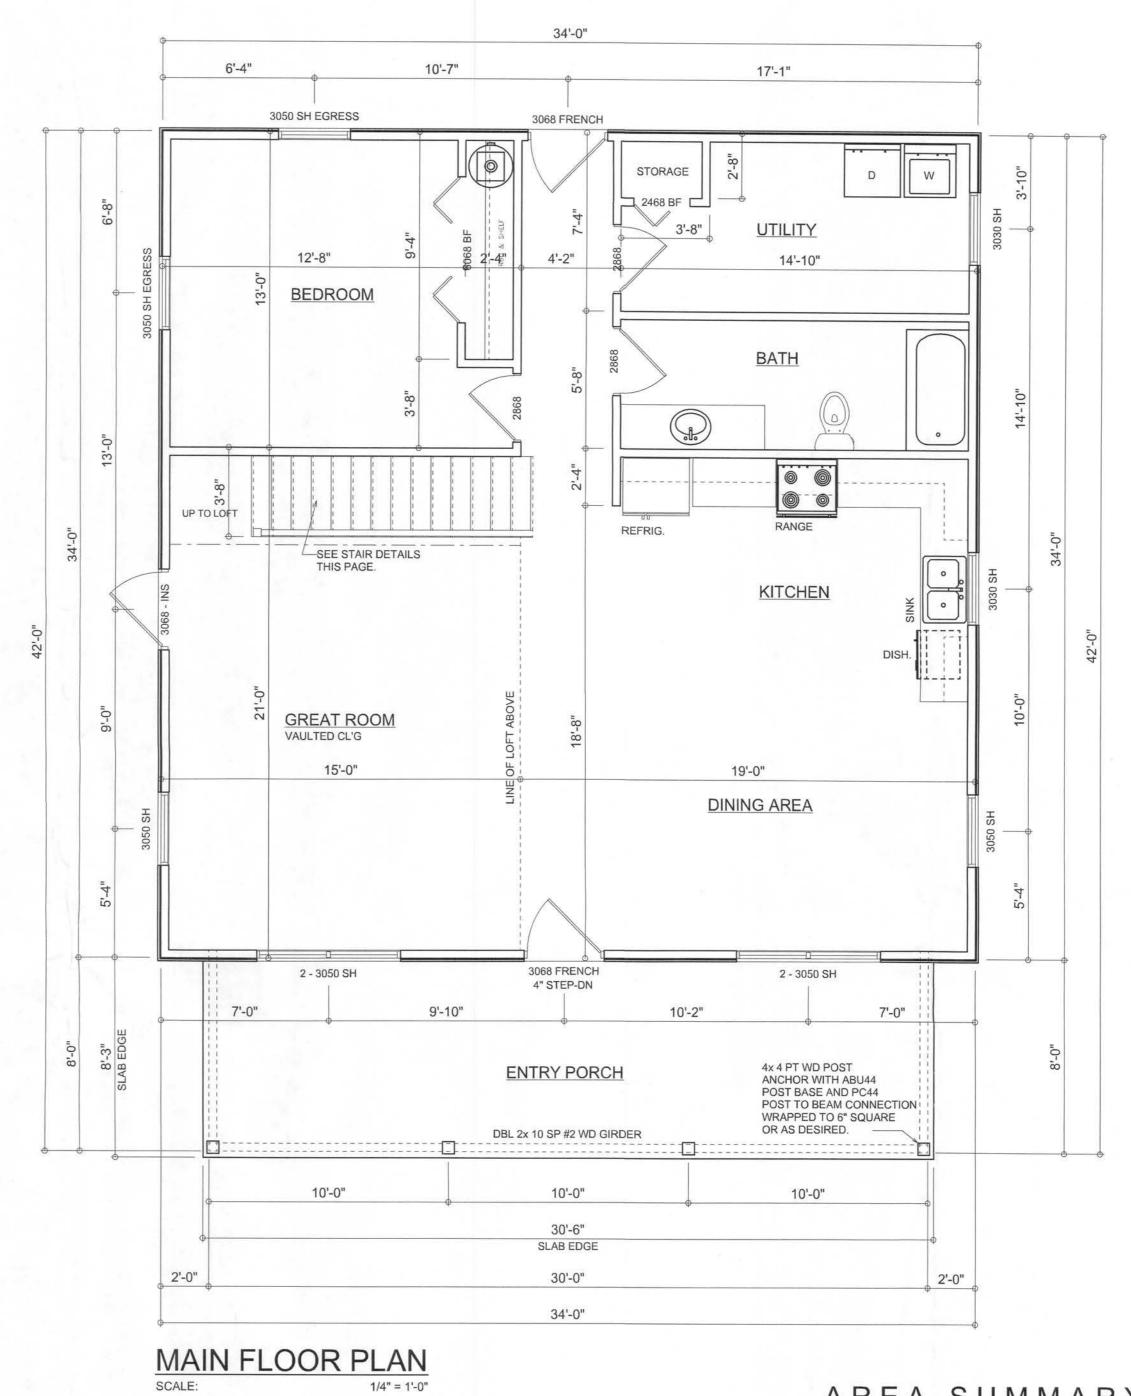

AREA SUMMARY

LIVING AREA 1156 S.F.

LOFT AREA 380 S.F.

ENTRY PORCH AREA 240 S.F.

TOTAL AREA 1776 S.F.

SEVISIONS

June 21, 2007

MAIN FLOOR PLAN

SCALE: 1/4" = 1'-0"

SCALE: 1/4" = 1'-0"

A NEW CUSTOM HOME FOR:

NANCY FERGUSON
PROJECT ADDRESS:

ISAAC CONSTRUCTION
125 SW MIDTOWN PLACE, SUITE 101, LAKE CITY, FL 32055

©VILLIAM MYERS


DESIGN

P.O. BOX 1513

LAKE CITY, FL 32056

(386) 758-8406

will@willmyers.net

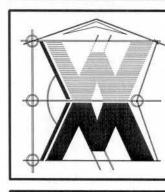



JOB NUMBER 070604

A.2
OF 3 SHEETS

Will CAM

	ELECTRICAL LEGEND
	CEILING FAN (PRE-WIRE FOR LIGHT KIT)
QD	DOUBLE SECURITY LIGHT
0	RECESSED CAN LIGHT
₩	BATH EXHAUST FAN
	LIGHT FIXTURE
Ф	DUPLEX OUTLET
•	220v OUTLET
<b></b> GFI	GFI DUPLEX OUTLET
TV †	TELEVISION JACK
PH 🗸	TELEPHONE JACK
•	SMOKE DETECTOR (see note below)
\$	WALL SWITCH
\$3	3 WAY WALL SWITCH
₩P/GFI	WATER PROOF GFI OUTLET
48" FLOUR.	2 OR 4 TUB FLUORESCENT FIXTURE

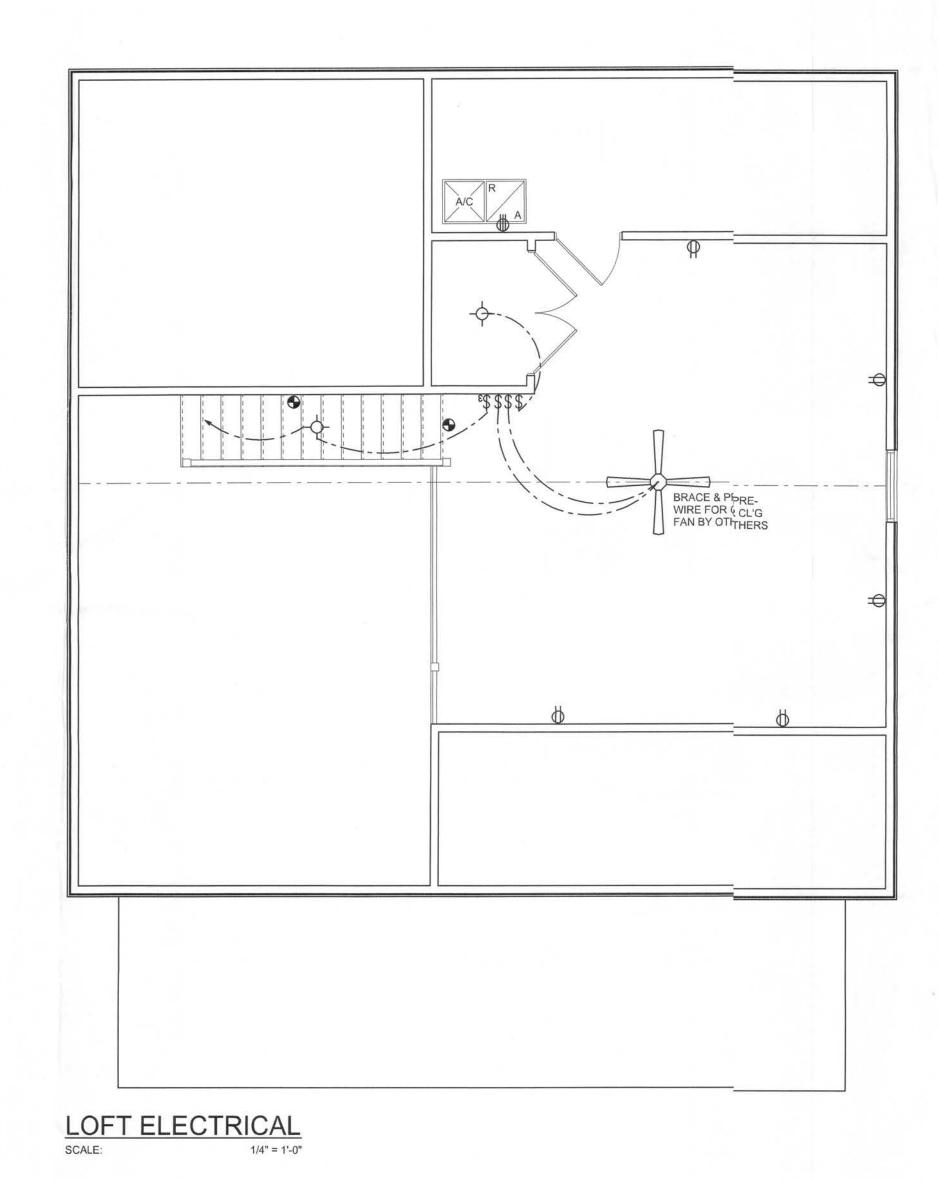

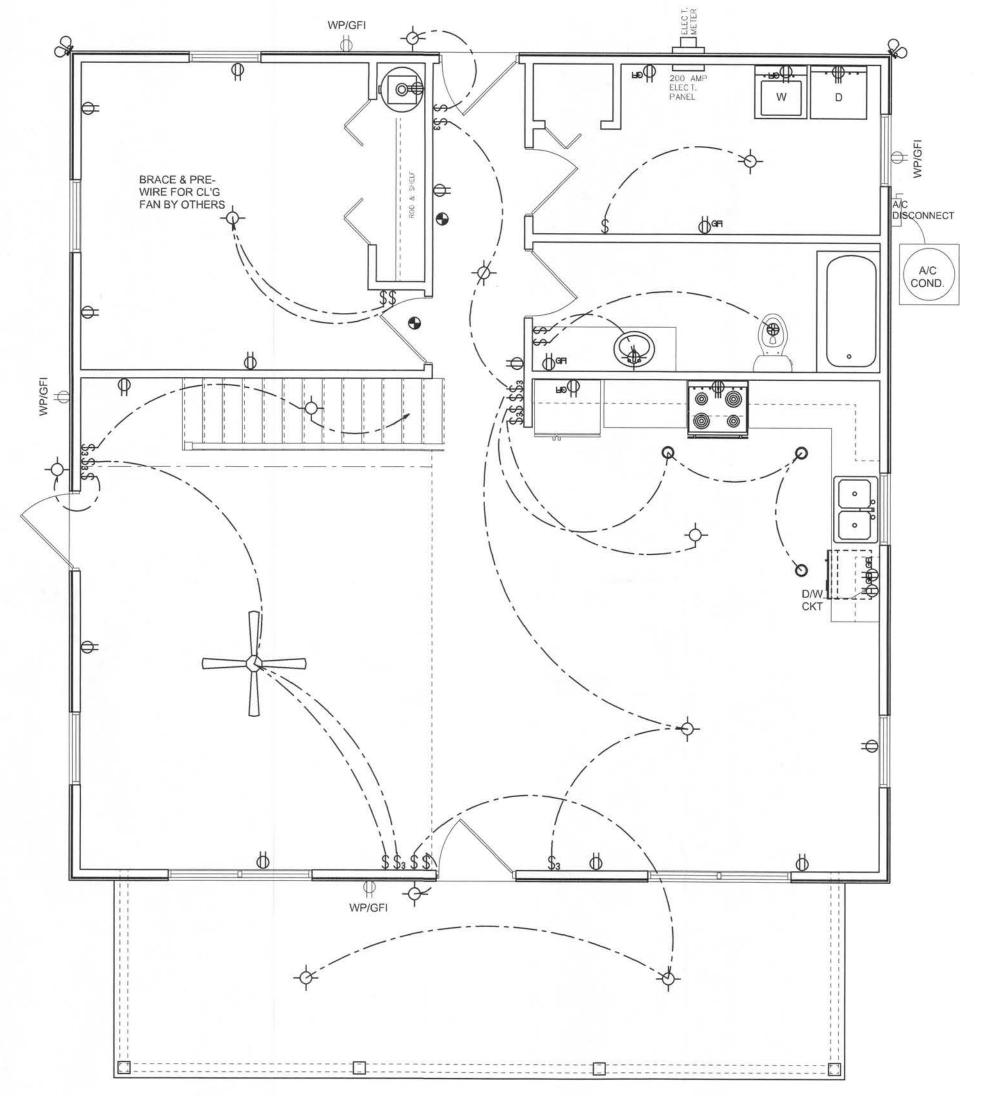

ELECTRICAL PLAN
SCALE: 1/4" = 1'-0"

NOTE: ALL BEDROOM RECEPTACLES SHALL BE AFCI (ARC FAULT CIRCUIT INTERRUPT)

ALL SMOKE DETECTORS SHALL HAVE BATTERY BACKUP POWER AND ALL WIRED TOGETHER SO IF ANY ONE UNIT IS ACTUATED THEY ALL ACTIVATE.

THE ELECTRICAL SERVICE OVERCURRENT PROTECTION DEVICE SHALL BE INSTALLED ON THE EXTERIOR OF STRUCTURES TO SERVE AS A DISCONNECT MEANS. CONDUCTORS USED FROM THE EXTERIOR DISCONNECTING MEANS TO A PANEL OR SUB PANEL SHALL HAVE FOUR-WIRE CONDUCTORS, OF WHICH ONE CONDUCTOR SHALL BE USED AS AN EQUIPMENT GROUND.

ANCY FERGUSON
ROJECT ADDRESS:
SAAC CONSTRUCTION

SOFTPIAN ARCHITECTURAL DESIGN SOFTMANE

ELECTRICAL PLAN SCALE: 1/4" = 1'-0"

LOFT ELECTRICAL SCALE: 1/4" = 1'-0"

©WILLIAM MYERS


DESIGN

P.O. BOX 1513

LAKE CITY, FL 32056

(386) 758-8406

will@willmyers.net

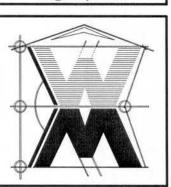



JOB NUMBER 070604

SHEET NUMBER

A.3


OF 3 SHEETS

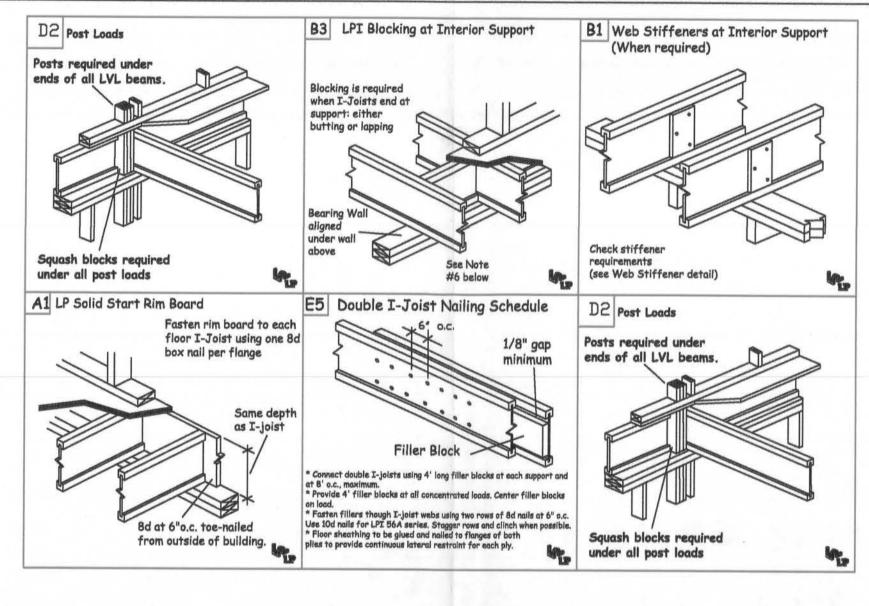


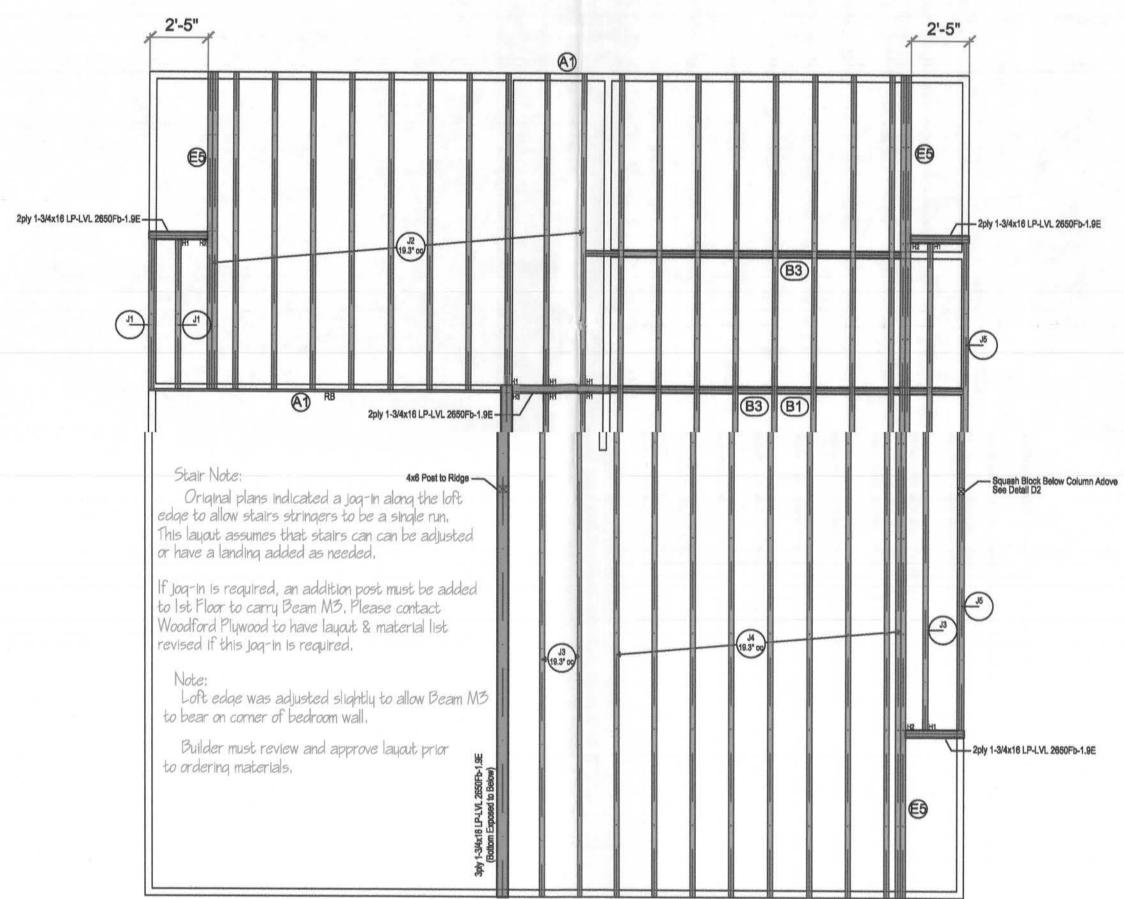

# 2ND FLOOR PLACEMENT PLAN

Label	Qtv	Description	Length
M1	6	1-3/4x16 LP-LVL 265	4'-0"
M2	2	1-3/4x16 LP-LVL 265	6'-0"
МЗ	3	1-3/4x18 LP-LVL 265	22'-0"
Joist S	Sched		
Label	Qty	Description	Length
J1	2	16" LPI 32Plus	7'-0"
J2	12	16" LPI 32Plus	14'-0"
J3	3	16" LPI 32Plus	21'-0"
J4	10	16" LPI 32Plus	36'-0"
J5	2	16" LPI 32Plus	10'-0"
Label	Qty	Description	
H1	8	ITT316	
H2	3	MIT416	
НЗ	1	LGU3.63-SDS X Right F	lange Concealed, H=16
Blocki	ng Sc	chedule	
		Description	Length
		16" LPI 32Plus	28 LF
		Schedule	
Label	NATIONAL PROPERTY.	Description	
RB	2	1 1/8" x 16" x 12'-0"	

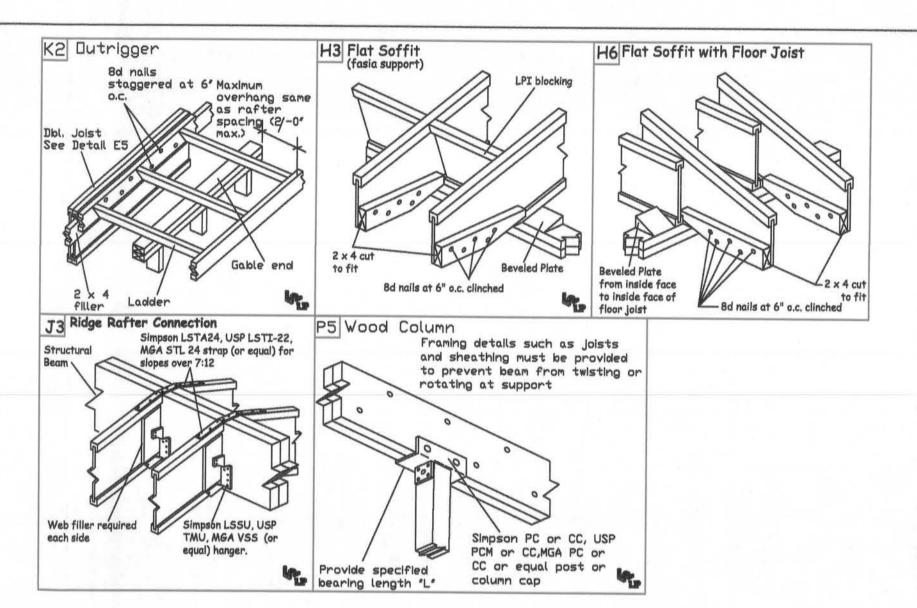

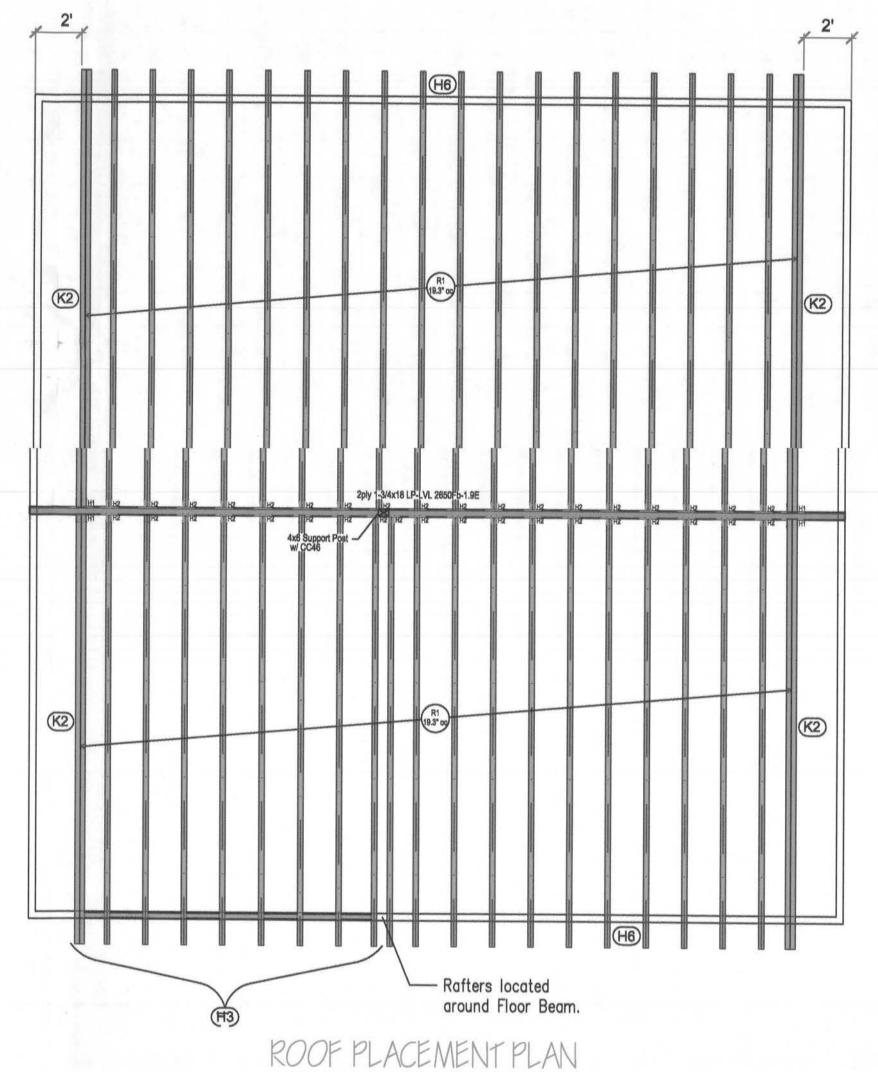

Beam Label		Description	Length	
M1		1-3/4x18 LP-LVL 265	36'-0"	
Rafter				
Label	Qty	Description	Length	
R1		14" LPI 20Plus	25'-0"	
Conne	ector	Schedule		
Label	Qty	Description		
H2	37	LSSUH310		
НЗ	1	CC46		
Blocki	ng So	chedule		
		Description	Length	
		14" LPI 20Plus	13 LF	

"Structural Wood Products"

1504 S. MOCK RD. : P.O. BOX 50007

ALBANY, GA 31705 (800) 342-6400



### NOTICE:

THIS PLACEMENT PLAN IS OFFERED AS A SALES PRESENTATION AND HAS NOT BEEN REVIEWED OR APPROVED BY AN ENGINEER. NO STRUCTURAL ANALYSIS HAS BEEN MADE OF SEISMIC,

LATERAL, SHEAR, STACKING, OR OTHER FORCES WHICH MAY ACT ON THESE COMPONENTS, THEREFORE THE USE OF THESE PRODUCTS SHALL BE SPECIFIED BY " THE DESIGNER OF THE COMPLETE STRUCTURE ".

DEALER SALES REPRESENTATIVE SHALL CHECK AND CONFIRM ALL LENGTHS, TALLIES, SERIES, AND DEPTH INFORMATION WITH CONTRACTOR

PRIOR TO PLACING ORDER FOR MATERIALS. THIS PLACEMENT PLAN IS PRELIMINARY AND NOT A CONSTRUCTION DOCUMENT.

THE LOAD BEARING WALLS, POSTS, AND/OR PIERS ON THIS PLACEMENT PLAN ARE NECESSARY FOR THE PROPER INSTALLATION OF YOUR STRUCTURAL WOOD PRODUCTS. PLEASE NOTIFY WOODFORD TECHNICAL DEPT. IN WRITING OF ANY CHANGES IN BEARING LOCATIONS. THE DESIGN OF BEARING LOCATIONS IS THE SOLE RESPONSIBILITY OF THE DESIGNER OF THE COMPLETE STRUCTURE.

3. ALL METAL CONNECTORS SPECIFIED ARE TO BE SIMPSON STRONG TIE CO., INC. OR EQUAL. ALL HANGERS AND CONNECTORS IN CONTACT WITH WITH PRESSURE TREATED WOOD MUST BE REVIEWED BY THE CONTRACTOR, PRESSURE TREATED WOOD AND HANGER MANUFACTURER TO INSURE PROPER COATINGS ON HANGERS, CONNECTORS AND ATTACHMENT

MATERIALS. A. SINDICATES UNIFORM OR CONCENTRATED ROOF BRACING LOCATIONS OTHERWISE, ALL ROOF BRACE LOADS SHALL BE TRANSFERRED TO FIRST FLOOR WALLS AND NOT TO FLOOR JOISTS.

5. I-JOIST SPACED 24"o.c. SHALL HAVE ADEQUATE SUBFLOOR TO INSURE STIFFNESS BETWEEN JOIST. 6. LATERAL BRACING IS REQUIRED ALONG BOTTOM FLANGES OF 1-JOIST. AT 8'-0"o.c. IF RIGID SHEATHING IS NOT APPLIED.

# LEGEND

=:==WALL ABOVE

=ROOF LOAD ---- =BEAM

=JOIST MARKER


----=I-JOIST - =HANGER △ = DETAIL MARK


=BEAM MARKER

CUSTOMER: Anderson Truss DRAWN BY: JJK PROJECT: Furguson Res.

DATE: 7-4-07 REV.2 \_ \_ \_ REV.1\_\_\_\_ REV.3\_\_\_\_

DESCRIPTION:\_\_\_\_\_ w/F# 7079

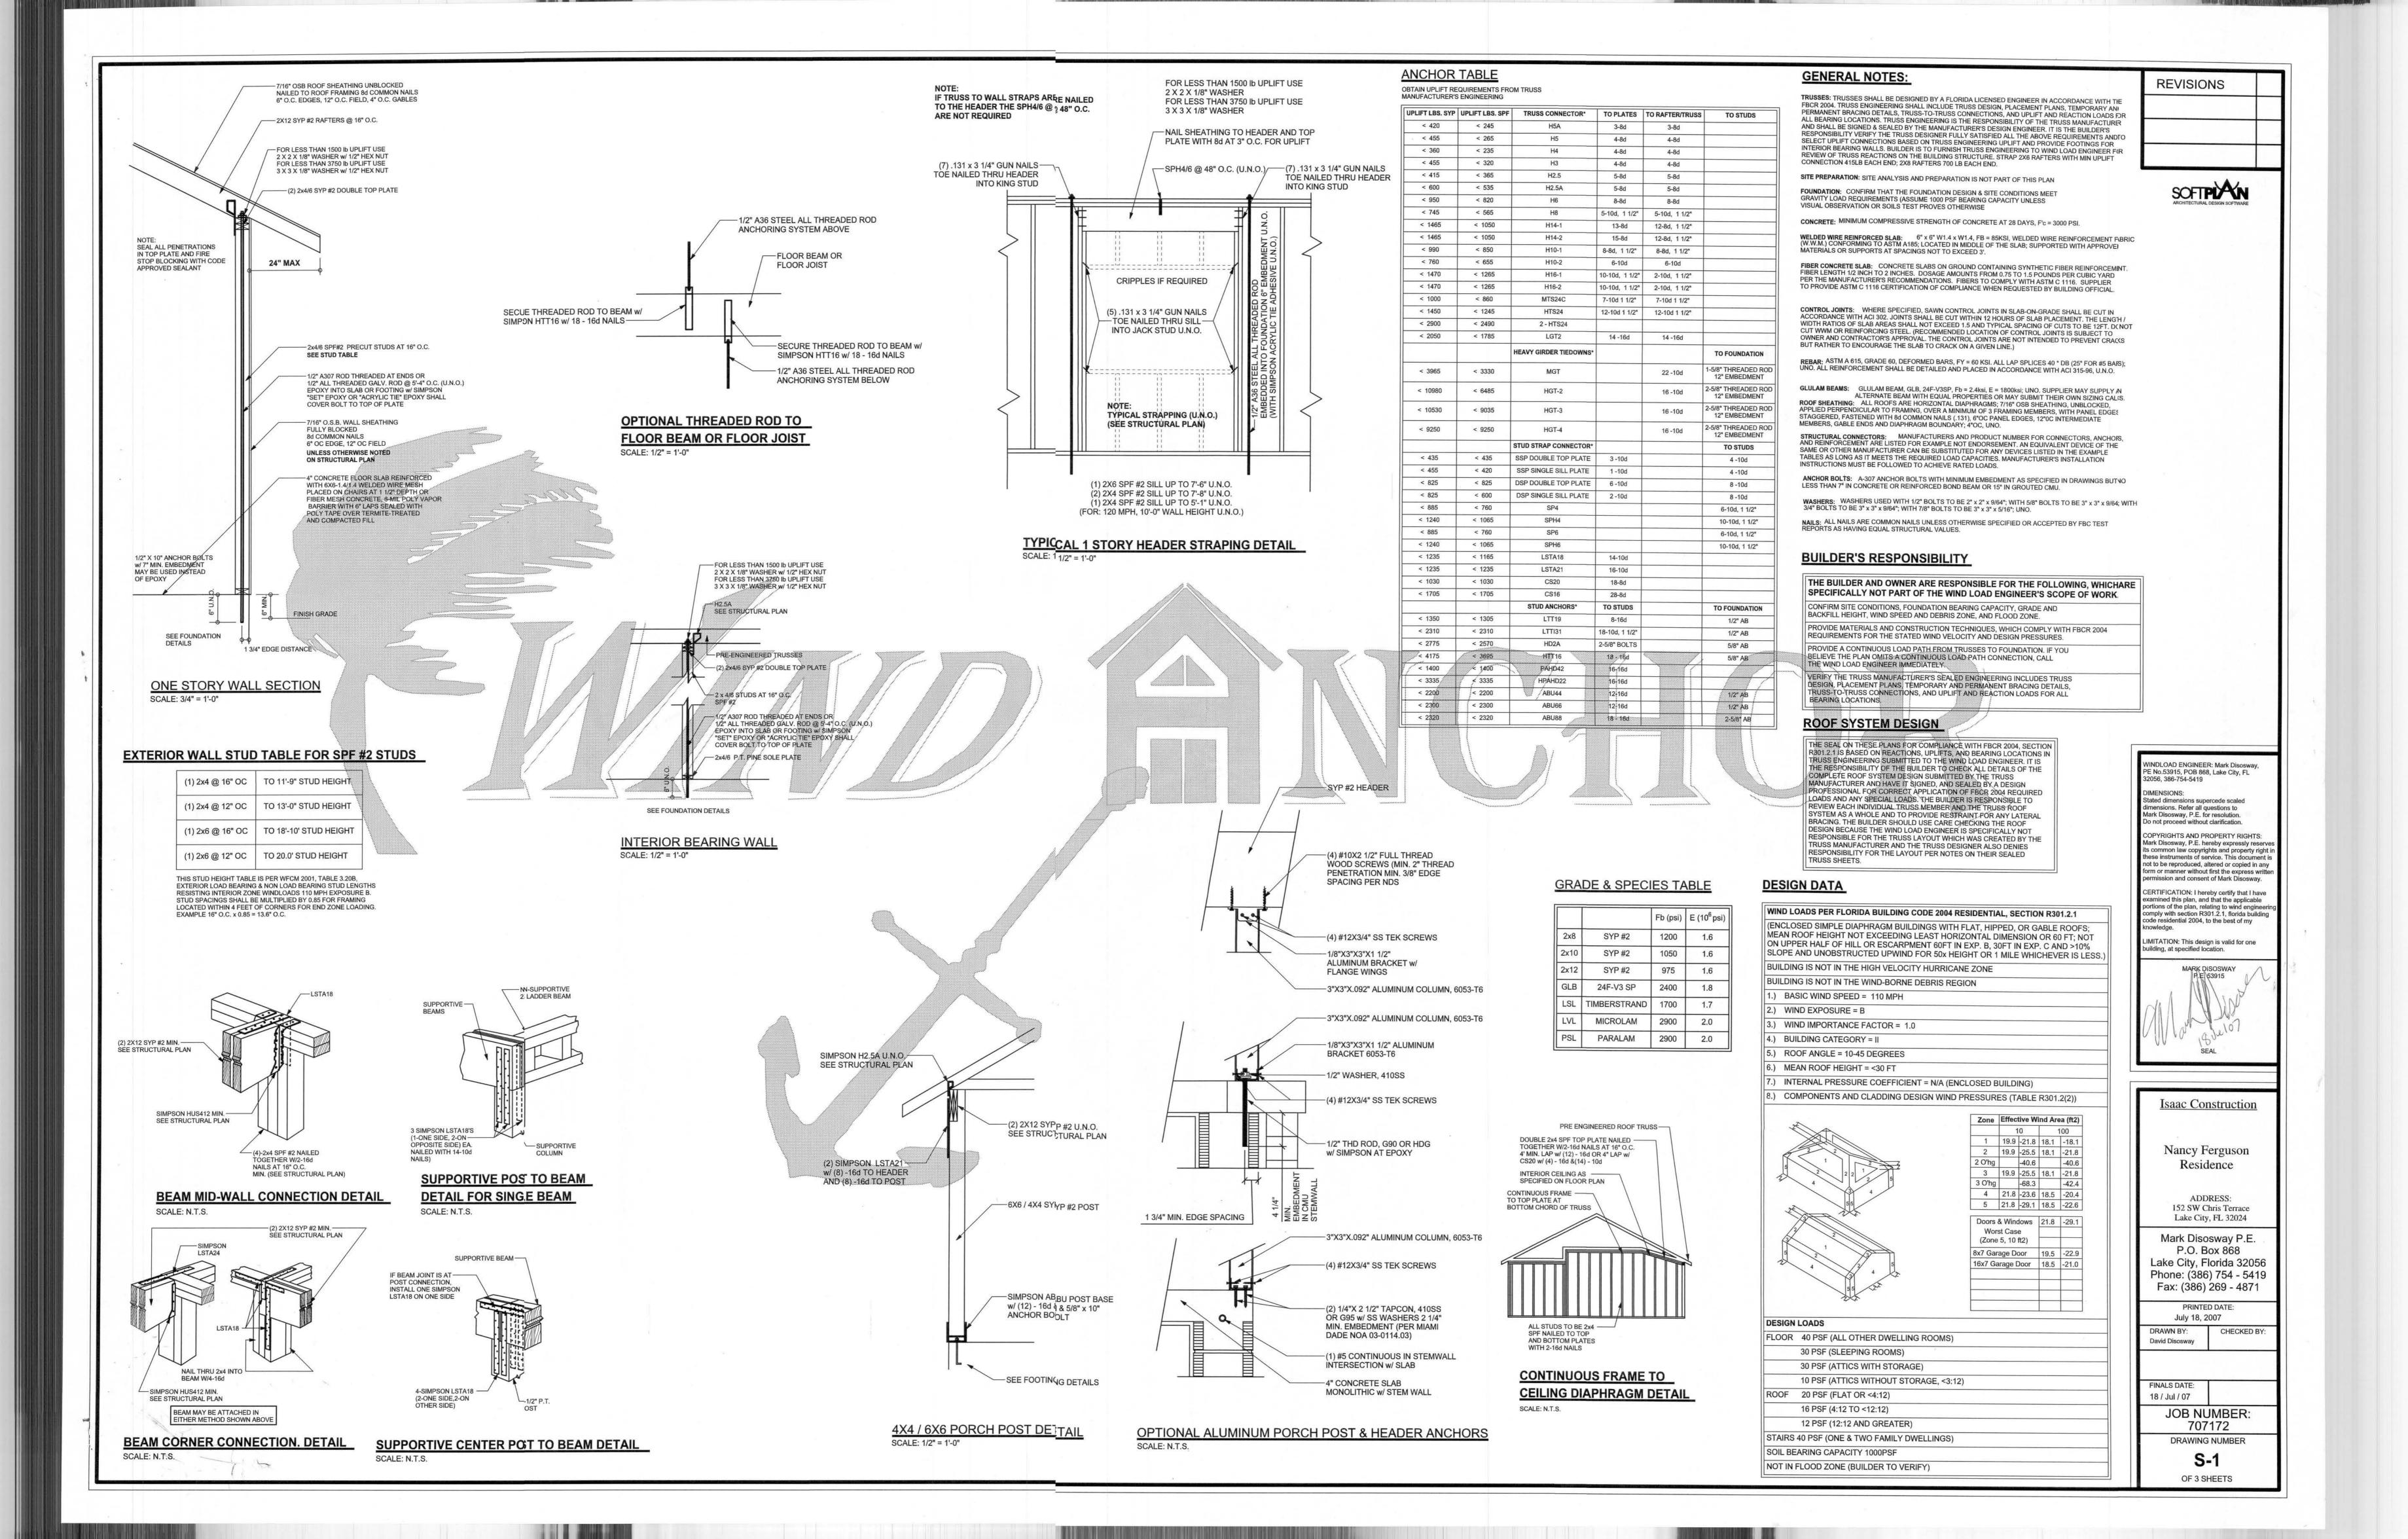

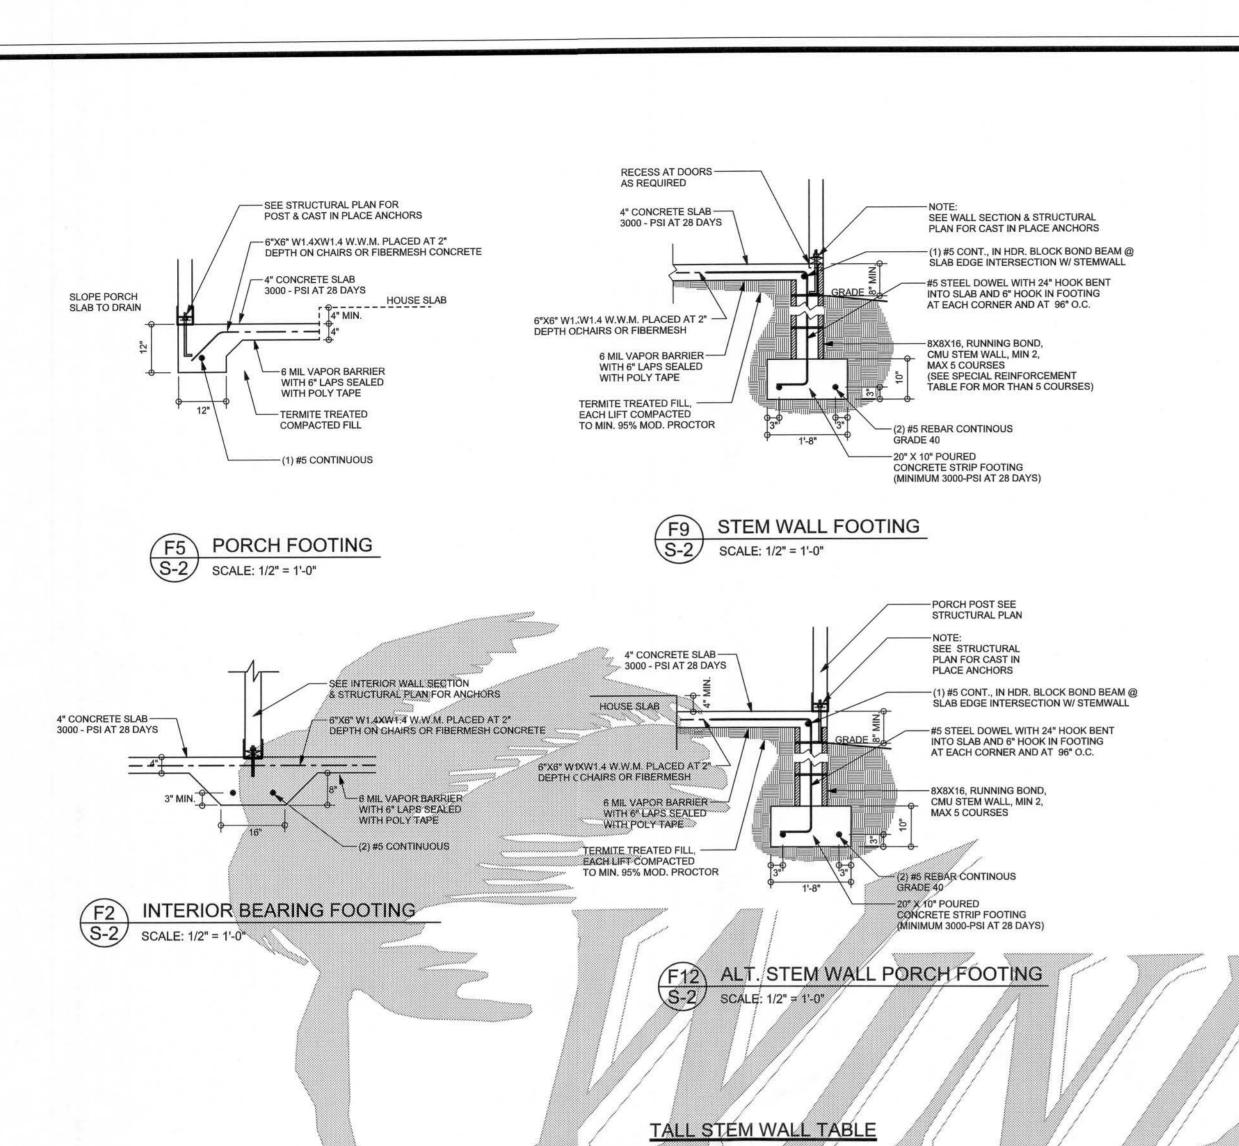

CMU wall (away from the soil pressure, within 2" of the exterior side of the wall). If the wall is over 8' high, add Durowall ladder reinforcement at 16"OC vertically or a horizontal bond

beam with 1#5 continuous at mid height. For higher parts of the wall 12" CMU may be used with reinforcement as shown in the table below.

#5 #7 #8

3.7 96 96 96 96 96

 4.3
 88
 96
 96
 96
 96
 96

 5.0
 56
 96
 96
 96
 96
 96

 5.7
 40
 80
 96
 80
 96
 96

6.3 32 56 80 56 96 96

 7.7
 16
 32
 48
 32
 64
 80

 8.3
 8
 24
 32
 24
 48
 64


 9.0
 8
 16
 24
 16
 40
 48

7.3 7.0 24 40 56 40 80 96

VERTICAL REINFORCEMENT FOR 12" CMU STEMWALL (INCHES O.C.)

STEMWALL UNBALANCED VERTICAL REINFORCEMENT
HEIGHT BACKFILL FOR 8" CMU STEMWALL
(FEET) HEIGHT (INCHES O.C.)

6.7

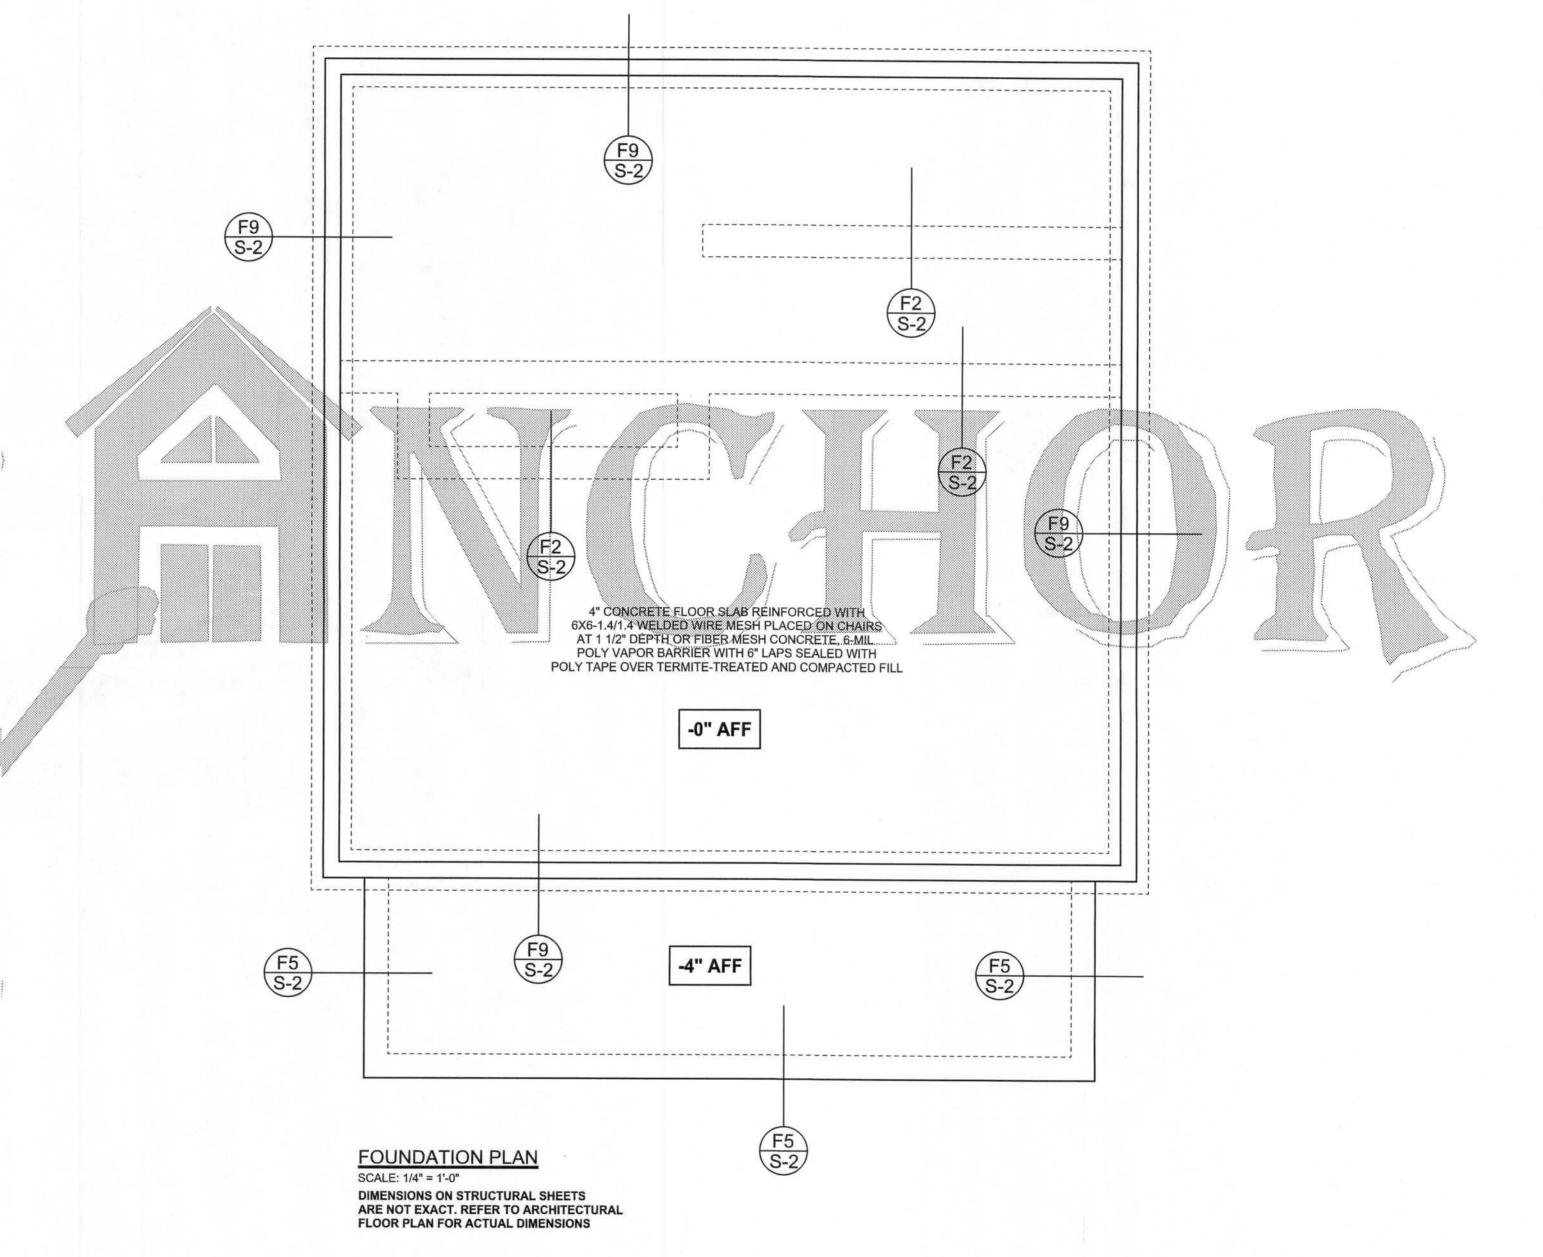

REVISIONS

SOFTPIAN ARCHITECTURAL DESIGN SOFTWARE


WINDLOAD ENGINEER: Mark Disosway, PE No.53915, POB 868, Lake City, FL 32056, 386-754-5419 DIMENSIONS: Stated dimensions supercede scaled

dimensions. Refer all questions to
Mark Disosway, P.E. for resolution.
Do not proceed without clarification.

COPYRIGHTS AND PROPERTY RIGHTS:
Mark Disosway, P.E. hereby expressly reserves
its common law copyrights and property right in
these instruments of service. This document is
not to be reproduced, altered or copied in any
form or manner without first the express written
permission and consent of Mark Disosway.

CERTIFICATION: I hereby certify that I have examined this plan, and that the applicable portions of the plan, relating to wind engineering comply with section R301.2.1, florida building code residential 2004, to the best of my knowledge.

LIMITATION: This design is valid for one building, at specified location.

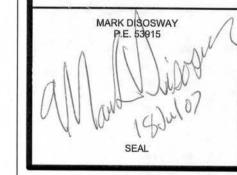

Isaac Construction

Nancy Ferguson Residence

> ADDRESS: 152 SW Chris Terrace Lake City, FL 32024

Mark Disosway P.E. P.O. Box 868 Lake City, Florida 32056 Phone: (386) 754 - 5419 Fax: (386) 269 - 4871

PRINTED DATE:
July 18, 2007

DRAWN BY: CHECKED BY:
David Disosway

FINALS DATE:

JOB NUMBER: 707172

S-2

OF 3 SHEETS

