





REAR ELEVATION
SCALE: 1/4" = 1'-0"

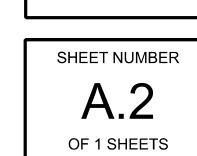

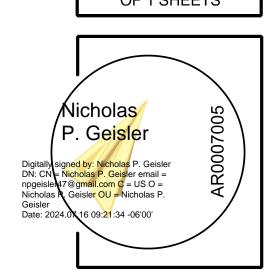

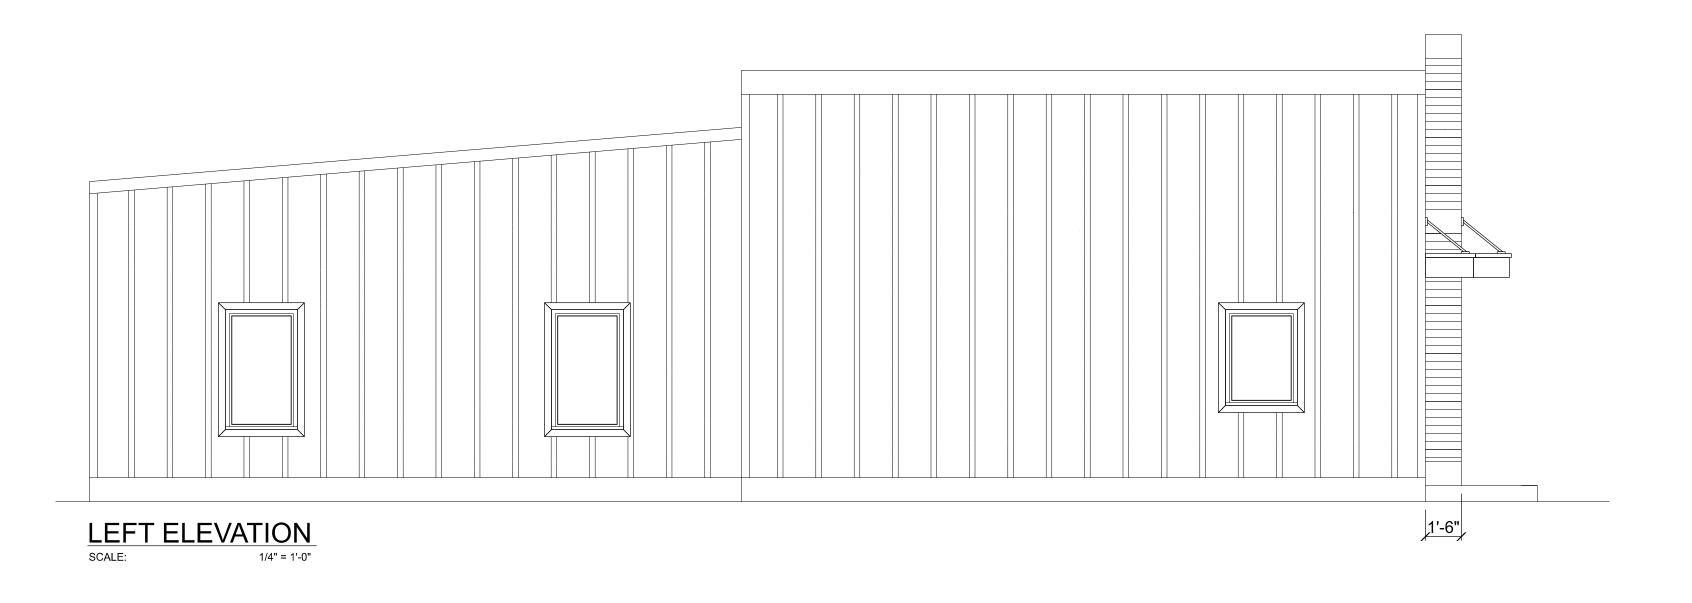



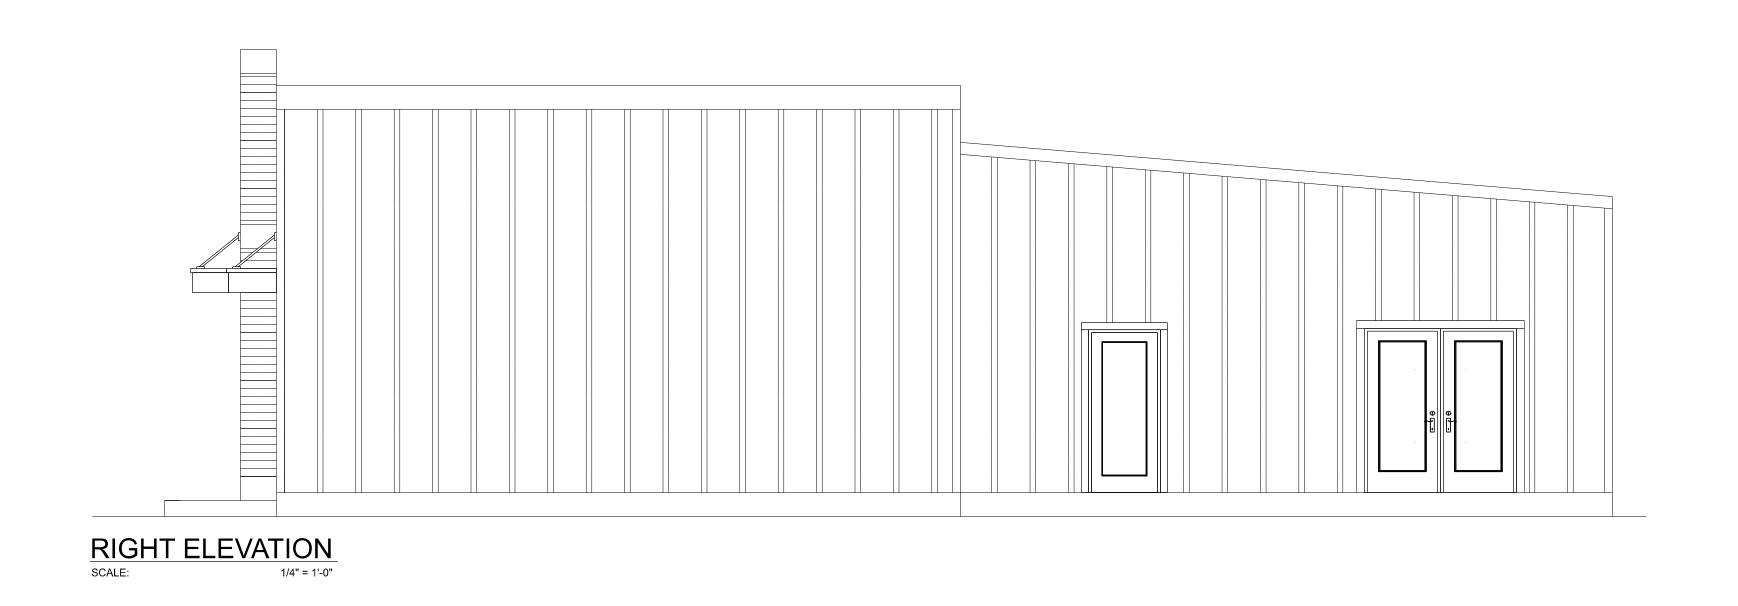

EXIT LIGHT - ARROW REPRESENTS DIRECTION OF EXIT

WALL HUNG "ABC" FIRE EXTINGUISHER

DOOR / CLOSWER FOR EXITING OR RATING REASONS

PRIMARY EGRESS W/ EXIT CAPACITY

SECONDARY EGRESS

EMERGENCY LIGHT W/ BATTERY BACKUP

EMERGENCY LIGHTING AND EXIT SIGNS, SHALL BE PROVIDED AS DIRECTED BY THE FIRE MARSHAL, AND SHALL BE WIRED PER NEC 700-12F


SMOKE DETECTORS SHALL BE MOUNTED NOT LESS THAN 90" ABOVE FINISHED FLOOR AND SHALL BE THE IONIZATION TYPE, INTERLOCKED TOGETHER, POWERED FROM EACH STORE PANEL W/ BATTERY BACKUP


EXIT ACCESS TRAVEL DISTANCE PER 2023 FBC TABLE 1006.2.1

OCCUPANCY - BUSINESS/OFFICE 150 FT. (WITHOUT SPRINKLER SYSTEM) 250 FT. (WITH SPRINKLER SYSTEM)

2023 FBC-BUILDING, TABLE 1004.5

MAXIMUM FLOOR AREA A	LLOWABLE PER OCC	CUPANT	
OCCUPANCY CLASSIFICATION	FLOOR AREA	OCCUPANCY BASIS	NUMBER OF OCCUPANTS
BUSINESS / OFFICE	1,141	@ 1/100 SF	12
ADDITION TOTALS	1,141		12

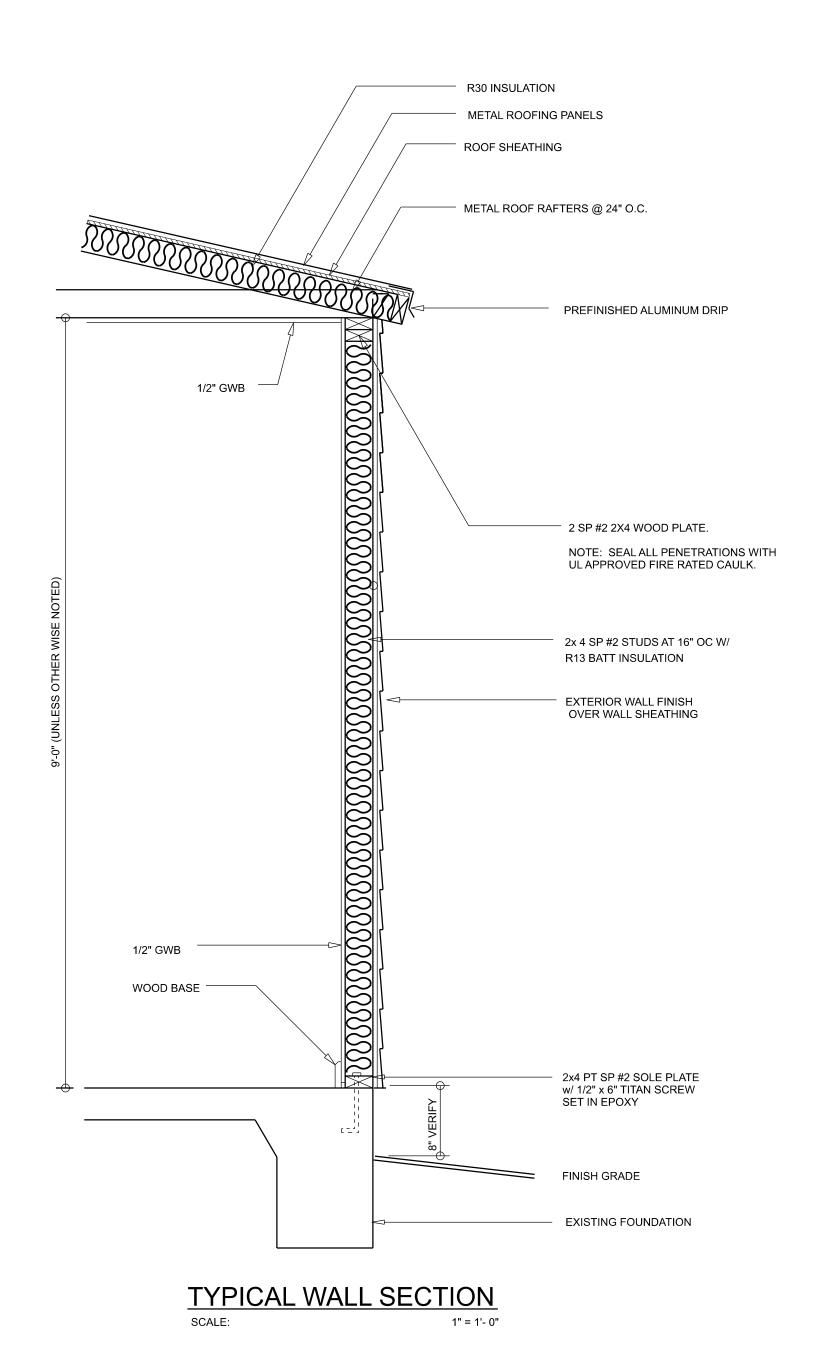


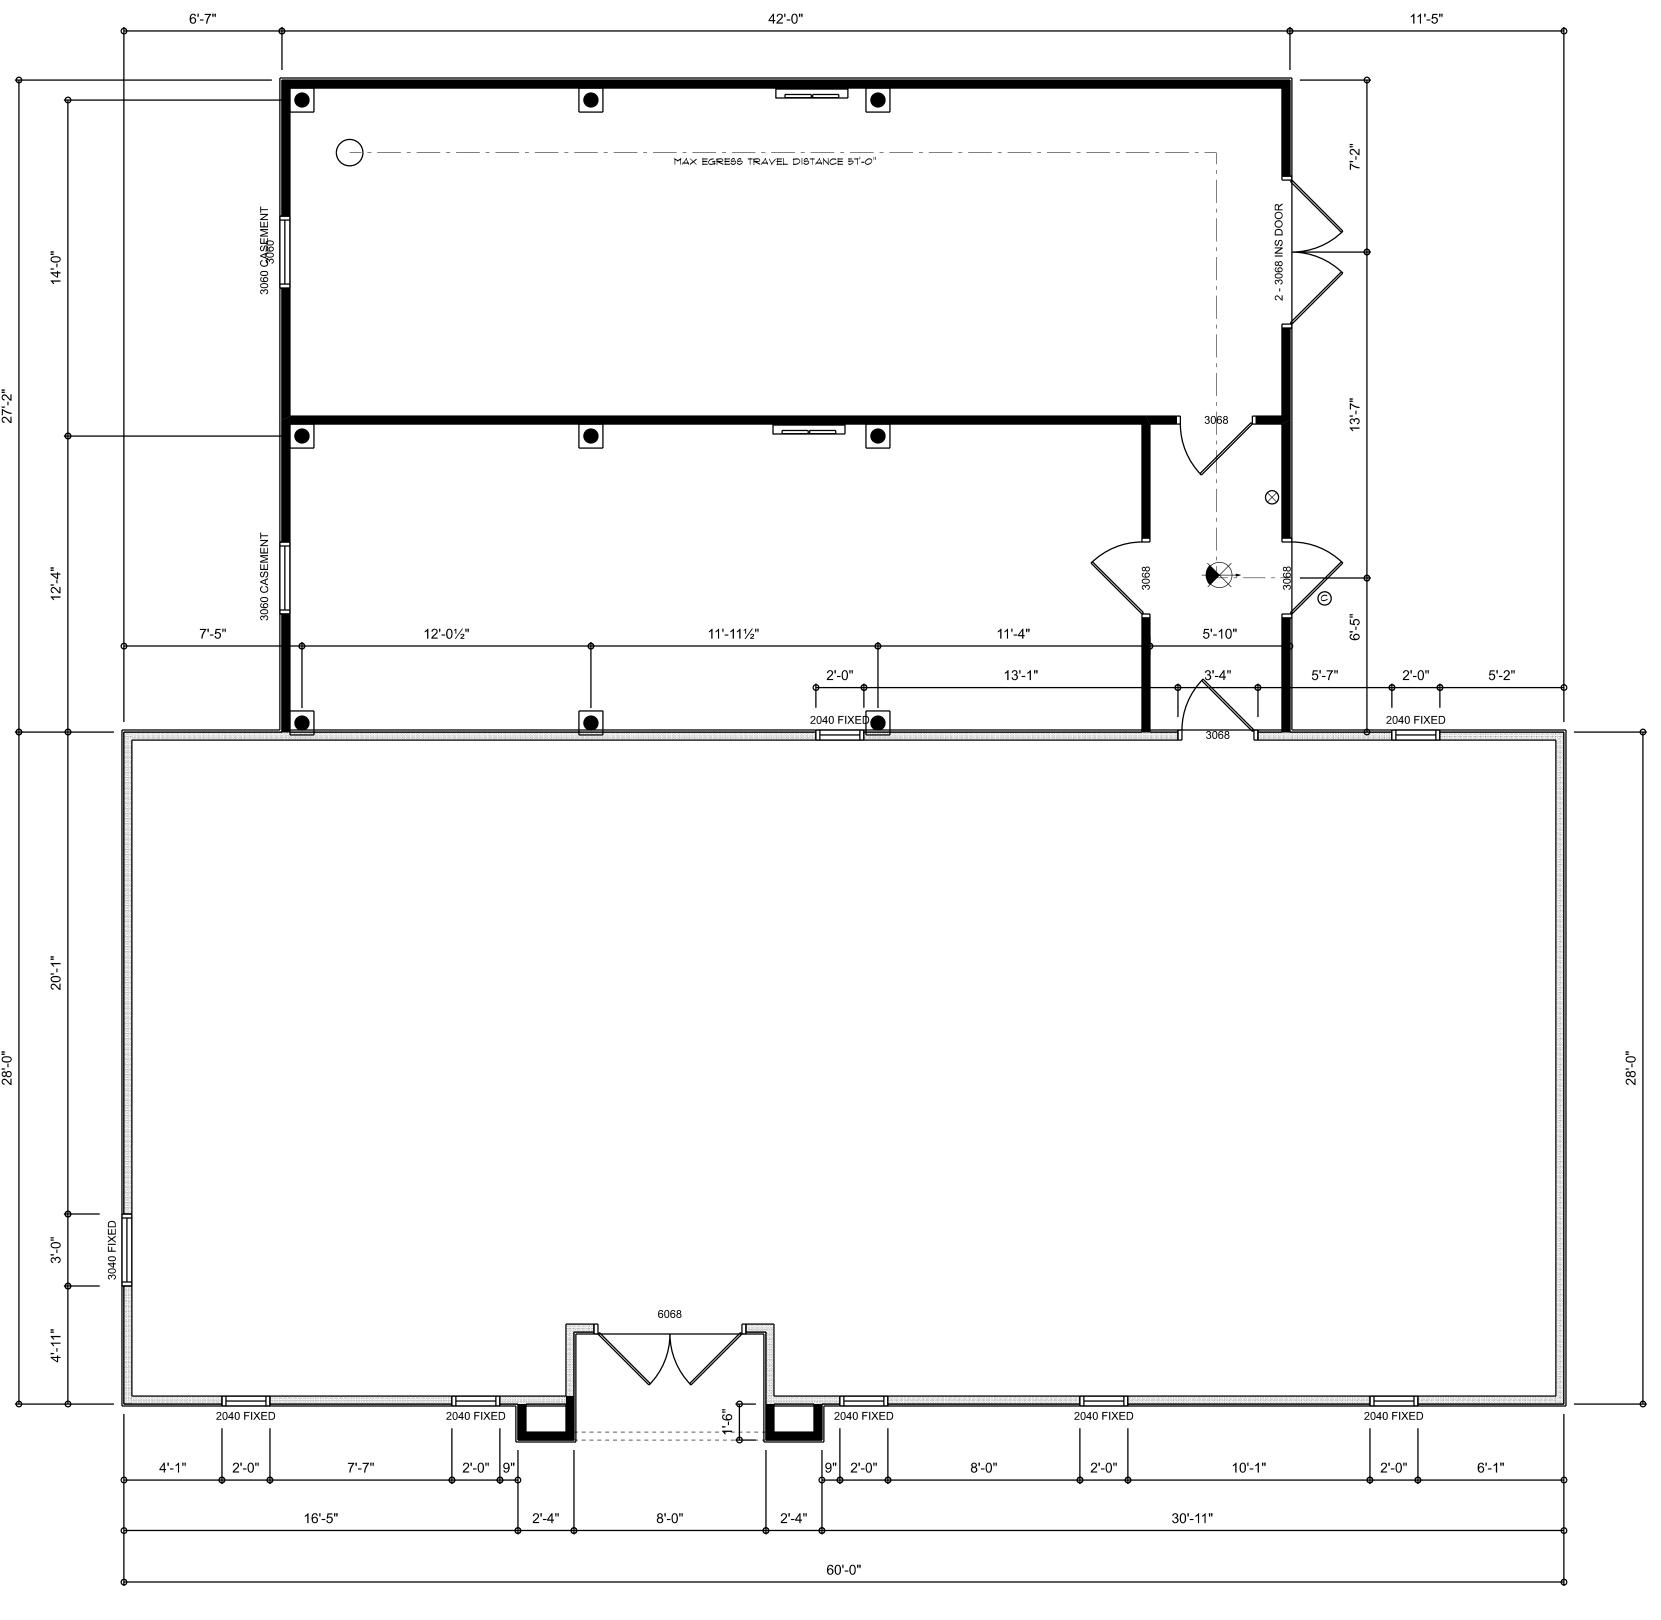


RENOVATED FLOOR & LIFE SAFETY PLAN
SCALE: 1/4" = 1'-0"


AREA SUMMARY

EXISTING CONDITIONED AREA 1,656 S.F. NEW ADDITION ENCLOSURE 1,141 S.F. TOTAL AREA 2,797 S.F. — UMB

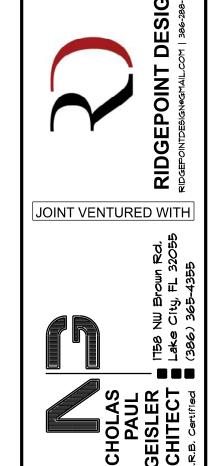


SHEET NUMBER OF 1 SHEETS

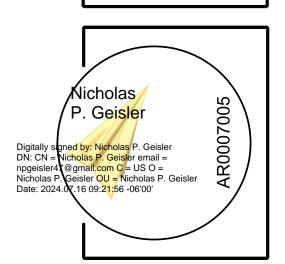


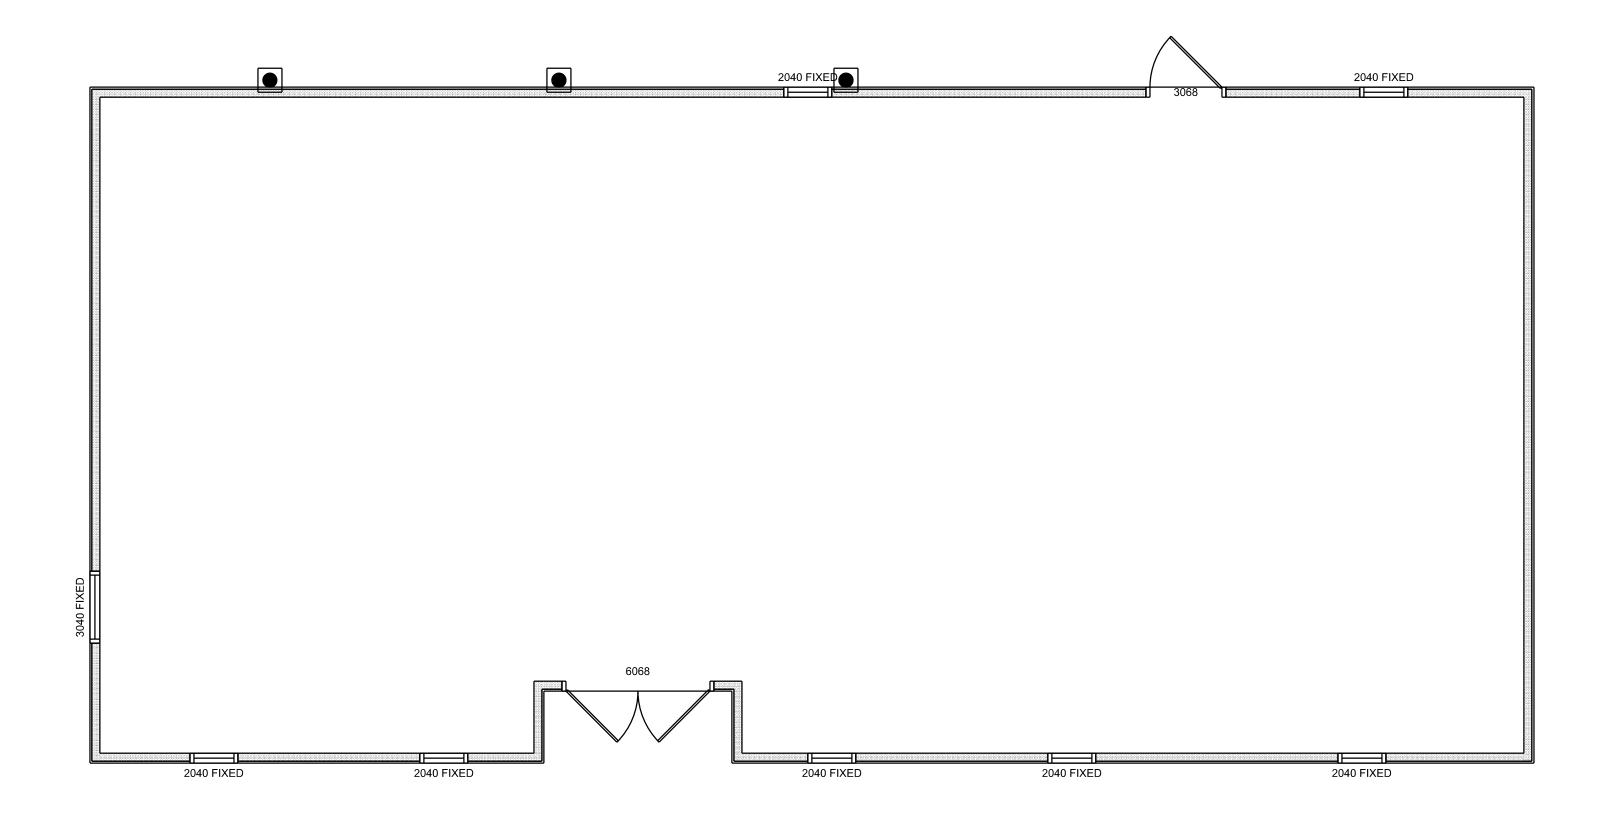


EXISTING FLOOR PLAN
SCALE: 1/4" = 1'-0"




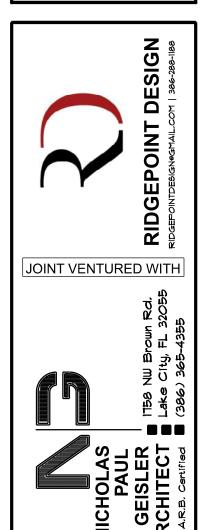

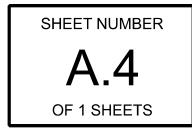

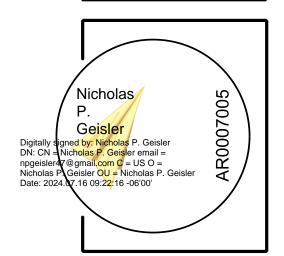

 $\mathbb{R} \quad \mathbb{Q}$

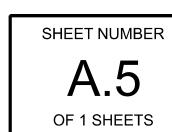

<i>,</i>	C. Geisler email = com C = US O = OU = Nicholas P.	AR0007005
Geisler		\overline{A}

ELEC	ΓRICAI	LEGEND	
CEILING FAN		CARBON DETECTOR	<u> </u>
		CAT6 OUTLET	T
		EXHAUST FAN	•
CAN LIGHT 6inch	0	OUTLET	ф
CHANDELIER	9 0	OUTLET 220v	₩
LED CEILING LIGHT 1x4		OUTLET GFI	Ø•
PENDANT LIGHT	0	OUTLET WP	مل
EXTERIOR SCONCE	0	SMOKE DETECTOR	•
MOTION SECURITY LIGHT	Φ	SWITCH	\$
AC DISCONNECT	<u> </u>	SWITCH 3 WAY	\$,
CABLE TV OUTLET	īv	VANITY BAR LIGHT - SMALL	000

ELECTRICAL PLAN NOTES:

INSTALLATION SHALL BE PER LATEST NAT'L ELECTRIC CODE.

WIRE ALL APPLIANCES, HYAC UNITS AND OTHER EQUIPMENT PER MANUF, SPECIFICATIONS

CONSULT WITH THE OWNER FOR THE NUMBER OF SEPERATE TELEPHONE LINES TO BE INSTALLED

ALL SMOKE DETECTORS SHALL BE 120V W/ BATTERY BACKUP OF THE PHOTOELECTRIC TYPE, AND SHALL BE INTERLOCKED TOGETHER. INSTALL INSIDE AND NEAR ALL BEDROOMS

TELEPHONE, TELEVISION AND OTHER LOW YOLTAGE DEVICES OR OUTLETS SHALL BE AS PER THE OWNER'S DIRECTIONS, & IN ACCORDANCE W/ APPLICABLE SECTIONS OF NEC-LATEST EDITION.


ELECTRICAL CONT'R SHALL PREPARE "AS-BUILT" SHOP
DWGS INDICATING ALL ELECTRICAL WORK, INCLUDING ANY
CHANGES TO THE ELEC. PLAN, ADD'NS TO THE ELEC. PLAN,
RISER DIAGRAM, AS-BUILT PANEL SCHEDULE W/ ALL CKTS
IDENTIFIED W/ CKT Nr. DESCRIPTION & BRKR, SERVICE ENT.
& ALL UNDERGROUND WIRE

LOCATIONS/ROUTING / DEPTH, RISER DIA, SHALL INCLUDE WIRE SIZES/TYPE & EQUIPMENT TYPE W/ RATINGS & LOADS,

CONTRACTOR SHALL PROVIDE I COPY OF AS-BUILT DWGS TO OWNER & I COPY TO THE PERMIT ISSUING AUTHORITY ALL RECEPTICALS, NOT OTHERWISE NOTED, SHALL BE ARC FAULT INTERRUPTER TYPE, EXCEPT DEDICATED OUTLETS

ALL RECEPTICALS IN WET AREAS SHALL BE GROUND FAULT INTERRUPTER TYPE (GFI)


ALL EXTERIOR RECEPTICALS SHALL BE WEATHERPROOF GROUD FAULT INTERRUPTER TYPE (WP/GFI)

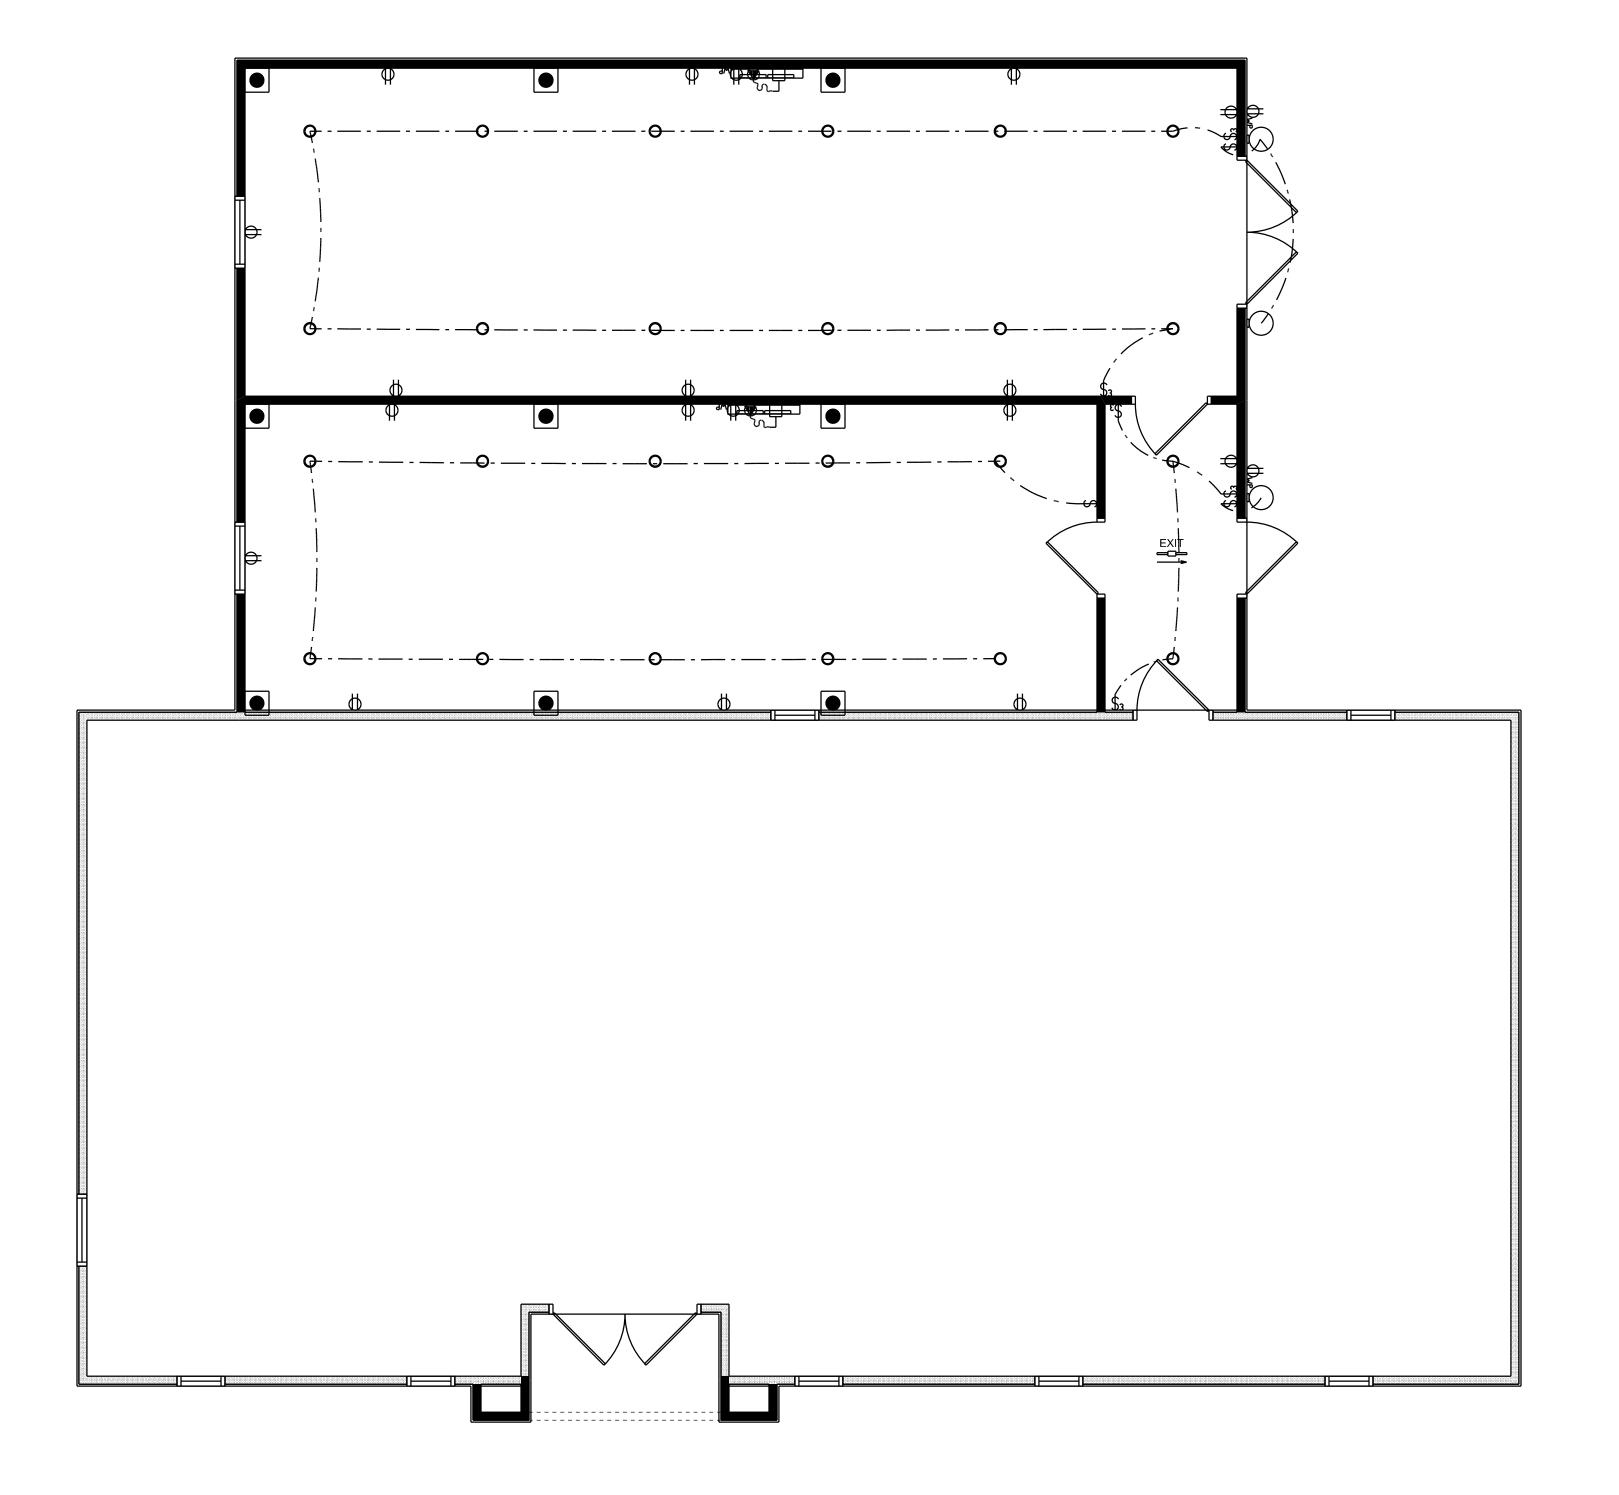


RENOVATED ELECTRICAL PLAN
SCALE: 1/4" = 1'-0"

SHEET NUMBER

OF 1 SHEETS

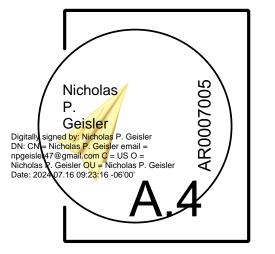

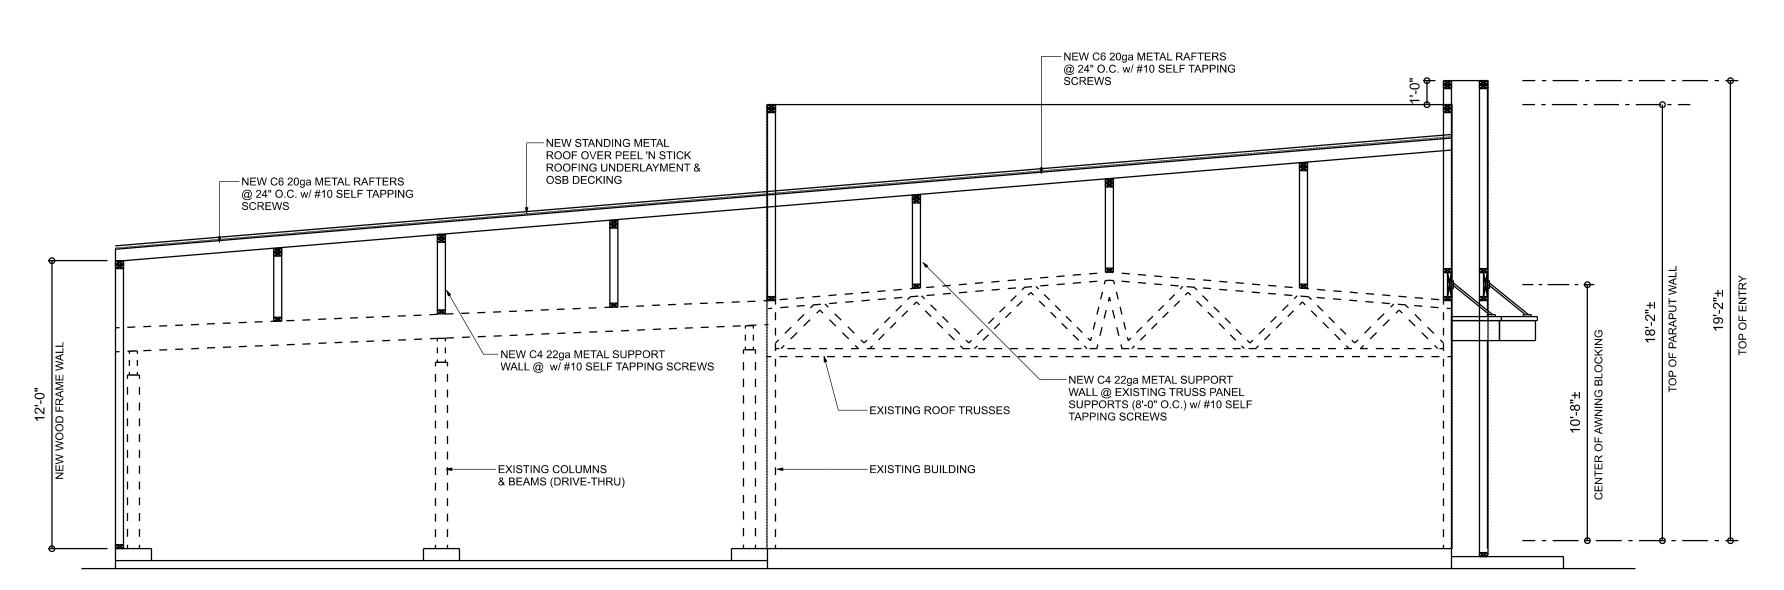

ROOF OVER CROSS SECTION

General Roofing NOTES:

DECK REQUIREMENTS: METAL PANELS MUST BE FASTENED TO 1x4 FURRING PURLINS OR 1/2" PLYWOOD

CAULKING: MUST BE APPROVED BY THE MANUFACTURER, BUTYL SEALANT SUPPLIED IN TAPE OR GUN-GRADE FORM.

METAL PANEL: METAL PANELS SHALL BE MIN. 29 GUAGE AND COMPLY WITH ASTM A-792 AND D 7-98

FASTENERS FOR METAL PANELS SHALL BE GALVANIZED

WOOD FAST SCREW, MINIMUM OF #9 imes 1 $1/2^{\circ}$ HEX HEAD. ATTACHMENT: METAL PANELS SHALL BE SECURED TO THE ROOF WITH NOT LESS THAN

24" O.C. WHERE ROOF IS LOCATED IN BASIC WIND SPEED OF 110 MPH OR GREATER, SPECIAL METHODS OF FASTENING ARE REQUIRED. UNLESS OTHERWISE NOTED, ATTACHMENT OF METAL PANELS SHALL CONFORM WITH ASTM E 330 OR PA 125.

BASE AND CAP FLASHINGS: BASE AND CAP FLASHING SHALL BE INSTALLED IN ACCORDANCE W/ MFGR'S

INSTALLATION INSTRUCTIONS. 1, RC-1 - RIDGE CAP

2. ED-1 - EAVE DRIP

3, EF-3 - EAVE FLASHING

4, SW-1 - SIDEWALL FLASHING 5. EW-1 - ENDWALL FLASHING

6. GR-4 - GABLE END OR RAKE BOARD FLASHING 7. TF-1 - TRANSITION FLASHING

8. PV-2 - PREFORMED VALLEY FLASHING

9. BUTYL TAPE 10, SEALANT TAPE UNDERLAYMENT SHALL BE A MINIMUM OF TWO LAYERS APPLIED AS FOLLOWS: 1. STARTING AT THE EAVE, A 19 INCH STRIP OF UNDERLAYMENT SHALL BE APPLIED PARALLEL WITH THE EAVE AND FASTENED SUFFICIENTLY TO

2. STARTING AT THE EAVE, 36 INCH WIDE STRIPS OF UNDERLAYMENT FELT SHALL BE APPLIED OVERLAPPING SUCCESSIVE SHEETS 13 INCHES AND FASTENED SUFFICIENTLY TO STAY IN PLACE.

BASE AND CAP FLASHING SHALL BE INSTALLED IN ACCORDANCE W/ MFGR'S INSTALLATION INSTRUCTIONS. BASE FLASHING SHALL BE EITHER CORROSION RESISTANT METAL OF MINIMUM NOMINAL THICKNESS 0.019 INCH OR MINERAL SURFACE ROLL ROOFING WEIGHING A MINIMUM OF 11 LBS PER 100 SQUARE FEET, CAP FLASHING SHALL BE CORROSION RESISTANT METAL OF MINIMUM NOMINAL THICKNESS OF 0.019 INCH.

ROOF SHEATHING NAILING ZONES

(GABLE ROOF)

STRUCTURAL DESIGN CRITERIA:

1. THE DESIGN COMPLIES WITH THE REQUIREMENTS OF THE 2023 FLORIDA, 8th EDITION BUILDING CODE - SECTION 1609 AND OTHER REFERENCED CODES AND SPECIFICATIONS, ALL CODES AND SPECIFICATIONS SHALL BE LATEST EDITION AT TIME OF PERMIT.

2. WIND LOAD CRITERIA: RISK CATAGORY: 2, EXPOSURE: "B"

BASED ON ANSI/ASCE 7-22. 2023 FBC 1609-A WIND VELOCITY: VULT = 130 MPH VASD = 101 MPH

3. ROOF DESIGN LOADS: SUPERIMPOSED DEAD LOADS: 20 PSF SUPERIMPOSED LIVE LOADS: 20 PSF 4. FLOOR DESIGN LOADS: SUPERIMPOSED DEAD LOADS: 25 PSF

SUPERIMPOSED LIVE LOADS:


RESIDENTIAL

BALCONIES 60 PSF 5. WIND NET UPLIFT: ARE AS INDICATED ON PLANS

4	BUILDING COMPONENTS & CLADDING LOADS THEAN BUILDING HEIGHT = 30.0', EXPOSURE "B" ROOF ANGLE TO 2TO									
27.	1 1 1	10 20 50	12.0 / -19.9 11.4 / -19.4 10.0 / -18.6	14.9 / -23.7 13.6 / -23.0 11.9 / -22.2	17.5 / -27.8 16.0 / -27.0 13.9 / -26.0	20.3 / -32.3 18.5 / -31.4 16.1 / -30.2				
7 7	2 2 2	10 20 50	12.5 / -34.7 11.4 / -31.9 10.0 / -28.2	14.9 / -41.3 13.6 / -38.0 11.9 / -33.6	17.5 / -48.4 16.0 / -44.6 13.9 / -39.4	20.3 / -56.2 18.5 / -51.7 16.1 / -45.7				
ROOF	3 3 3	<u>0</u> 0 0	12.5 / -51.3 11.4 /-47.9 10.0 / -43.5	14.9 / -61.0 13.6 / -57.1 11.9 / -51.8	17.5 / -71.6 16.0 / -67.0 13.9 / -60.8	20.3 / -83.1 18.5 / -TT.T 16.1 / -70.5				
MALL	4 4 4	<u>10</u> 20 50	21.8 / -23.6 20.8 / -22.6 19.5 / -21.3	25.9 / -34.7 24.7 / -26.9 23.2 / -25.4	30.4 / -33.0 29.0 / -31.6 27.2 / -29.8	35.3 / -38.2 33.7 / -36.7 31.6 / -34.6				
	5 5 5	10 20 50	21.8 / -29.1 20.8 / -27.2 19.5 / -24.6	25.9 / -34.7 24.7 / -32.4 23.2 / -29.3	30.4 /-40.7 29.0 / -38.0 27.2 / -34.3	35.3 / -47.2 33.7 / -44.0 31.6 / -39.8				

		DJUSTMENT CO NENTS & CLADI			
BLDG	EXPOSURE	EXPOSURE	EXPOSURE		
HEIGHT	"B"	"C"	"D"		
15	.82	1.21	1.47		
20	.89	1.29	1.55		
25	.94	1.35	1.61		
30	1.00	1.4 <i>O</i>	1.66		

	ALTERNA ⁻	TE FASTENET MANUFACTUT FOR BUILDING	-RIB METAL R SCHEDULE RER'S RECOMM 56 W/ 35 MEA 46ED ON ASCE	FOR VAI 1ENDED FAS N ROOF HEIG	RIOUS TENER S GHT, MIN	WIND VEL SCHEDULE 1. 3/12 PITCH	OCITIE	6	
DOOF FASTELIED		FASTENER PLACEMENT		100 - 11	0	120 - 13	0	140 - 15	,o
ROOF FASTENER ZONE TYPE	SIZE	TO	O/C SPACING	TRIM	O/C SPACING	TRIM	O/C SPACING	TRIM	
1	WD, SCREW	#9 × 1 1/2"	WOOD	36"	18"	24"	12"	24"	12"
	MTL, SCR,	#12 × 1" #14 × 7/8"	< 18 GA > 18 GA	36"	18"	24"	12"	24"	12"
2 4 3	WD, SCREW	#9 × 1 1/2"	WOOD	36"	<u>8</u>	24"	12"	24"	8"
	MTL, SCR,	#12 × 1" #14 × 7/8"	< 18 GA > 18 GA	36"	18"	24"	12"	24"	8"

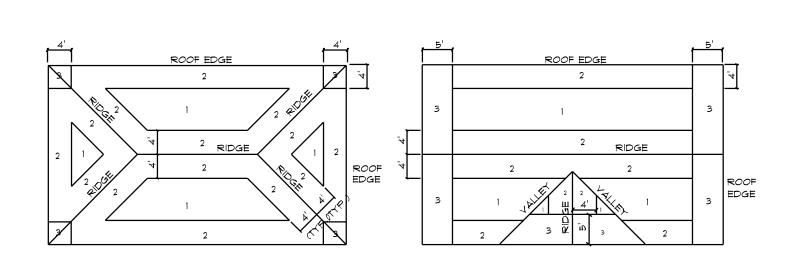

Roof Nail Pattern DET.

ROOF SHEATHING NAILING ZONES

(HIP ROOF)

SCALE: NONE

NEW ROOF PLAN

NEW C4 22ga METAL SUPPORT WALL @ EXISTING TRUSS PANEL SUPPOND (8'-0" O.C.) w/ #10' SELF

TAPPING SCREWS

- NEW C4 22ga METAL SUPPORT

TAPPING SCREWS

WALL @ EXISTING TRUSS PANEL SUPPORTS (8'-0" O.Cl.) w/ #10 \$ELF

NEW C6 20ga METAL RAFTERS @ 24" O.C. w/#10 SELF TAPPING SCREWS

NEW C6|20ga METAL RAFTERS @ 24" O.C. w/ #10 SELF TAPPING SCREWS

NEW C4 22ga METAL SUPPORT
WALL @ EXISTING TRUSS PANEL
SUPPORTS (8'-0" O.C.) w/ #10 SELF

TAPPING SCREWS