December 31, 2020

Mr. Thomas Campbell Florida Department of Business and Professional Regulation 2601 Blair Stone Road, Building C Tallahassee, Florida 32399-6563

RE: Plan Approval

**Graceland Portable Buildings** 

Plan # GPB LB-20

Dear Mr. Campbell,

Pursuant to the requirements of the Department of Business & Professional Regulation, the above referenced documents have been reviewed for compliance with:

2020 Florida Building Code, 7th Edition 2017 National Electrical Code (NFPA-70) Florida Product Approval Rule 61G20-3.006 (FAC)

All mandatory comments have been satisfied and plans are approved for construction by a currently approved modular building manufacturer.

These documents were reviewed for only what is to be constructed in the factory. Any work performed at the site, such as the foundation, is under the authority and jurisdiction of the local Building Official.

Third Party Agency approval in no way alleviates the builder/manufacturer from complying with all the applicable codes, which may or may not be identified in this review. Approval also does not preclude the local building official from requiring work be performed that was not previously reviewed, approved, and constructed under the State of Florida's Manufactured (Modular) Building Program to make the building, code compliant, for the intended use.

A signed and sealed set of plans are maintained on file with Top Line Engineering, LLC.

If you require my assistance in any way, please do not hesitate to contact me.

Thank you.

Respectfully,

William E. Neary,(I) Business Partner

Top Line Engineering, LLC

BILL.TLE@vahoo.com

\*\*\* Please note: Any questions regarding local permitting should be directed to the Manufacturer. The Manufacturer's contact information can be found in the title block of the plans.

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|  | SQUARE FOOTAGE 719 SQ-FT |  | "R" RATING OF FLOOR, WALL, R-0, R-0, R-0 | ROOF LIVE LOAD/DEAD LOAD 20PSF/10PSF | FLOOR LIVE LOAD/DEAD LOAD 40PSF/10PSF | FIRE RATING OF EXTERIOR O HOUR | WIND VELOCITY 150 MPH - EXPOSURE: C 3 SECOND GUST | ALLOWABLE # OF STORIES 1 | OCCUPANCY | FIRE SUPPRESSION SYSTEM NO | FIRE PROTECTION B | CONSTRUCTION TYPE V-B | AGENCY PLAN NUMBER LB-2020 | AGENCY TOP LINE ENGINEERING, LLC | MANUFACTURER GRACELAND PORTABLE BUILDINGS | BUILDING TYPE RESIDENTIAL LAWN STORAGE | CODE (NFPA-70 | NONO - COL |
|--|--------------------------|--|--|--------------------------------------|---------------------------------------|--------------------------------|---|--------------------------|-----------|----------------------------|-------------------|-----------------------|----------------------------|----------------------------------|---|--|---------------|------------|
|--|--------------------------|--|--|--------------------------------------|---------------------------------------|--------------------------------|---|--------------------------|-----------|----------------------------|-------------------|-----------------------|----------------------------|----------------------------------|---|--|---------------|------------|

- FOUNDATION PLANS ARE NOT PART OF THIS PLAN SET AND ARE GOVERNED BY LOCAL JURISDICTION.
- BUILDINGS ARE APPROVED FOR RESIDENTIAL LAWN STORAGE ONLY.
- THIS BUILDING IS EXEMPT FROM THE FECC PER SECTIONS R101.4.2.4, R402.1.
- 5. ALL LUMBER FO EXCEPT AS NOTED.
- ALL WINDOWS AND DOORS TO MEET THE MINIMUM SPECIFICATIONS PER THE APPROVED PLANS AND THE FLORIDA BUILDING CODE.

4. REFER TO TIE DOWN DETAILS INSTALLATION REQUIREMENTS TO MEET CODE.

LUMBER FOR CONSTRUCTION WILL BE #2 SYP

GUTTERS SHALL BE SITE INSTALLED PER LOCAL AUTHORITY HAVING JURISDICTION AND PERMITTING REQUIREMENTS. 굶

HEDS THAT ARE NOT DESIGNED FOR HUMAN
ABITATION AND THAT HAVE A FLOOR AREA OF 720
GUARE FEET OR LESS AR NOT REQUIRED TO COMPLY
ITH THE MANDATORY WINDBORNE DEBRIS IMPACT TANDARDS OF THIS CODE" IN ACCORDANCE WITH FBC 1609.1.2, "STORAGE

10.), BUILDINGS THAT ARE 400 SQ FT OR LESS AND HAT ARE INTENDED FOR USE IN CONJUCTION WITH NE- AND TWO-FAMILY RESIDENCES ARE NOT UBJECT TO THE DOOR HEIGHT AND WIDTH EQUIREMENTS OF THIS CODE. STRUCTURES 400 RQ-FT OR MORE SHALL HAVE AN 80" MINIMUM DOOR.

O. IN ACCORDANCE WITH FLORIDA STATUTE 553.80 1)D, LAWN STORAGE BUILDINGS AND STORAGE SHEDS EARING THE INSIGNIA OF APPROVAL OF THE EPARTMENT ARE NOT SUBJECT TO 553.842 (FLORIDA PRODUCT APPROVALS) BUT SHALL MEET THE DESIGN INDICIOAD REQUIREMENTS OF THE 2020 FBC 7TH

11. FLAT METAL SCRAPS CAN BE BENT AROUND STRUCTURAL MEMBERS OF WALL STUDS, TRUSSES, CHORDS, ETC. TO HELP SECURE THESE MEMBERS, PROVIDED THAT THE ADDED BEND DOES NOT INTERFERE WITH ANY OF THE EXISTING BREAKS/BENDS IN THE STRAP.

12. AS PER FBC SECTION 1626.1 EXCEPTION (F): STORAGE SHEDS THAT ARE NOT DESIGNED FOR HUMAN HABITATION AND THAT HAVE A FLOOR AREA OF LESS THAN 720 SQUARE FEET OR LESS ARE NOT REQUIRED TO COMPLY WITH THE MANDATORY WINDBORNE DEBRIS IMPACT STANDARDS OF THIS CODE.

H 3. COMPONENTS/CLADDING ARE IN COMPLIANCE WITH 2020 FBC 7TH EDITION.

14. SHEDS LOCATED IN FLOOD HAZARD AREAS MUST COMPLY WITHT HE LOCAL FLOOD ZONE REGULATIONS.

15. IF A WALL IS FRAMED FOR FUTURE HVAC UNITS THAT SHALL BE APPROVED BY THE AHJ AND SHALL COMPLY WITH LOCAL REQUIREMENTS FOR PERMITTING.

16. WINDOWS AND DOORS INSTALLED BY THE CUSTOMER THAT SHALL BE APPROVED BY THE AHJ AND SHALL COMPLY WITH LOCAL REQUIREMENTS FOR PERMITTING.

17. HVHZ COMPONENTS FOR SHEDS REQUIRE THAT INSTALLATION BE PER MANUFACTURER'S INSTRUCTIONS.

18. STRUCTURES ARE DESIGNED FOR LOCATIONS A SURFACE ROUGHNESS CATEGORY B AND A TOPOGRAPHICAL FACTOR OF 1.0. STRUCTURES SHOULD NOT BE USED IN OTHER LOCATIONS.

SHINGLES. STRUCTURES SHOULD HAVE METAL ROOF OR OPTIONAL 25 YEAR RATED FIBERGLASS/ASPHALT

20. ALL STUDS, RAFTERS, COLLAR TIES, AND TRUSS CHORDS ARE SPF #2, U.N.O.

21. ALL EXTERIOR WOOD IS TREATED.

23. ALL SIDING DURATEMP. S TO BE %" P.T. T-III PLYWOOD

24. ALL FLOOR JOISTS ARE TO BE P.T. SYP #2.

GALVANIZED. 25. ALL EXTERIOR NAILS ARE TO BE HOT DIPPED

AZ

ENGINEER

SHALL NOT BE SCALED FOR

22. ALL ROOF DECKING IS TO

S-1-LB S-1-LB S-1-LB S-1-LB S-1-LB S-1-LB S-1-LB S-1-LB S-1-LB

UPLIFT ANCHORAGE (NOT USED) FOUNDATION PLAN (NOT USED) GENERAL NOTES (CONT. COVER SHEET

27. ALL SKIDS ARE TO BE 4x6 P.T. SYP, RATED FOR GROUND CONTACT.

TO RESIST

29. NO FIELD SUPERVISION OR CONSTRUCTION ADMINISTRATION HAS BEEN PROVIDED BY THE

DRAWINGS

31. DIFFERENTIAL PRESSURE: WINDOWS & DOORS = +/-25PSF

MIT

8' WIDTH 8'x12'

14'x24

4'x28'

\*NOTE:(13'-0 ACTUAL)

10'x12'

BUILDING

SIZES:

TO BE PRESSURE

12'x20' 12'x24' 12'x28' 12'x32' 12'x40'

Commbia

for Code Samerae Plan

Department

\*\*NOTE:(11'-2 ACTU 12" WIDTH\*\* 10'x16' IO' WIDTH

BE %" O.S.B.

SR

S-0-LB -

INDEX OF SHEETS

Jors of Aorida

26. ALL FLOOR DECKING IS TO BE %" P.T. PLYWOOD.

S-B-LB

DETAILS NAIL PATTERN DETAILS FRAMING PLAN
BUILDING SECTIONS
ELEVATIONS

29. THE STRUCTURE HAS BEEN DESIGNED TO RESIST LOADS AS A COMPLETED STRUCTURE ONLY.
APPLICATION OF CONSTRUCTION LOADS TO THE PARTIALLY COMPLETED STRUCTURE SHALL BE CONSIDERED BY THE CONTRACTOR AND INCLUDED IN THE DESIGN OF SHORING, BRACING, FORM WORK, AN OTHER SUPPORTING ELEMENTS PROVIDED FOR CONSTRUCTION OF THE STRUCTURE.

DIMENSIONS.

NOT APPROVED FOR HVHZ

TEMS BY OTHERS:

THE FOLLOWING ITEMS ARE NOT PROVIDED BY RAILROAD CONSULTANTS, PLLC AND ARE TO BE DESIGNED BY OTHERS IF APPLICABLE AND ARE TO BE SUPPLIED AND INSTALLED BY OTHERS. THESE ITEMS MAY BE SUBJECT TO LOCAL JURISDICTION APPROVAL. RAILROAD CONSULTANTS, PLLC IS NOT RESPONSIBLE THESE ITEMS.

1. RAMPS, STAIRS, AND GENERAL ACCESS

\*\*\* Please note: Any questions regarding local permitting should be directed to the Manufacturer The Manufacturer's confact information can be found in the little block of the plans.

## STATE . Surge Killing

SHEET APPROVAL STAMP

TET TOT LINE DESIGNATION TO SMP-S1, SMI-79, ICC 5185040 10549 Oskview Pointe Terrace Gotha, Florida 34734 William E. Neary, III

SAPETIONS SACRETURES RAILROAD CONSULTANTS, PLLC MURFREESBORO, TN 37129 PHONE: (615) 663-1142 213 UPTOWN SQUARE

CEACE AND

--V=150

PHONE: (888) 472-2304 267 RELIHAN STREET PEARSON, GA 31642 BUILDINGS, LLC

GRACELAND PORTABLE DATE REVISION:

PROJECT NO: 4061001FL SHEET NUMBER DRAWN BY: CHECKED BY: DBG 8 PMG 12-22-20 SCALE: 1/4"=1'-0 S-0-L

2020-12-3) TOP LINE ENGINEERING APPROVAL PLAN # GPB LB-20 \*\*\* NOT HVHZ APPROVED

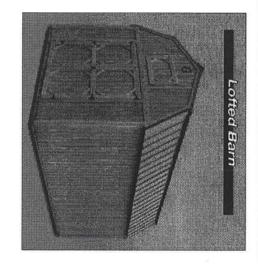


### GENERAL NOTES (CONT.)

32. HARDIE OR LP LAP SIDE OR EQUAL (8-1/4", 7" EXPORSURE/REVEAL) INSTALLED OVER 7/16" OSB ARE ACCEPTABLE ALTERNATES TO THE ORIGINAL DESIGN FOR ALL STRUCTURES AND THEY MEET OR EXCEED ALL APPLICABLE BUILDING CODES.

# DESIGN CRITERIA:

- DEAD LOADS: LOFT: 5 PSF
- LIVE LOADS: LOFT: 10 PSF
- SNOW LOADS: GROUND SNOW LOAD, Pg=25psf
  FLAT ROOF SNOW LOAD, Pf=20psf
  SNOW EXPOSURE FACTOR, Ce=1.2
  SNOW LOAD IMPORTANCE FACTOR, I=0.8
  THERMAL FACTOR, Ct=1.2
- BASIC WIND SPEED, V=150 MPH
  RISK CATEGORY = |
  WIND EXPOSURE B
  C&C ROOF-ZONE 1=23.3, -37.0 psf
  C&C ROOF-ZONE 2=23.3, -95.4 psf
  C&C ROOF-ZONE 3=23.3, -95.4 psf
  C&C ROOF-ZONE 4=40.5, -43.9 psf
  C&C WALL-ZONE 5=40.5, -54.2 psf WIND LOADS:
- 5. SEISMIC LOADS: THIS STRUCTURE IS EXEMPT FROM SEISMIC DESIGN PER EXEMPTION 3 OF ASCE 7-16, SECTION 11.1.2



# NOT APPROVED FOR HVHZ

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SHEET APPROVAL STAMP

William E. Neary, III SMP-51, SMI-79, ICC 5185040 10649 Oskview Points Terrace

TETOCHECONOMINATION OF

Gotha, Florida 34734



RAILROAD CONSULTANTS, PLLC MURFREESBORO, TN 37129 PHONE: (615) 663-1142 213 UPTOWN SQUARE

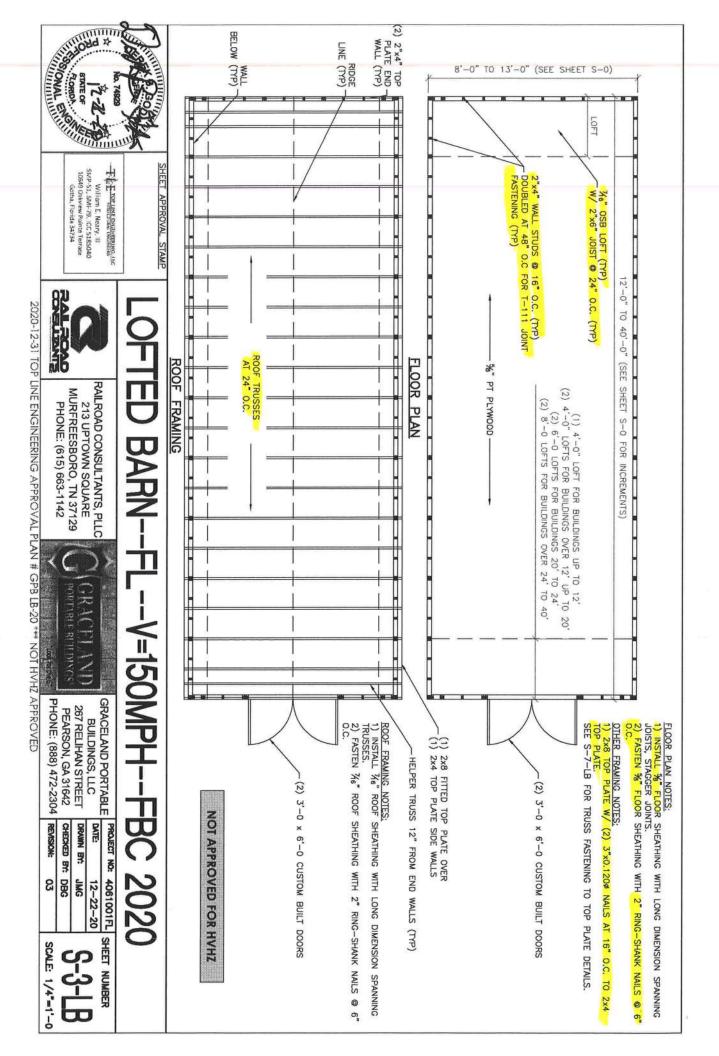
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GRACELAND PORTABLE 267 RELIHAN STREET PEARSON, GA 31642 BUILDINGS, LLC

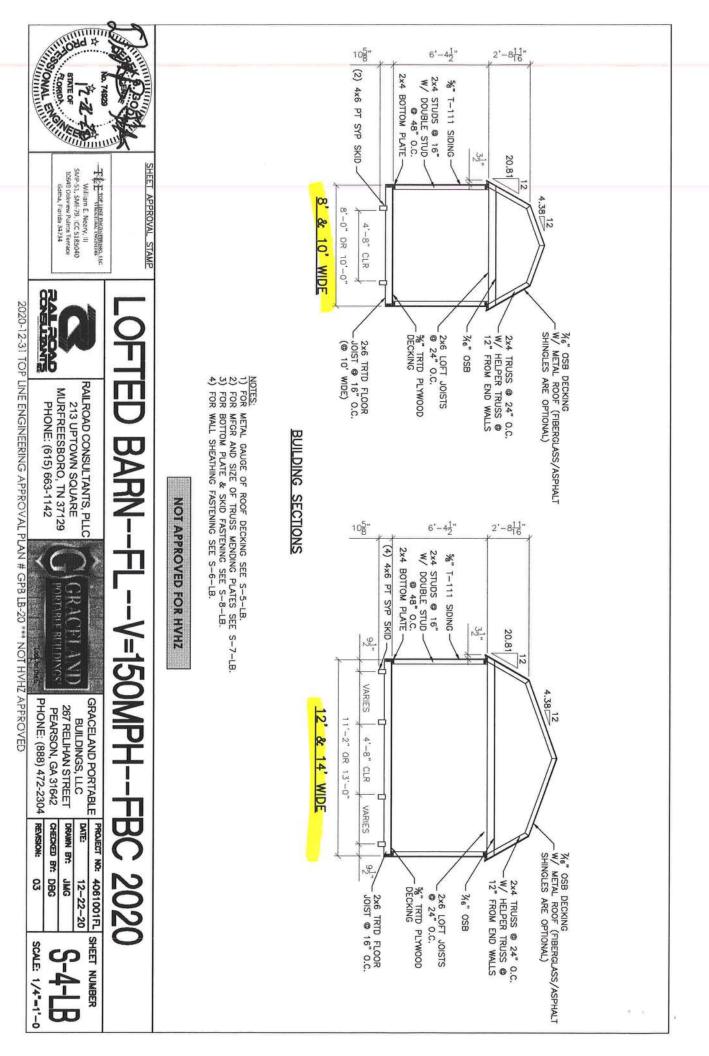
PHONE: (888) 472-2304 REVISION:

DATE CHECKED BY: DBG DRAWN BY: ខ JMG 12-22-20

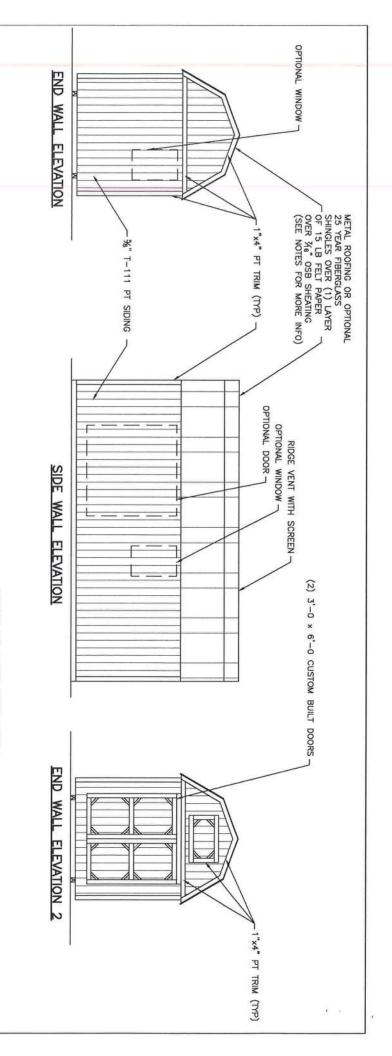
PROJECT NO: 4061001FL SHEET NUMBER S-OA-LB SCALE: 1/4"=1"-0



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SHEET APPROVAL STAMP

- ROOFING AND UNDERLAYMENT NOTES:

  1) PROVIDE A RIDGE VENT TYPICAL WITH INSECT SCREEN.

  2) METAL ROOFING SHALL BE 29 GAUGE METAL IN ACCORDANCE WITH ASTM A 924 OR ASTM A
- 924M OVER OSB SHEATHING.
  3) PROVIDE 29 GAUGE RIDGE CAP, EAVE TRIM AND RAKE TRIM.
  4) INSTALL AND FASTEN METAL ROOFING PER MANUFACTURER'S INSTRUCTIONS FOR WIND LOADING.
  5) OPTIONAL SHINGLES SHALL BE IN ACCORDANCE WITH ASTM D 7158 TYPE H OR ASTM D 3161F
- 6) INSTALL 1 LAYER OF 15 LB ROOFING FELT, START WITH A 19" WIDE STRIP PARALLEL WITH AND STARTING AT EAVES FASTENED SECURELY TO HOLD IN PLACE. START AT EAVE WITH A 38" WIDE SHEET WITH OVERLAPPING SUCCESSIVE SHEETS BY 19". FASTEN UNDERLAYMENT WITH CORROSION-RESISTANT FASTENERS PER MAUFACTURER'S INSTRUCTIONS AND SPACED A MAXIMUM OF 36" APART.

  7) FASTEN 1"×4" PT TRIM W/ (2) Bd NAILS @ 24" O.C.

ED BARN--FL--V=150MPH

# TET TOT HIME ENGINEERING, INC. William E. Neary, ili SMP-51, SMI-79, ICC 5185040 10549 Onkview Pointe Terrace Gotha, Florida 34734 RAILROAD CONSULTANTS, PLLC

A PROPERTY

213 UPTOWN SQUARE MURFREESBORO, TN 37129 PHONE: (615) 663-1142



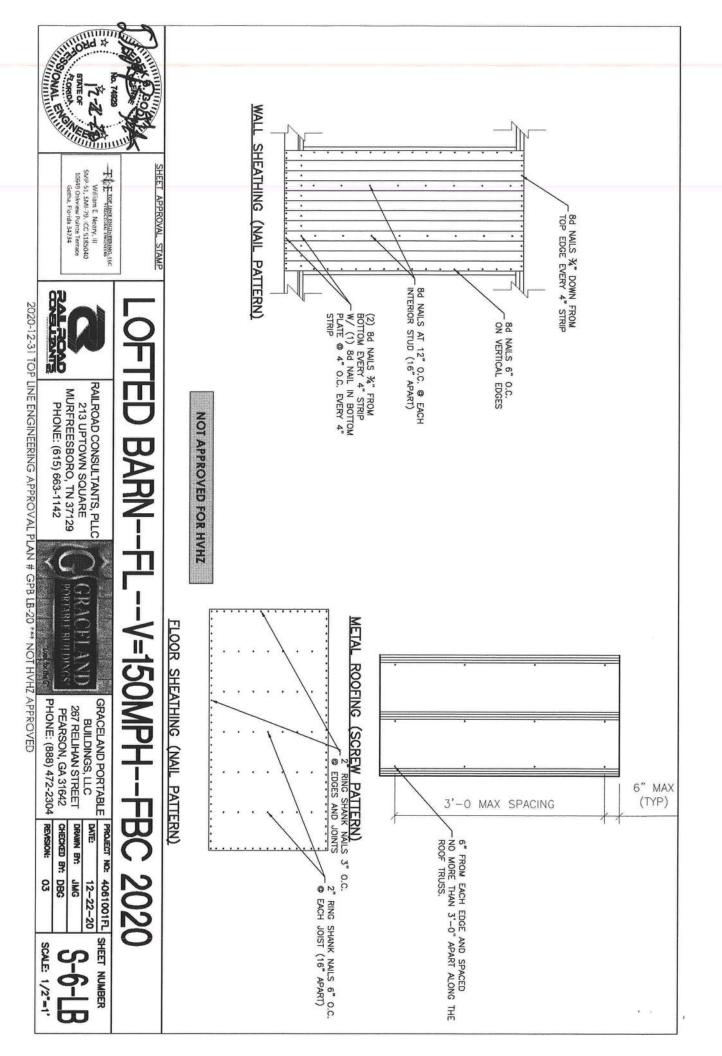
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GRACELAND PORTABLE BUILDINGS, LLC DATE CHECKED BY: DBG DRAWN BY: PMG

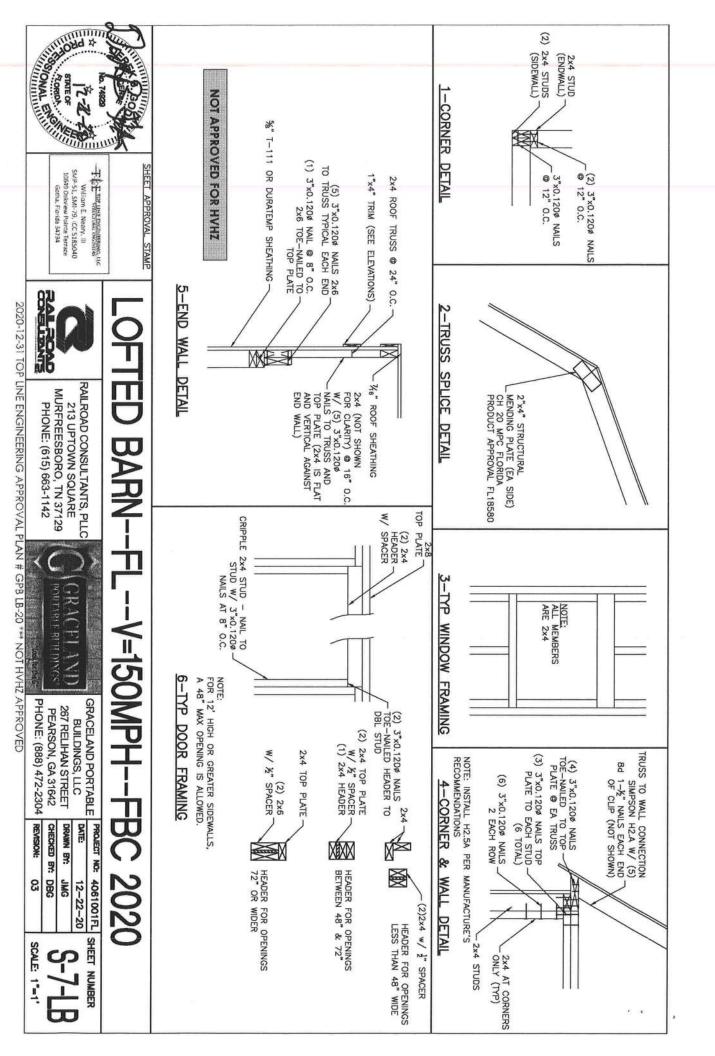
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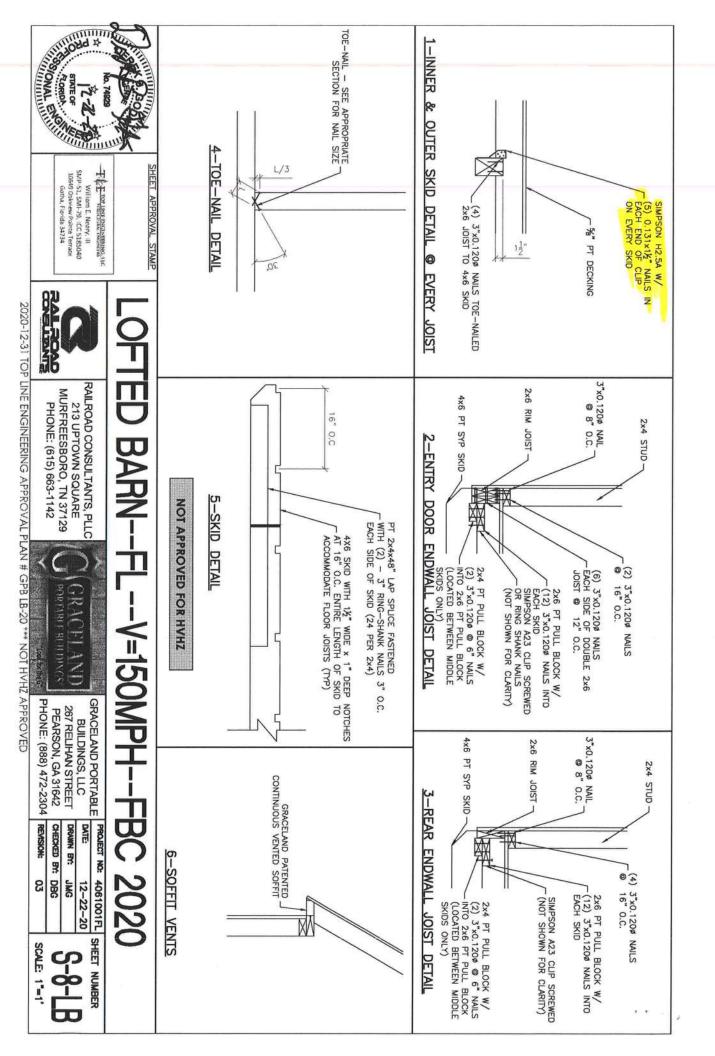
2020-12-31 TOP LINE ENGINEERING APPROVAL PLAN # GPB LB-20 \*\*\* NOT HVHZ APPROVED



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