

0 0 0 0 0 0

0 0 0 0 0 0

0 0 0 0 0 0 0

0000000

NOTE:

SHEATHING ON BOTH SIDES

DOUBLES THE EFFECTIVE

SHEARWALL LENGTH

NAIL ENTIRE

CORNER ZONE AT

3" O.C. BOTH WAYS

CORNER SHEATHING

(SINGLE PIECE) DETAIL

All-Thread Shear Wall DETAILS

SCALE: NONE

APPLY VERTICALLY, "WindSTORM" 7/16" OSB 48" X 97", 109", 121" OR 145"

SHEATHING, FASTEN TO THE TOP PLATE AND THE SILL PLATE WITH EITHER

6d COMMON NAILS # 3" O.C. OR 8d COMMON NAILS # 4" O.C. FASTEN TO

EACH STUD WITH EITHER 6d COMMON NAILS . 6" O.C. OR 8d COMMON

DOUBLE

TOP PLATE -

GDO HEADER,

PER PLAN

WALL SHEATHING

BOTH SIDES OF WALL W/ 8d NAILS @ 3" O.C.

ALONG ALL EDGES

(2) 4800 Ib CAPACITY

ANCHORS, EACH END

- 5/8"~ ALL-THREAD

ROD W/ EPOXY

(4) 2×4 MINIMUM

- DOUBLE P.T.


BOTTOM

PLATE

SCALE: 1/2" = 1'-0"

EXTERIOR WALL SHEATHING:

NAILS . B" O.C.

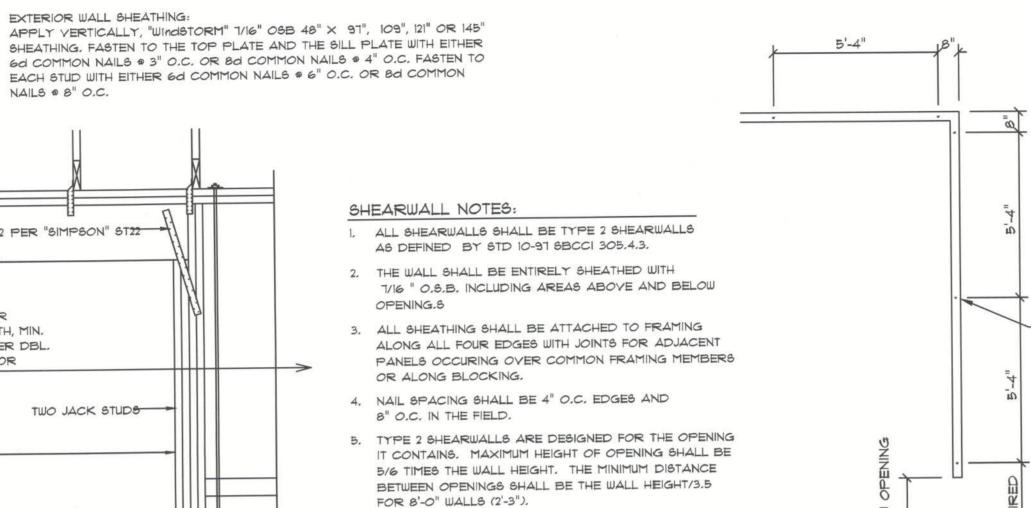

PLATES

(1) 2x4 OR (1) 2x6

(3) 2x4 OR (1) 2x6

> 9' TO 12'-0" (5) 2x4 OR (2) 2x6

OPENING WIDTH

UP TO 6'-0" > 6' TO 9'-0" 16d TOE NAILS

EACH END

PROVIDE 5/8"~ A-301 ALL-THREAD ROD WITH 5" EMBEDMENT IN SLAB, EXTENDING TO THE TOP PLATE, WITH $2" \times 2" \times 1/8"$ SQ. WASHERS FOR ALL LOADS UPTO 1.5K OR 3" X 3" X 1/8" WASHERS FOR LOADS UP TO 3.75K PLACE RODS PER DIAGRAM: WITHIN 8" OF CORNERS, ALONG SIDE OF WALL OPENINGS AND AT 64" O.C., MAXIMUM ALONG ALL WALL RUNS. PLACE ALL-THREAD ROD IN CURED

CONCRETE SLAB, IN DRILLED 3/4"~ X 5" HOLES, CLEARED OF ALL CHIPS AND DUST, SET WITH "SIMPSON" 2-PART EPOXY "SET"

All-Thread Wall Tie-Down PLAN SCALE: NONE

CONSTRUCTION NOTES


- 1. FIELD YERIFY ALL DIMENSIONS AND MATERIALS. ALL OUTSIDE DIMENSIONS ARE TO FACE OF STEMWALL
- 2. ALL NAILING CONSTRUCTION MATERIALS SHALL BE AS PER 2004 FBC - SEE SD.1
- 3. PROVIDE EXTERIOR COMBUSTION AIR TO GAS FIRED H.Y.A.C. EQUIPMENT, WOOD BURNING STOVES, AND
- FIREPLACES. 4. VENT CLOTHES DRYER, BATH, AND COOKING FANS TO
- EXTERIOR AS REQUIRED. 5. CONTRACTOR SHALL CALL ATTENTION TO THE DESIGNER, ANY DISCREPANCIES IN DRAWINGS AND/OR SPECIFICATIONS AND SHALL RECEIVE INSTRUCTIONS OR CLEARIFACATIONS

BEFORE PROCEEDING WITH THE PORTION OF THE WORK IN


- 6. ROOF & FLOOR TRUSS FRAMING PLANS ARE FOR GENERAL INFORMATION ONLY. THE TRUSS MANUFACTURER SHALL PROVIDE A DETAILED LAYOUT FOR TRUSS AND FRAMING
- 7. SHOULD CONDITIONS AT THE SITE BE FOUND MATERIALLY DIFFERENT FROM THOSE INDICATED BY THE DRAWINGS AND/OR SPECIFICATIONS, AND THE CONDITIONS USUALLY INHERENT IN THE WORK OF THE CHARACTER SHOWN AND SPECIFIED BE DIFFERENT FROM THE DESIGNERS RECOMMENDED BUILDING PROCEDURES: CALL IMMEDIATE ATTENTION TO SUCH CONDITIONS BEFORE PROCEEDING.
- 8. LP GAS-BURNING APPLIANCES ARE NOT PERMITTED IN BASEMENTS OR CRAWLSPACES.
- 9. DO NOT SCALE DRAWINGS, USE PRINTED DIMENSIONS ONLY.

9 16" O.C.


WALL CORNER WALL INTERSECTION

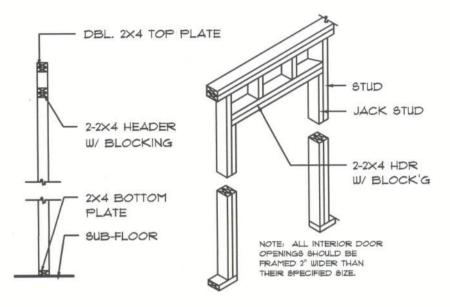

NON-BEARING WALL HEADER

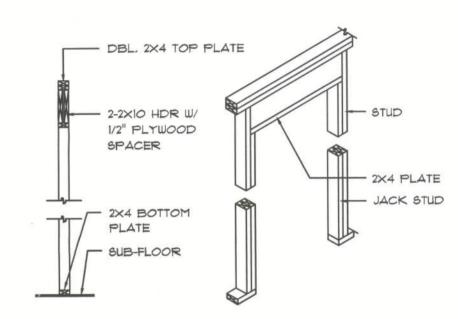

BEARING WALL HEADER

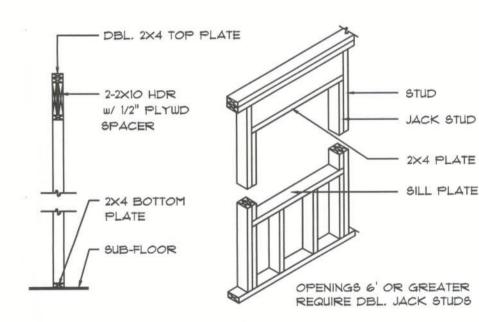

TYPICAL WINDOW HEADER

Framing DETAILS

SCALE: 1/4" = 1'-0"

CASTANGA <u>CONSTRUCTION</u>

G

REVISIONS

SOFTPIAN

WILLIAM HUBBARD RES.

FINALS DATE PRINTED DATE: March 30, 2010 03 / Mar / 10 JFB JFB

PEACOCK ROAD

COLUMBIA COUNTY

JOHN F BENZ DRAFTING SERVICE 386-266-0746 JOB NUMBER:


031010

DRAWING NUMBER

FRAMING DETAILS OF 3 SHEETS

GIRDER TRUSS, UPLIFT \$ REACTION (DOWN) LOADS PER MANUFACTURER A SOLID MEMBER OF EQUAL OR GREATER SIZE THAN MULTIPLE MEMBERS MAY BE USED IF RATED SHEATHING IS APPLIED TO NARROW EDGES, NAILED TO DOUBLE 2X TOP PLATE EACH STUD AT 12" O.C. MAXIMUM, THE LAMINATION NAILING SHOWN HERE IS NOT REQUIRED PROVIDE CONNECTORS AS REQUIRED TO RESIST UPLIFT PER MANUF'R OF TRUSSES - IOd NAILS, TYPICAL, 2" FROM ENDS, FROM OPPOSITE SIDES, 9" ON CENTER PROVIDE CONNECTORS AS MAXIMUM, STAGGERED REQUIRED TO RESIST UPLIFT 2 ROWS PER MANUF'R OF TRUSSES P.T. BOTTOM PLATE 5/8"~ ALL-THREAD END (TOP OR BOTTOM) ROD W/ EPOXY CONCRETE FILLED CMU: POURED CONCRETE: "X" DEPTH OF EMBEDMENT "X" DEPTH OF EMBEDMENT 5" = 3140* TENSILE LOAD 5" = 3340* TENSILE LOAD 5"(133%) = 4185# TENSILE LOAD 10" = 5750* TENSILE LOAD

Garage End Wall DETAILS

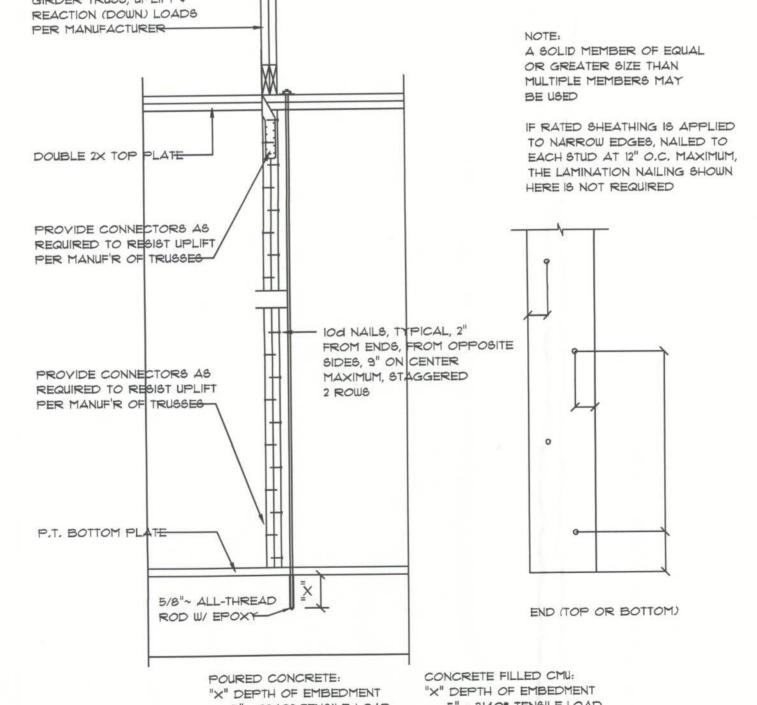

Girder Truss Column DET.

SCALE: 1/2" = 1'-0"

HEADER SPANS FOR EXTERIOR BEARING WALLS BUILDING WIDTH (FT) 20' 28' HEADER HEADERS SPAN * JACKS SPAN * JACKS SPAN * JACKS SIZE SUPPORTING: 2-2×4 3'-6" 3'-2" 2'-10" 4'-2" 4'-8" 2-2×6 5'-4" ROOF, CEILING 2-2×8 5'-11" 6-10" 2 6'-6" 7'-3" 2-2×10 7'-6" 2 8'-5" 2-2×12 9'-9" 3-2×8 7'-5" 6'-8" 8'-2" 9'-1" 3-2×10 9'-5" 2 10'-7" 3-2×12 9'-2" 8'-4" 4-2x8 9'-2" 9'-5" 10'-6" 1 4-2×10 2 10'-11" 12'-2" 4-2×12