

**VERIZON SITE NUMBER: 236777** 

**VERIZON SITE NAME:** 

**SITE TYPE:** 

**TOWER HEIGHT:** 

LAKE CITY EAST

**SELF SUPPORT TOWER** 

251'-6"

**BUSINESS UNIT #: 846215** 

**SITE ADDRESS:** 

**COUNTY:** 

**JURISDICTION:** 

3099 NE MT CARRIE RD LAKE CITY, FL 32055

**COLUMBIA** 

**LOCATION MAP** 

**COLUMBIA COUNTY** 

# TEMPLE TERRACE, FL 3363





1080 HOLCOMB BRIDGE ROAD BUILDING 100, SUITE 350 ROSWELL, GA 30076 TEL: 678-990-2338 FAX: 678-990-2342

## **VERIZON SITE NUMBER:** 236777

## BU #: **846215 OSCEOLA**

3099 NE MT CARRIE RD LAKE CITY, FL 32055

EXISTING 251'-6" SELF SUPPORT TOWER

	ISSUED FOR:						
REV	DATE	DRWN	DESCRIPTION	DES./QA			
0	12/10/21	FS	FINAL	MDS			



AD K. PARSA, P.E. ON THE DATE ADJACENT TO THE SEAI TED COPIES OF THIS DOCUMENT ARE NOT CONSIDER ED AND SEALED AND THE SIGNATURE MUST BE IFIED ON ANY ELECTRONIC COPIES.

IT IS A VIOLATION OF LAW FOR ANY PERSON, UNLESS THEY ARE ACTING UNDER THE DIRECTION OF A LICENSED PROFESSIONAL ENGINEER, TO ALTER THIS DOCUMENT

REVISION:

# **VERIZON SUB 6-GHZ**

## SITE INFORMATION

EXISTING

CROWN CASTLE USA INC.

SITE ADDRESS: 3099 NE MT CARRIE RD LAKE CITY, FL 32055

COUNTY: COLUMBIA

MAP/PARCEL#: AREA OF CONSTRUCTION:

LATITUDE: 30° 14' 3.66" -82° 29' 56.23" LONGITUDE LAT/LONG TYPE: NAD83 GROUND ELEVATION: 156 FT

CURRENT ZONING:

IURISDICTION COLUMBIA COUNTY OCCUPANCY CLASSIFICATION: U

TYPE OF CONSTRUCTION:

A.D.A. COMPLIANCE: FACILITY IS UNMANNED AND NOT FOR

PROPERTY OWNER:

TOWER OWNER:

CROWN CASTLE 2000 CORPORATE DRIVE CANONSBURG, PA 15317

CARRIER/APPLICANT

VERIZON WIRELESS 7701 EAST TELECOM PARKWAY WING A-1

TEMPLE TERRACE, FL 33637

ELECTRIC PROVIDER

TELCO PROVIDER:

**DRAWING INDEX** SHEET# SHEET DESCRIPTION TITLE SHEET GENERAL NOTES T-2 SITE PLAN EQUIPMENT PLAN C-2 TOWER ELEVATION & ANTENNA PLANS EQUIPMENT SCHEDULE C-3 EQUIPMENT SPECS C-4 EQUIPMENT SPECS GROUNDING DETAILS GROUNDING DETAILS ONE-LINE DIAGRAM/PANEL SCHEDULE

ALL DRAWINGS CONTAINED HEREIN ARE FORMATTED FOR 1X17. CONTRACTOR SHALL VERIFY ALL PLANS AND EXISTING DIMENSIONS AND CONDITIONS ON THE JOB SITE AND SHALL IMMEDIATELY NOTIFY THE ENGINEER IN WRITING OF ANY DISCREPANCIES BEFORE PROCEEDING WITH THE WORK OF BE RESPONSIBLE FOR SAME

PROJECT DESCRIPTION

THE PURPOSE OF THIS PROJECT IS TO ENHANCE BROADBAND CONNECTIVITY AND CAPACITY TO THE EXISTING ELIGIBLE WIRELESS FACILITY

## TOWER SCOPE OF WORK

- REMOVE (3) ANTENNAS
- INSTALL (9) ANTENNAS INSTALL (6) RRUS
- INSTALL (2) OVPs
- INSTALL (2) 2" HYBRID CABLE
- INSTALL (27) CROSSOVER PLATE INSTALL (3) V-BRACING KIT
- INSTALL (3) 150" LONG, PIPE 2 1/2 SCH40

## GROUND SCOPE OF WORK

- INSTALL -48 DC POWER PLANT
- REMOVE 6201 CABINET W/ (6) RUL01 B13

- CONTRACTOR TO CONFIRM LATEST RFDS VERSION
- PRIOR TO ACCESSING/ENTERING THE SITE YOU MUST CONTACT THE CROWN NOC AT (800) 788-7011 & CROWN

- WITH VERIZON PRIOR TO WORK COMMENCEMENT.

# APPLICABLE CODES/REFERENCE DOCUMENTS

## **PROJECT TEAM**

A&E FIRM:

CROWN CASTLE USA INC. 2000 CORPORATE DRIVE CANONSBURG, PA 15317

CROWNAE.APPROVAL@CROWNCASTLE.COM 8000 AVALON BLVD, SUITE 700

CROWN CASTLE USA INC. DISTRICT ALPHARETTA, GA 30009 CONTACTS:

DEREK SMITH - PROJECT MANAGER (561) 544-4972

https://pmi.vxwsmart.com SMART TOOL VENDOR

CONTRACTOR PMI REQUIREMENTS

PROIECT NUMBER VzW LOCATION CODE (PSLC)

\*\*\* PMI AND REQUIREMENTS ALSO EMBEDDED IN MOUNT ANALYSIS REPORT

MOUNT MODIFICATION REQUIRED

## VzW APPROVED SMART KIT VENDORS

REFER TO MOUNT MODIFICATION DRAWINGS PAGE FOR VzW SMART KIT APPROVED VENDORS

# ALL WORK SHALL BE PERFORMED AND MATERIALS INSTALLED IN ACCORDANCE WITH

THE CURRENT EDITIONS OF THE FOLLOWING CODES AS ADOPTED BY THE LOCAL GOVERNING AUTHORITIES. NOTHING IN THESE PLANS IS TO BE CONSTRUED TO PERMIT WORK NOT CONFORMING TO THESE CODES:

CODE TYPE BUILDING MECHANICAI ELECTRICAL 2017 NEC

2020 FLORIDA BUILDING CODE, 7th EDITION 2018 IMC

APPLICABLE CODES: TIA-222-H / ASCE 7-16 WIND SPEED: V = 118 MPH (ULTIMATE 3 SECOND GUST) EXPOSURE CATEGORY: B

RISK CATEGORY: II TOPOGRAPHIC CATEGORY: 1 SEISMIC RESPONSE: NA REFERENCE DOCUMENTS STRUCTURAL ANALYSIS: BY OTHERS

NO SCALE

DATED: MOUNT ANALYSIS: 11/11/21

ITE ID: 236777 AT: 30° 14' 3.66" ONG: -82° 29' 56.23"

DATED: RFDS REVISION: DATED: 10/14/21 ORDER ID: 585989

REVISION:

(800) 432-4770



## CROWN CASTLE USA INC. SITE ACTIVITY REQUIREMENTS:

- NOTICE TO PROCEED- NO WORK SHALL COMMENCE PRIOR TO CROWN CASTLE USA INC. WRITTEN NOTICE TO PROCEED (NTP) AND THE ISSUANCE OF A PURCHASE ORDER. PRIOR TO ACCESSING/ENTERING THE STUDY OF THE CONTACT THE CROWN CASTLE USA INC. NOC AT 800-788-7011 & THE CROWN CASTLE USA INC. CONSTRUCTION MANAGER.
- "LOOK UP" CROWN CASTLE USA INC. SAFETY CLIMB REQUIREMENT: THE INTEGRITY OF THE SAFETY CLIMB AND ALL COMPONENTS OF THE CLIMBING FACILITY SHALL BE CONSIDERED DURING ALL STAGES OF DESIGN, INSTALLATION, AND INSPECTION. TOWER MODIFICATION, MOUNT REINFORCEMENTS, AND/OR EQUIPMENT INSTALLATIONS SHALL NOT COMPROMISE THE INTEGRITY OR FEINTORGEMENTS, AND/OW EQUIPMENT INSTALLATIONS STALL NOT COMPROMISE THE INTEGRIT OF FUNCTIONAL USE OF THE SAFETY CLIMB OR ANY COMPONENTS OF THE CLIMBING FACILITY ON THE STRUCTURE. THIS SHALL INCLUDE, BUT NOT BE LIMITED TO: PINCHING OF THE WIRE ROPE, BENDING OF THE WIRE ROPE FROM ITS SUPPORTS, DIRECT CONTACT OR CLOSE PROXIMITY TO THE WIRE ROPE WHICH MAY CAUSE FRICTIONAL WEAR, IMPACT TO THE ANCHORAGE POINTS IN ANY WAY, OR TO IMPEDE/BLOCK ITS INTENDED USE. ANY COMPROMISED SAFETY CLIMB, INCLUDING EXISTING CONDITIONS MUST BE TAGGED OUT AND REPORTED TO YOUR CROWN CASTLE USA INC. POC OR CALL THE NOC TO GENERATE A SAFETY CLIM MAINTENANCE AND CONTRACTOR NOTICE TICKET.
- PRIOR TO THE START OF CONSTRUCTION, ALL REQUIRED JURISDICTIONAL PERMITS SHALL BE OBTAINED. THIS INCLUDES, BUT IS NOT LIMITED TO, BUILDING, ELECTRICAL, MECHANICAL, FIRE, FLOOD ZONE, ENVIRONMENTAL, AND ZONING. AFTER ONSITE ACTIVITIES AND CONSTRUCTION ARE COMPLETED, ALL REQUIRED PERMITS SHALL BE SATISFIED AND CLOSED OUT ACCORDING TO LOCAL JURISDICTIONAL REQUIREMENTS
- ALL CONSTRUCTION MEANS AND METHODS; INCLUDING BUT NOT LIMITED TO, ERECTION PLANS, RIGGING PLANS, CLIMBING PLANS, AND RESCUE PLANS SHALL BE THE RESPONSIBILITY OF THE GENERAL CONTRACTOR RESPONSIBLE FOR THE EXECUTION OF THE WORK CONTAINED HEREIN, AND SHALL MEET ANSI/ASSE A10.48 (LATEST EDITION); FEDERAL, STATE, AND LOCAL REGULATIONS; AND ANY APPLICABLE INDUSTRY CONSENSUS STANDARDS RELATED TO THE CONSTRUCTION ACTIVITIES BEING PERFORMED. ALL RIGGING PLANS SHALL ADHERE TO ANSI/ASSE A10.48 (LATEST EDITION) AND CROWN CASTLE USA INC. STANDARD CED-STD-10253, INCLUDING THE REQUIRED INVOLVEMENT OF A QUALIFIED ENGINEER FOR CLASS IV CONSTRUCTION, TO CERTIFY THE SUPPORTING STRUCTURE(S) IN ACCORDANCE WITH ANSI/TIA-322
- ALL SITE WORK TO COMPLY WITH DAS-STD-10068 "INSTALLATION STANDARDS FOR CONSTRUCTION ACTIVITIES ON CROWN CASTLE USA INC. TOWER SITE," CED-STD-10294 "STANDARD FOR INSTALLATION OF MOUNTS AND APPURTENANCES," AND LATEST VERSION OF ANSI/TIA-1019-A-2012 "STANDARD FOR INSTALLATION, ALTERATION, AND MAINTENANCE OF ANTENNA SUPPORTING STRUCTURES AND ANTENNAS." IF THE SPECIFIED EQUIPMENT CAN NOT BE INSTALLED AS SHOWN ON THESE DRAWINGS, THE CONTRACTOR
- SHALL PROPOSE AN ALTERNATIVE INSTALLATION FOR APPROVAL BY CROWN CASTLE USA INC. PRIOR TO PROCEEDING WITH ANY SUCH CHANGE OF INSTALLATION.
- PROCEEDING WITH ANY SUCH CHANGE OF INSTALLATION.
  ALL MATERIALS FURNISHED AND INSTALLED SHALL BE IN STRICT ACCORDANCE WITH ALL APPLICABLE
  CODES, REGULATIONS AND ORDINANCES. CONTRACTOR SHALL ISSUE ALL APPROPRIATE NOTICES AND
  COMPLY WITH ALL LAWS, ORDINANCES, RULES, REGULATIONS AND LAWFUL ORDERS OF ANY PUBLIC
  AUTHORITY REGARDING THE PERFORMANCE OF THE WORK, ALL WORK CARRIED OUT SHALL COMPLY WITH
  ALL APPLICABLE MUNICIPAL AND UTILITY COMPANY SPECIFICATIONS AND LOCAL JURISDICTIONAL CODES, ORDINANCES AND APPLICABLE REGULATIONS.
- THE CONTRACTOR SHALL INSTALL ALL EQUIPMENT AND MATERIALS IN ACCORDANCE WITH MANUFACTURER'S RECOMMENDATIONS UNLESS SPECIFICALLY STATED OTHERWISE.
- RECOMMENDATIONS ONLESS SPECIFICALLY STATED OTHERWISE.

  9. THE CONTRACTOR SHALL CONTACT UTILITY LOCATING SERVICES PRIOR TO THE START OF CONSTRUCTION.

  10. ALL EXISTING ACTIVE SEWER, WATER, GAS, ELECTRIC AND OTHER UTILITIES WHERE ENCOUNTERED IN THE WORK, SHALL BE PROTECTED AT ALL TIMES AND WHERE REQUIRED FOR THE PROPER EXECUTION OF THE WORK, SHALL BE RELOCATED AS DIRECTED BY CONTRACTOR. EXTREME CAUTION SHOULD BE USED BY THE CONTRACTOR WHEN EXCAVATING OR DRILLING PIERS AROUND OR NEAR UTILITIES. CONTRACTOR SHALL PROVIDE SAFETY TRAINING FOR THE WORKING CREW. THIS WILL INCLUDE BUT NOT BE LIMITED TO A) FALL PROTECTION B) CONFINED SPACE C) ELECTRICAL SAFETY D) TRENCHING AND EXCAVATION E) CONSTRUCTION SAFETY PROCEDURES
- CONSTRUCTION SAFETY PROCEDURES.
  ALL SITE WORK SHALL BE AS INDICATED ON THE STAMPED CONSTRUCTION DRAWINGS AND PROJECT
  SPECIFICATIONS, LATEST APPROVED REVISION.
  CONTRACTOR SHALL KEEP THE SITE FREE FROM ACCUMULATING WASTE MATERIAL, DEBRIS, AND TRASH AT
  THE COMPLETION OF THE WORK. IF NECESSARY, RUBBISH, STUMPS, DEBRIS, STICKS, STONES AND OTHER
  REFUSE SHALL BE REMOVED FROM THE SITE AND DISPOSED OF LEGALLY.
  ALL EXISTING INACTIVE SEWER, WATER, GAS, ELECTRIC AND OTHER UTILITIES, WHICH INTERFERE WITH THE
- EXECUTION OF THE WORK, SHALL BE REMOVED AND/OR CAPPED, PLUGGED OR OTHERWISE DISCONTINUED AT POINTS WHICH WILL NOT INTERFERE WITH THE EXECUTION OF THE WORK, SUBJECT TO THE APPROVAL OF CONTRACTOR, TOWER OWNER, CROWN CASTLE USA INC., AND/OR LOCAL UTILITIES.
- THE CONTRACTOR SHALL PROVIDE SITE SIGNAGE IN ACCORDANCE WITH THE TECHNICAL SPECIFICATION FOR SITE SIGNAGE REQUIRED BY LOCAL JURISDICTION AND SIGNAGE REQUIRED ON INDIVIDUAL PIECES OF EQUIPMENT, ROOMS, AND SHELTERS.
- THE SITE SHALL BE GRADED TO CAUSE SURFACE WATER TO FLOW AWAY FROM THE CARRIER'S EQUIPMENT
- 16. THE SUB GRADE SHALL BE COMPACTED AND BROUGHT TO A SMOOTH UNIFORM GRADE PRIOR TO FINISHED SURFACE APPLICATION.
- SURFACE APPLICATION.

  THE AREAS OF THE OWNERS PROPERTY DISTURBED BY THE WORK AND NOT COVERED BY THE TOWER, EQUIPMENT OR DRIVEWAY, SHALL BE GRADED TO A UNIFORM SLOPE, AND STABILIZED TO PREVENT EROSION AS SPECIFIED ON THE CONSTRUCTION DRAWINGS AND/OR PROJECT SPECIFICATIONS.
- CONTRACTOR SHALL MINIMIZE DISTURBANCE TO EXISTING SITE DURING CONSTRUCTION FROSION CONTRO SURES, IF REQUIRED DURING CONSTRUCTION, SHALL BE IN CONFORMANCE WITH THE LOCAL GUIDELINES : EROSION AND SEDIMENT CONTROL.
- THE CONTRACTOR SHALL PROTECT EXISTING IMPROVEMENTS, PAVEMENTS, CURBS, LANDSCAPING AND STRUCTURES. ANY DAMAGED PART SHALL BE REPAIRED AT CONTRACTOR'S EXPENSE TO THE SATISFACTION 20. CONTRACTOR SHALL LEGALLY AND PROPERLY DISPOSE OF ALL SCRAP MATERIALS SUCH AS COAXIAL
- CABLES AND OTHER ITEMS REMOVED FROM THE EXISTING FACILITY. ANTENNAS REMOVED SHALL BE RETURNED TO THE OWNER'S DESIGNATED LOCATION.

  CONTRACTOR SHALL LEAVE PREMISES IN CLEAN CONDITION. TRASH AND DEBRIS SHOULD BE REMOVED.
- FROM SITE ON A DAILY BASIS.
- NO FILL OR EMBANKMENT MATERIAL SHALL BE PLACED ON FROZEN GROUND. FROZEN MATERIALS, SNOW OR ICE SHALL NOT BE PLACED IN ANY FILL OR EMBANKMENT.

## GENERAL NOTES:

- FOR THE PURPOSE OF CONSTRUCTION DRAWING, THE FOLLOWING DEFINITIONS SHALL APPLY:
  CONTRACTOR: GENERAL CONTRACTOR RESPONSIBLE FOR CONSTRUCTION
  CARRIER: VERIZON
  VERIZON
- OWER OWNER: CROWN CASTLE USA INC.
- TOWER OWNER: CROWN CASTLE USA INC.

  THESE DRAWINGS HAVE BEEN PREPARED USING STANDARDS OF PROFESSIONAL CARE AND COMPLETENESS NORMALLY EXERCISED UNDER SIMILAR CIRCUMSTANCES BY REPUTABLE ENGINEERS IN THIS OR SIMILAR LOCALITIES. IT IS ASSUMED THAT THE WORK DEPICTED WILL BE PERFORMED BY AN EXPERIENCED CONTRACTOR AND/OR WORKPEOPLE WHO HAVE A WORKING KNOWLEDGE OF THE APPLICABLE CODE STANDARDS AND REQUIREMENTS AND OF INDUSTRY ACCEPTED STANDARD GOOD PRACTICE. AS NOT EVERY CONDITION OR ELEMENT IS (OR CAN BE) EXPLICITLY SHOWN ON THESE DRAWINGS, THE CONTRACTOR SHALL USE INDUSTRY ACCEPTED STANDARD GOOD PRACTICE FOR MISCELLANEOUS WORK NOT EXPLICITLY SHOWN.
- MISCELLANEOUS WORK NOT EXPLICITLY SHOWN.
  THESE DRAWINGS REPRESENT THE FINISHED STRUCTURE. THEY DO NOT INDICATE THE MEANS OR METHODS OF CONSTRUCTION. THE CONTRACTOR SHALL BE SOLELY RESPONSIBLE FOR THE CONSTRUCTION MEANS, METHODS, TECHNIQUES, SEQUENCES, AND PROCEDURES. THE CONTRACTOR SHALL PROVIDE ALL MEASURES NECESSARY FOR PROTECTION OF LIFE AND PROPERTY DURING CONSTRUCTION. SUCH MEASURES SHALL INCLUDE, BUT NOT BE LIMITED TO, BRACING, FORMWORK, SHORING, ETC. SIE VISITS BY THE ENGINEER OR HIS PERPESENTATIVE WILL DOWN INCLUDE INSPECTION OF THESE ITEMS AND IS FOR STRUCTURAL OBSERVATION OF THE FINISHED STRUCTURE ONLY.
- INSPECTION OF THESE HEMS AND IS FOR STRUCTURAL OBSERVATION OF THE FINISHED STRUCTURE ONLY.

  NOTES AND DETAILS IN THE CONSTRUCTION DRAWINGS SHALL TAKE PRECEDENCE OVER GENERAL NOTES AND TYPICAL

  DETAILS. WHERE NO DETAILS ARE SHOWN, CONSTRUCTION SHALL CONFORM TO SIMILAR WORK ON THE PROJECT,
  AND/OR AS PROVIDED FOR IN THE CONTRACT DOCUMENTS. WHERE DISCREPANCES COCUR BETWEEN PLANS, DETAILS,
  GENERAL NOTES, AND SPECIFICATIONS, THE GREATER, MORE STRICT REQUIREMENTS, SHALL GOVERN. IF FURTHER
  CLARIFICATION IS REQUIRED CONTACT THE ENGINEER OF RECORD.

  SUBSTANTIAL EFFORT HAS BEEN MADE TO PROVIDE ACCURATE DIMENSIONS AND MEASUREMENTS ON THE DRAWINGS TO
- ASSIST IN THE FABRICATION AND/OR PLACEMENT OF CONSTRUCTION ELEMENTS BUT IT IS THE SOLE RESPONSIBILITY OF THE CONTRACTOR TO FIELD VERIFY THE DIMENSIONS, MEASUREMENTS, AND/OR CLEARANCES SHOWN IN THE CONSTRUCTION DRAWINGS PRIOR TO FABRICATION OR CUTTING OF ANY NEW OR EXISTING CONSTRUCTION ELEMENTS. F IT IS DETERMINED THAT THERE ARE DISCREPANCIES AND/OR CONFLICTS WITH THE CONSTRUCTION DRAWINGS THE
- IF IT IS DETERMINED THAT THERE ARE DISCREPANCIES AND/OR CONFLICTS WITH THE CONSTRUCTION DRAWINGS THE ENGINEER OF RECORD IS TO BE NOTHED AS SOON AS POSSIBLE.

  PRIOR TO THE SUBMISSION OF BIOS, THE BIDDING CONTRACTOR SHALL WIST THE CELL SITE TO FAMILIARIZE WITH THE EXISTING CONDITIONS AND TO CONFIRM THAT THE WORK CAN BE ACCOMPLISHED AS SHOWN ON THE CONSTRUCTION DRAWINGS. ANY DISCREPANCY FOUND SHALL BE BROUGHT TO THE ATTENTION OF CROWN CASTLE.

  ALL MATERIALS FURNISHED AND INSTALLED SHALL BE IN STRICT ACCORDANCE WITH ALL APPLICABLE CODES, REGULATIONS AND ORDINANCES. CONTRACTOR SHALL ISSUE ALL APPROPRIATE NOTICES AND COMPLY WITH ALL LAWS, ORDINANCES, REGULATIONS AND LAWFUL ORDERS OF ANY PUBLIC AUTHORITY REGARDING THE PERFORMANCE OF THE WORK. ALL WORK CARRIED OUT SHALL COMPLY WITH ALL APPLICABLE WUNICIPAL AND UTILITY COMPANY SPECIFICATIONS AND LOCAL JURISDICTIONAL CODES, ORDINANCES AND APPLICABLE REGULATIONS.

  UNLESS NOTED OTHERWISE, THE WORK SHALL INCLUDE FURNISHING MATERIALS, EQUIPMENT, APPURTENANCES AND LABOR NECESSARY TO COMPLETE ALL INSTALLATIONS AS INDICATED ON THE DRAWINGS.

  THE CONTRACTOR SHALL INSTALLAL LEQUIPMENT AND MATERIALS, IN ACCORDANCE WITH MANUFACTURER'S

- THE CONTRACTOR SHALL INSTALLAL EQUIPMENT AND MATERIALS IN ACCORDANCE WITH MANUFACTURER'S RECOMMENDATIONS UNLESS SPECIFICALLY STATED OTHERWISE. IF THE SPECIFIED EQUIPMENT CAN NOT BE INSTALLED AS SHOWN ON THESE DRAWINGS, THE CONTRACTOR SHALL PROPOSE AN ALTERNATIVE INSTALLATION FOR APPROVAL BY THE CARRIER AND CROWN CASTLE PRIOR TO PROCEEDING WITH ANY SUCH CHANGE OF INSTALLATION.

  CONTRACTOR IS TO PEFFORM A SITE INVESTIGATION AND IS TO DETERMINE THE BEST ROUTING OF ALL CONDUITS FOR POWER, AND TELCO AND FOR GROUNDING CABLES AS SHOWN IN THE POWER, TELCO, AND GROUNDING PLAN
- HE CONTRACTOR SHALL PROTECT EXISTING IMPROVEMENTS, PAVEMENTS, CURBS, LANDSCAPING AND STRUCTURES, ANY
- DAMAGED PART SHALL BE REPAIRED AT CONTRACTOR'S EXPENSE TO THE SATISFACTION OF GROWN CASTLE USA INC. CONTRACTOR SHALL LEGALLY AND PROPERLY DISPOSE OF ALL SCRAP MATERIALS SUCH AS COAXIAL CABLES AND OTHER ITEMS REMOVED FROM THE EXISTING FACILITY. ANTENNAS REMOVED SHALL BE RETURNED TO THE OWNER'S DESIGNATED LOCATION
- CONTRACTOR SHALL LEAVE PREMISES IN CLEAN CONDITION. TRASH AND DEBRIS SHOULD BE REMOVED FROM SITE ON

## CONCRETE, FOUNDATIONS, AND REINFORCING STEEL:

- ALL CONCRETE WORK SHALL BE IN ACCORDANCE WITH THE ACI 301, ACI 318, ACI 336, ASTM A184, ASTM A185 AND THE DESIGN AND CONSTRUCTION SPECIFICATION FOR CAST—IN—PLACE CONCRETE.
  UNLESS NOTED OTHERWISE, SOIL BEARING PRESSURE USED FOR DESIGN OF SLABS AND FOUNDATIONS IS ASSUMED TO BE 1000 psf.
- ALL CONCRETE SHALL HAVE A MINIMUM COMPRESSIVE STRENGTH (f'c) OF 3000 psi AT 28 DAYS, UNLESS NOTED OTHERWISE. NO MORE THAN 90 MINUTES SHALL ELAPSE FROM BATCH TIME TO TIME OF PLACEMENT UNLESS APPROVED BY THE ENGINEER OF RECORD. TEMPERATURE OF CONCRETE SHALL NOT EXCEED 90'F AT TIME OF PLACEMENT.
- CONCRETE EXPOSED TO FREEZE—THAW CYCLES SHALL CONTAIN AIR ENTRAINING ADMIXTURES. AMOUNT OF AIR ENTRAINMENT TO BE BASED ON SIZE OF AGGREGATE AND F3 CLASS EXPOSURE (VERY SEVERE). CEMENT USED TO BE TYPE II PORTLAND CEMENT WITH A MAXIMUM WATER-TO-CEMENT RATIO (W/C) OF 0.45.
- ALL STEEL REINFORCING SHALL CONFORM TO ASTM A615. ALL WELDED WIRE FABRIC (WWF) SHALL CONFORM TO ASTM A185. ALL SPLICES SHALL BE CLASS "B" TENSION SPLICES, UNLESS NOTED OTHERWISE. ALL HOOKS SHALL BE STANDARD 90 DEGREE HOOKS, UNLESS NOTED OTHERWISE. YIELD STRENGTH (Fy) OF STANDARD DEFORMED BARS ARE AS FOLLOWS: #4 BARS AND SMALLER
- ON DRAWINGS
- CONCRETE CAST AGAINST AND PERMANENTLY EXPOSED TO EARTH... CONCRETE EXPOSED TO EARTH OR WEATHER
  #6 BARS AND LARGER..... #5 BARS AND SMALLER. ..1-1/2"
- CONCRETE NOT EXPOSED TO EARTH OR WEATHER: BEAMS AND COLUMNS.
- A TOOLED EDGE OR A 3/4" CHAMFER SHALL BE PROVIDED AT ALL EXPOSED EDGES OF CONCRETE, UNLESS NOTED OTHERWISE, IN ACCORDANCE WITH ACI 301 SECTION 4.2.4.

## GREENFIELD GROUNDING NOTES:

- ALL GROUND ELECTRODE SYSTEMS (INCLUDING TELECOMMUNICATION, RADIO, LIGHTNING PROTECTION AND AC POWER GES'S) SHALL BE BONDED TOGETHER AT OR BELOW GRADE, BY TWO OR MORE COPPER BONDING CONDUCTORS IN ACCORDANCE WITH THE NEC
- THE CONTRACTOR SHALL PERFORM IEEE FALL—OF—POTENTAL RESISTANCE TO EARTH TESTING (PER IEEE 1100 AND 81) FOR GROUND ELECTRODE SYSTEMS, THE CONTRACTOR SHALL FURNISH AND INSTALL SUPPLEMENTAL GROUND ELECTRODES AS NEEDED TO ACHIEVE A TEST RESULT OF 5 OHMS OR LESS.

  THE CONTRACTOR IS RESPONSIBLE FOR PROPERLY SEQUENCING GROUNDING AND UNDERGROUND CONDUIT INSTALLATION AS TO PREVENT ANY LOSS OF CONTINUITY IN THE GROUNDING SYSTEM OR DAMAGE TO THE CONDUIT AND PROVIDE METAL CONDUIT AND TRAY SHALL BE GROUNDED AND MADE ELECTRICALLY CONTINUOUS WITH LISTED BONDING FITTINGS OR BY BONDING ACROSS THE DISCONTINUITY WITH #6 COPPER WIRE UL APPROVED GROUNDING TYPE CONDUIT
- WETAL RACEWAY SHALL NOT BE USED AS THE NEC REQUIRED EQUIPMENT GROUND CONDUCTOR. STRANDED COPPER CONDUCTORS WITH GREEN INSULATION, SIZED IN ACCORDANCE WITH THE NEC, SHALL BE FURNISHED AND INSTALLED WITH THE POWER CIRCUITS TO BTS EQUIPMENT.
- EACH CABINET FRAME SHALL BE DIRECTLY CONNECTED TO THE MASTER GROUND BAR WITH GREEN INSULATED SUPPLEMENTAL EQUIPMENT GROUND WIRES, #6 STRANDED COPPER OR LARGER FOR INDOOR BTS; #2 BARE SOLID TINNED COPPER FOR OUTDOOR BTS.
- CONNECTIONS TO THE GROUND BUS SHALL NOT BE DOUBLED UP OR STACKED BACK TO BACK CONNECTIONS ON OPPOSITE SIDE OF THE GROUND BUS ARE PERMITTED. ALL EXTERIOR GROUND CONDUCTORS BETWEEN EQUIPMENT/GROUND BARS AND THE GROUND RING SHALL BE #2 SOLID TINNED COPPER UNLESS OTHERWISE INDICATED.
  ALUMINUM CONDUCTOR OR COPPER CLAD STEEL CONDUCTOR SHALL NOT BE USED FOR GROUNDING CONNECTIONS.
  USE OF 90' BENDS IN THE PROTECTION GROUNDING CONDUCTORS SHALL BE AVOIDED WHEN 45' BENDS CAN BE ADEQUATELY SUPPORTED.
  EXCITERMIC WELDS SHALL BE USED FOR ALL GROUNDING CONNECTIONS BELOW GRADE.

- ALL GROUND CONNECTIONS ABOVE GRADE (INTERIOR AND EXTERIOR) SHALL BE FORMED USING HIGH PRESS CRIMPS.

  COMPRESSION GROUND CONNECTIONS MAY BE REPLACED BY EXOTHERMIC WELD CONNECTIONS.

  ICE BRIDGE BONDING CONDUCTORS SHALL BE EXOTHERMICALLY BONDED OR BOLTED TO THE BRIDGE AND THE TOWER GROUND BAR.

- RE BRIDGE BONDING CONDUCTORS SHALL BE EXCHERMICALLY BONDED OR BOLIED TO THE BRIDGE AND THE TOWER GROUND BAR.

  APPROVED ANTIOXIDANT COATINGS (i.e. CONDUCTIVE GEL OR PASTE) SHALL BE USED ON ALL COMPRESSION AND BOLTED GROUND CONNECTIONS.

  ALL EXTERIOR GROUND CONNECTIONS SHALL BE COATED WITH A CORROSION RESISTANT MATERIAL.

  MISCELLANGOUS ELECTRICAL AND NON-ELECTRICAL METAL BOXES, FRAMES AND SUPPORTS SHALL BE BONDED TO THE GROUND RING, IN ACCORDANCE WITH THE NEC.

  BOND ALL METALLIC OBJECTS WITHIN 6 ft OF MAIN GROUND RING WITH (1) #2 BARE SOLD TINNED COPPER GROUND CONDUCTORS.

  GROUND CONDUCTORS USED FOR THE FACILITY GROUNDING AND LIGHTNING PROTECTION SYSTEMS SHALL NOT BE ROUTED THROUGH METALLIC OBJECTS THAT FORM A RING AROUND THE CONDUCTOR, SUCH AS METALLIC CONDUITS,

  METAL SUPPORT CLIPS OR SLEEVES THROUGH WALLS OR FLOORS. WHEN IT IS REQUIRED TO BE HOUSED IN CONDUIT TO MEET COPE REQUIREMENTS OR LOCAL CONDITIONS, NON-METALLIC MATERIAL SUCH AS PVC CONDUIT SHALL BE USED. WHERE USE OF METAL CONDUIT IS UNAVOIDABLE (i.e., NONMETALLIC CONDUIT PROHIBITED BY LOCAL CODE) THE GROUND CONDUCTOR SHALL BE BONDED TO EACH END OF THE METAL CONDUIT.

  ALL GROUNDS THAT TRANSITION FROM BELOW GRADE TO ABOVE GRADE MUST BE #2 BARE SOLID TINNED COPPER IN 3/4" NON-METALLIC, FLEXIBLE CONDUIT FROM 24" BELOW GRADE TO WITHIN 3" TO 6" OF CAD-WELD TERMINATION
- POINT. THE EXPOSED END OF THE CONDUIT MUST BE SEALED WITH SILICONE CAULK. (ADD TRANSITIONING GROUND STANDARD DETAIL AS WELL).
  BUILDINGS WHERE THE MAIN GROUNDING CONDUCTORS ARE REQUIRED TO BE ROUTED TO GRADE, THE CONTRACTOR SHALL ROUTE TWO GROUNDING CONDUCTORS FROM THE ROOFTOP, TOWERS, AND WATER TOWERS GROUNDING RING, TO THE EXISTING GROUNDING SYSTEM, THE GROUNDING CONDUCTORS SHALL NOT BE SMALLER THAN 2/O COPPER. ROOFTOP GROUNDING RING SHALL BE BONDED TO THE EXISTING GROUNDING SYSTEM, THE BUILDING STEEL COLUMNS, LIGHTNING PROTECTION SYSTEM, AND BUILDING MAIN WATER LINE (FERROUS OR NONFERROUS METAL PIPING ONLY).

## **ELECTRICAL INSTALLATION NOTES:**

- ALL ELECTRICAL WORK SHALL BE PERFORMED IN ACCORDANCE WITH THE PROJECT SPECIFICATIONS, NEC AND ALL APPLICABLE
- FEDERAL, STATE, AND LOCAL CODES/ORDINANCES.
  CONDUIT ROUTINGS ARE SCHEMATIC. CONTRACTOR SHALL INSTALL CONDUITS SO THAT ACCESS TO EQUIPMENT IS NOT BLOCKED. AND TRIP HAZARDS ARE FLIMINATED

- AND TRIP HAZARDS ARE ELIMINATED.
  WIRING, RACEWAY AND SUPPORT WEHTHODS AND MATERIALS SHALL COMPLY WITH THE REQUIREMENTS OF THE NEC.
  ALL CIRCUITS SHALL BE SEGREGATED AND MAINTAIN MINIMUM CABLE SEPARATION AS REQUIRED BY THE NEC.
  I. ALL EQUIPMENT SHALL BEAR THE UNDERWRITERS LABORATORIES LABEL OF APPROVAL, AND SHALL CONFORM TO
  REQUIREMENT OF THE NATIONAL ELECTRICAL CODE.
  2. ALL OVERCURRENT DEVICES SHALL HAVE AN INTERRUPTING CURRENT RATING THAT SHALL BE GREATER THAN THE SHORT
  CIRCUIT CURRENT TO WHICH THEY ARE SUBJECTED, 22,000 AIC MINIMUM. VERYIFY AVAILABLE SHORT CIRCUIT CURRENT DOES
  NOT EXCEED THE RATING OF ELECTRICAL EQUIPMENT IN ACCORDANCE WITH ARTICLE 110.24 NEC OR THE MOST CURRENT
- ADOPTED CODE PRE THE GOVERNING JURISDICTION.
  EACH END OF EVERY POWER PHASE CONDUCTOR, GROUNDING CONDUCTOR, AND TELCO CONDUCTOR OR CABLE SHALL BE LABELED WITH COLOR-CODED INSULATION OR ELECTRICAL TAPE (3M BRAND, 1/2" PLASTIC ELECTRICAL TAPE WITH UV
- PROTECTION, OR EQUAL). THE IDENTIFICATION METHOD SHALL CONFORM WITH NEC AND OSHA.
  ALL ELECTRICAL COMPONENTS SHALL BE CLEARLY LABELED WITH LAMICOID TAGS SHOWING THEIR RATED VOLTAGE, PHASE
- CIRCUIT ID'S).
- PANEL BOARDS (ID NUMBERS) SHALL BE CLEARLY LABELED WITH PLASTIC LABELS.
  ALL TIE WRAPS SHALL BE CUT FLUSH WITH APPROVED CUTTING TOOL TO REMOVE SHARP EDGES.
  ALL POWER AND EQUIPMENT GROUND WIRING IN TUBING OR CONDUIT SHALL BE SINGLE COPPER CONDUCTOR (#14 OR LARGER)
  WITH TYPE THHW, THWN, THWN-2, XHHW, XHHW-2, THW, THW-2, FHW, OR RHW-2 INSULATION UNLESS OTHERWISE SPECIFIED.
- SUPPLEMENTAL EQUIPMENT GROUND WIRING LOCATED INDOORS SHALL BE SINGLE COPPER CONDUCTOR (#6 OR LARGER) WITH TYPE THHW, THWN, THWN-2, XHHW, XHHW-2, THW, THW-2, RHW, OR RHW-2 INSULATION UNLESS OTHERWISE SPECIFIED.

  POWER AND CONTROL WIRING IN FLEXIBLE CORD SHALL BE MULTI-CONDUCTOR, TYPE SOOW CORD (#14 OR LARGER) UNLESS
- OTHERWISE SPECIFIED.
- POWER AND CONTROL WIRING FOR USE IN CABLE TRAY SHALL BE MULTI-CONDUCTOR, TYPE TC CABLE (#14 OR LARGER), WITH TYPE THHW, THWN, THWN-2, XHHW, XHHW-2, THW, THW-2, RHW, OR RHW-2 INSULATION UNLESS OTHERWISE SPECIFIED. ALL POWER AND GROUNDING CONNECTIONS SHALL BE CRIMP-STYLE, COMPRESSION WIRE LUGS AND WIRE NUTS BY THOMAS AN BETTS (OR EQUAL). LUGS AND WIRE NUTS SHALL BE RATED FOR OPERATION NOT LESS THAN 75' C (90' C IF AVAILABLE).
- RACEWAY AND CABLE TRAY SHALL BE LISTED OR LABELED FOR ELECTRICAL USE IN ACCORDANCE WITH NEMA, UL. ANSI/IEEE
- 15. ELECTRICAL METALLIC TUBING (EMT), INTERMEDIATE METAL CONDUIT (IMC), OR RIGID METAL CONDUIT (RMC) SHALL BE USED FOR EXPOSED INDOOR LOCATIONS.
- ELECTRICAL METALLIC TUBING (EMT) OR METAL—CLAD CABLE (MC) SHALL BE USED FOR CONCEALED INDOOR LOCATIONS.

  SCHEDULE 40 PVC UNDERGROUND ON STRAIGHTS AND SCHEDULE 80 PVC FOR ALL ELBOWS/90s AND ALL APPROVED ABOVE GRADE PVC CONDUIT.
- 18. LIQUID-TIGHT FLEXIBLE METALLIC CONDUIT (LIQUID-TITE FLEX) SHALL BE USED INDOORS AND OUTDOORS, WHERE VIBRATION
- COURS OR FLEXIBLE WEIGHT SINCEDED.

  COURS OR FLEXIBILITY IS NEEDED.

  CONDUIT AND TUBING FITTINGS SHALL BE THREADED OR COMPRESSION—TYPE AND APPROVED FOR THE LOCATION USED. SET SCREW FITTINGS ARE NOT ACCEPTABLE.
- 20. CABINETS, BOXES AND WIRE WAYS SHALL BE LABELED FOR ELECTRICAL USE IN ACCORDANCE WITH NEMA, UL, ANSI/IEEE AND
- WIREWAYS SHALL BE METAL WITH AN ENAMEL FINISH AND INCLUDE A HINGED COVER, DESIGNED TO SWING OPEN DOWNWARDS
- (WIREMOLD SPECMATE WIREWAY).
  SLOTTED WIRING DUCT SHALL BE PVC AND INCLUDE COVER (PANDUIT TYPE E OR EQUAL).
- SLOTTED WIRING DUCT SHALL BE PVC AND INCLUDE COVER (PANDUIT TYPE E OR EQUIAL).

  CONDUITS SHALL BE FASTENED SECURELY IN PLACE WITH APPROVED NON-PERFORATED STRAPS AND HANGERS. EXPLOSIVE DEVICES (i.e. POWDER-ACTUATED) FOR ATTACHING HANGERS TO STRUCTURE WILL NOT BE PERMITTED. CLOSELY FOLLOW THE LINES OF THE STRUCTURE, MAINTAIN CLOSE PROXIMITY TO THE STRUCTURE AND KEEP CONDUITS IN TIGHT ENVELOPES. CHANGES IN DIRECTION TO ROUTE AROUND OBSTACLES SHALL BE MADE WITH CONDUIT OUTLET BODIES. CONDUIT SHALL BE INSTALLED IN A NEAT AND WORKMANLIKE MANNER. PARALLEL AND PERPENDICULAR TO STRUCTURE WALL AND CEILING LINES. ALL CONDUIT SHALL BE FISHED TO CLEAR OBSTRUCTIONS. ENDS OF CONDUITS SHALL BE RIGHDY CLEAR OBSTRUCTIONS. ENDS OF CONDUITS SHALL BE RIGHDY CLAMPED TO BOXES BY GALVANIZED MALLEABLE IRON BUSHING ON INSIDE AND GALVANIZED MALLEABLE IRON LOCKNUT ON OUTSIDE AND INSIDE. EQUIPMENT CABINETS, TERMINAL BOXES, JUNCTION BOXES AND PULL BOXES SHALL BE GALVANIZED OR EPOXY—COATED SHEET STEEL. SHALL MEET OR EXCEED UL 50 AND BE RATED NEMA 1 (OR BETTER) FOR INTERIOR LOCATIONS AND NEMA 3R (OR BETTER) FOR EXTERIOR LOCATIONS.
- BETTER) FOR EXTERIOR LOCATIONS.
- METAL RECEPTACLE, SWITCH AND DEVICE BOXES SHALL BE GALVANIZED, EPOXY—COATED OR NON—CORRODING; SHALL MEET OR EXCEED UL 514A AND NEMA OS 1 AND BE RATED NEMA 1 (OR BETTER) FOR INTERIOR LOCATIONS AND WEATHER PROTECTED (WP OR BETTER) FOR EXTERIOR LOCATIONS
- NONMETALLIC RECEPTACLE, SWITCH AND DEVICE BOXES SHALL MEET OR EXCEED NEMA OS 2 (NEWEST REVISION) AND BE RATED NEMA 1 (OR BETTER) FOR INTERIOR LOCATIONS AND WEATHER PROTECTED (WP OR BETTER) FOR EXTERIOR LOCATIONS.
- THE CONTRACTOR SHALL NOTIFY AND OBTAIN NECESSARY AUTHORIZATION FROM THE CARRIER AND/OR CROWN CASTLE USA INC.
  BEFORE COMMENCING WORK ON THE AC POWER DISTRIBUTION PANELS.
  THE CONTRACTOR SHALL PROVIDE NECESSARY TAGGING ON THE BREAKERS, CABLES AND DISTRIBUTION PANELS IN ACCORDANCE
  WITH THE APPLICABLE CODES AND STANDARDS TO SAFEGUARD LIFE AND PROPERTY. 28.
- INSTALL LAMICOID LABEL ON THE METER CENTER TO SHOW "VERIZON"
- ALL EMPTY/SPARE CONDUITS THAT ARE INSTALLED ARE TO HAVE A METERED MULE TAPE PULL CORD INSTALLED.

CONDUCTOR COLOR CODE					
SYSTEM	CONDUCTOR	COLOR			
	A PHASE	BLACK			
120/240V, 1Ø	B PHASE	RED			
120/2400, 10	NEUTRAL	WHITE			
	GROUND	GREEN			
	A PHASE	BLACK			
	B PHASE	RED			
120/208V, 3Ø	C PHASE	BLUE			
	NEUTRAL	WHITE			
	GROUND	GREEN			
	A PHASE	BROWN			
	B PHASE	ORANGE OR PURPLE			
277/480V, 3Ø	C PHASE	YELLOW			
	NEUTRAL	GREY			
	GROUND	GREEN			
DC VOLTAGE	POS (+)	RED**			
DO VOLIAGE	NEG (-)	BLACK**			

\* SEE NEC 210.5(C)(1) AND (2)
\*\* POLARITY MARKED AT TERMINATION

ΔΝΙΤΕΝΙΝΙΔ EXISTING FACILITY INTERFACE FRAME GEN GPS GSM LTE MGB MW GENERATOR GLOBAL POSITIONING SYSTEM GLOBAL SYSTEM FOR MOBILE LONG TERM EVOLUTION MASTER GROUND BAR MICROWAVE (N) NEC NEW NATIONAL ELECTRIC CODE (P) PROPOSED POWER PLANT QTY RECT QUANTITY RECTIFIER RADIO BASE STATION RADIO BASE STATION
REMOTE ELECTRIC TILT
RADIO FREQUENCY DATA SHEET
REMOTE RADIO HEAD
REMOTE RADIO UNIT
SMART INTEGRATED DEVICE TOWER MOUNTED AMPLIFIER

UNIVERSAL MOBILE TELECOMMUNICATIONS SYSTEM

UMTS W.P.

## APWA UNIFORM COLOR CODE:

WHITE PROPOSED EXCAVATION TEMPORARY SURVEY MARKINGS ELECTRIC POWER LINES, CABLES, CONDUIT, AND LIGHTING CABLES YELLOW GAS, OIL, STEAM, PETROLEUM, OR GASEOUS MATERIALS

COMMUNICATION, ALARM OR SIGNAL LINES, CABLES, OR CONDUIT AND TRAFFIC LOOPS POTABLE WATER

RECLAIMED WATER, IRRIGATION, AND SLURRY LINES SEWERS AND DRAIN LINES

# TEMPLE TERRACE, FL 33637



ALPHARETTA, GA 30009



BUILDING 100, SUITE 350 ROSWELL, GA 30076 TEL: 678-990-2338 FAX: 678-990-2342


VERIZON SITE NUMBER: 236777

> BU #: **846215 OSCEOLA**

3099 NE MT CARRIE RD LAKE CITY, FL 32055

EXISTING 251'-6" SELF SUPPORT TOWER


E	ISSUED FOR:							
	REV	DATE	DRWN	DESCRIPTION	DES./Q			
	0	12/10/21	FS	FINAL	MDS			

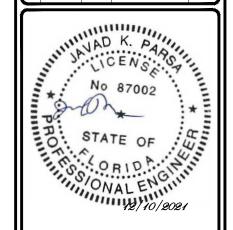

IIS ITEM HAS BEEN DIGITALLY SIGNED AND SEALED BY AD K. PARSA, P.E. ON THE DATE ADJACENT TO THE SEA INTED COPIES OF THIS DOCUMENT ARE NOT CONSIDERE NED AND SEALED AND THE SIGNATURE MUST BE ERIFIED ON ANY ELECTRONIC COPIES.

IT IS A VIOLATION OF LAW FOR ANY PERSON UNLESS THEY ARE ACTING UNDER THE DIRECTION OF A LICENSED PROFESSIONAL ENGINEER. TO ALTER THIS DOCUMENT

SHEET NUMBER:

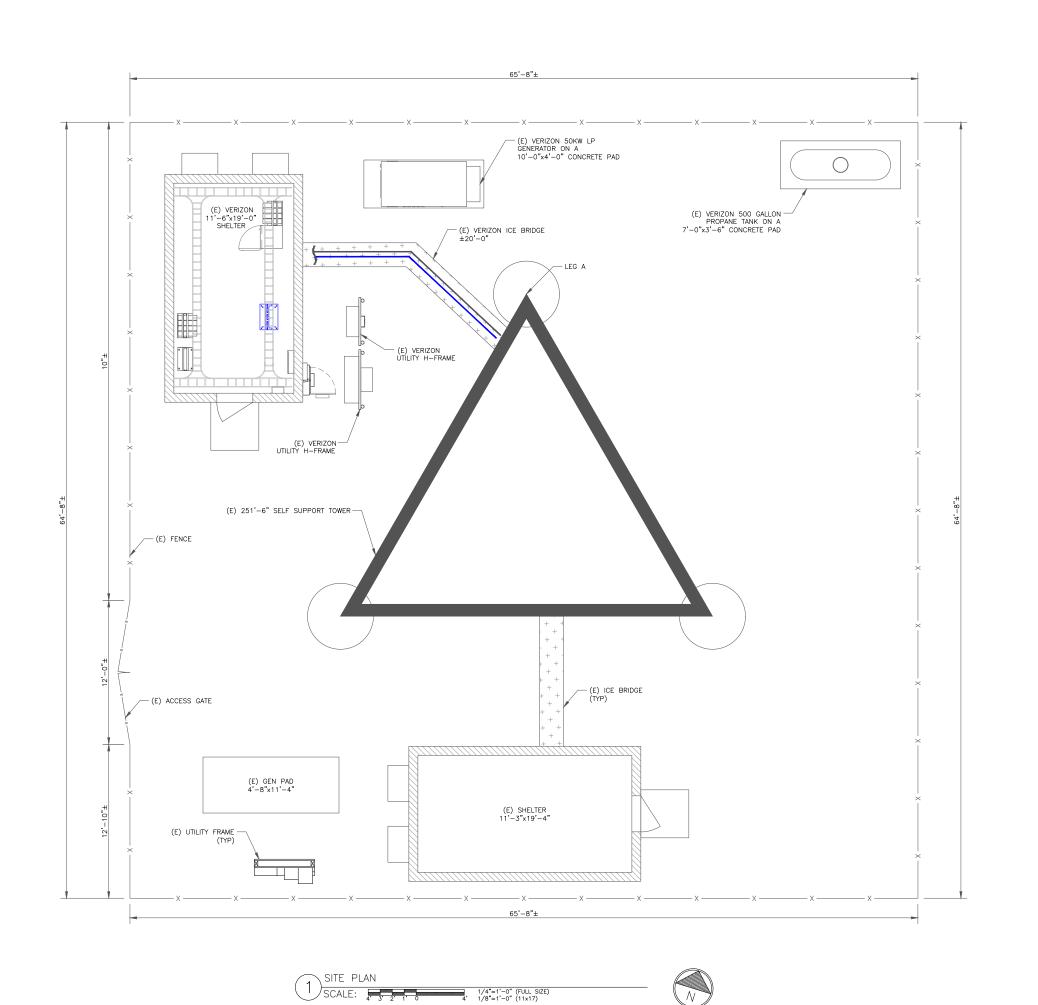







1080 HOLCOMB BRIDGE ROAD BUILDING 100, SUITE 350 ROSWELL, GA 30076 TEL: 678-990-2338 FAX: 678-990-2342


VERIZON SITE NUMBER: 236777

> BU #: **846215 OSCEOLA**

3099 NE MT CARRIE RD LAKE CITY, FL 32055

EXISTING 251'-6" SELF SUPPORT TOWER


I	ISSUED FOR:							
REV	DATE	DRWN	DESCRIPTION	DES./QA				
0	12/10/21	FS	FINAL	MDS				

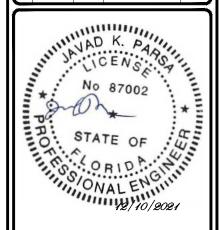


THIS ITEM HAS BEEN DIGITALLY SIGNED AND SEALED BY AVAD K. PARSA, P.E. ON THE DATE ADJACENT TO THE SEAL. RINTED COPIES OF THIS DOCUMENT ARE NOT CONSIDEREI IGNED AND SEALED AND THE SIGNATURE MUST BE PERIFIED ON ANY ELECTRONIC COPIES.

IT IS A VIOLATION OF LAW FOR ANY PERSON, UNLESS THEY ARE ACTING UNDER THE DIRECTION OF A LICENSED PROFESSIONAL ENGINEER, TO ALTER THIS DOCUMENT.

SHEET NUMBER:

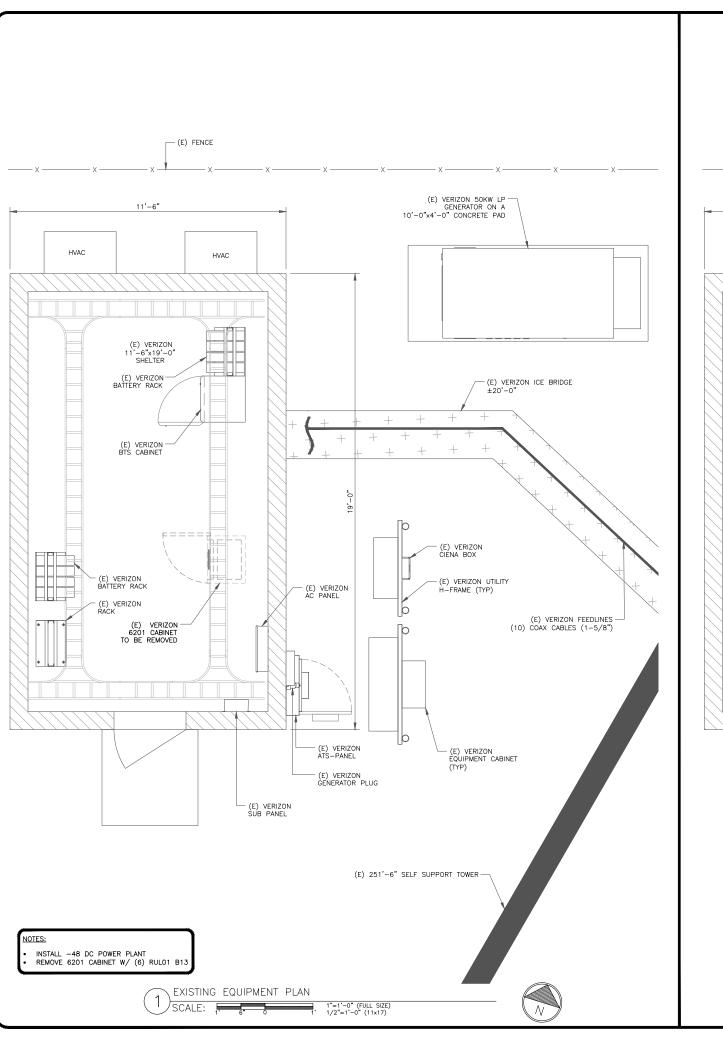

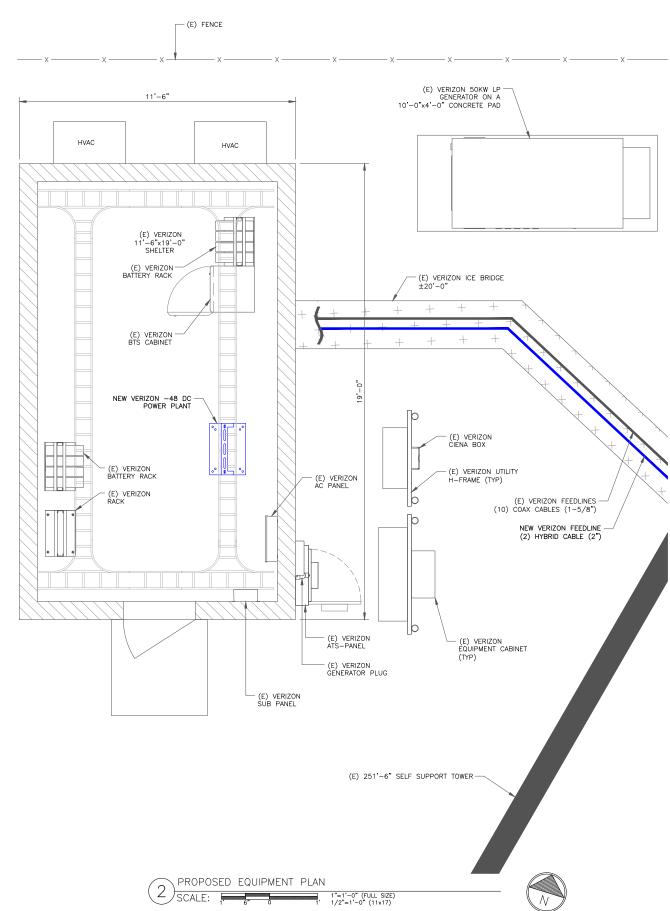







1080 HOLCOMB BRIDGE ROAD BUILDING 100, SUITE 350 ROSWELL, GA 30076 TEL: 678-990-2338 FAX: 678-990-2342

VERIZON SITE NUMBER: 236777

BU #: **846215 OSCEOLA** 

3099 NE MT CARRIE RD LAKE CITY, FL 32055

EXISTING 251'-6" SELF SUPPORT TOWER

	ISSUED FOR:						
REV	REV DATE DRWN DESCRIPTION DES./QA						
0	12/10/21	FS	FINAL	MDS			





THIS TIEM HAS BEEN DIGITALLY SIGNED AND SEALED BY JAVAD K. PARSA, P.E. ON THE DATE ADJACENT TO THE SEAL PRINTED COPIES OF THIS DOCUMENT ARE NOT CONSIDERED SIGNED AND SEALED AND THE SIGNATURE MUST BE VERIFIED ON ANY ELECTRONIC COPIES.

IT IS A VIOLATION OF LAW FOR ANY PERSON, UNLESS THEY ARE ACTING UNDER THE DIRECTION OF A LICENSED PROFESSIONAL ENGINEER, TO ALTER THIS DOCUMENT.

SHEET NUMBER:


C-1.2

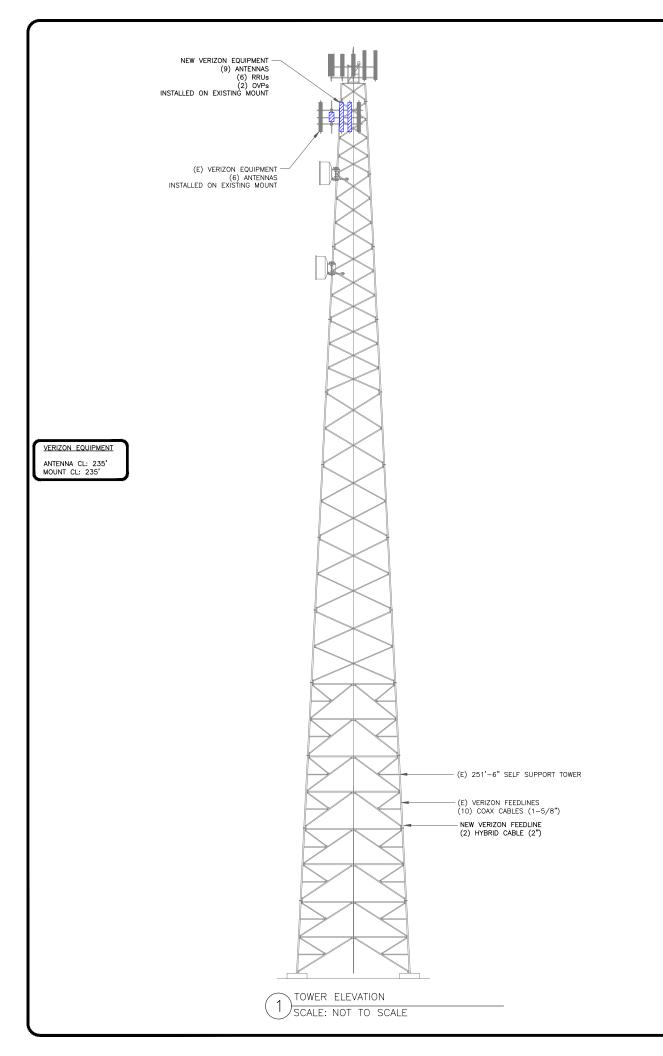

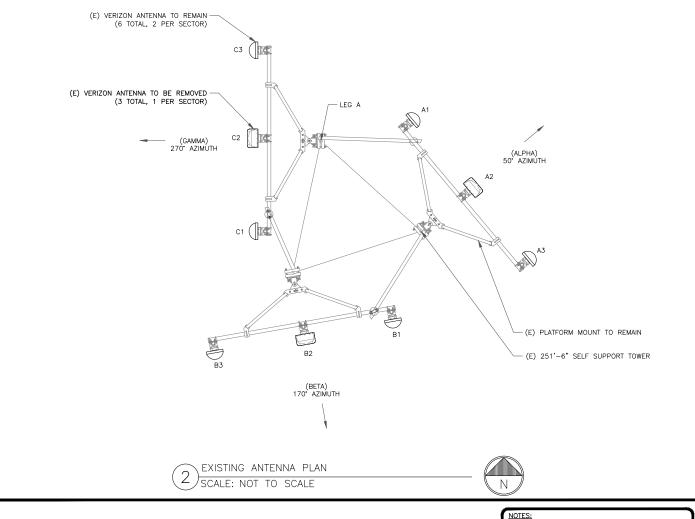

(BETA) 170° AZIMUTH

NEW ANTENNA PLAN SCALE: NOT TO SCALE

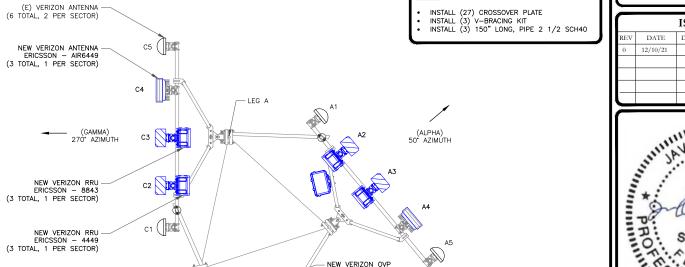

RAYCAP - OVP12/6627 (2 TOTAL)

NEW VERIZON ANTENNA COMMSCOPE - NHH-65C-R2B (6 TOTAL, 2 PER SECTOR) verizon /

TEMPLE TERRACE, FL 33637





1080 HOLCOMB BRIDGE ROAD BUILDING 100, SUTTE 350 ROSWELL, GA 30076 TEL: 678-990-2338 FAX: 678-990-2342

VERIZON SITE NUMBER: 236777

BU #: **846215 OSCEOLA** 

3099 NE MT CARRIE RD LAKE CITY, FL 32055

EXISTING 251'-6" SELF SUPPORT TOWER

ISSUED FOR:							
REV	DATE	DRWN	DESCRIPTION	DES./QA			
0	12/10/21	FS	FINAL	MDS			



THIS ITEM HAS BEEN DIGITALLY SIGNED AND SEALED BY AVAD K. PARSA, P.E. ON THE DATE ADJACENT TO THE SEAL RINTED COPIES OF THIS DOCUMENT ARE NOT CONSIDEREE IGNED AND SEALED AND THE SIGNATURE MUST BE FERRIED ON ANY ELECTRONIC COPIES.

IT IS A VIOLATION OF LAW FOR ANY PERSON, UNLESS THEY ARE ACTING UNDER THE DIRECTION OF A LICENSED PROFESSIONAL ENGINEER, TO ALTER THIS DOCUMENT.

SHEET NUMBER:

C-2

MBER: REVISION:

	FINAL EQUIPMENT SCHEDULE							
SECTOR	STATUS	ANTENNA MANUFACTURER	ANTENNA MODEL	ANTENNA CENTERLINE	AZIMUTH	TOWER EQUIPMENT MANUFACTURER	TOWER EQUIPMENT QTY/MODEL	
A1	EXISTING	ANTEL	RWA-80016CF	235'	50°	-	-	
A2	NEW	COMMSCOPE	NHH-65C-R2B	235'	50°	ERICSSON	(1) RADIO 4449	
A3	NEW	COMMSCOPE	NHH-65C-R2B	235'	50 <b>°</b>	ERICSSON	(1) RADIO 8843	
A4	NEW	ERICSSON	AIR6449	235'	50°	RAYCAP	(1) OVP12/6627	
A5	EXISTING	ANTEL	RWA-80016CF	235'	50°	-	-	
B1	EXISTING	ANTEL	RWA-80016CF	235'	170°	-	-	
B2	NEW	COMMSCOPE	NHH-65C-R2B	235'	170°	ERICSSON	(1) RADIO 4449	
В3	NEW	COMMSCOPE	NHH-65C-R2B	235'	170°	ERICSSON	(1) RADIO 8843	
B4	NEW	ERICSSON	AIR6449	235'	170°	RAYCAP	(1) OVP12/6627	
B5	EXISTING	ANTEL	RWA-80016CF	235'	170°	-	-	
C1	EXISTING	ANTEL	RWA-80016CF	235'	270*	-	-	
C2	NEW	COMMSCOPE	NHH-65C-R2B	235'	270°	ERICSSON	(1) RADIO 4449	
C3	NEW	COMMSCOPE	NHH-65C-R2B	235'	270°	ERICSSON	(1) RADIO 8843	
C4	NEW	ERICSSON	AIR6449	235'	270°	-	-	
C5	EXISTING	ANTEL	RWA-80016CF	235'	270*	-	-	

FINAL CABLE SCHEDULE						
STATUS CABLE TYPE SIZE LENGTH Q						
EXISTING	COAX	1-5/8"	285'-0"±	10		
NEW	HYBRID	2"	285'-0"±	2		
TOTAL CABLE QTY:						

REFER TO RFDS FOR ELECTRICAL & MECHANICAL DOWNTILTS







1080 HOLCOMB BRIDGE ROAD BUILDING 100, SUITE 350 ROSWELL, GA 30076 TEL: 678-990-2338 FAX: 678-990-2342


VERIZON SITE NUMBER: 236777

> BU #: **846215 OSCEOLA**

3099 NE MT CARRIE RD LAKE CITY, FL 32055

EXISTING 251'-6" SELF SUPPORT TOWER

ISSUED FOR:						
REV	DATE	DRWN	DESCRIPTION	DES./QA		
0	12/10/21	FS	FINAL	MDS		

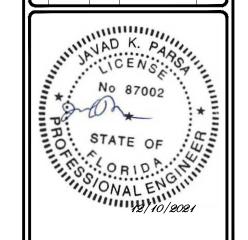

THIS ITEM HAS BEEN DIGITALLY SIGNED AND SEALED BY JAVAD K. PARSA, P.E. ON THE DATE ADJACENT TO THE SEAL. PRINTED COPIES OF THIS DOCUMENT ARE NOT CONSIDERED SIGNED AND SEALED AND THE SIGNATURE MUST BE VERIFIED ON ANY ELECTRONIC COPIES.

IT IS A VIOLATION OF LAW FOR ANY PERSON, UNLESS THEY ARE ACTING UNDER THE DIRECTION OF A LICENSED PROFESSIONAL ENGINEER, TO ALTER THIS DOCUMENT.

SHEET NUMBER:

## NHH-65C-R2B



6-port sector antenna, 2x 698-896 and 4x 1695-2360 MHz, 65° HPBW, 2x RET. Both high bands share the same electrical tilt.

3GPP/AISG 2.0 (Single RET)

Separate RS-485 RET input/output for low and high band
 One RET for low band and one RET for both high bands to ensure same tilt level for 4x Rx or 4x

## General Specifications

Band Multiband Light gray

Grounding Type RF connector body grounded to reflector and mounting bracket

Radome Material Fiberglass, UV resistant Radiator Material Copper | Low loss circuit board

Reflector Material RF Connector Quantity, high band

RF Connector Quantity, low band RF Connector Quantity, total

Remote Electrical Tilt (RET) Information

RET Interface 8-pin DIN Female | 8-pin DIN Male RET Interface, quantity 2 female | 2 male 10-30 Vdc Input Voltage

Internal RET

Power Consumption, idle state, maximum Power Consumption, normal conditions, maximum 13 W

Dimensions Width 301 mm | 11.85 in 180 mm | 7.087 in Depth 2438 mm | 95.984 in 23.4 kg | 51.588 lb Net Weight, without mounting kit

COMMSCOPE - NHH-65C-R2B

SCALE: NOT TO SCALE

AIR 6449 B41, B77D, B78M, B43\*



- Advanced Antenna System (AAS)
- 64TX/64RX with 192 AE
- Up to 320W
- EIRP up to 79 dBm
- Up to 200 MHz IBW & CBW
- Max total carrier BW is 200MHz for NR, or 100MHz for LTE
- 4 x 25 Gbps eCPRI
- Weight: 47 kg
- Size (H x W x D): 841 x 524 x 211
- -48 VDC (3-wire or 2-wire)
- Support number of layers: DL/UL 16/8



ERICSSON - AIR6449 2) SCALE: NOT TO SCALE



ERICSSON - RADIO 4449 WEIGHT: 67.2 LBS SIZE (HxWxD): 17.9x13.2x9.3 IN.

ERICSSON - RADIO 4449 SCALE: NOT TO SCALE



**OSCEOLA** 3099 NE MT CARRIE RD LAKE CITY, FL 32055

> EXISTING 251'-6" SELF SUPPORT TOWER

TEMPLE TERRACE, FL 33637

8000 AVALON BLVD, SUITE 700

ALPHARETTA, GA 30009

1080 HOLCOMB BRIDGE ROAD

BUILDING 100, SUITE 350

ROSWELL, GA 30076

TEL: 678-990-2338 FAX: 678-990-2342

VERIZON SITE NUMBER:


236777

BU #: **846215** 

towersource

**CROWN CASTLE** 

ISSUED FOR:						
REV	DATE	DRWN	DESCRIPTION	DES./Q/		
0	12/10/21	FS	FINAL	MDS		

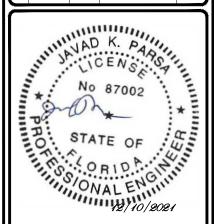

IIS ITEM HAS BEEN DIGITALLY SIGNED AND SEALED BY AVAD K. PARSA, P.E. ON THE DATE ADJACENT TO THE SEAL RINTED COPIES OF THIS DOCUMENT ARE NOT CONSIDERED IGNED AND SEALED AND THE SIGNATURE MUST BE ERIFIED ON ANY ELECTRONIC COPIES.

IT IS A VIOLATION OF LAW FOR ANY PERSON, UNLESS THEY ARE ACTING UNDER THE DIRECTION OF A LICENSED PROFESSIONAL ENGINEER, TO ALTER THIS DOCUMENT.

REVISION:


SHEET NUMBER:



ERICSSON — RADIO 8843 WEIGHT: 71.9 LBS SIZE (HxWxD): 18.0x13.2x11.1 IN.

ERICSSON - RADIO 8843 (4) SCALE: NOT TO SCALE



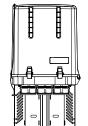

SIZE (HxWxD): 28.93x15.73x10.31 IN.


RAYCAP - OVP12/6627SCALE: NOT TO SCALE

NOT USED

(6) SCALE: NOT TO SCALE

# INSTALLER NOTES:

COMPLY WITH MANUFACTURERS
INSTRUCTIONS TO ENSURE THAT ALL RRUS
RECEIVE ELECTRICAL POWER WITHIN 24
HOURS OF BEING REMOVED FROM THE
MANUFACTURER'S PACKAGING.
2. DO NOT OPEN RRU PACKAGES IN THE RAIN.
3. ALL PIPES, BRACKETS, AND MISCELLANEOUS
HARDWARE TO BE GALVANIZED UNLESS
NOTED OTHERWISE.

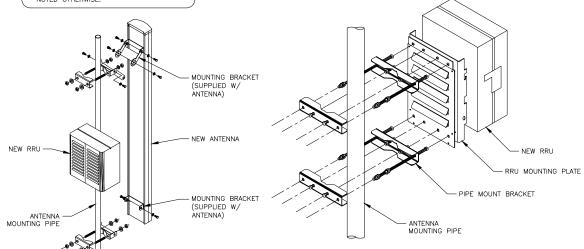







1080 HOLCOMB BRIDGE ROAD BUILDING 100, SUITE 350 ROSWELL, GA 30076 TEL: 678-990-2338 FAX: 678-990-2342

VERIZON SITE NUMBER: 236777

> BU #: **846215 OSCEOLA**

3099 NE MT CARRIE RD LAKE CITY, FL 32055

EXISTING 251'-6" SELF SUPPORT TOWER

	ISSUED FOR:						
REV	DATE	DRWN	DESCRIPTION	DES./Q			
0	12/10/21	FS	FINAL	MDS			



HIS ITEM HAS BEEN DIGITALLY SIGNED AND SEALED BY HIS HEAS BEEN DIGHTALLY SIGNED AND SEALED BY AVAD K. PARSA, P.E. ON THE DATE ADJACENT TO THE SEAL RINTED COPIES OF THIS DOCUMENT ARE NOT CONSIDEREI GONED AND SEALED AND THE SIGNATURE MUST BE ERIFIED ON ANY ELECTRONIC COPIES.


IT IS A VIOLATION OF LAW FOR ANY PERSON, UNLESS THEY ARE ACTING UNDER THE DIRECTION OF A LICENSED PROFESSIONAL ENGINEER, TO ALTER THIS DOCUMENT.

SHEET NUMBER:

REVISION:


NOT USED SCALE: NOT TO SCALE

ANTENNA WITH RRU MOUNTING DETAIL 2) SCALE: NOT TO SCALE

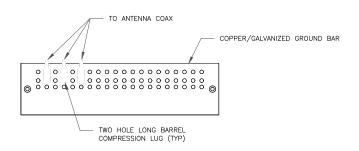

- 1. DOUBLING UP "OR STACKING" OF CONNECTIONS IS NOT PERMITTED
- 2. EXTERIOR ANTIOXIDANT JOINT COMPOUND TO BE USED ON ALL EXTERIOR CONNECTIONS.
- GROUND BAR SHALL NOT BE ISOLATED FROM TOWER. MOUNT DIRECTLY TO ANTENNA MOUNT STEEL.

ANTENNA SECTOR GROUND BAR DETAIL SCALE: NOT TO SCALE

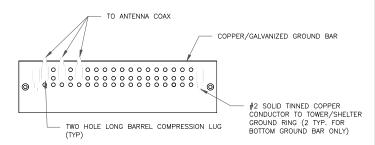


## NOTES:

- 1. EXTERIOR ANTIOXIDANT JOINT COMPOUND TO BE USED ON ALL EXTERIOR CONNECTIONS.
- 2. GROUND BAR SHALL NOT BE ISOLATED FROM TOWER. MOUNT DIRECTLY TO TOWER STEEL (TOWER ONLY).
- 3. GROUND BAR SHALL BE ISOLATED FROM BUILDING OR SHELTER.


TOWER/SHELTER GROUND BAR DETAIL

SCALE: NOT TO SCALE

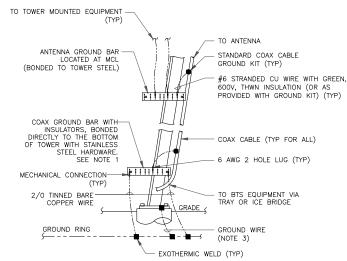


- NUMBER OF GROUNDING BARS MAY VARY DEPENDING ON THE TYPE OF TOWER, ANTENNA LOCATIONS AND CONNECTION ORIENTATION. COAXIAL CABLES EXCEEDING 200 FEET ON THE TOWER SHALL HAVE GROUND KITS AT THE MIDPOINT. PROVIDE AS REQUIRED.
- ONLY MECHANICAL CONNECTIONS ARE ALLOWED TO BE MADE TO CROWN CASTLE USA INC. TOWERS. ALL MECHANICAL CONNECTIONS SHALL BE TREATED WITH AN ANTI-OXIDANT COATING.
- ALL TOWER GROUNDING SYSTEMS SHALL COMPLY WITH THE REQUIREMENTS OF THE RECOGNIZED EDITION OF ANSI/TIA 222 AND NFPA 780.


TYPICAL ANTENNA CABLE GROUNDING (4) SCALE: NOT TO SCALE

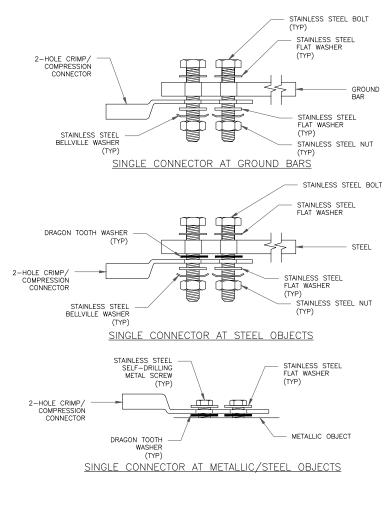

HARDWARE DETAIL FOR EXTERIOR CONNECTIONS SCALE: NOT TO SCALE

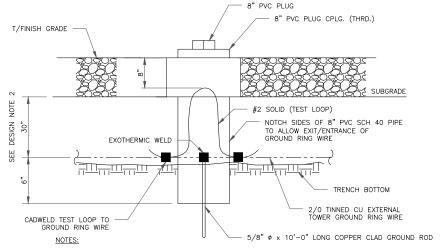

- 1. GROUND ROD SHALL BE DRIVEN VERTICALLY, NOT TO EXCEED 45 DEGREES FROM THE
- GROUND WIRE SHALL BE MIN. 30" BELOW GRADE OR 6" BELOW FROST LINE. (WHICH EVER IS GREATER) AS PER N.E.C. ARTICLE 250-50(D)
- INSPECTION WELL DETAIL SCALE: NOT TO SCALE

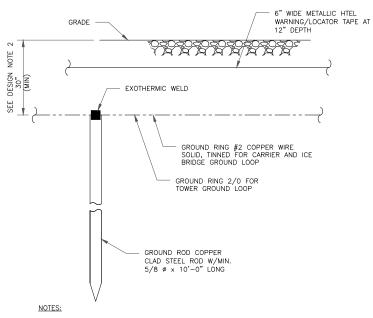

- 1. GROUND ROD SHALL BE DRIVEN VERTICALLY, NOT TO EXCEED 45 DEGREES FROM THE
- VERTICAL

  2. GROUND WIRE SHALL BE MIN. 30" BELOW GRADE OR 6" BELOW FROST LINE. (WHICH EVER IS GREATER) AS PER N.E.C. ARTICLE 250-50(D)

GROUND ROD DETAIL SCALE: NOT TO SCALE







1080 HOLCOMB BRIDGE ROAD BUILDING 100, SUITE 350 ROSWELL, GA 30076 TEL: 678-990-2338 FAX: 678-990-2342

**VERIZON SITE NUMBER:** 236777

> BU #: **846215 OSCEOLA**

3099 NE MT CARRIE RD LAKE CITY, FL 32055

EXISTING 251'-6" SELF SUPPORT TOWER


	ISSUED FOR:						
REV	DATE	DRWN	DESCRIPTION	DES./QA			
0	12/10/21	FS	FINAL	MDS			



IS ITEM HAS BEEN DIGITALLY SIGNED AND SEALED BY AD K. PARSA, P.E. ON THE DATE ADJACENT TO THE SEAL NTED COPIES OF THIS DOCUMENT ARE NOT CONSIDERE JED AND SEALED AND THE SIGNATURE MUST BE RIFIED ON ANY ELECTRONIC COPIES.

IT IS A VIOLATION OF LAW FOR ANY PERSON, UNLESS THEY ARE ACTING UNDER THE DIRECTION OF A LICENSED PROFESSIONAL ENGINEER, TO ALTER THIS DOCUMENT.


SHEET NUMBER:

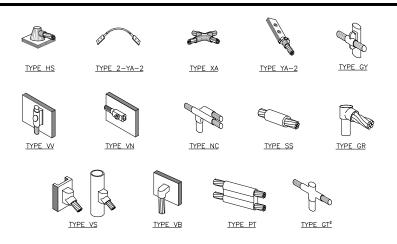

### NOTE:


- ERICO EXOTHERMIC "MOLD TYPES" SHOWN HERE ARE EXAMPLES. CONSULT WITH CONSTRUCTION MANAGER FOR SPECIFIC MOLDS TO BE USED FOR THIS PROJECT.
   MOLD TYPE ONLY TO BE USED BELOW GRADE WHEN CONNECTING GROUND RING TO GROUND ROD.


## CADWELD GROUNDING CONNECTIONS SCALE: NOT TO SCALE

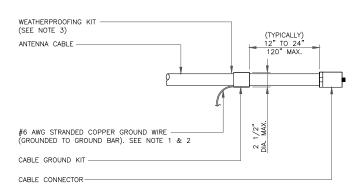

## NOTES:

- DO NOT INSTALL CABLE GROUND KIT AT A BEND AND ALWAYS DIRECT GROUND WIRE DOWN TO GROUND BAR.
- GROUNDING KIT SHALL BE TYPE AND PART NUMBER AS SUPPLIED OR RECOMMENDED BY CABLE MANUFACTURER.
- WEATHER PROOFING SHALL BE TWO-PART TAPE KIT, COLD SHRINK SHALL NOT

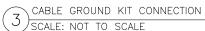


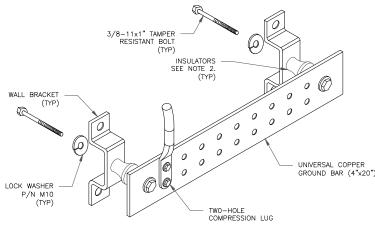

1. DOWN LEAD (HOME RUN) CONDUCTORS ARE NOT TO BE INSTALLED ON CROWN CASTLE USA INC. TOWER, PER THE GROUNDING DOWN CONDUCTOR POLICY QAS—STD-10091. NO MODIFICATION OR DRILLING TO TOWER STEEL IS ALLOWED IN ANY FORM OR FASHION, CAD—WELDING ON THE TOWER AND/OR IN THE AIR ARE NOT PERMITTED.

2. OMIT INSULATOR WHEN MOUNTING TO TOWER STEEL OR PLATFORM STEEL USE INSULATORS WHEN ATTACHING TO BUILDING OR SHELTERS.


GROUND BAR DETAIL (6) SCALE: NOT TO SCALE

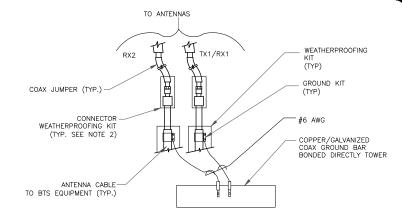


## NOTES:

- 1. DO NOT INSTALL CABLE GROUND KIT AT A BEND AND ALWAYS DIRECT GROUND WIRE DOWN TO ANTENNA GROUND BAR
- 2. WEATHER PROOFING SHALL BE TWO-PART TAPE KIT. COLD SHRINK SHALL NOT BE USED.

GROUND CABLE CONNECTION SCALE: NOT TO SCALE

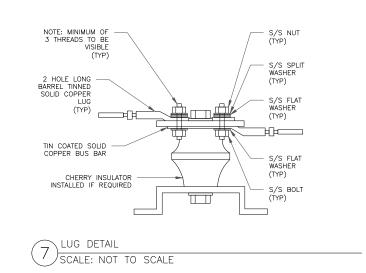


BURNDY LUG BOLT SIZE WIRE SIZE #6 AWG GREEN INSULATED YA6C-2TC38 3/8" - 16 NC S 2 BOLT #2 AWG SOLID TINNED YA3C-2TC38 3/8" - 16 NC S 2 BOLT #2 AWG STRANDED YA2C-2TC38 3/8" - 16 NC S 2 BOLT #2/0 AWG STRANDED YA26-2TC38 3/8" - 16 NC S 2 BOLT #4/0 AWG STRANDED YA28-2N 1/2" - 16 NC S 2 BOLT

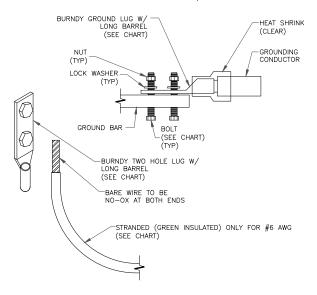


## NOTES:

ALL GROUNDING LUGS ARE TO BE INSTALLED PER MANUFACTURER'S SPECIFICATIONS. ALL HARDWARE BOLTS, NUTS, LOCK WASHERS SHALL BE STAINLESS STEEL. ALL HARDWARE ARE TO BE AS FOLLOWS: BOLT, FLAT WASHER, GROUND BAR, GROUND LUG, FLAT WASHER AND NUT.

MECHANICAL LUG CONNECTION SCALE: NOT TO SCALE

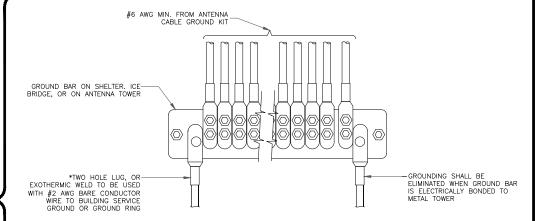

GROUNDWIRE INSTALLATION SCALE: NOT TO SCALE

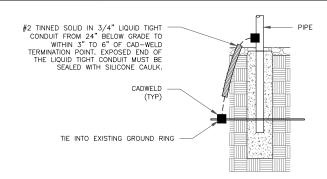

TRANSITIONING GROUND DETAIL SCALE: NOT TO SCALE







1080 HOLCOMB BRIDGE ROAD BUILDING 100, SUITE 350 ROSWELL, GA 30076 TEL: 678-990-2338 FAX: 678-990-2342


**VERIZON SITE NUMBER:** 236777

> BU #: **846215 OSCEOLA**

3099 NE MT CARRIE RD LAKE CITY, FL 32055

EXISTING 251'-6" SELF SUPPORT TOWER


-										
	ISSUED FOR:									
REV	DATE	DRWN	DESCRIPTION	DES./QA						
0	12/10/21	FS	FINAL	MDS						
I —										

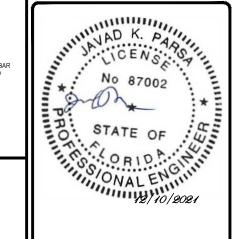

IS ITEM HAS BEEN DIGITALLY SIGNED AND SEALED BY AD K. PARSA, P.E. ON THE DATE ADJACENT TO THE SEAL NTED COPIES OF THIS DOCUMENT ARE NOT CONSIDERE ED AND SEALED AND THE SIGNATURE MUST BE RIFIED ON ANY ELECTRONIC COPIES.

IT IS A VIOLATION OF LAW FOR ANY PERSON, UNLESS THEY ARE ACTING UNDER THE DIRECTION OF A LICENSED PROFESSIONAL ENGINEER, TO ALTER THIS DOCUMENT.

SHEET NUMBER:

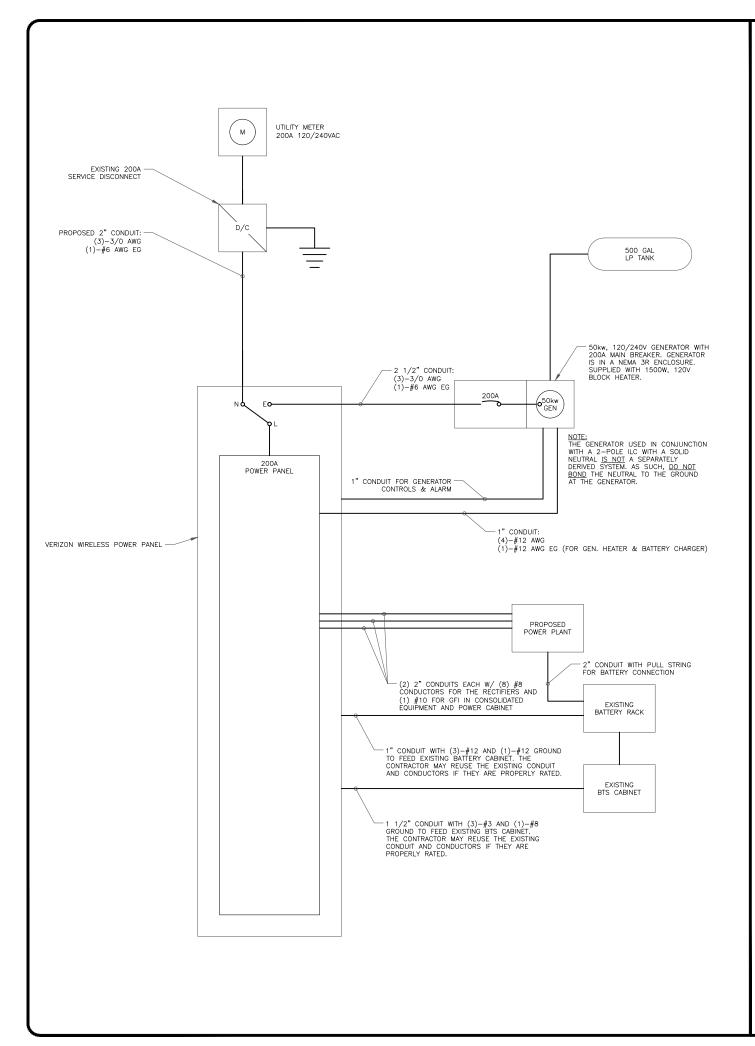

# 200A 120/240V 10 3W VERIZON POWER PANEL SCHEDULE

LOAD DESCRIPTION	TRIP	CKT#	PHAS	SE	CKT#	TRIP	LOAD DESCRIPTION
RECTIFIER #1	40A	1 3	A B		2	40A	RECTIFIER #2
RECTIFIER #3	40A	5 7	A B		6 8	40A	RECTIFIER #4
RECTIFIER #5	40A	9	A B		10 12	40A	RECTIFIER #6
RECTIFIER #7	40A	13 15	A B		14 16	60A	POWER PLANT
BTS CABINET	100A	17 19	A B	_	18 20	200A	GENERATOR
INTERIOR & EXTERIOR LIGHTS HALON ALARM PANEL	20A	21	A B		22 24	20A	EXTERIOR RECEPTACLES RECEPTACLES
AC 3 WALL MOUNT AC 3 WALL MOUNT	30A	25 27	A B		26 28	20A	DSX FRAME RECEPTACLE
COMP 1 COMP 1	30A	29 31	A B		30 32	20A	ATTU 2 ATTU 2
AC CONTROL PANEL	20A	33 35	A B		34 36	20A	COMP 2 COMP 2
	-	37 39	A B		38 40	20A	PUMP PUMP
VORTEX	20A	41	A		42	-	







1080 HOLCOMB BRIDGE ROAD BUILDING 100, SUITE 350 ROSWELL, GA 30076 TEL: 678-990-2338 FAX: 678-990-2342


VERIZON SITE NUMBER: 236777

BU #: **846215 OSCEOLA** 

3099 NE MT CARRIE RD LAKE CITY, FL 32055

EXISTING 251'-6" SELF SUPPORT TOWER

ISSUED FOR:									
REV	DATE	DRWN	DESCRIPTION	DES./QA					
0	12/10/21	FS	FINAL	MDS					

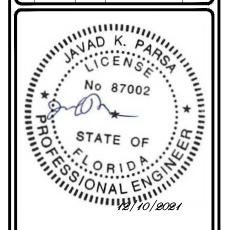

THIS TIEM HAS BEEN DIGITALLY SIGNED AND SEALED BY JAVAD K. PARSA, P.E. ON THE DATE ADJACENT TO THE SEAL PRINTED COPIES OF THIS DOCUMENT ARE NOT CONSIDERED SIGNED AND SEALED AND THE SIGNATURE MUST BE VERIFIED ON ANY ELECTRONIC COPIES.

IT IS A VIOLATION OF LAW FOR ANY PERSON, UNLESS THEY ARE ACTING UNDER THE DIRECTION OF A LICENSED PROFESSIONAL ENGINEER, TO A LIFER THIS DOCUMENT

SHEET NUMBER:

 $E_{-1}$ 

REVISION:

PANEL SCHEDULE
SCALE: NOT TO SCALE